CITY COUNCIL MEMBERS

AMY PECK

TARSHA JACKSON

ABBIE KAMIN

CAROLYN EVANS-SHABAZZ

FRED FLICKINGER

TIFFANY THOMAS

MARY NAN HUFFMAN

MARIO CASTILLO

PROJECT SITE

VICINITY MAP

N.T.S.



PLANS FOR CONSTRUCTION

OF

CONTROLLER

CITY COUNCIL MEMBERS

CHRIS HOLLINS

JOAQUIN MARTINEZ

EDWARD POLLARD

MARTHA CASTEX-TATUM

JULIAN RAMIREZ

WILLIE DAVIS

TWILA CARTER

LETITIA PLUMMER

SALLIE ALCORN

KENSWICK DRIVE EXTENSION

T

GEORGE BUSH INTERCONTINENTAL AIRPORT / HOUSTON


PROJECT NO. 935 TIP-20-220-IAH



ATKINS

MAY 08, 2024 ISSUED FOR PERMIT

ROADWAY	DESIGN SPEED
KENSWICK DR	45 MPH
WILL CLAYTON PKWY	50 MPH
LEE RD	45 MPH
*WILL CLAYTON TURNAROUNDS BASED ON TXDOT 75FT.	TURNAROUND RADIUS OF

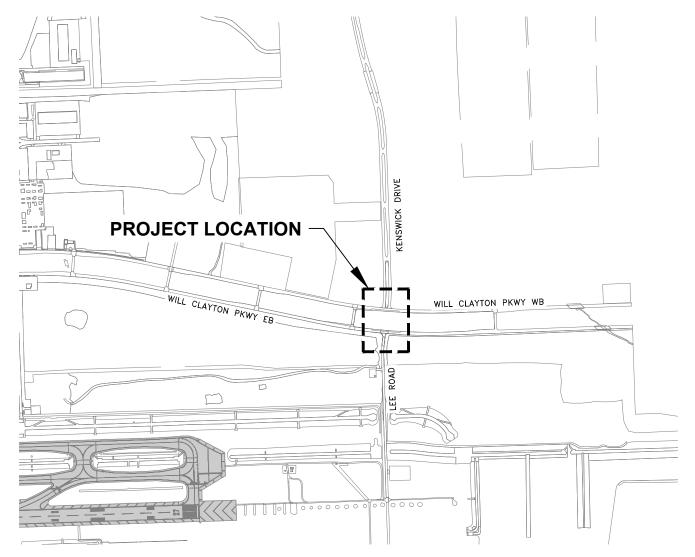

LOCATION MAP

N.T.S.

HAS FILE: C: \PW_WORK\ATKNATX01\WSATKINS_LESL4438\DMS59378\I-0935-G-

G-001

100072032

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ATKINS NORTH
AMERICA PE FIRM REG.

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NO. DESCRIPTION

CTTY OF HOLSTON
HOLSTON AIRPORTS SYSTEM
Recommended

AIRPORTS System
DATE
Director or Designated Representative

Recommended System DATE
Director or Designated Representative

REVENEED IN EXECUTIONS TAKEN
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K DRIVE EXTENSION OVER SHEET

PROJECT MGR: MES


DESIGNER: ALR

DRAWN BY: ALR

CHECK BY: PMW

SCALE:

05/08/2024

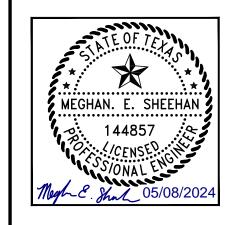

APPROVED BY:

PROJECT NO.

A.I.P. NO.

C.I.P. NO.

H.A.S. NO.

SHEET NO.

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#	SHEET TITLE	SHEET DESCRIPTION	
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2	G-002	SHEET INDEX	
3	G-003	SUMMARY OF QUANTITIES	
4	G-004	GENERAL NOTES, LEGEND AND ABBREVIATIONS	
5	G-005	OVERALL SITE PLAN	
6	G-006	SITE LAYOUT AND ACCESS PLAN	
7	G-007	CONSTRUCTION SAFETY PHASING PLANS	
8	G-008	MAINTENANCE OF TRAFFIC NOTES AND DETAILS	
9	G-009	MAINTENANCE OF TRAFFIC NOTES AND DETAILS	
10	G-010	MAINTENANCE OF TRAFFIC NOTES AND DETAILS	
11	G-011	MAINTENANCE OF TRAFFIC NOTES AND DETAILS	
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27	D-104	DEMOLITION PLAN	
28	D-105	DEMOLITION PLAN	
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30	D-107	DEMOLITION PLAN	
31	D-108	DEMOLITION PLAN	
32	D-109	DEMOLITION PLAN	
33	CP-101	OVERALL GEOMETRY AND PAVING PLAN	
34	CP-102	GEOMETRY AND PAVING PLAN	
35	CP-103	GEOMETRY AND PAVING PLAN	
36	CP-104	GEOMETRY AND PAVING PLAN	
37	CP-105	GEOMETRY AND PAVING PLAN	
38	CP-106	GEOMETRY AND PAVING PLAN	
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47	CP-206	ROADWAY PLAN AND PROFILES	
48	CP-207	ROADWAY PLAN AND PROFILES	
49	CP-208	ROADWAY PLAN AND PROFILES	
50	CP-209	ROADWAY PLAN AND PROFILES	
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52	CP-551	TYPICAL PAVEMENT SECTIONS AND DETAILS	
53	CP-552	TYPICAL PAVEMENT SECTIONS AND DETAILS	
54	CP-553	TYPICAL PAVEMENT SECTIONS AND DETAILS	

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57	CJ-102	JOINTING PLAN		
58	CJ-103	JOINTING PLAN		
59	CJ-104	JOINTING PLAN		
60	CJ-105	JOINTING PLAN		
61	CJ-106	JOINTING PLAN		
62	CJ-107	JOINTING PLAN		
63	CJ-108	JOINTING PLAN		
64	CJ-109	JOINTING PLAN		
65	CD-101	OVERALL GRADING AND DRAINAGE PLAN		
66	CD-102	GRADING AND DRAINAGE PLAN		
67	CD-103	GRADING AND DRAINAGE PLAN		
68	CD-104	GRADING AND DRAINAGE PLAN		
69	CD-105	GRADING AND DRAINAGE PLAN		
70	CD-106	GRADING AND DRAINAGE PLAN		
71	CD-107	GRADING AND DRAINAGE PLAN		
72	CD-108	GRADING AND DRAINAGE PLAN		
73	CD-109	GRADING AND DRAINAGE PLAN		
74	CD-110	DRAINAGE STRUCTURE AND PIPE SCHEDULES		
75	CD-201	STORM DRAIN PROFILES		
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77	CD-501	DETENTION POND PLAN AND PROFILE		
78	CD-502	DETENTION POND PLAN AND PROFILE		
79	CD-551	DRAINAGE DETAILS		
80	CD-552	DRAINAGE DETAILS		
81	CD-553	DRAINAGE DETAILS		
82	CD-601	CROSS-SECTION LAYOUT PLAN		
83	CD-602	KENSWICK INTERSECTION SECTIONS		
84	CD-603	KENSWICK INTERSECTION SECTIONS		
85	CD-604	KENSWICK FULL SECTION SECTIONS		
86	CD-605	LEE ROAD SECTIONS		
87	CD-606	LEE ROAD SECTIONS		
88	CD-607	WILL CLAYTON EB TO WB U-TURN SECTIONS		
89	CD-608	WILL CLAYTON EB TO WB U-TURN SECTIONS		
90	CD-609	WILL CLAYTON WB TO EB U-TURN SECTIONS		
91	CD-610	WILL CLAYTON WB TO EB U-TURN SECTIONS		
92	CM-101	OVERALL SIGNAGE AND MARKINGS PLAN		
93	CM-102	SIGNAGE AND MARKINGS PLAN		
94	CM-103	SIGNAGE AND MARKINGS PLAN		
95	CM-104	SIGNAGE AND MARKINGS PLAN		
96	CM-105	SIGNAGE AND MARKINGS PLAN		
97	CM-106	SIGNAGE AND MARKINGS PLAN		
98	CM-107	SIGNAGE AND MARKINGS PLAN		
99	CM-108	SIGNAGE AND MARKINGS PLAN		
100	CM-109	SIGNAGE AND MARKINGS PLAN		
101	CM-501	SIGNAGE AND MARKINGS DETAILS		
102	CM-502	SIGNAGE AND MARKINGS DETAILS		
103	CM-503	SIGNAGE AND MARKINGS DETAILS		
104	CM-504	SIGNAGE AND MARKINGS DETAILS		
105	CM-601	SUMMARY OF SMALL SIGNS		
106	CE-101	OVERALL EROSION AND SEDIMENT CONTROL PLAN		
107	CE-102	EROSION AND SEDIMENT CONTROL PLAN		
108	CE-103	EROSION AND SEDIMENT CONTROL PLAN		

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110	CE-105	EROSION AND SEDIMENT CONTROL PLAN	
111	CE-106	EROSION AND SEDIMENT CONTROL PLAN	
112	CE-107	EROSION AND SEDIMENT CONTROL PLAN	
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114	CE-109	EROSION AND SEDIMENT CONTROL PLAN	
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116	CE-502	EROSION AND SEDIMENT CONTROL NOTES AND DETAILS	
117	CS-001	TRAFFIC SIGNAL GENERAL NOTES	
118	CS-101	OVERALL SIGNALIZATION PLAN	
119	CS-102	SIGNALIZATION PLAN	
120	CS-103	SIGNALIZATION PLAN	
121	CS-501	TRAFFIC SIGNAL DETAILS	
122	CS-502	TRAFFIC SIGNAL DETAILS	
123	CS-503	TRAFFIC SIGNAL DETAILS	
124	CS-504	TRAFFIC SIGNAL DETAILS	
125	CS-601	TRAFFIC SIGNAL PROPOSED POLE SCHEDULE	
126	CS-602	TRAFFIC SIGNAL WIRING DIAGRAM	



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REVISIONS NO. DESCRIPTION DATE BY

GEORGE BUSH INTERCONTINENTAL AIRPORT (IAH)
KENSWICK DRIVE EXTENSION
SHEET INDEX

MES PROJECT MGR: DESIGNER: ALR ALR DRAWN BY: PMW CHECK BY: DATE:

05/08/2024



APPROVED BY:

DIRECTOR HOUSTON AIRPORT SYSTEM

PROJECT NO.

100072032

C.I.P. NO.

H.A.S. NO. 935 SHEET NO.

		SUMMARY OF QUANTITIES		
BID ITEM #	SPEC REF. #	BID ITEM DESCRIPTION	UNIT	QUANTI
1	1502-100	MOBILIZATION	LS	1
2	1554-100	INSTALLATION OR REPLACEMENT OF PERMANENT SIGNS	EA	37
3	1555-100	TRAFFIC CONTROL AND REGULATION	LS	1
4	1555-300	FLAGMEN	LS	1
5	1575-100	STABILIZED CONSTRUCTION ACCESS	SY	3195
6	2136-200	REMOVAL AND DISPOSAL OF POTENTIALLY PETROLEUM SOAKED SAND	CY	500
7	2221-252	REMOVE AND DISPOSE OF REINFORCED CONCRETE PAVEMENT, WITH OR WITHOUT ASPHALT OVERLAY	SY	2373
8	2221-252	REMOVE AND DISPOSE OF ASPHALTIC SURFACE WITH OR WITHOUT BASE	SY	470
9	2221-301	REMOVE EXISTING POLE FOUNDATION (SALVAGE SIGN)	EA	17
10	2233-100	CLEARING AND GRUBBING	AC	3
11	2315-100	ROADWAY EXCAVATION (ROADWAY / INFIELD AREAS)	СҮ	4725
12	2315-100	ROADWAY EXCAVATION (DETENTION BASIN)	СҮ	10491
13	2336-107	LIME STABILIZED SUBGRADE, 10-INCH	SY	9905
14	2336-200	LIME-FOR LIME STABILIZED SUBGRADE	TON	212
15	2711-100	TYPE A HOT MIX ASHPHALTIC BASE COURSE	TON	2610
16	2751-109	10-INCH REINFORCED CONCRETE PAVEMENT	SY	8715
17	2752-101	BOARD EXPANSION JOINT WITHOUT LOAD TRANSFER DEVICE	LF	11112
18	2762-100	REMOVE OF RAISED PAVEMENT MARKING ALL TYPES	LS	5585
	2762-200	BLAST CLEANING OF PAVEMENT (SYMBOLS AND LEGENDS)		
19	2762-205	BLAST CLEANING OF PAVEMENT MARKINGS (4-INCH LINES)	SF	12037
20		BLAST CLEANING OF PAVEMENT MARKINGS (4-INCH LINES)	LF	250
21	2762-206	, , , , , , , , , , , , , , , , , , ,	LF 	8
22	2762-207	BLAST CLEANING OF PAVEMENT MARKINGS (12-INCH LINES)	LF	10
23	2762-208	BLAST CLEANING OF PAVEMENT MARKINGS (24-INCH LINES)	LF	29
24	2767-405	THERMOPLASTIC PAVEMENT MARKING (4-INCH-WIDE) WHITE OR YELLOW	LF	5309
25	2767-406	THERMOPLASTIC PAVEMENT MARKING (6-INCH-WIDE) WHITE OR YELLOW	LF	4833
26	2767-408	THERMOPLASTIC PAVEMENT MARKING (12-INCH-WIDE) WHITE OR YELLOW	LF	1895
27	2767-409	THERMOPLASTIC PAVEMENT MARKING (24-INCH-WIDE) WHITE OR YELLOW	LF	250
28	2767-301	THERMOPLASTIC PAVEMENT MARKING, ELONGATED WORD "ONLY"	EA	8
29	2767-302	THERMOPLASTIC PAVEMENT MARKING, TURNING ARROWS	EA	29
30	2771-100	6-INCH CONCRETE CURB	LF	5207
31	2772-100	6-INCH CONCRETE MEDIAN	SY	1662
32	2775-105	4-1/2-INCH CONCRETE SIDEWALK	SF	156
33	2915-300	REMOVE, TEMPORARY STORE, AND REPLANT TREE	EA	13
		DRAINAGE / MANHOLE / SWPPP		
34	1570-101	FILTER FABRIC BARRIER	LF	2448
35	1570-109	INLET PROTECTION BARRIER	LF	600
36	2086-100	ADJUST EXISTING MANHOLE FRAME AND COVER TO NEW GRADE	EA	3
37	2221-200	REMOVE AND DISPOSE OF EXISTING MANHOLES	EA	4
38	2221-201	REMOVE AND DISPOSE OF EXISTING INLETS	EA	4
39	2221-500	REMOVE AND DISPOSE OF 15-INCH AND SMALLER STORM CULVERTS	LF	8
40	2221-520	REMOVE AND DISPOSE OF STORM SEWERS AND LEADS LESS THAN 24-INCH	LF	109
41	2221-521	REMOVE AND DISPOSE 24-INCH TO 36-INCH STORM SEWERS AND LEADS	LF	8
42	2221-522	REMOVE AND DISPOSE 42-INCH TO 54-INCH STORM SEWERS AND LEADS	LF	24
43	2221-523	REMOVE AND DISPOSE OF STORM SEWERS AND LEADS LARGER THAN 60-INCH	LF	8
44	2631-105	24-INCH DIAMETER RCP STORM SEWER BY OPEN CUT	LF	844
45	2631-109	42-INCH DIAMETER RCP STORM SEWER BY OPEN CUT	LF LF	8
45	2631-109	48-INCH DIAMETER RCP STORM SEWER BY OPEN CUT	LF LF	
	2631-110	60-INCH DIAMETER RCP STORM SEWER BY OPEN CUT		16
47			LF	8
48	2633-300	TYPE C-1 INLET (PRECAST)	EA	7
49	2633-600	TYPE E INLET (PRECAST)	EA	2
50	2633-900	JUNCTION BOX WITH LID OR GRATE FOR STORM SEWER (PRECAST)	EA	3
51	2633-801	HEADWALL INCLUDING PARALLEL WINGWALLS (PRECAST)	EA	2
52	2921-100	HYDRO MULCH SEEDING	SY	11396


BID ITEM #	SPEC REF. #	BID ITEM DESCRIPTION	UNIT	QUANTITY
		SIGNALIZATION / ELECTICAL*		
53	2582-203	35-FOOT GALVANIZED MAST ARM POLE WITH FOUNDATION	EA	1
54	2582-204	40-FOOT GALZANIZED MAST ARM POLE WITH FOUNDATION	EA	1
55	2582-205	45-FOOT GALZANIZED MAST ARM POLE WITH FOUNDATION	EA	2
56	2582-206	50-FOOT MAST ARM POLE ASSEMBLY AND FOUNDATION	EA	1
57	2582-207	55-FOOT GALZANIZED MAST ARM POLE WITH FOUNDATION		1
58	2893-01	REMOVE HIGH MAST ILLUMINATION	EA	2
59	2893-07	15 FT PEDESTRIAN PUSH BUTTON POLE WITH FOUNDATION	EA	5
60	2893-08	METERED PEDESTAL SERVICE UL TYPE 3R	EA	1
61	2893-11	STREET NAME SIGNS	EA	6
62	2893-13	ALUMINUM SIGN "RIGHT LANE MUST TURN RIGHT" SIGN R3-7R (30"X30")	EA	1
63	2893-14	ALUMINUM SIGN R3-5L (30"X36")	EA	5
64	16710-100	TYPE A PULL BOX WITH GRAVEL AND GROUND ROD	EA	14
65	16710-200	TYPE B PULL BOX WITH GRAVEL AND GROUND ROD	EA	9
66	16710-300	TYPE C PULL BOX WITH GRAVEL AND GROUND ROD	EA	1
67	16711-105	1-INCH PVC SCH.80 UNDERGROUND, EARTH	LF	80
68	16711-205	2-INCH PVC SCH.80 UNDERGROUND, EARTH	LF	2440
69	16711-305	3-INCH PVC SCH.80 UNDERGROUND, EARTH	LF	345
70	16711-405	4-INCH PVC SCH.80 UNDER PAVEMENT, BORE	LF	1475
71	16711-406	4-INCH PVC SCH.80 UNDERGROUND, EARTH		385
72	16713-105	VEHICLE PRE-FORMED LOOP DETECTOR, 6-FOOT BY 6-FOOT	EA	44
73	16715-300	3-SECTION VEHICLE SIGNAL HEAD ASSEMBLY 12" (HORIZONTAL) (RYG) WITH BACKPLAYE		17
74	16715-300	3-SECTION VEHICLE SIGNAL HEAD ASSEMBLY 12" (HORIZONTAL) (R <y<g), arrow="" backplate<="" td="" with=""><td>EA</td><td>3</td></y<g),>	EA	3
75	16715-300	3-SECTION VEHICLE SIGNAL HEAD ASSEMBLY 12" (VERTICAL) (R <y<g), arrow="" backplate<="" td="" with=""><td>EA</td><td>2</td></y<g),>	EA	2
76	16719-100	COUNTDOWN PEDESTRIAN SIGNAL MODULE	EA	6
77	16720	1/C #4 XHHW (POWER)	LF	0
78	16720	1/C #8 AWG BARE COPPER	LF	4715
79	16720	LOOP DETECTOR WIRE	LF	1345
80	16720-300	3/C-#14 AWG SOLID CABLE	LF	1660
81	16720-206	2/C-#10 AWG SOLID CABLE	LF	1020
82	16720-206	2/C-#12 AWG BARE CABLE	LF	1020
83	16720-505	5/C-#14 AWG SOLID CABLE	LF	1660
84	16720-705	7/C-#14 AWG SOLID CABLE	LF	5605
85	16724-100	EMERGENCY VEHICLE PREEMPTION	LS	1
86	16727-100	LOOP DETECTOR SAWCUT	LF	2161
87	16727-100	LOOP-LEAD-IN	LF	14750
88	16731-100	MODEL 2070 CONTROLLER UNIT (2070-F6330600S13)	EA	1
89	16732-100	UNITERRUPTIBLE POWER SUPPLY	EA	1
90	16738-100	WIRELESS COMMUNICATION SYSTEM (CELLULAR)	EA	1
		"POLARA NAVIGATOR ACCESSIBLE PEDESTRIAN PUSH BUTTON STATION		
91	16750	ON TRAFFIC (R) & PEDESTRIAN SIGNAL POLES"	EA	4
92	16750	"POLARA NAVIGATOR ACCESSIBLE PEDESTRIAN PUSH BUTTON STATION ON TRAFFIC (L) & PEDESTRIAN SIGNAL POLES"	EA	2
93	16750-100	ACCESSIBLE PEDESTRIAN PUSH BUTTON STATION	EA	1



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REVISIONS NO. DESCRIPTION DATE BY

PROJECT MGR: MES ALR DESIGNER: ALR DRAWN BY: CHECK BY: PMW

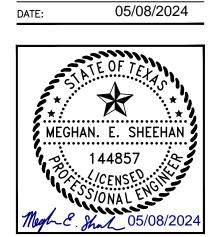

APPROVED BY:

PROJECT NO.

100072032 A.I.P. NO.

H.A.S. NO.

SHEET NO.

- 2. THE CONTRACTOR SHALL FIELD VERIFY EXISTING CONDITIONS PRIOR TO COMMENCING WORK. SHOULD THE CONTRACTOR DISCOVER ANY CONDITIONS NOT REFLECTED WITHIN THE PROJECT DOCUMENTS, HE SHALL NOTIFY THE HAS REPRESENTATIVE IMMEDIATELY.
- 3. THE PROJECT PAY ITEMS SHALL BE INCLUSIVE OF ALL WORK TO BE PERFORMED AS SHOWN IN THESE PROJECT PLANS. WORK NOT IDENTIFIED WITH A SPECIFIC PAY ITEMS SHALL BE INCLUDED, UNLESS OTHERWISE STATED IN APPLICABLE SPECIFICATION, IN THE COST OF THE PROJECT PAY ITEMS OF WHICH IT IS A COMPONENT.
- 4. THE LOCATION FOR THE CONTRACTOR'S STAGING AREA AND HAUL ROUTE IS INDICATED ON SHEET G-006. THE CONTRACTOR IS RESPONSIBLE FOR SECURING ALL UTILITY CONNECTIONS AND SERVICE TO AND WITHIN THE STAGING AREA AS MAY BE NECESSARY. THE CONTRACTOR SHALL PROVIDE SECURITY, FENCING OR BARRICADES AROUND THE STAGING AREA(S) AS NEEDED. THE CONTRACTOR SHALL RESTORE THE STAGING AREA UPON PROJECT COMPLETION, INCLUDING REPAIR OF EXISTING FACILITIES, REMOVAL OF INSTALLED UTILITIES, REGRADING, TOP SOILING AND RESEEDING, COMPLETE AND TO THE SATISFACTION OF THE ENGINEER AND AIRPORT MANAGER. THE WORK ASSOCIATED WITH ESTABLISHING, MAINTAINING, DEMOBILIZING AND RESTORING THE CONTRACTOR'S STAGING AREA IS INCIDENTAL AND NOT MEASURED FOR SEPARATE PAYMENT.
- 5. ACCESS TO THE PROJECT SITE TO/FROM THE STAGING AREA SHALL BE VIA THE ROUTE SHOWN ON SHEET G-006.
- 6. THE CONTRACTOR SHALL SECURE MATERIALS STOCKPILED WITHIN THE CONSTRUCTION AREA TO PREVENT ITS MOVEMENT OR EROSION RESULTING FROM WIND CONDITION AND/OR RAINFALL. THE CONTRACTOR IS RESPONSIBLE FOR THE IMMEDIATE CLEANUP OF ANY DEBRIS ON PAVEMENTS WITHIN OR ADJACENT TO THE PROJECT WORK AREA. THE CONTRACTOR SHALL SWEEP AND/OR VACUUM ALL PAVEMENT AREAS AFFECTED BY THE WORK ON A DAILY BASIS. IN ADDITION, THE CONTRACTOR SHALL SWEEP/CLEAN PAVED ROADWAYS ALONG THE PROJECT HAUL ROUTES AND IMMEDIATELY CLEAN UP MUD, DEBRIS OR CONSTRUCTION MATERIALS FALLING ON ANY PAVEMENTS OUTSIDE OF THE LIMITS OF CONSTRUCTION OR RESULTING FROM HIS HAULING ACTIVITIES.
- 7. THE CONTRACTOR SHALL COMPLY WITH ALL LOCAL, STATE AND FEDERAL LAWS AND REGULATIONS THAT ARE PERTINENT TO THIS WORK. IT IS THE CONTRACTOR'S RESPONSIBILITY TO OBTAIN, MAINTAIN AND PAY ALL COSTS ASSOCIATED WITH ANY PERMITS AND LICENSES REQUIRED TO ACCOMPLISH THE WORK. THESE COSTS ARE INCIDENTAL TO THE WORK AND WILL NOT BE PAID FOR SEPARATELY.
- 8. MATERIAL PRODUCED AS A RESULT OF THE CONTRACTOR'S OPERATIONS THAT ARE NOT OTHERWISE USEABLE BY HAS SHALL BE DISPOSED OF OFF HAS PROPERTY IN ACCORDANCE WITH FEDERAL, STATE AND LOCAL REGULATIONS. THERE WILL BE NO SEPARATE PAY ITEM FOR WASTE MATERIAL DISPOSAL.
- 9. WHERE THE FOLLOWING ITEMS ARE CALLED FOR REMOVAL, THEY SHALL BE SALVAGED AND TURNED OVER TO HAS:

 a. SIGNS
- 10. MECHANICAL SWEEPER AND/OR VACUUM TRUCK SHALL BE ON-SITE AT ALL TIMES TO CLEAN ANY DEBRIS OFF THE ROADWAY PAVEMENTS FOR THE DURATION OF ALL CONSTRUCTION ACTIVITIES.
- 11. CONTRACTOR SHALL BE RESPONSIBLE FOR COORDINATION OF ACTIVITIES WITH THE APPROPRIATE ENTITY, INCLUDING BUT NOT LIMITED TO HAS, AND CITY OF HOUSTON.
- 12. CONTRACTOR SHALL REFER TO THE PROJECT MANUAL VOLUME 2 FOR EMPLOYEE PARKING, TEMPORARY SAFETY ITEMS, AND OTHER INFORMATION NECESSARY TO COMPLETE THE PROJECT.
- 13. CONTRACTOR TO MAINTAIN TREES FOR A PERIOD OF 24 MONTHS AFTER COMPLETION OF CONSTRUCTION. CONTRACTOR SHALL WATER TREES DURING THE MAINTENANCE PERIOD.

PHASING NOTES

- 1. THE GENERAL INTENT OF THE CONSTRUCTION PHASING IS TO MINIMIZE THE CLOSURE OF ROADWAYS, REDUCE CONSTRUCTION DURATION AND DECREASE DISRUPTIONS TO OPERATIONS. SHOP DRAWINGS, MATERIAL AND EQUIPMENT SHALL BE PROCURED PRIOR TO COMMENCEMENT OF CONSTRUCTION ACTIVITIES.
- 2. PROCUREMENT PHASE (PHASE 0): PRIOR TO COMMENCEMENT OF PHASE A CONSTRUCTION, THERE WILL BE A PROCUREMENT PHASE. WITHIN THE PROCUREMENT PHASE THE CONTRACTOR SHALL SUBMIT ALL SHOP DRAWINGS REQUIRED BY THE SPECIFICATIONS SUCH THAT ALL SUBMITTALS CAN BE APPROVED PRIOR TO COMMENCEMENT OF THE INSTALLATION OF THE EROSION CONTROL DEVICES IDENTIFIED IN THE STORM WATER POLLUTION PREVENTION PLAN AND DETAILED IN EROSION AND SEDIMENT CONTROL PLANS ON SHEET CE-101 (SWPPP); ESTABLISHING HIS ACCESS/HAUL ROUTES. ESTABLISHING THE STAGING AREA; INSTALL AND HAVE INSPECTED ALL TRAFFIC CONTROL DEVICES; CONSTRUCT HAUL ROAD.
 - A. SWPPP: PRIOR TO THE START OF CONSTRUCTION PHASE A, THE CONTRACTOR SHALL IMPLEMENT, INSTALL, AND AND HAVE INSPECTED ALL THE EROSION CONTROL DEVICES FOR THE APPLICABLE PHASES OF CONSTRUCTION PER THE SWPPP AS OUTLINED ON THE EROSION CONTROL PLANS.
 - B. TRAFFIC CONTROL: ONLY THE CONSTRUCTION LIMITS AND ADJACENT ROADWAY/TRAVEL LANE, AS DEPICTED ON THE SITE LAYOUT AND ACCESS PLAN, WILL BE CLOSED TO TRAFFIC. THE CONTRACTOR SHALL DEVELOP AND SUBMIT A TRAFFIC CONTROL PLAN FOR ASSOCIATED LANE CLOSERS AND TRAFFIC BARRICADE REQUIREMENTS TO HAS FOR REVIEW AND APPROVED PRIOR TO PHASE O. TRAFFIC CONTROL PLAN SHALL BE SIGNED AND SEALED BY LICENSED TEXAS PE.
 - C. HAUL ROAD: SUBSEQUENT TO THE INSTALLATION OF THE EROSION CONTROL AND TRAFFIC CONTROL DEVICES, THE CONTRACTOR SHALL CONSTRUCT THE HAUL ROAD GENERALLY AS SHOWN ON THE SITE LAYOUT AND ACCESS PLAN. THE ENTIRE LENGTH OF THE HAUL ROAD SHALL BE CONSTRUCTED DURING PHASE O. THE COST OF THE HAUL ROAD IS INCIDENTAL TO THE TRAFFIC CONTROL PAY ITEM.
 - D. THE PROJECT PHASES SHALL BE DIVIDED BETWEEN WORK WITHIN KENSWICK DRIVE, WILL CLAYTON PARKWAY, AND LEE ROAD RIGHT OF WAY (ROW) AND WORK OUTSIDE OF KENSWICK DRIVE, WILL CLAYTON PARKWAY, AND LEE ROAD ROW. ALL WORK WITHIN THE ROW WILL REQUIRE COORDINATION WITH HAS PRIOR TO BEGINNING. WORK INSIDE THE ROW WILL COMMENCE WITH THE INSTALLATION OF TRAFFIC CONTROL DEVICES AND SIGNAGE AS IDENTIFIED IN THE CONSTRUCTION SAFETY PHASING PLAN. THE CONTRACTOR WILL HAVE THE LATITUDE TO SCHEDULE WORK AND INSTALL TRAFFIC CONTROL DEVICES/BARRICADES, AS APPROPRIATE, FOR CONSTRUCTION ACTIVITIES OUTSIDE THE ROW WHEN WORKING ON OTHER AREAS.
- 3. ALL CONTRACTOR VEHICLES AND TRAFFIC SHALL REMAIN WITHIN THE LIMITS OF THE CONSTRUCTION AREA, STAGING AREA, OR HAUL ROUTES UNLESS OTHERWISE DIRECTED BY THE HOUSTON AIRPORT SYSTEM (HAS) OPERATIONS.

CENTERPOINT ENERGY NOTES:

CAUTION: UNDERGROUND GAS FACILITIES

THE CONTRACTOR SHALL CONTACT THE UTILITY COORDINATING COMMITTEE AT 1-800-545-6005 OR 811 A MINIMUM OF 48 HOURS PRIOR TO CONSTRUCTION TO HAVE MAIN AND SERVICE LINES FIELD LOCATED.

- WHEN CENTERPOINT ENERGY PIPE LINE MARKINGS ARE NOT VISIBLE, CALL (713) 207-5463 OR (713) 945-8037 (7:00 A.M. TO 4:30 P.M.) FOR STATUS OF LINE LOCATION REQUEST BEFORE EXCAVATION BEGINS.
- WHEN EXCAVATING WITHIN EIGHTEEN INCHES (18") OF THE INDICATED LOCATION OF CENTERPOINT ENERGY FACILITIES, ALL EXCAVATION MUST BE ACCOMPLISHED USING NON-MECHANIZED EXCAVATION PROCEDURES.
- WHEN CENTERPOINT ENERGY FACILITIES ARE EXPOSED, SUFFICIENT SUPPORT MUST BE PROVIDED TO THE FACILITIES TO PREVENT EXCESSIVE STRESS ON THE PIPING.
- FOR EMERGENCIES REGARDING GAS LINES CALL (713) 659-2111 OR (713) 207-4200.

THE CONTRACTOR IS FULLY RESPONSIBLE FOR ANY DAMAGES CAUSED BY HIS FAILURE TO EXACTLY LOCATE AND PRESERVE THESE UNDERGROUND FACILITIES.

WARNING: OVERHEAD ELECTRICAL LINES

OVERHEAD LINES MAY EXIST ON THE PROPERTY. THE LOCATION OF OVERHEAD LINES HAS NOT BEEN SHOWN ON THESE DRAWINGS AS THE LINES ARE CLEARLY VISIBLE, BUT YOU SHOULD LOCATE THEM PRIOR TO BEGINNING ANY CONSTRUCTION. TEXAS LAW, SECTION 752, HEALTH & SAFETY CODE FORBIDS ACTIVITIES THAT OCCUR IN CLOSE PROXIMITY TO HIGH VOLTAGE LINES, SPECIFICALLY:

- ANY ACTIVITY WHERE PERSON OR THINGS MAY COME WITHIN SIX(6) FEET OF LIVE OVERHEAD HIGH VOLTAGE LINES; AND
- OPERATING A CRANE, DERRICK, POWER SHOVEL, DRILLING RIG, PILE DRIVER, HOISTING EQUIPMENT, OR SIMILAR APPARATUS WITHIN 10 FEET OF LIVE OVERHEAD HIGH VOLTAGE LINES.

PARTIES RESPONSIBLE FOR THE WORK, INCLUDING CONTRACTORS ARE LEGALLY RESPONSIBLE FOR THE SAFETY OF CONSTRUCTION WORKERS UNDER THIS LAW. THIS LAW CARRIES BOTH CRIMINAL AND CIVIL LIABILITY. TO ARRANGE FOR LINES TO BE TURNED OFF OR REMOVED CALL CENTERPOINT ENERGY AT (713) 207-2222.

ACTIVITIES ON/OR ACROSS CENTERPOINT ENERGY FEE OR EASEMENT PROPERTY

NO APPROVAL TO USE, CROSS OR OCCUPY CENTERPOINT FEE OR EASEMENT PROPERTY IS GIVEN. IF YOU NEED TO USE CENTERPOINT PROPERTY, PLEASE CONTACT OUR SURVEYING & RIGHT OF WAY DIVISION AT (713) 207-6348 OR (713) 207-5769.

WARNING: UNDERGROUND ELECTRICAL UTILITIES

THE CONTRACTOR SHALL CONTACT THE UTILITY COORDINATING COMMITTEE AT 1-800-545-6005 OR 811 A MINIMUM OF 48 HOURS PRIOR TO CONSTRUCTION TO HAVE MAIN AND SERVICE LINES FIELD LOCATED.

- ALL INFORMATION CONCERNING TYPE AND LOCATION OF UNDERGROUND UTILITIES IS NOT GUARANTEED TO BE ACCURATE OR ALL INCLUSIVE. THE CONTRACTORS ARE RESPONSIBLE MAKING THEIR OWN DETERMINATIONS AS TO TYPE AND LOCATION OF UNDERGROUND UTILITIES AS MAY BE NECESSARY TO AVOID DAMAGE THERETO. THE CONTRACTOR SHALL VERIFY LOCATION OF UNDERGROUND PIPELINES, CONDUITS, AND STRUCTURES BY CONTACTING OWNERS OF UNDERGROUND UTILITIES OR BY EXCAVATING IN ADVANCE OF CONSTRUCTION.
- THE CONTRACTOR IS RESPONSIBLE FOR DETERMINING THE EXACT LOCATION OF ALL UTILITIES WHEN AND WHERE THEY FALL IN THE PATH OF CONSTRUCTION.
- THE CONTRACTOR IS ALSO RESPONSIBLE FOR CONTACTING THE UTILITY COORDINATING COMMITTEE AT (713) 223-4567 AND TEXAS ONE CALL AT 1-800-245-4545, FORTY-EIGHT (48) HOURS PRIOR TO ANY CONSTRUCTION.
- THE LOCATION OF ANY CENTERPOINT ENERGY UTILITIES ARE SHOWN IN APPROXIMATE WAY ONLY. THE CONTRACTOR SHALL DETERMINE THE EXACT LOCATION BEFORE COMMENCING WORK. THEY AGREE TO BE FULLY RESPONSIBLE FOR ANY AND ALL DAMAGES WHICH MIGHT BE OCCASIONED BY THIS FAILURE TO EXACTLY LOCATE AND PRESERVE THESE UNDERGROUND UTILITIES.
- ALL PROPOSED FACILITIES SHALL MAINTAIN 12" CLEAR FROM ALL EXISTING UTILITIES.

AT&T TEXAS/SWBT FACILITIES

- 1. THE LOCATIONS OF AT&T TEXAS/SWBT FACILITIES ARE SHOWN IN AN APPROXIMATE WAY ONLY. THE CONTRACTOR SHALL DETERMINE THE EXACT LOCATION BEFORE COMMENCING WORK. HE AGREES TO BE FULLY RESPONSIBLE FOR ANY AND ALL DAMAGES WHICH MIGHT BE OCCASIONED BY THIS FAILURE TO EXACTLY LOCATE AND PRESERVE THESE UNDERGROUND UTILITIES.
- 2. THE CONTRACTOR SHALL CALL 1-800-344-8377 (TEXAS 811) A MINIMUM OF 48 HOURS PRIOR TO CONSTRUCTION TO HAVE UNDERGROUND LINES FIELD LOCATED.
- 3. WHEN EXCAVATING WITHIN EIGHTEEN INCHES (18") OF THE INDICATED LOCATION OF AT&T TEXAS/SWBT FACILITIES, ALL EXCAVATIONS MUST BE ACCOMPLISHED USING NON-MECHANIZED EXCAVATION PROCEDURES. WHEN BORING, THE CONTRACTOR SHALL EXPOSE THE AT&T TEXAS/SWBT FACILITIES.
- 4. WHEN AT&T TEXAS/SWBT FACILITIES ARE EXPOSED, THE CONTRACTOR WILL PROVIDE SUPPORT TO PREVENT DAMAGE TO THE CONDUIT DUCTS OR CABLES. WHEN EXCAVATING NEAR TELEPHONE POLES THE CONTRACTOR SHALL BRACE THE POLE FOR SUPPORT.
- 5. THE PRESENCE OR ABSENCE OF AT&T TEXAS/SWBT UNDERGROUND CONDUIT FACILITIES OR BURIED CABLE FACILITIES SHOWN ON THESE PLANS DOES NOT MEAN THAT THERE ARE NO DIRECT BURIED CABLES OR OTHER CABLES IN CONDUIT IN THE AREA.
- 6. PLEASE CONTACT THE AT&T TEXAS DAMAGE
 PREVENTION MANAGER KEVIN RAY AT (713) 614-1983
 OR E-MAIL HIM AT kr7896@att.com IF CABLE LOCATE
 REQUESTS ARE NOT COMPLETED FOR OUR AT&T
 TEXAS/SWBT FACILITIES.

HOUSTON AIRPORT SYSTEM

ATKINS

LOCAL OFFICE:
920 MEMORIAL CITY WAY.
STE. 400
HOUSTON, TX 77024
TEL: (713) 576-8500
ATKINS NORTH
AMERICA PE FIRM REG.

REVISIONS

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CITY OF HOUSTON
HOUSTON AIRPORTS SYSTEM
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DESIGNER: ALR

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DIRECTOR HOUSTON AIRPORT SYSTEM	

PROJECT NO.

100072032

A.I.P. NO.

C.I.P. NO.

H.A.S. NO.
935
SHEET NO.

G-004

BC BACK OF CURB
COH CITY OF HOUSTON
DR DRIVE
E EAST

E EAST
EB EAST BOUND
EOP EDGE OF PAVEMENT
FL FLOW LINE

HAS HOUSTON AIRPORT SYSTEMS
N NORTH

NB NORTH BOUND
PKWY PARKWAY
RCP REINFORCED CONCRETE PIPE

RD ROAD
S SOUTH
SB SOUTH BOUND
SWPPP STORMWATER POLLUTION PREVENTION PLAN

TYP. TYPICAL
W WEST
WB WEST BOUND
WCR WHEELCHAIR RAMP



ATKINS LOCAL OFFICE: 920 MEMORIAL CITY WAY.

STE. 400 HOUSTON, TX 77024 TEL: (713) 576-8500 ATKINS NORTH AMERICA PE FIRM REG. #F-000474

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100072032 A.I.P. NO.

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H.A.S. NO.

935 SHEET NO.

- 3. MATERIALS AND EQUIPMENT DELIVERIES ARE RESTRICTED DURING WEEKDAYS FROM 7:00AM - 9:00AM AND 4:00PM -6:00PM UNLESS DELIVERED DIRECTLY TO THE STAGING YARD VIA ACCESS ON THE CLOSED TURN AROUND ROAD.
- COMPLETION OF CONSTRUCTION. SEE DEMOLITION PLANS.
- EXISTING TURN AROUND TO BE CLOSED TO THE PUBLIC FOR THE DURATION OF THE PROJECT.

PE. THE CONTRACTOR MAY

PHASING PLAN AS SHOWN.

MODIFY OR DEVIATE FROM THE



ATKINS LOCAL OFFICE:

920 MEMORIAL CITY WAY. STE. 400 HOUSTON, TX 77024 TEL: (713) 576-8500 ATKINS NORTH AMERICA PE FIRM REG. #F-000474

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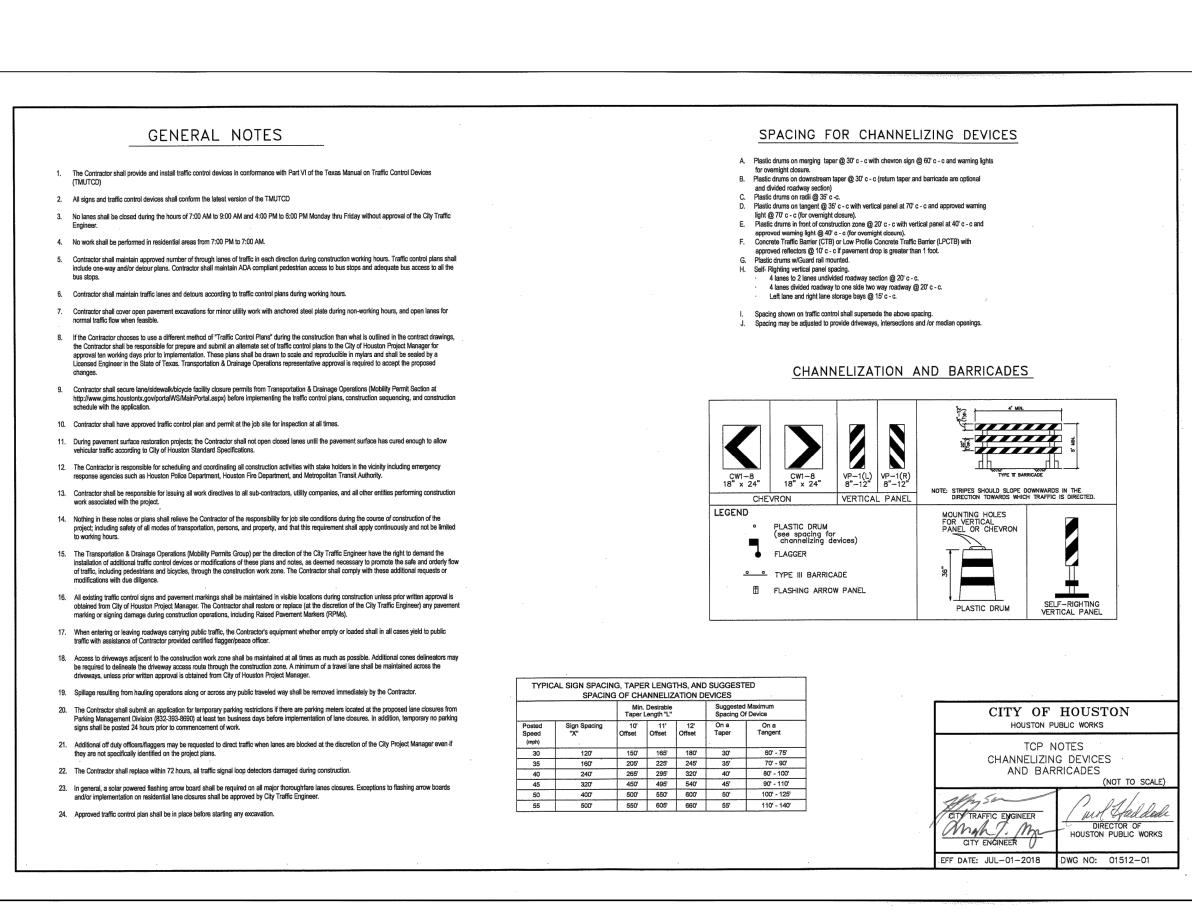
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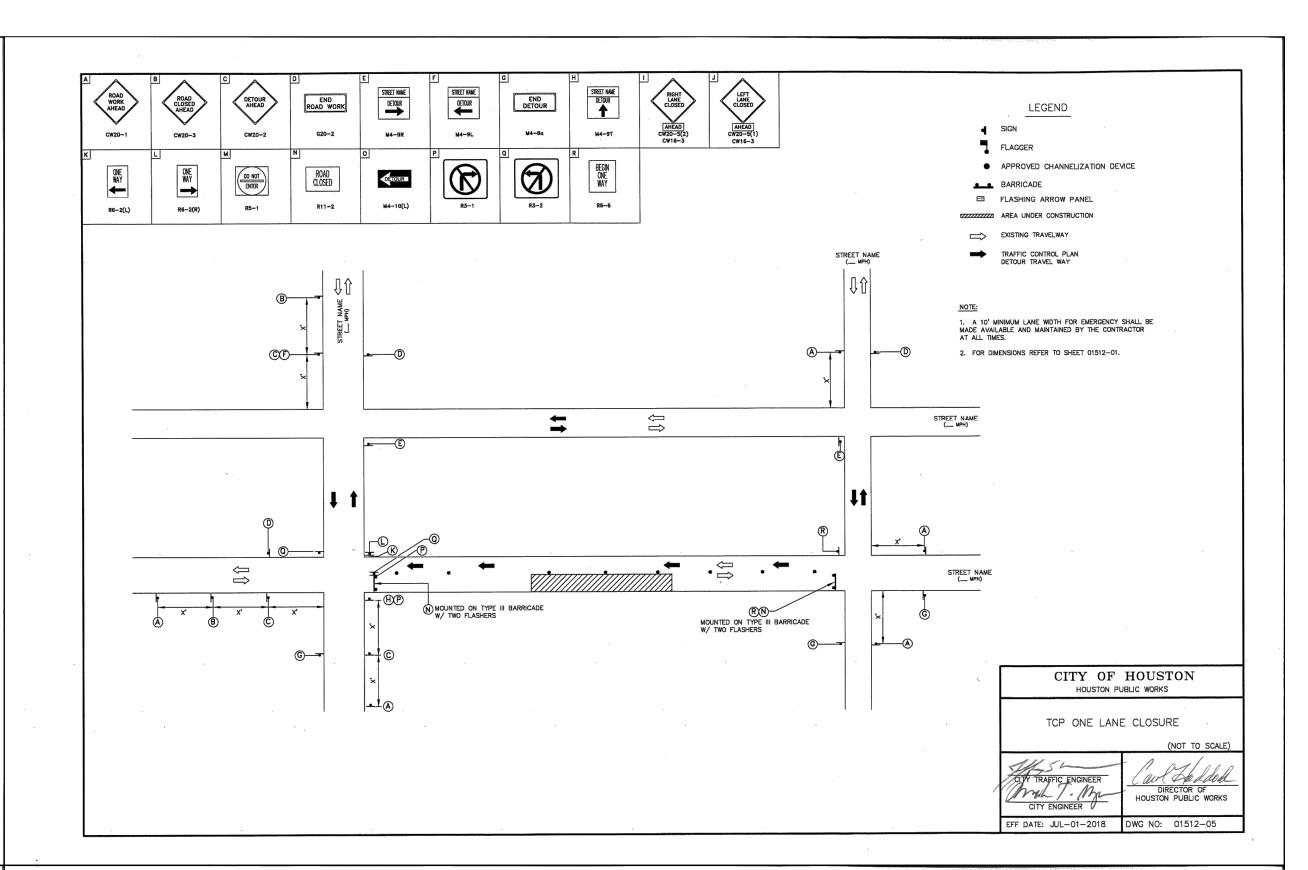
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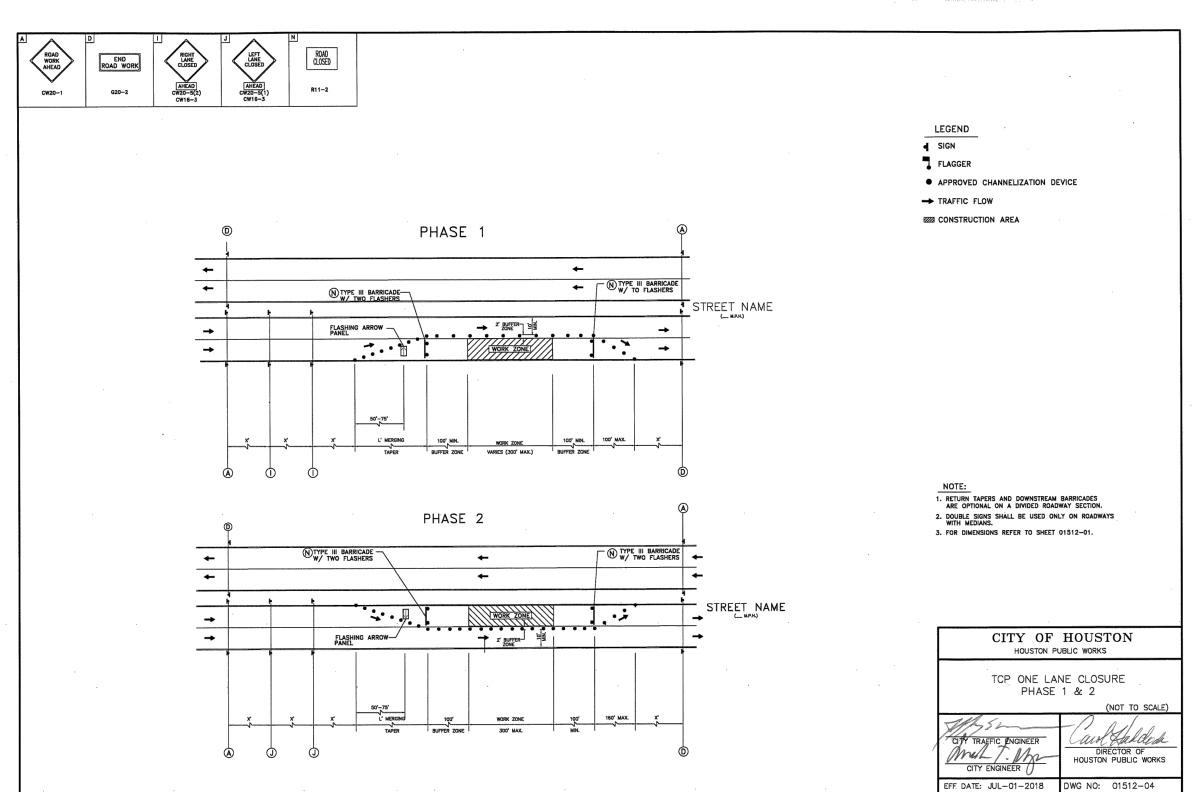
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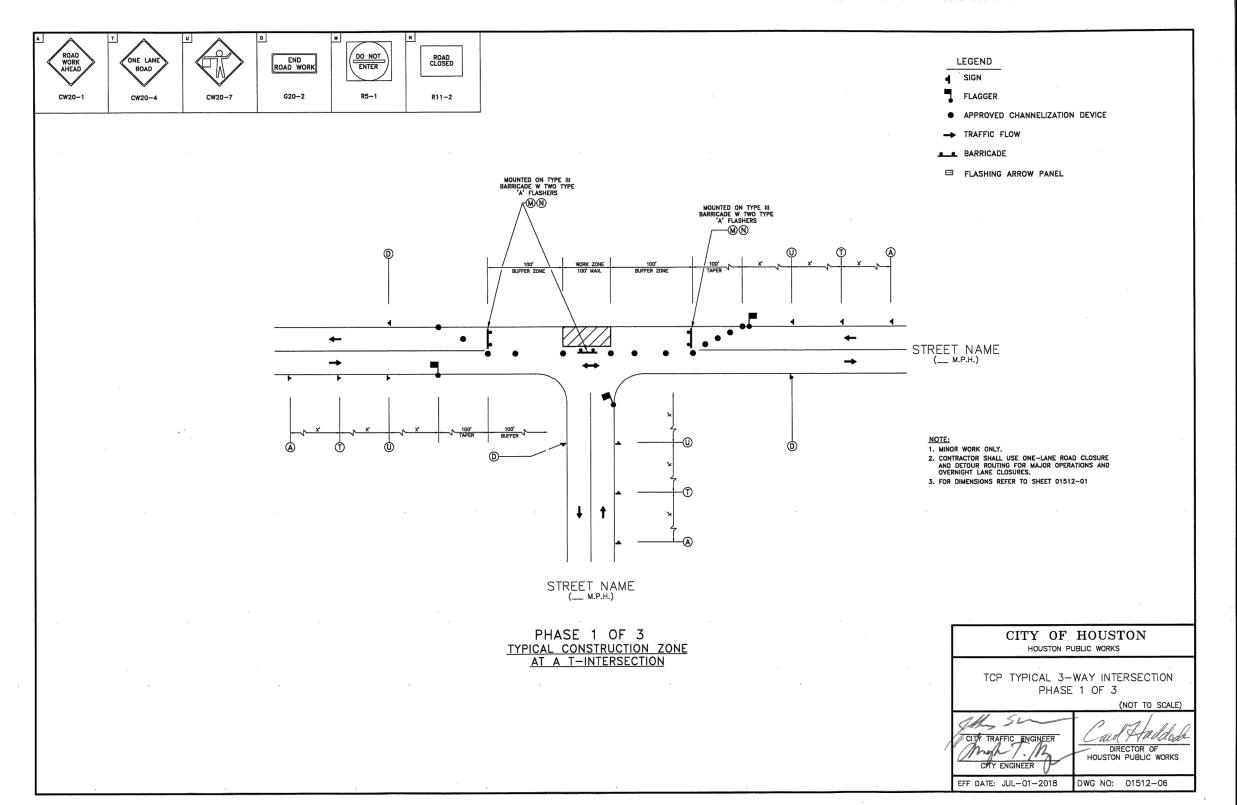
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HOUSTON AIRPORT SYSTEM

GEORGE BUSH INTERCONTINENTAL AIRPORT /

ATKINS

LOCAL OFFICE:
920 MEMORIAL CITY WAY.
STE. 400
HOUSTON, TX 77024
TEL: (713) 576-8500
ATKINS NORTH
AMERICA PE FIRM REG.
#F-000474

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DATE:

DIRECTOR HOUSTON AIRPORT SYSTEM
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C.I.P. NO.

H.A.S. NO.





920 MEMORIAL CITY WAY. STE. 400 HOUSTON, TX 77024 TEL: (713) 576-8500 ATKINS NORTH AMERICA PE FIRM REG. #F-000474

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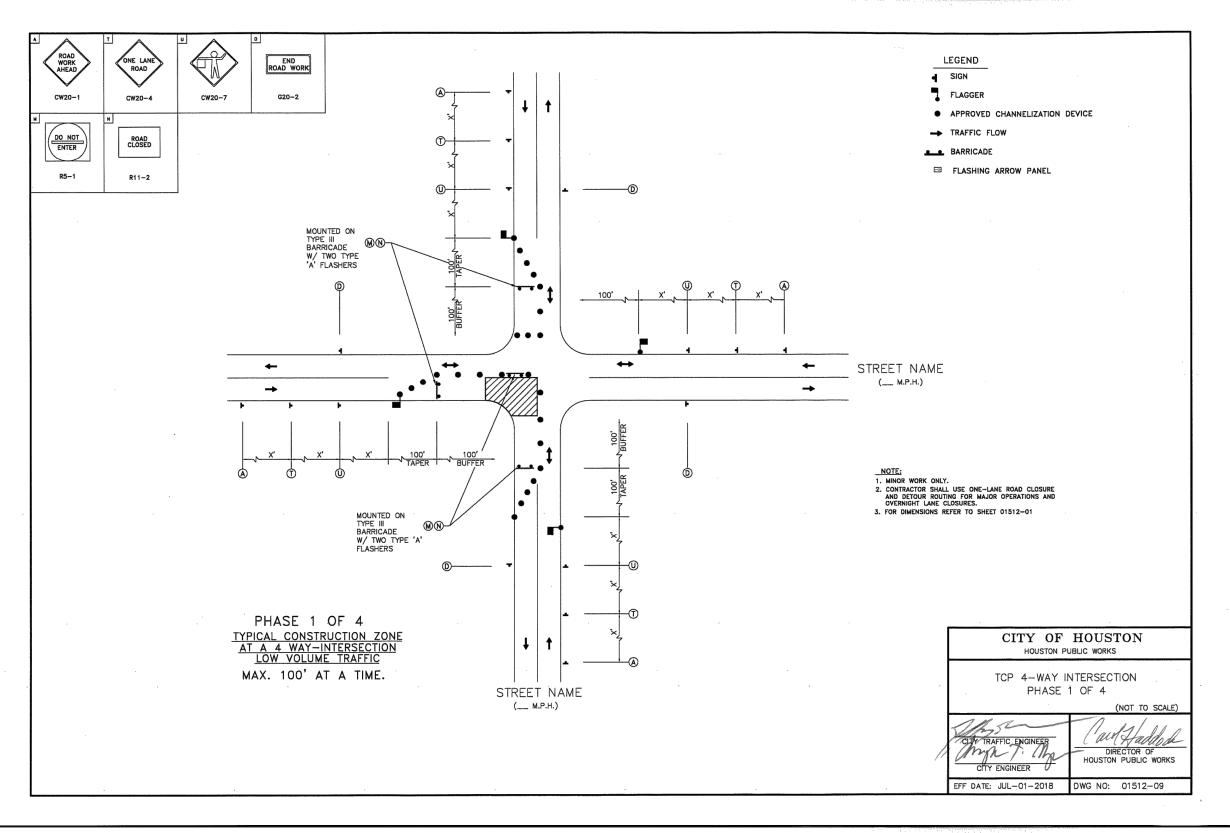
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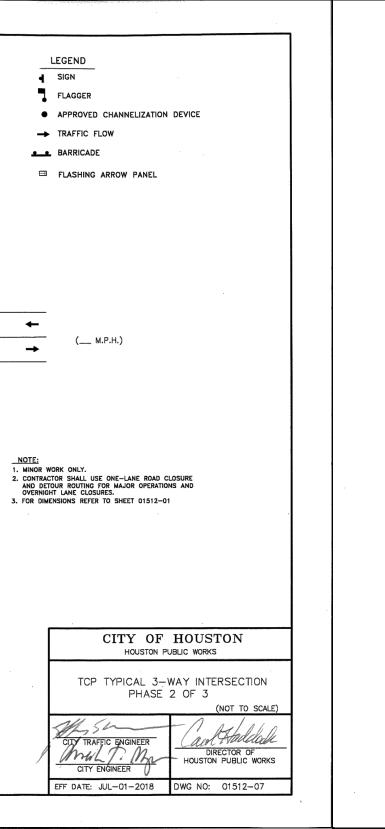
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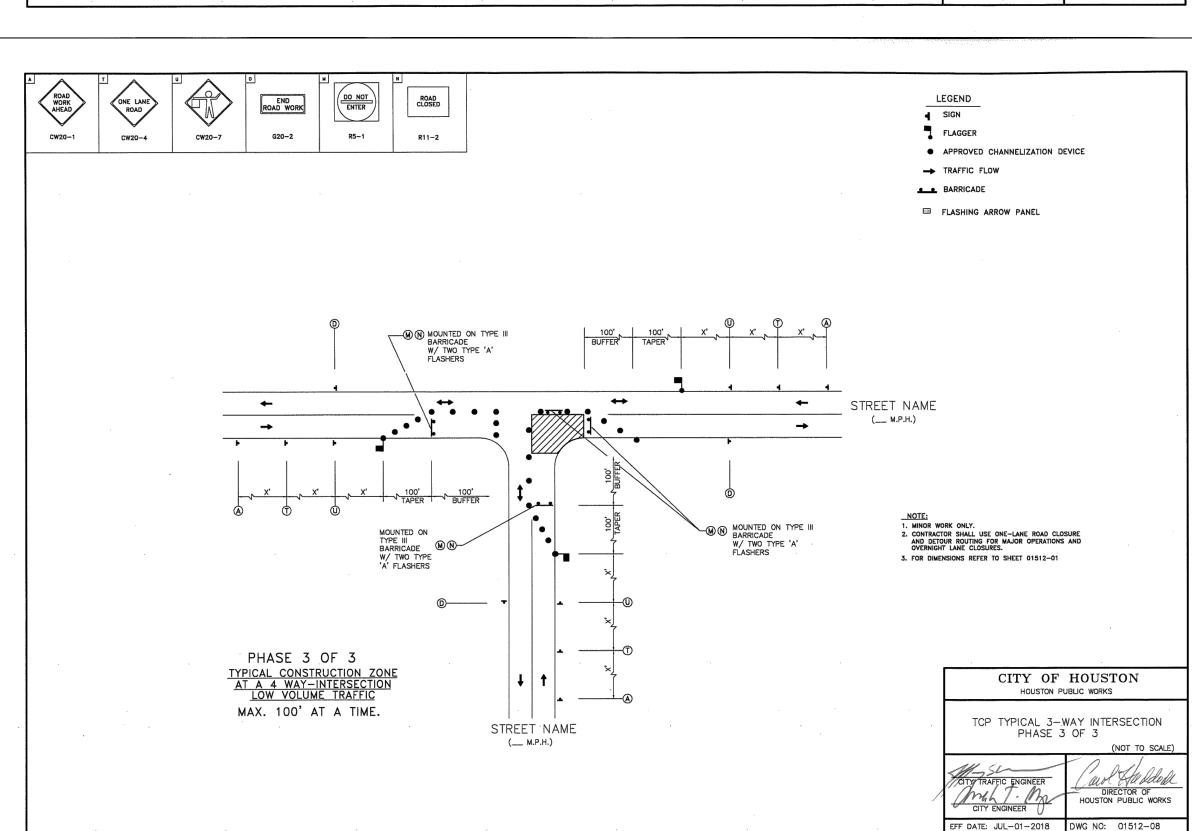
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ROAD CLOSED

MOUNTED ON TYPE III BARRICADE W/ TWO TYPE 'A' FLASHERS


MOUNTED ON TYPE III BARRICADE W/ TWO TYPE 'A' FLASHERS


PHASE 2 OF 3

TYPICAL CONSTRUCTION ZONE
FOR CONSTRUCTION AT A T-INTERSECTION
(NEAR SIDE - LEFT LANE CLOSURE)

MAX. 100' AT A TIME.

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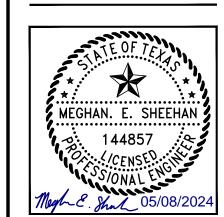

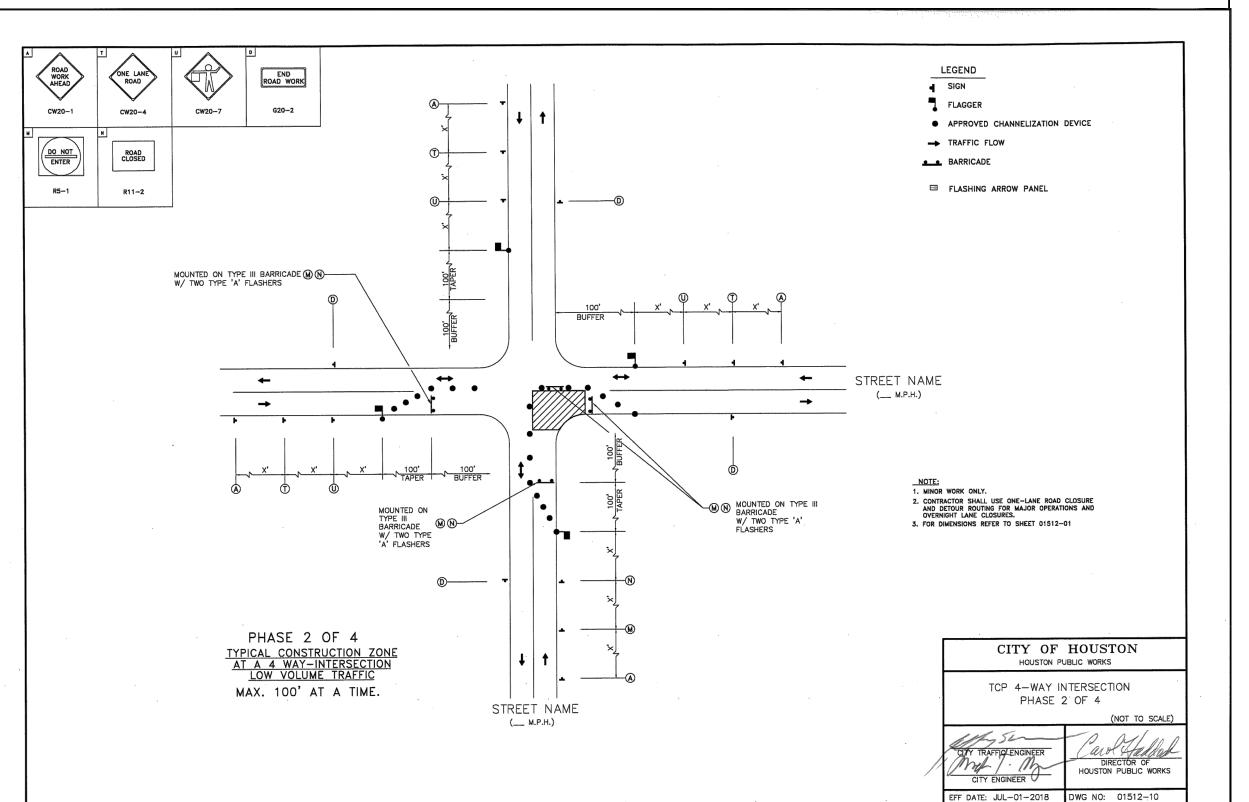
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920 MEMORIAL CITY WAY. STE. 400 HOUSTON, TX 77024 TEL: (713) 576-8500 ATKINS NORTH AMERICA PE FIRM REG. #F-000474
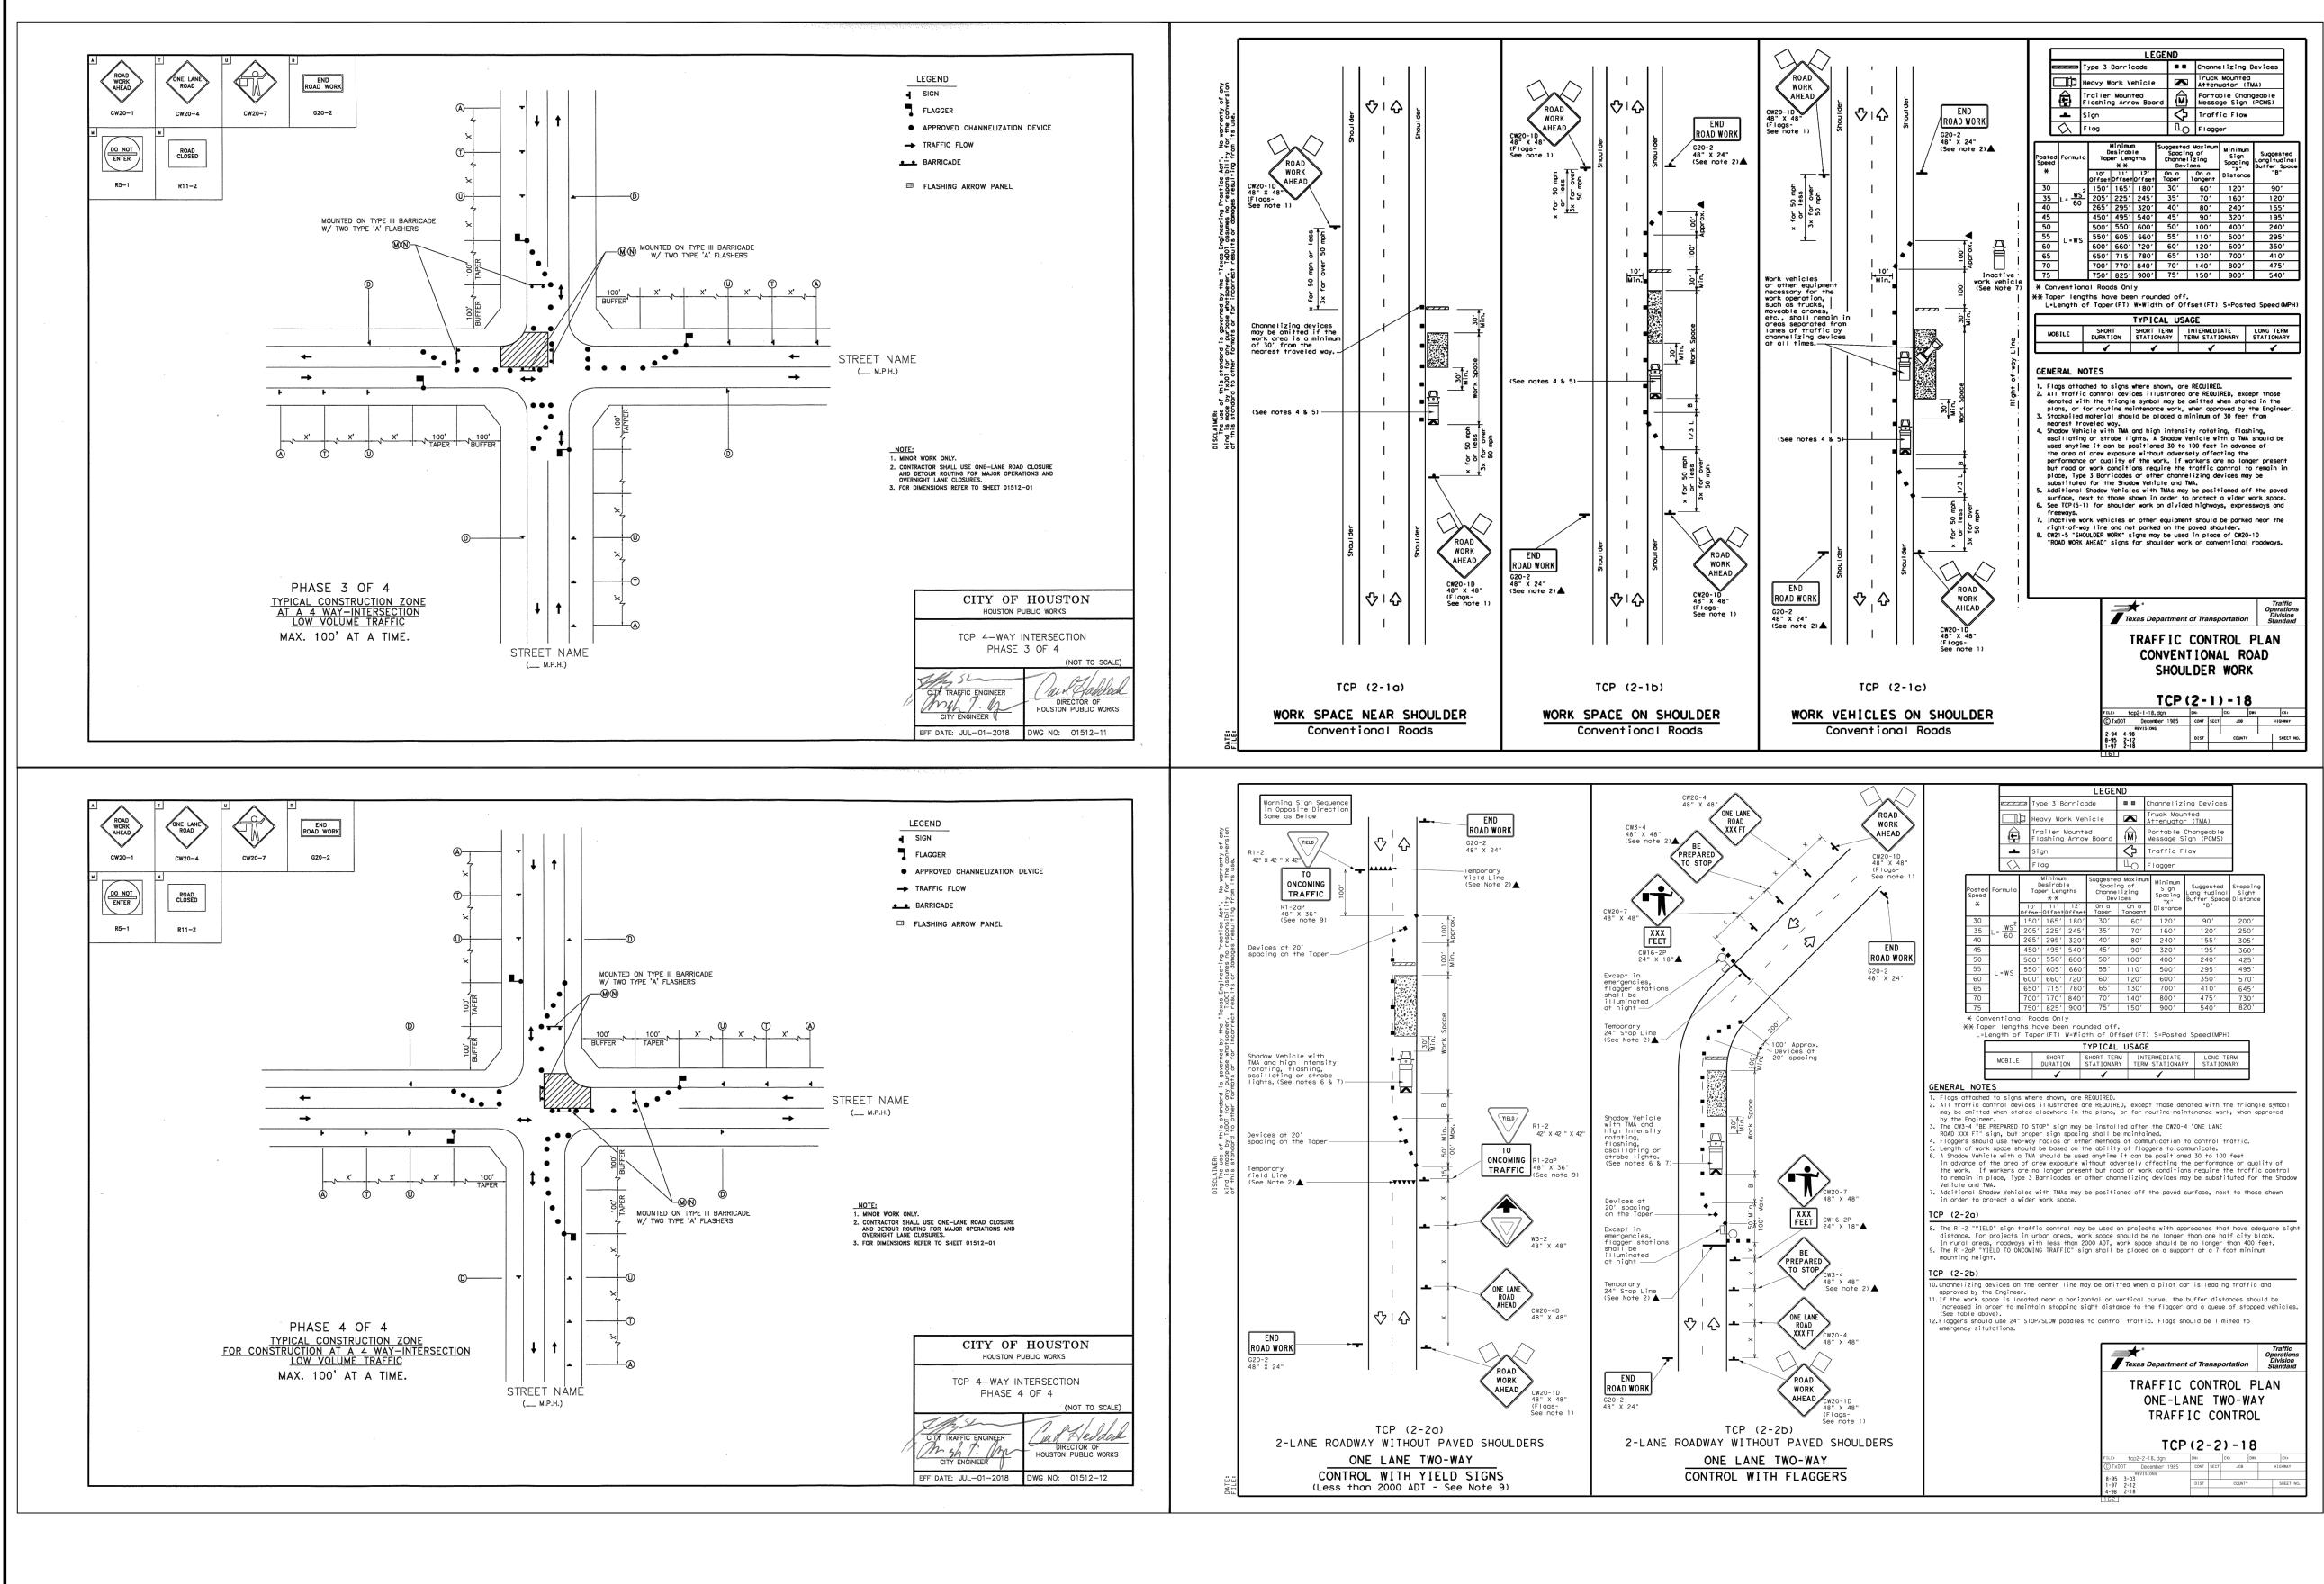
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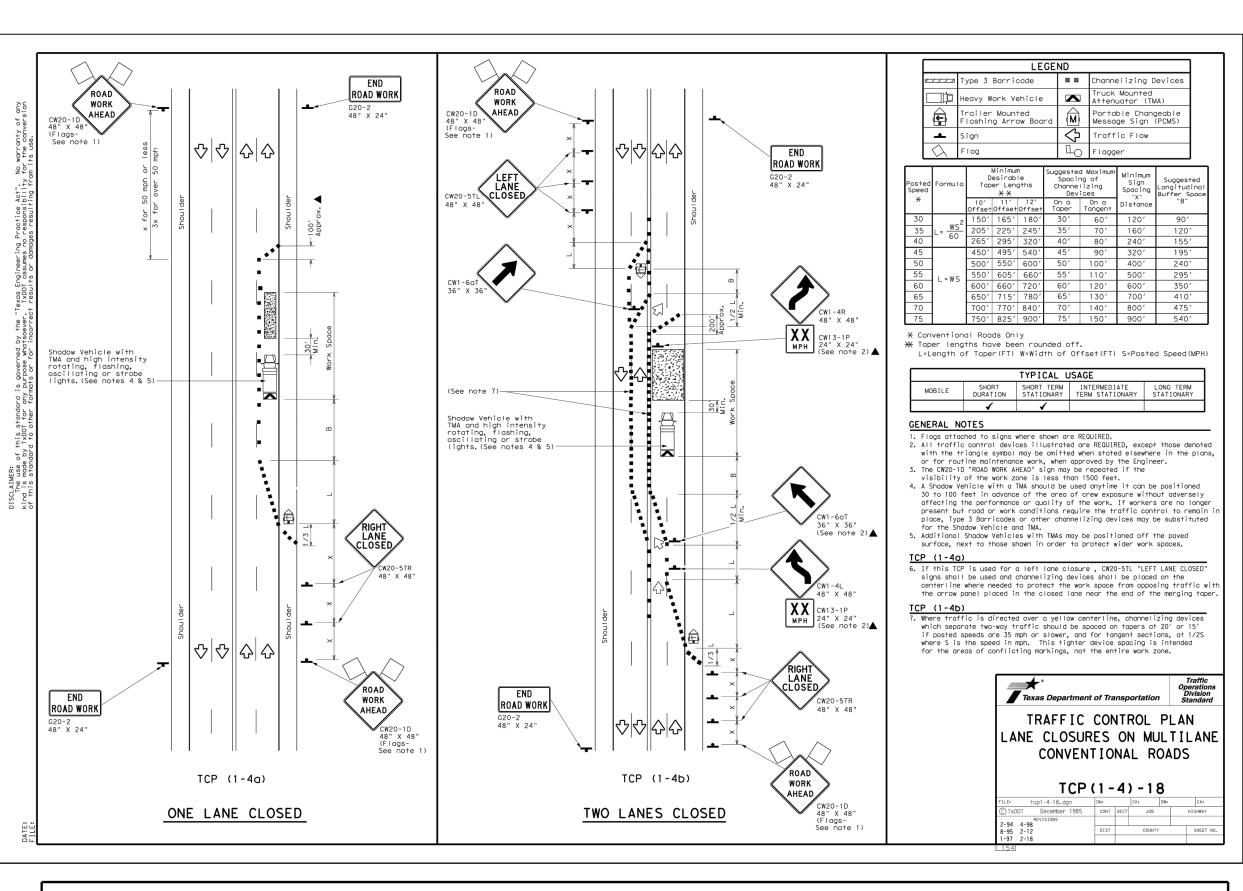
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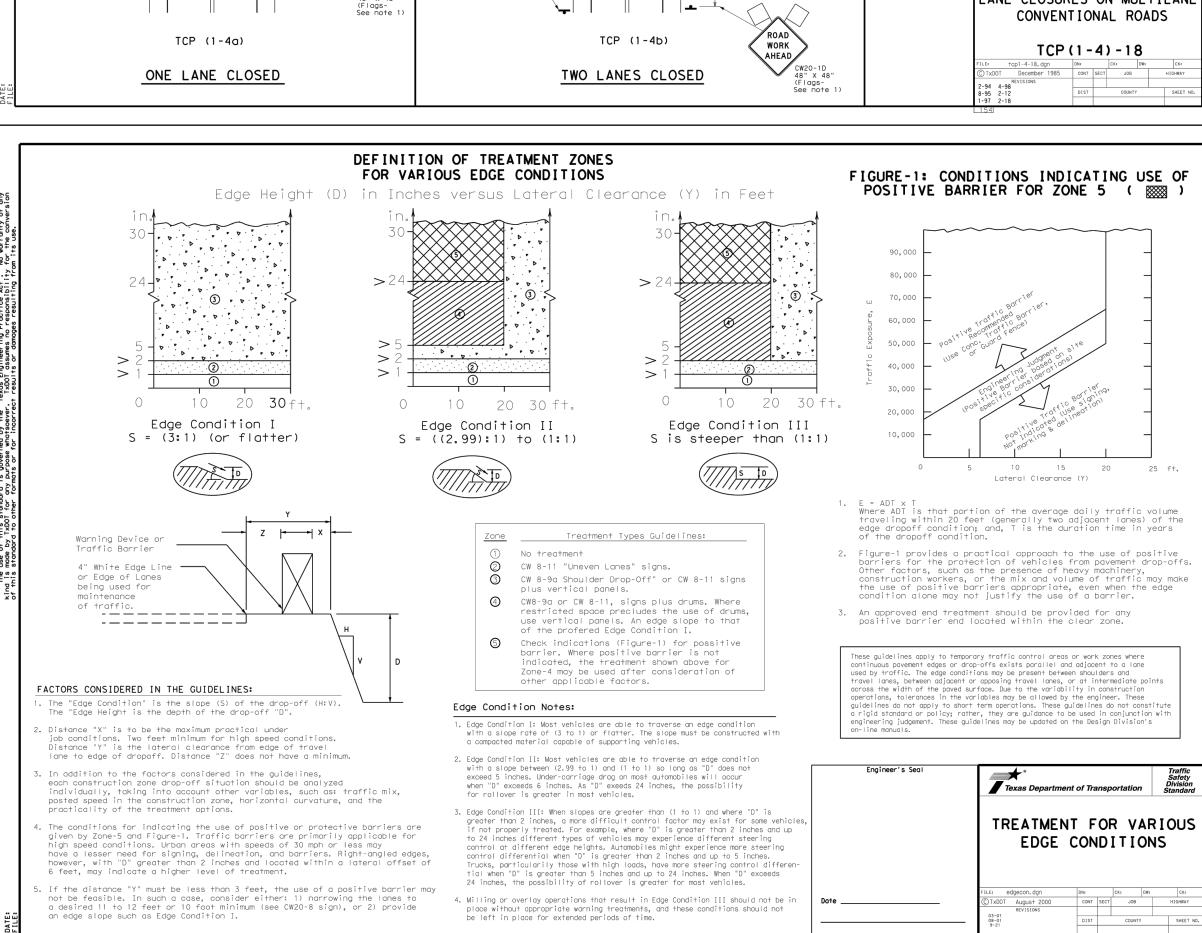
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LOCAL OFFICE:

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CITY OF HOLSTON
HOLSTON AIRPORTS SYSTEM
Recommended

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DIRECTOR

HOUSTON AIRPORT SYSTEM
PROJECT NO.

PROJECT NO.

100072032

A.I.P. NO.

C.I.P. NO.

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SECURITY REQUIREMENTS

- 1. GENERAL INTENT: IT IS INTENDED THAT THE CONTRACTOR SHALL COMPLY WITH ALL REQUIREMENTS OF THE AIRPORT SECURITY PLAN (PROVIDED IN THE PROJECT MANUAL DOCUMENTS, VOLUME 2) AND WITH THE SECURITY REQUIREMENTS SPECIFIED HEREIN BY HOUSTON AIRPORT SYSTEM (HAS) OPERATIONS. THE CONTRACTOR SHALL DESIGNATE TO THE ENGINEER AND AIRPORT OPERATIONS, IN WRITING, THE NAME OF HIS "CONTRACTOR SECURITY AND SAFETY OFFICER (CSSO)." THE CSSO SHALL REPRESENT THE CONTRACTOR ON THE SECURITY REQUIREMENTS FOR THE CONTRACT.
- 2. CONTRACTOR PERSONNEL SECURITY ORIENTATION: THE CSSO SHALL BE RESPONSIBLE FOR BRIEFING ALL CONTRACTOR PERSONNEL ON SECURITY REQUIREMENTS. ALL CONTRACTOR EMPLOYEES SHALL BE BRIEFED ON SECURITY REQUIREMENTS PRIOR TO WORKING IN THE CONSTRUCTION AREA.
- 3. ACCESS TO THE SITE: CONTRACTOR'S ACCESS TO THE SITE SHALL BE AS SHOWN ON THE PLANS. NO OTHER ACCESS POINTS SHALL BE ALLOWED UNLESS APPROVED BY HAS OPERATIONS. ALL CONTRACTOR TRAFFIC AUTHORIZED TO ENTER THE SITE SHALL BE EXPERIENCED IN THE ROUTE OR GUIDED BY CONTRACTOR PERSONNEL. THE CONTRACTOR SHALL BE RESPONSIBLE FOR TRAFFIC CONTROL TO AND FROM AREAS ON THE SITE. A CONTRACTOR'S FLAGMAN OR TRAFFIC CONTROL PERSON SHALL MONITOR AND COORDINATE ALL THE ENTRANCE TO THE SITE. THE CONTRACTOR SHALL NOT PERMIT ANY UNAUTHORIZED CONSTRUCTION PERSONNEL OR TRAFFIC ON THE SITE. THE CONTRACTOR IS RESPONSIBLE FOR THE IMMEDIATE CLEANUP OF ANY DEBRIS DEPOSITED ALONG THE ACCESS ROUTE AS A RESULT OF HIS CONSTRUCTION TRAFFIC. DIRECTIONAL SIGNING FROM THE SITE ENTRANCE ALONG THE DELIVERY ROUTE TO THE STORAGE AREA, PLANT SITE OR WORK SITE IS THE CONTRACTOR'S RESPONSIBILITY.
- 4. MATERIALS DELIVERY TO THE SITE: ALL CONTRACTOR'S MATERIAL ORDERS FOR DELIVERY TO THE WORK SITE WILL USE A DELIVERY ADDRESS, THE STREET NAME ASSIGNED TO THE ACCESS POINT AT THE CONTRACTOR'S STAGING SITE. THE NAME "GEORGE BUSH INTERCONTINENTAL AIRPORT" SHALL NOT BE USED IN THE DELIVERY ADDRESS AT ANY TIME. HAS WILL NOT BE RESPONSIBLE FOR ACCEPTING OR DIRECTING CONTRACTOR MATERIAL DELIVERIES. CONSTRUCTION ACCESS SHALL BE ONLY VIA DESIGNATED ROUTING AND LOCATIONS.
- 5. CONSTRUCTION AREA LIMITS: FOR THE LIMITS OF CONSTRUCTION, THE CONTRACTOR SHALL ERECT AND MAINTAIN AROUND THE PERIMETER OF THESE AREAS, SUITABLE FENCING, MARKING AND/OR WARNING DEVICES VISIBLE FOR DAY/NIGHT USE. TEMPORARY BARRICADES, FLAGGING, AND FLASHING WARNING LIGHTS, WILL BE REQUIRED AT CRITICAL ACCESS POINTS. TYPE OF MARKING AND WARNING DEVICES SHALL BE APPROVED BY AIRPORT OPERATIONS.

AIRPORT SAFETY REQUIREMENTS

- 1. THE CONTRACTOR SHALL CONDUCT THE CONSTRUCTION ACTIVITIES TO CONFORM TO ALL ROUTINE EMERGENCY PROCEDURES AND SAFETY REQUIREMENTS OUTLINED IN THE PROJECT MANUAL DOCUMENTS, VOLUME 2.
- 2. STOCKPILE EROSION AND DUST CONTROL STOCKPILED MATERIAL AND OPEN EXCAVATIONS SHALL BE TREATED IN SUCH A MANNER AS TO PREVENT MOVEMENT OF MATERIALS RESULTING FROM WIND.
- 3. PRIOR TO OPENING FOR PUBLIC USE, THE AIRPORT WILL ARRANGE FOR INSPECTION BY HAS OPERATIONS OF ANY PAVEMENT THAT HAS BEEN CLOSED FOR WORK, OR THAT HAS BEEN USED FOR A CROSSING POINT OR HAUL ROUTE BY THE CONTRACTOR. THIS AREA MUST COMPLY WITH THE SAFETY REQUIREMENTS, AND BE REVIEWED BY THE DESIGNATED OPERATION'S INSPECTOR, BEFORE PERMISSION FOR THE CONTRACTOR'S WORK CREWS TO DEPART WILL BE GRANTED.
- 4. THE CONTRACTOR SHALL SUBMIT A DESTRUCTIVE/INCLEMENT WEATHER PLAN TO SET FORTH GENERAL GUIDANCE AND INFORMATION FOR THE CONTRACTOR TO COORDINATE PREPAREDNESS PLANS WHEN DESTRUCTIVE WEATHER THREATENS THE IAH AIRPORT ENVIRONMENT.
- 5. MATERIALS STORED OR STOCKPILED ON THE SITE SHALL BE SO PLACED, AND THE WORK SHALL, AT ALL TIMES, BE SO CONDUCTED AS TO CAUSE NO GREATER OBSTRUCTION TO EXISTING TRAFFIC THAN IS CONSIDERED NECESSARY. ANY IMPACTS TO EXISTING TRAFFIC PATTERNS SHALL BE SUBMITTED TO THE OWNER'S REPRESENTATIVE PRIOR TO SCHEDULING AND IMPLEMENTING A TRAFFIC PLAN.
- 6. THE CONTRACTOR SHALL CONFINE HIS/HER PERSONNEL, EQUIPMENT, AND OPERATIONS, TO THE AREA WITHIN THE DEFINED WORK LIMITS SHOWN ON THE PLANS.
- 7. THE CONTRACTOR SHALL INFORM ALL CONSTRUCTION PERSONNEL AS TO THE PROPER ROUTES, SPEEDS, AND PROCEDURES, FOR TRANSPORTING EQUIPMENT AND MATERIALS TO THE CONSTRUCTION SITE.

- 8. MEASURES SHALL BE ADOPTED TO PREVENT POTENTIAL POLLUTANTS FROM ENTERING ANY DRAINAGE SYSTEM OR WATERWAY. MATERIALS AND DEBRIS SHALL NOT BE STORED IN THE WORK AREA IN A MANNER THAT WOULD ALLOW THEM TO ENTER THE DRAINAGE SYSTEM AS A RESULT OF SPILLAGE, NATURAL RUNOFF, OR FLOODING. IT SHALL BE THE RESPONSIBILITY OF THE CONTRACTOR TO IMMEDIATELY NOTIFY THE HAS REPRESENTATIVE SHOULD THERE BE A SPILLAGE OF MATERIAL WHICH MIGHT CONTAMINATE THE DRAINAGE SYSTEM. IT SHALL ALSO BE THE CONTRACTOR'S RESPONSIBILITY TO REMOVE AND CLEAR UP SUCH SPILLAGE IN A MANNER ACCEPTABLE TO THE HAS REPRESENTATIVE. MATERIAL SHALL BE SECURED SO THAT IT WILL NOT BE BLOWN BY THE WIND ONTO THE ADJACENT ROADWAYS.
- 9. SPECIAL ATTENTION TO DUST CONTROL WILL BE REQUIRED WHEN EARTHWORK OR HAULING OPERATIONS ARE IN PROGRESS OR WHEN WIND AND WEATHER CONDITIONS CAUSE EXCESSIVE BLOWING OF DUST. IN THIS REGARD, THE CONTRACTOR SHALL APPLY WATER TO THE AFFECTED SITES AS DIRECTED.
- 10. THE CONTRACTOR SHALL SUBMIT A SAFETY AND SECURITY PLAN TO THE HAS PROJECT MANAGER FOR REVIEW AND APPROVAL BY THE AIRPORT PRIOR TO CONSTRUCTION COMMENCING.
- 11. IT IS THE CONTRACTOR'S RESPONSIBILITY TO SEE THAT ALL SHEETING, SHORING, AND BRACING IS DONE IN ACCORDANCE WITH CURRENT O.S.H.A REGULATIONS AND REQUIREMENTS. SHEETING, SHORING, AND BRACING (EXCEPT TRENCH SAFETY), IS CONSIDERED TO BE AN INCIDENTAL PART OF THE WORK AND NO SEPARATE PAYMENT WILL BE ALLOWED.

UTILITY NOTES

- 1. THE CONTRACTOR SHALL NOTIFY ALL UTILITY COMPANIES INVOLVED, A MINIMUM OF 72 HOURS IN ADVANCE OF ANY EXCAVATION OR BORINGS, TO HAVE THEIR UTILITIES LOCATED AND MARKED IN THE FIELD.
 - A. THE CONTRACTOR SHALL CONTACT TEXAS ONE CALL 1-800-344-8377 (TEXAS 811) AND THE FOLLOWING LOCAL UTILITY OWNERS (LIST NOT INCLUSIVE OF ALL POTENTIAL UTILITY OWNERS) TO VERIFY ALL UNDERGROUND UTILITY LOCATIONS IN THE VICINITY OF THE PROPOSED WORK:

CABLE OWNER CONTACT PERSON PHONE NUMBER
HOUSTON AIRPORT
SYSTEM OPERATIONS 281-233-3000

CENTERPOINT ENERGY (SEE CENTERPOINT NOTES BELOW) SYSTEM

- B. ALL UNDERGROUND UTILITIES SHALL THEN BE LOCATED BY THE CONTRACTOR TO VERIFY LOCATION AND ELEVATION PRIOR TO COMMENCING CONSTRUCTION OPERATIONS.
- C. THE CONTRACTOR SHALL COORDINATE WITH THE RESPECTIVE UTILITY OWNER IF A UTILITY INSPECTOR MUST BE ON SITE WHEN LOCATING OR EXCAVATING NEAR UTILITIES.
- 2. THE CONTRACTOR SHALL BE RESPONSIBLE FOR SETTING UP HIS/HER OWN WATER SOURCES WITH THE CITY. ALL CONSTRUCTION WATER WILL BE METERED BY THE CITY-OWNED METERS AND ONLY THOSE METERS. THE CONTRACTOR WILL BE RESPONSIBLE FOR PAYING ALL RELATED FEES TO THE CITY.
- 3. THE CONTRACTOR SHALL TAKE ALL STEPS TO PROTECT ALL COMMERCIAL AND AIRPORT UTILITIES DURING CONSTRUCTION IN ORDER TO ENSURE CONTINUOUS OPERATION WHEN NEEDED. THE CONTRACTOR SHALL, AT HIS/HER OWN EXPENSE, MAINTAIN IN PROPER WORKING ORDER AND WITHOUT INTERRUPTION OF SERVICE ALL EXISTING UTILITIES AND SERVICES WHICH MAY BE ENCOUNTERED IN THE WORK. WITH THE CONSENT OF THE OWNER' REPRESENTATIVE, ENGINEER, AND/OR UTILITY OWNER, AS APPROPRIATE, SUCH SERVICE CONNECTIONS MAY BE TEMPORARILY INTERRUPTED TO PERMIT THE CONTRACTOR TO REMOVE DESIGNATED LINES OR TO MAKE TEMPORARY CHANGES IN THE LOCATIONS OF SERVICES. THE COST OF MAKING CHANGES SHALL BE AT THE CONTRACTOR'S EXPENSE, UNLESS OTHERWISE NOTED IN THE PLANS OR SPECIFICATIONS.
- 4. ALL UTILITIES DAMAGED BY CONTRACTOR'S OPERATIONS SHALL BE REPAIRED EXPEDITIOUSLY AT NO ADDITIONAL EXPENSE TO THE OWNER.
- 5. THE CONTRACTOR SHALL BE RESPONSIBLE FOR COORDINATING INSPECTIONS, AS NECESSARY, OF ANY UTILITY WORK BY THE UTILITY OWNER THROUGHOUT THE PROJECT. THIS SHALL BE CONSIDERED SUBSIDIARY TO THE VARIOUS BID ITEMS OF THE PROJECT.



ATKINS
LOCAL OFFICE:

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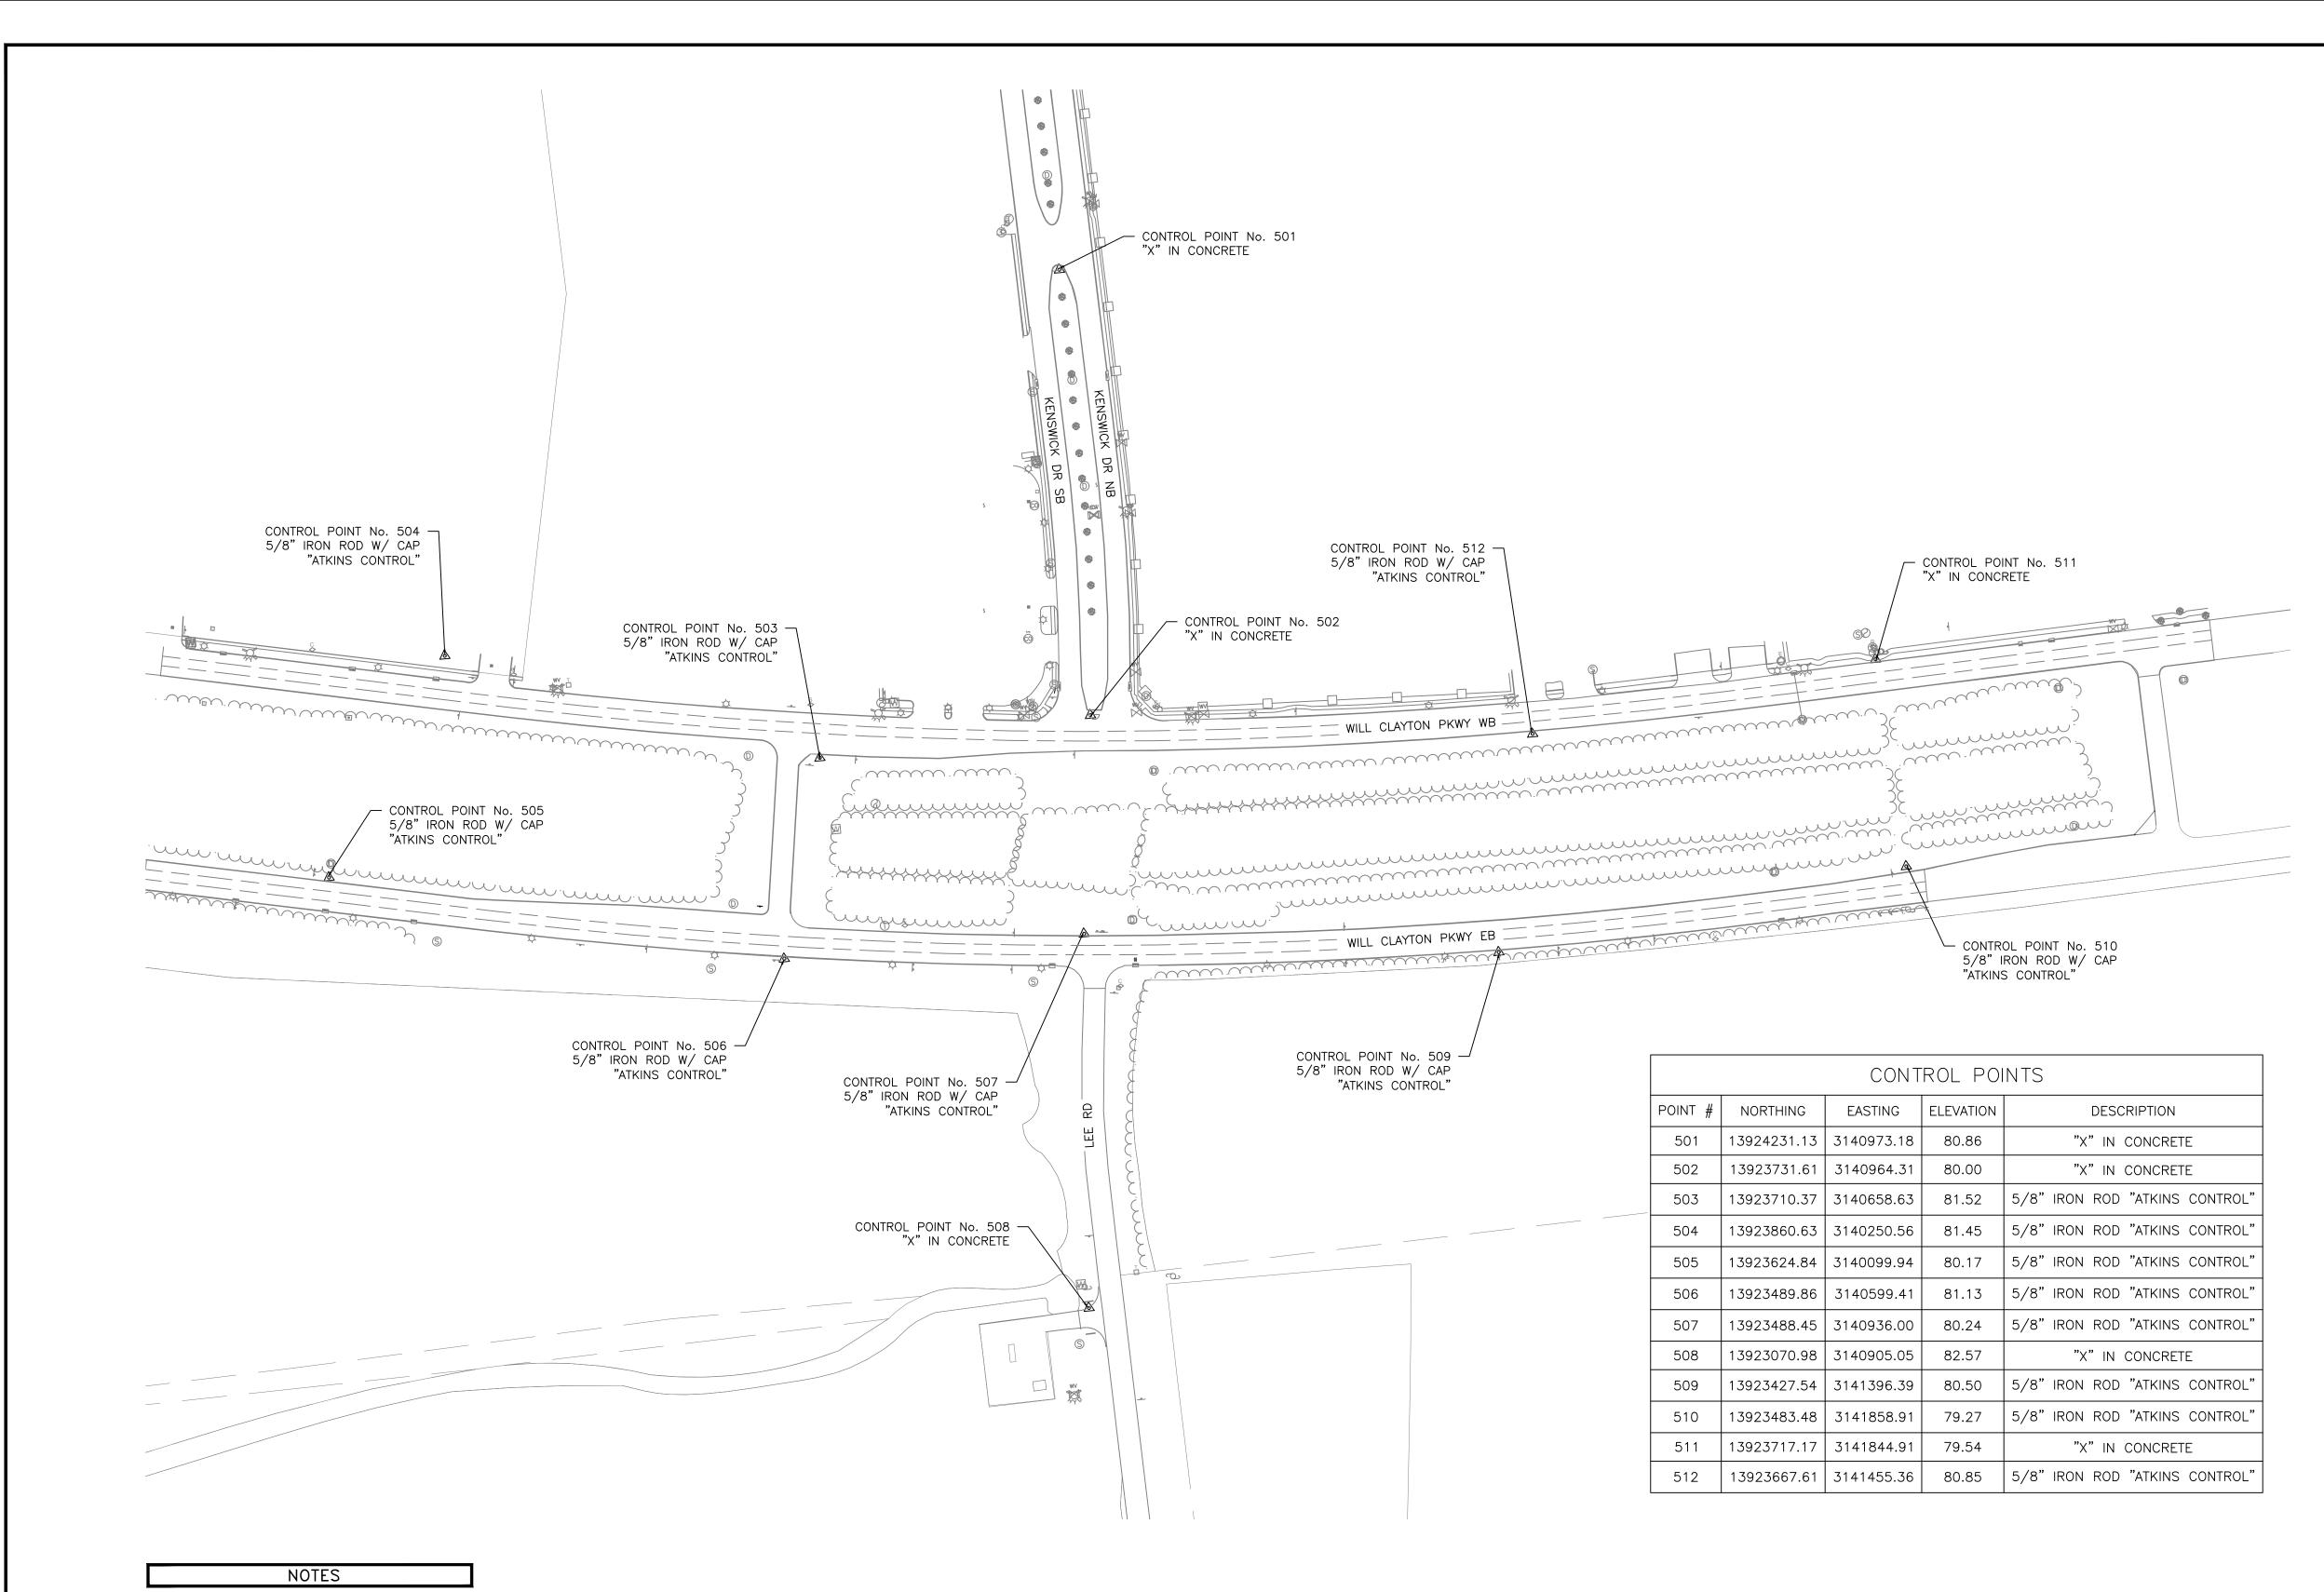
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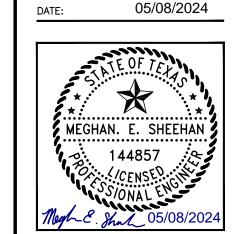




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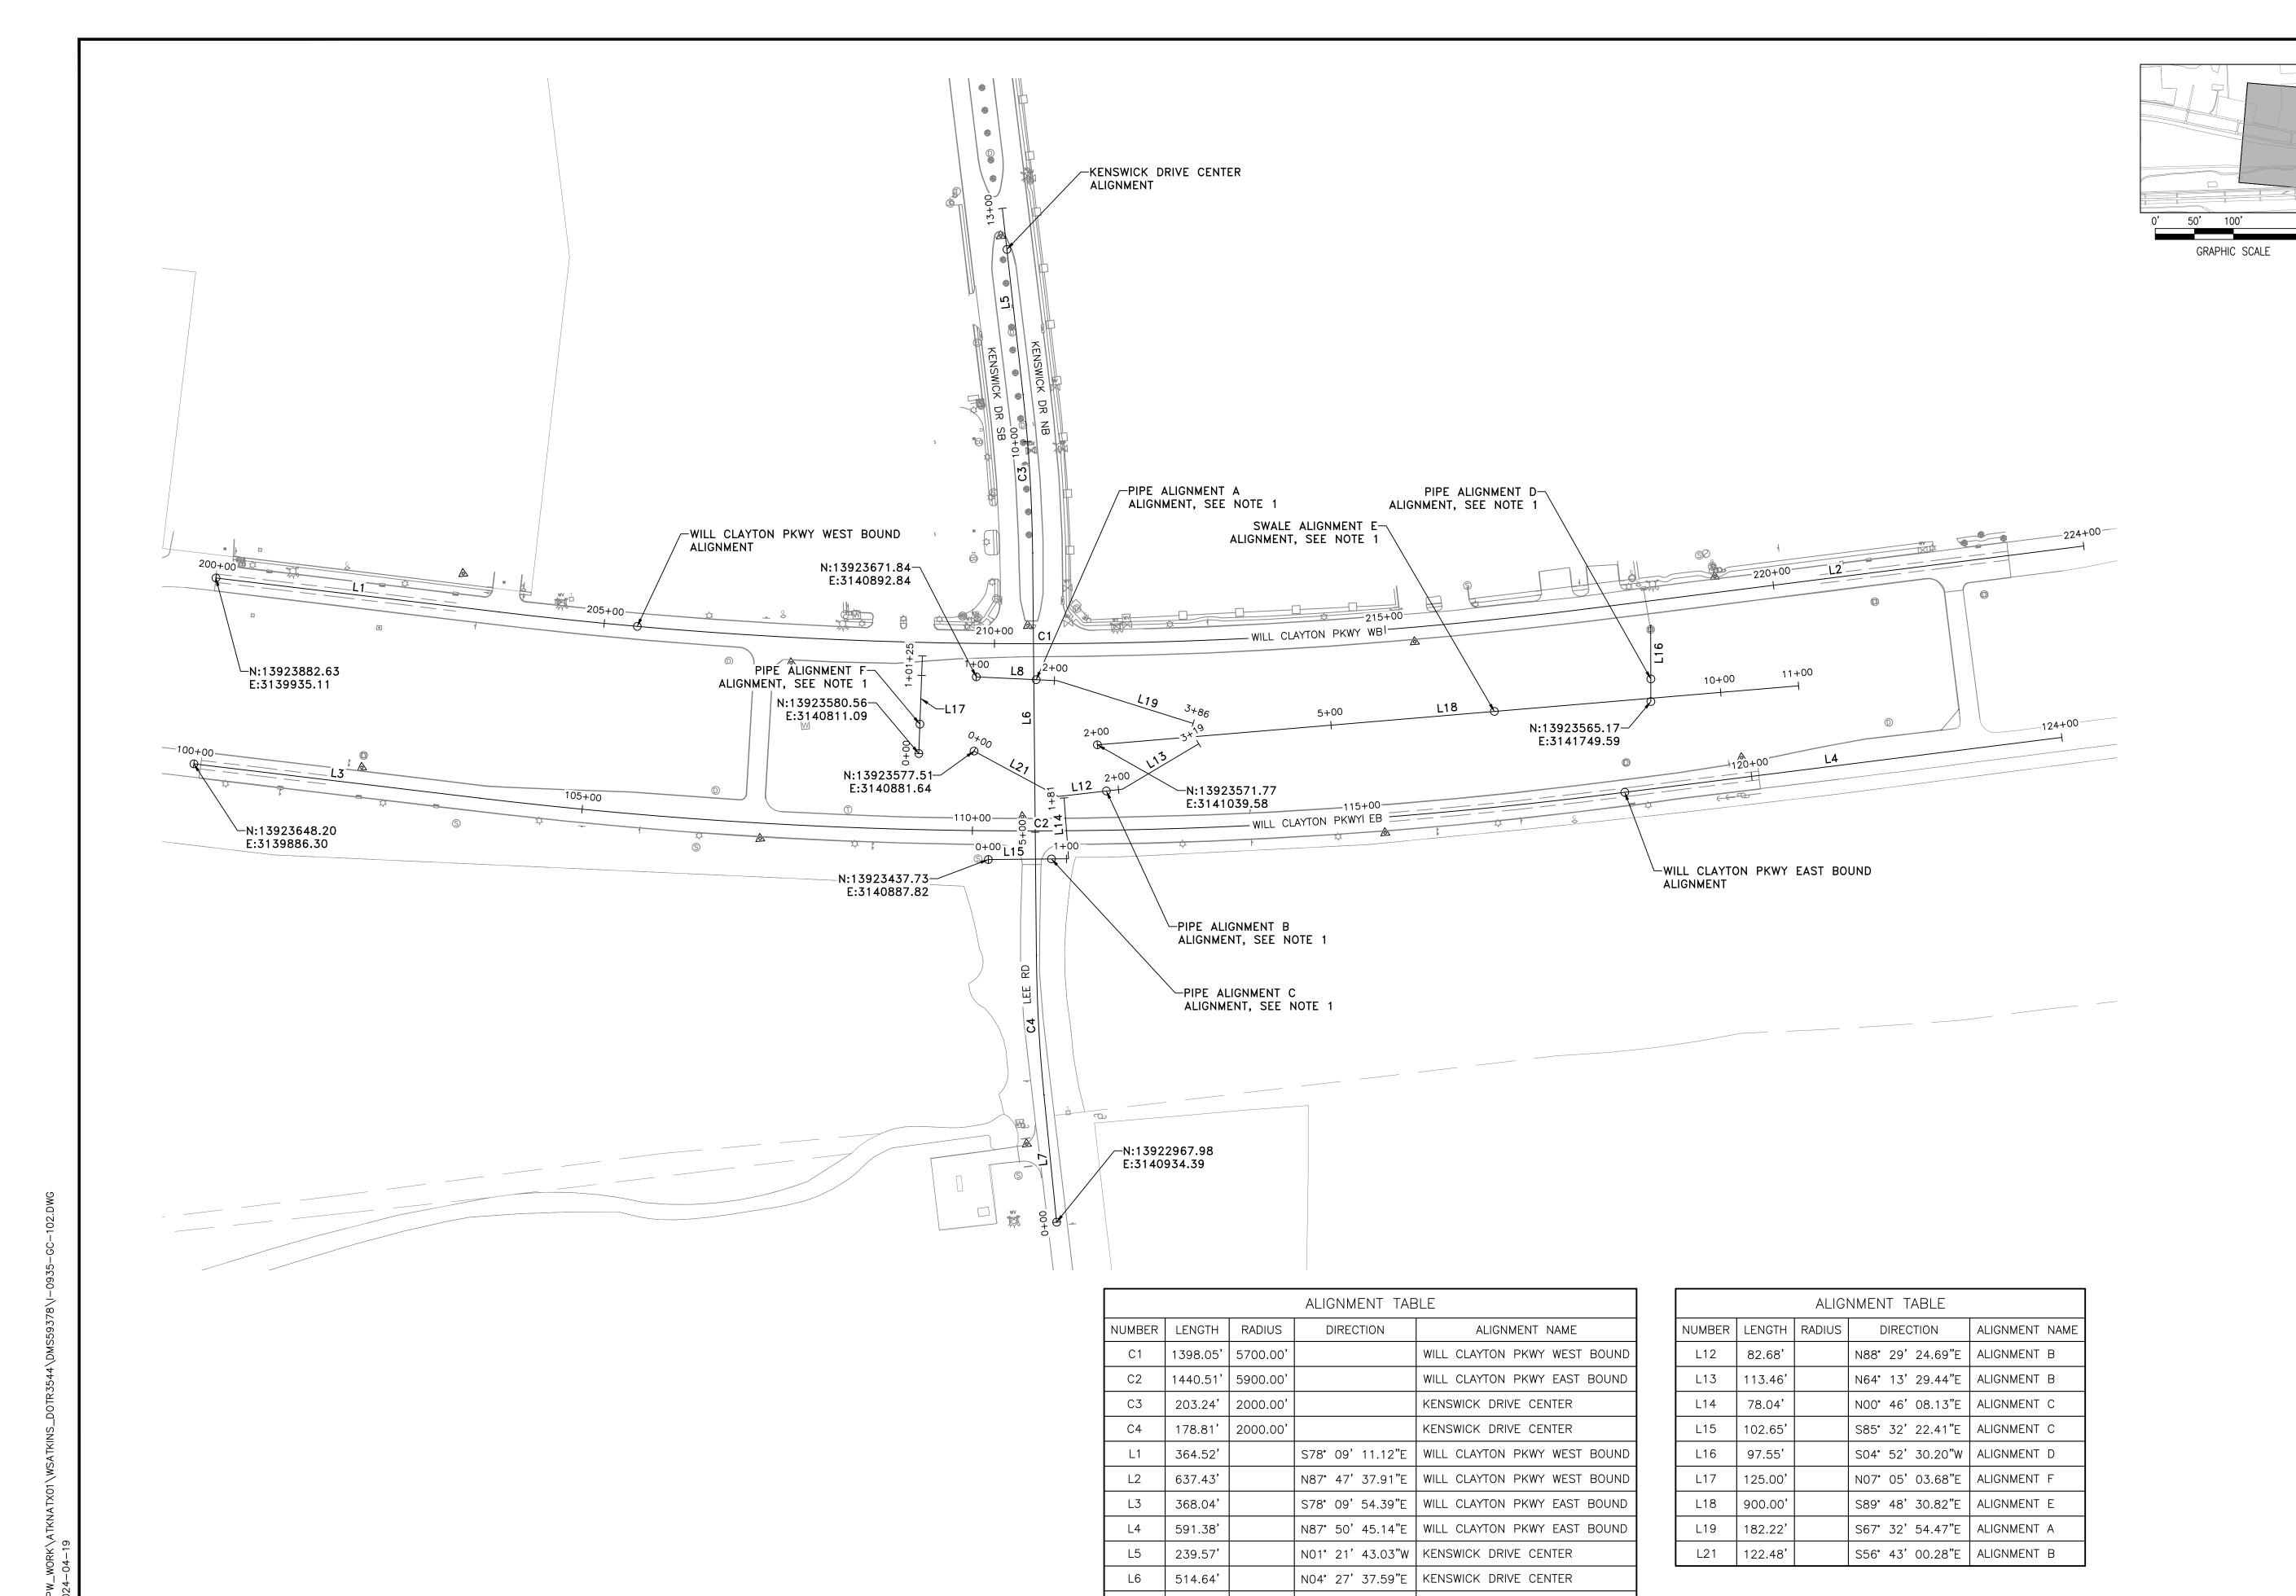
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SURVEY PROVIDED BY ATKINS AND COMPLETED ON NOVEMBER 10, 2020. HORIZONTAL DATUM IS BASED ON NAD83 (GRID) / TEXAS STATE PLANE

COORDINATES, SOUTH CÉNTRAL ZONE. VERTICAL

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1. SEE GRADING AND DRAINAGE SERIES CD-100 FOR

FOR PIPE ALIGNMENTS / STRUCTURE LOCATIONS.

GENERAL LOCATION AND STATION OFFSET INFORMATION



ATKINS LOCAL OFFICE: 920 MEMORIAL CITY WAY. STE. 400 HOUSTON, TX 77024

TEL: (713) 576-8500 ATKINS NORTH AMERICA PE FIRM REG. #F-000474

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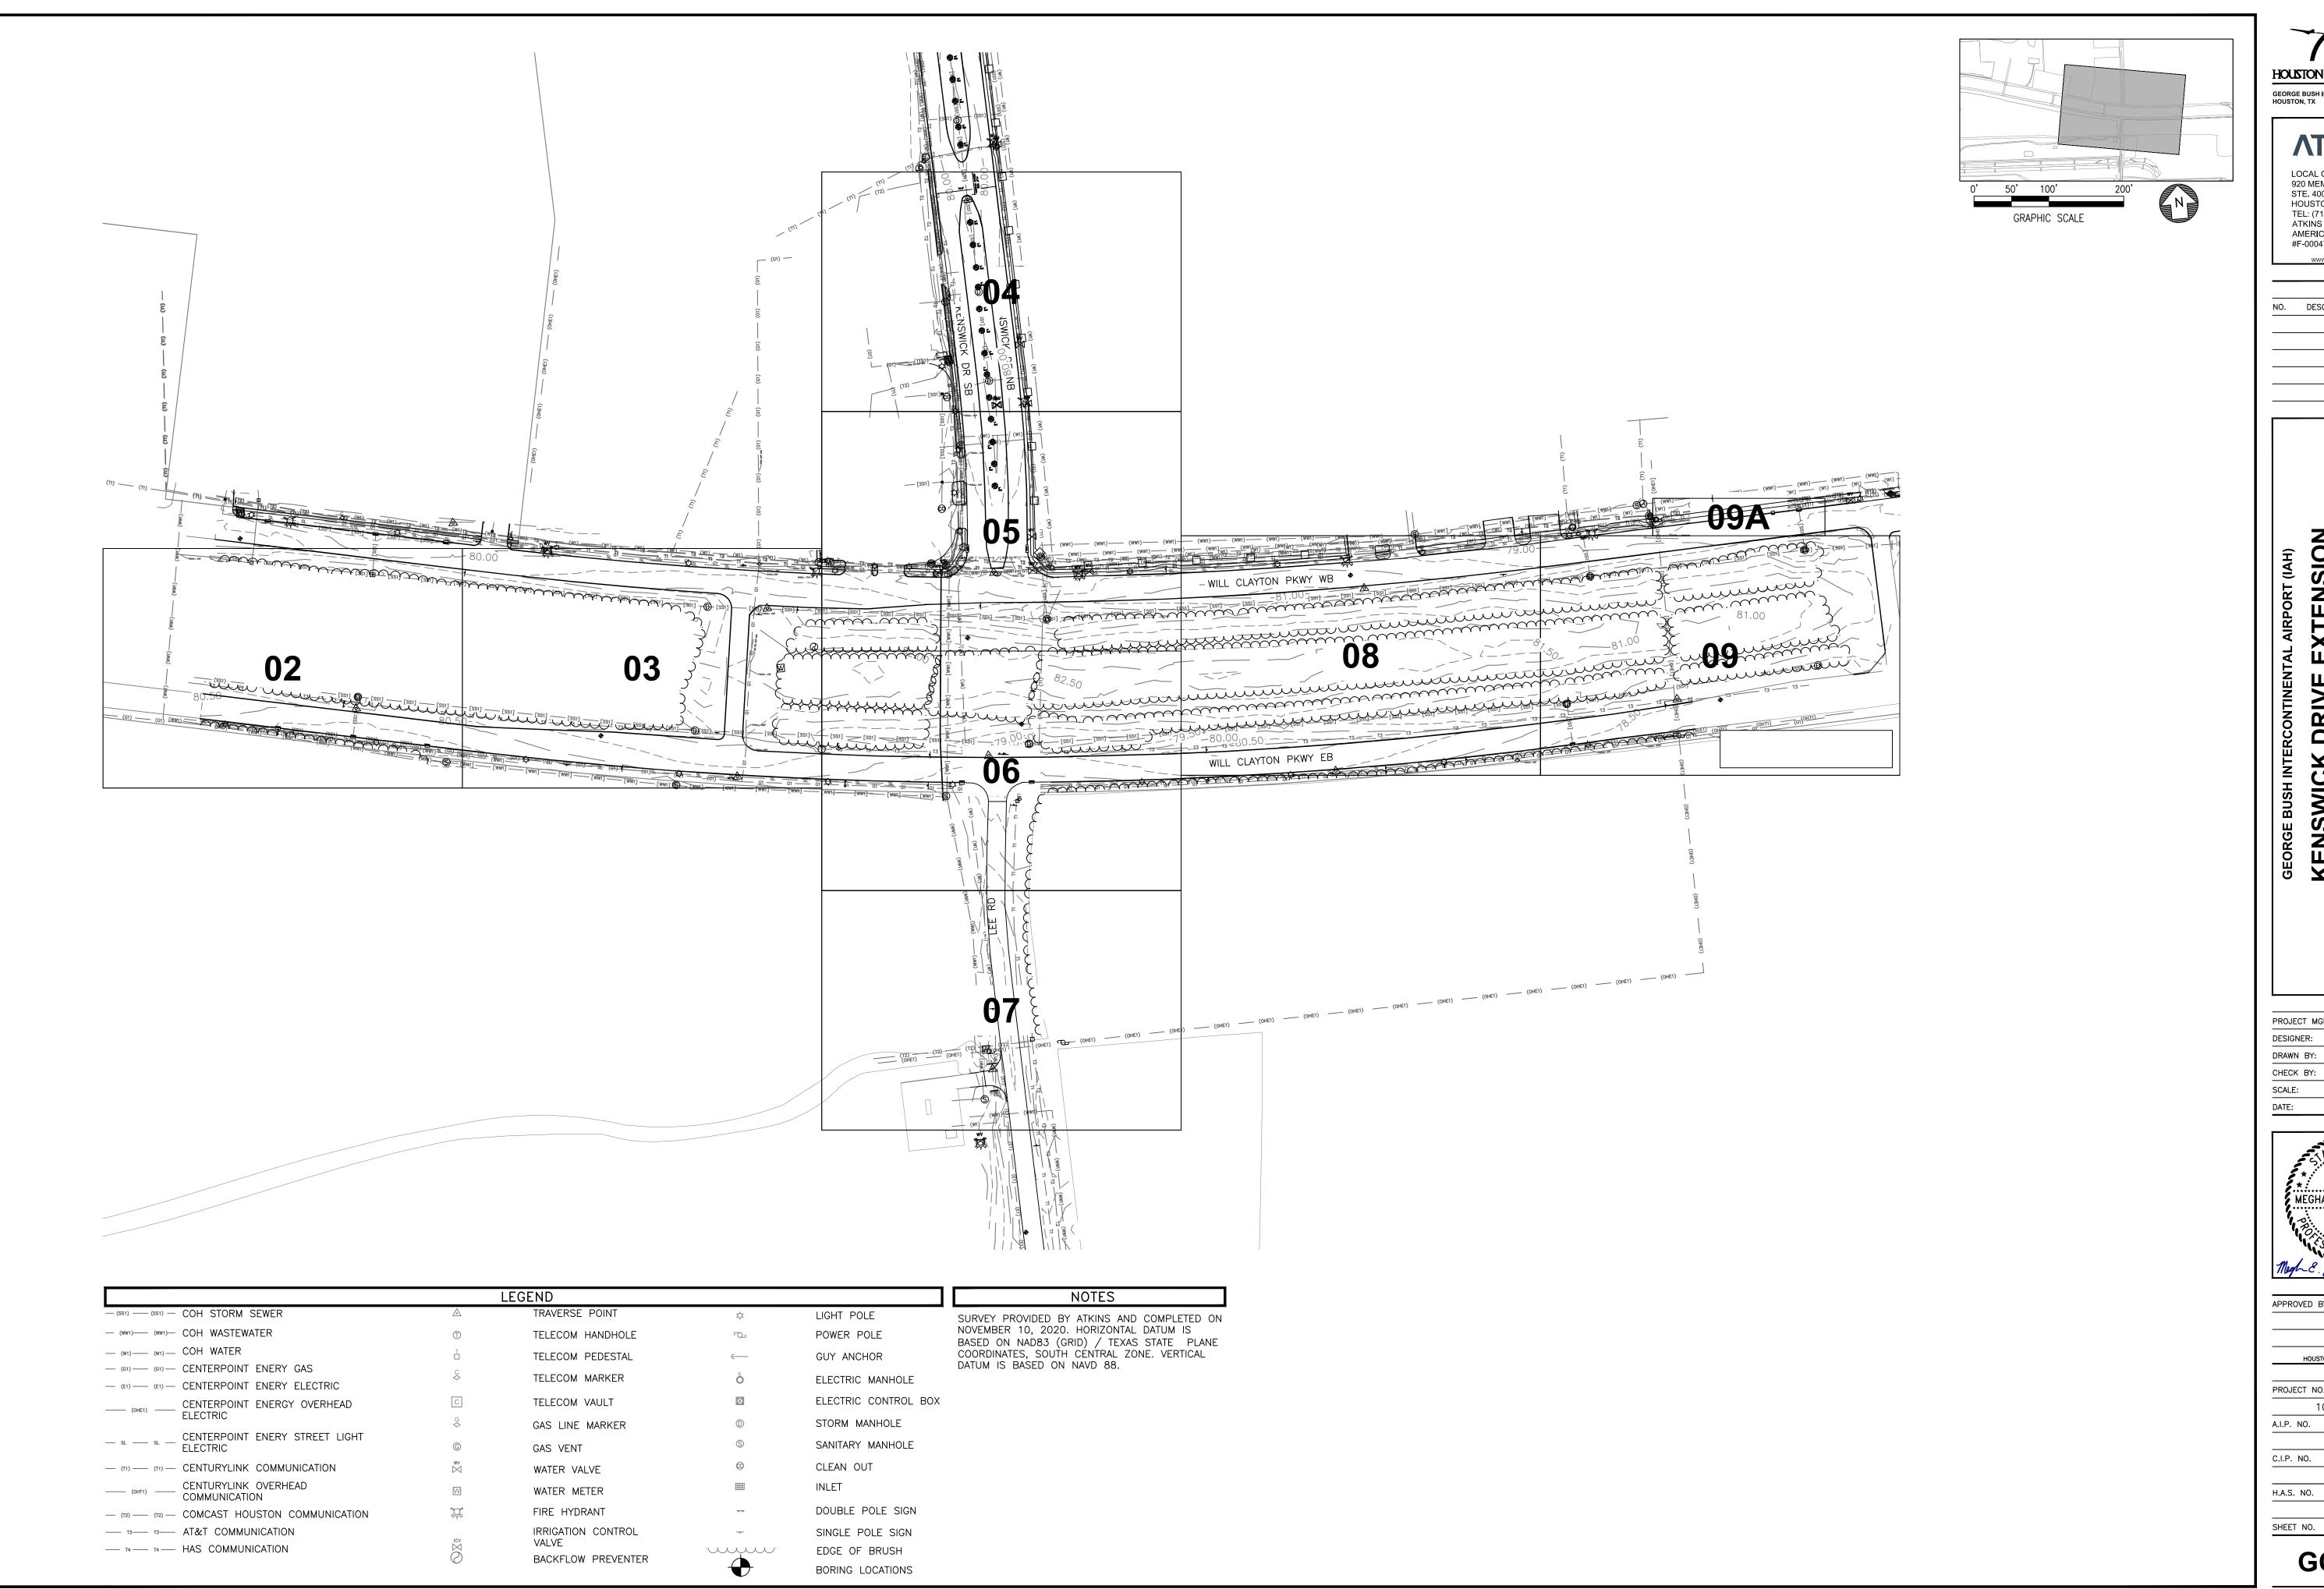
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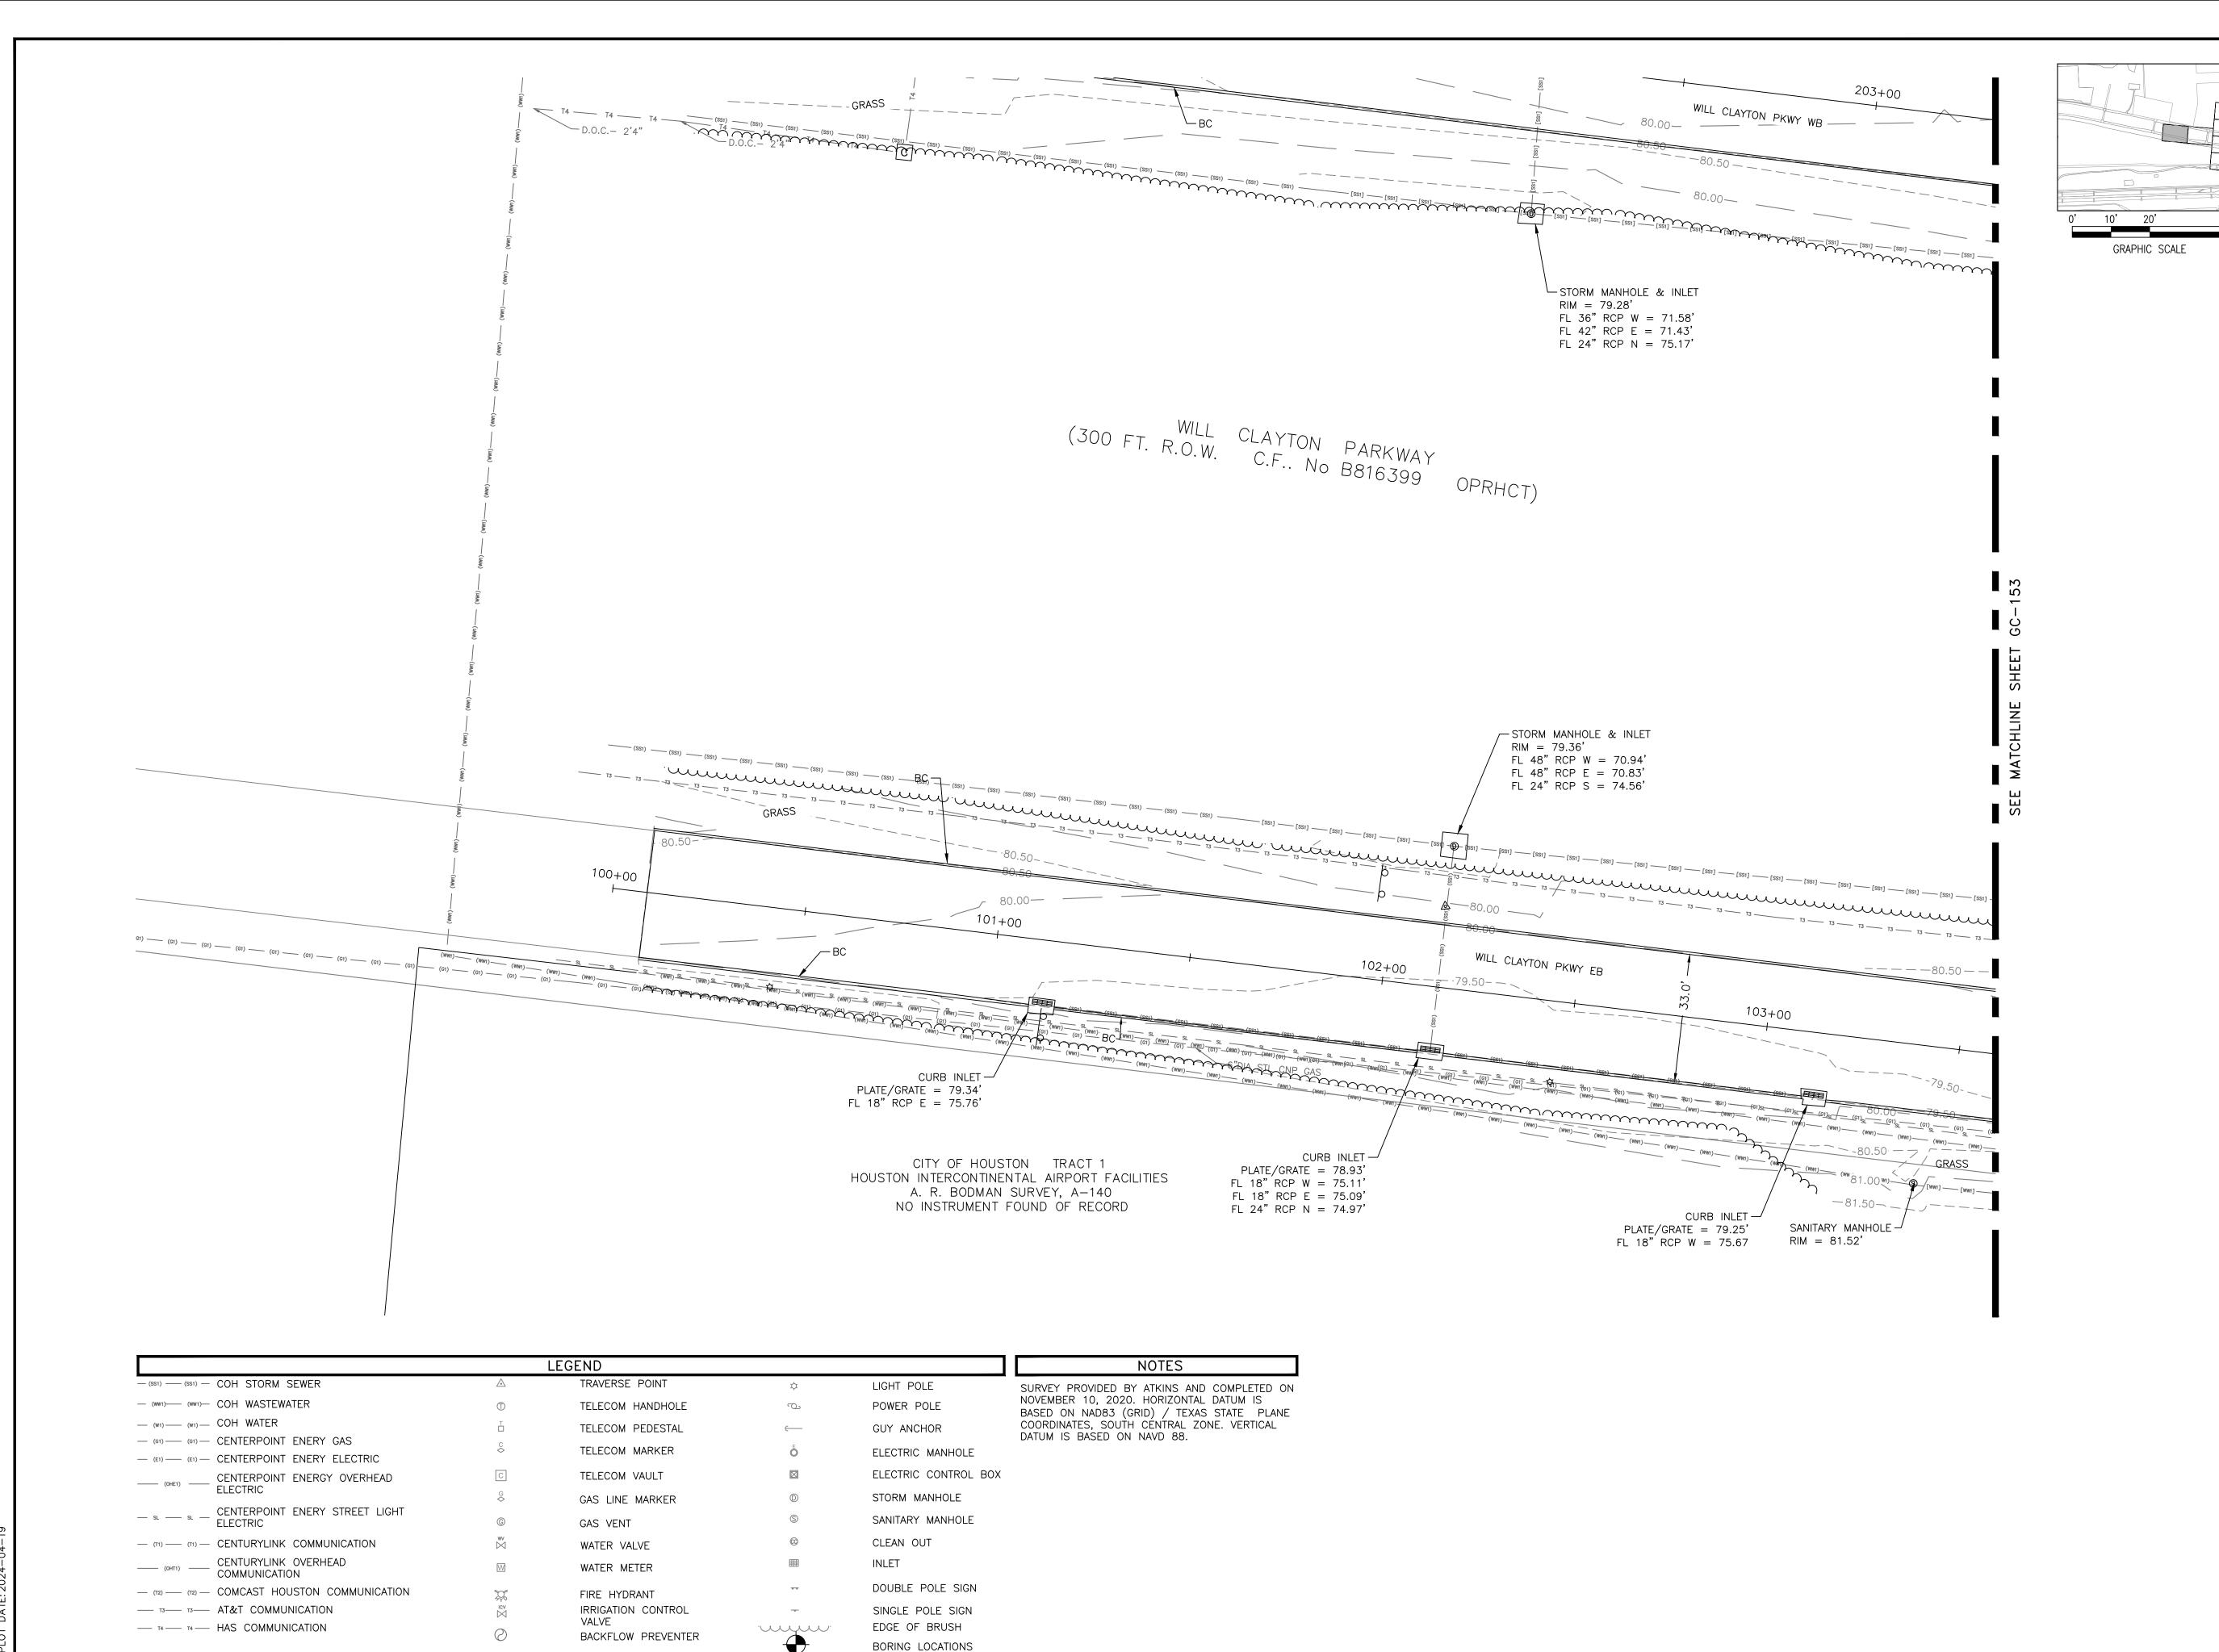
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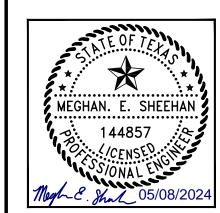
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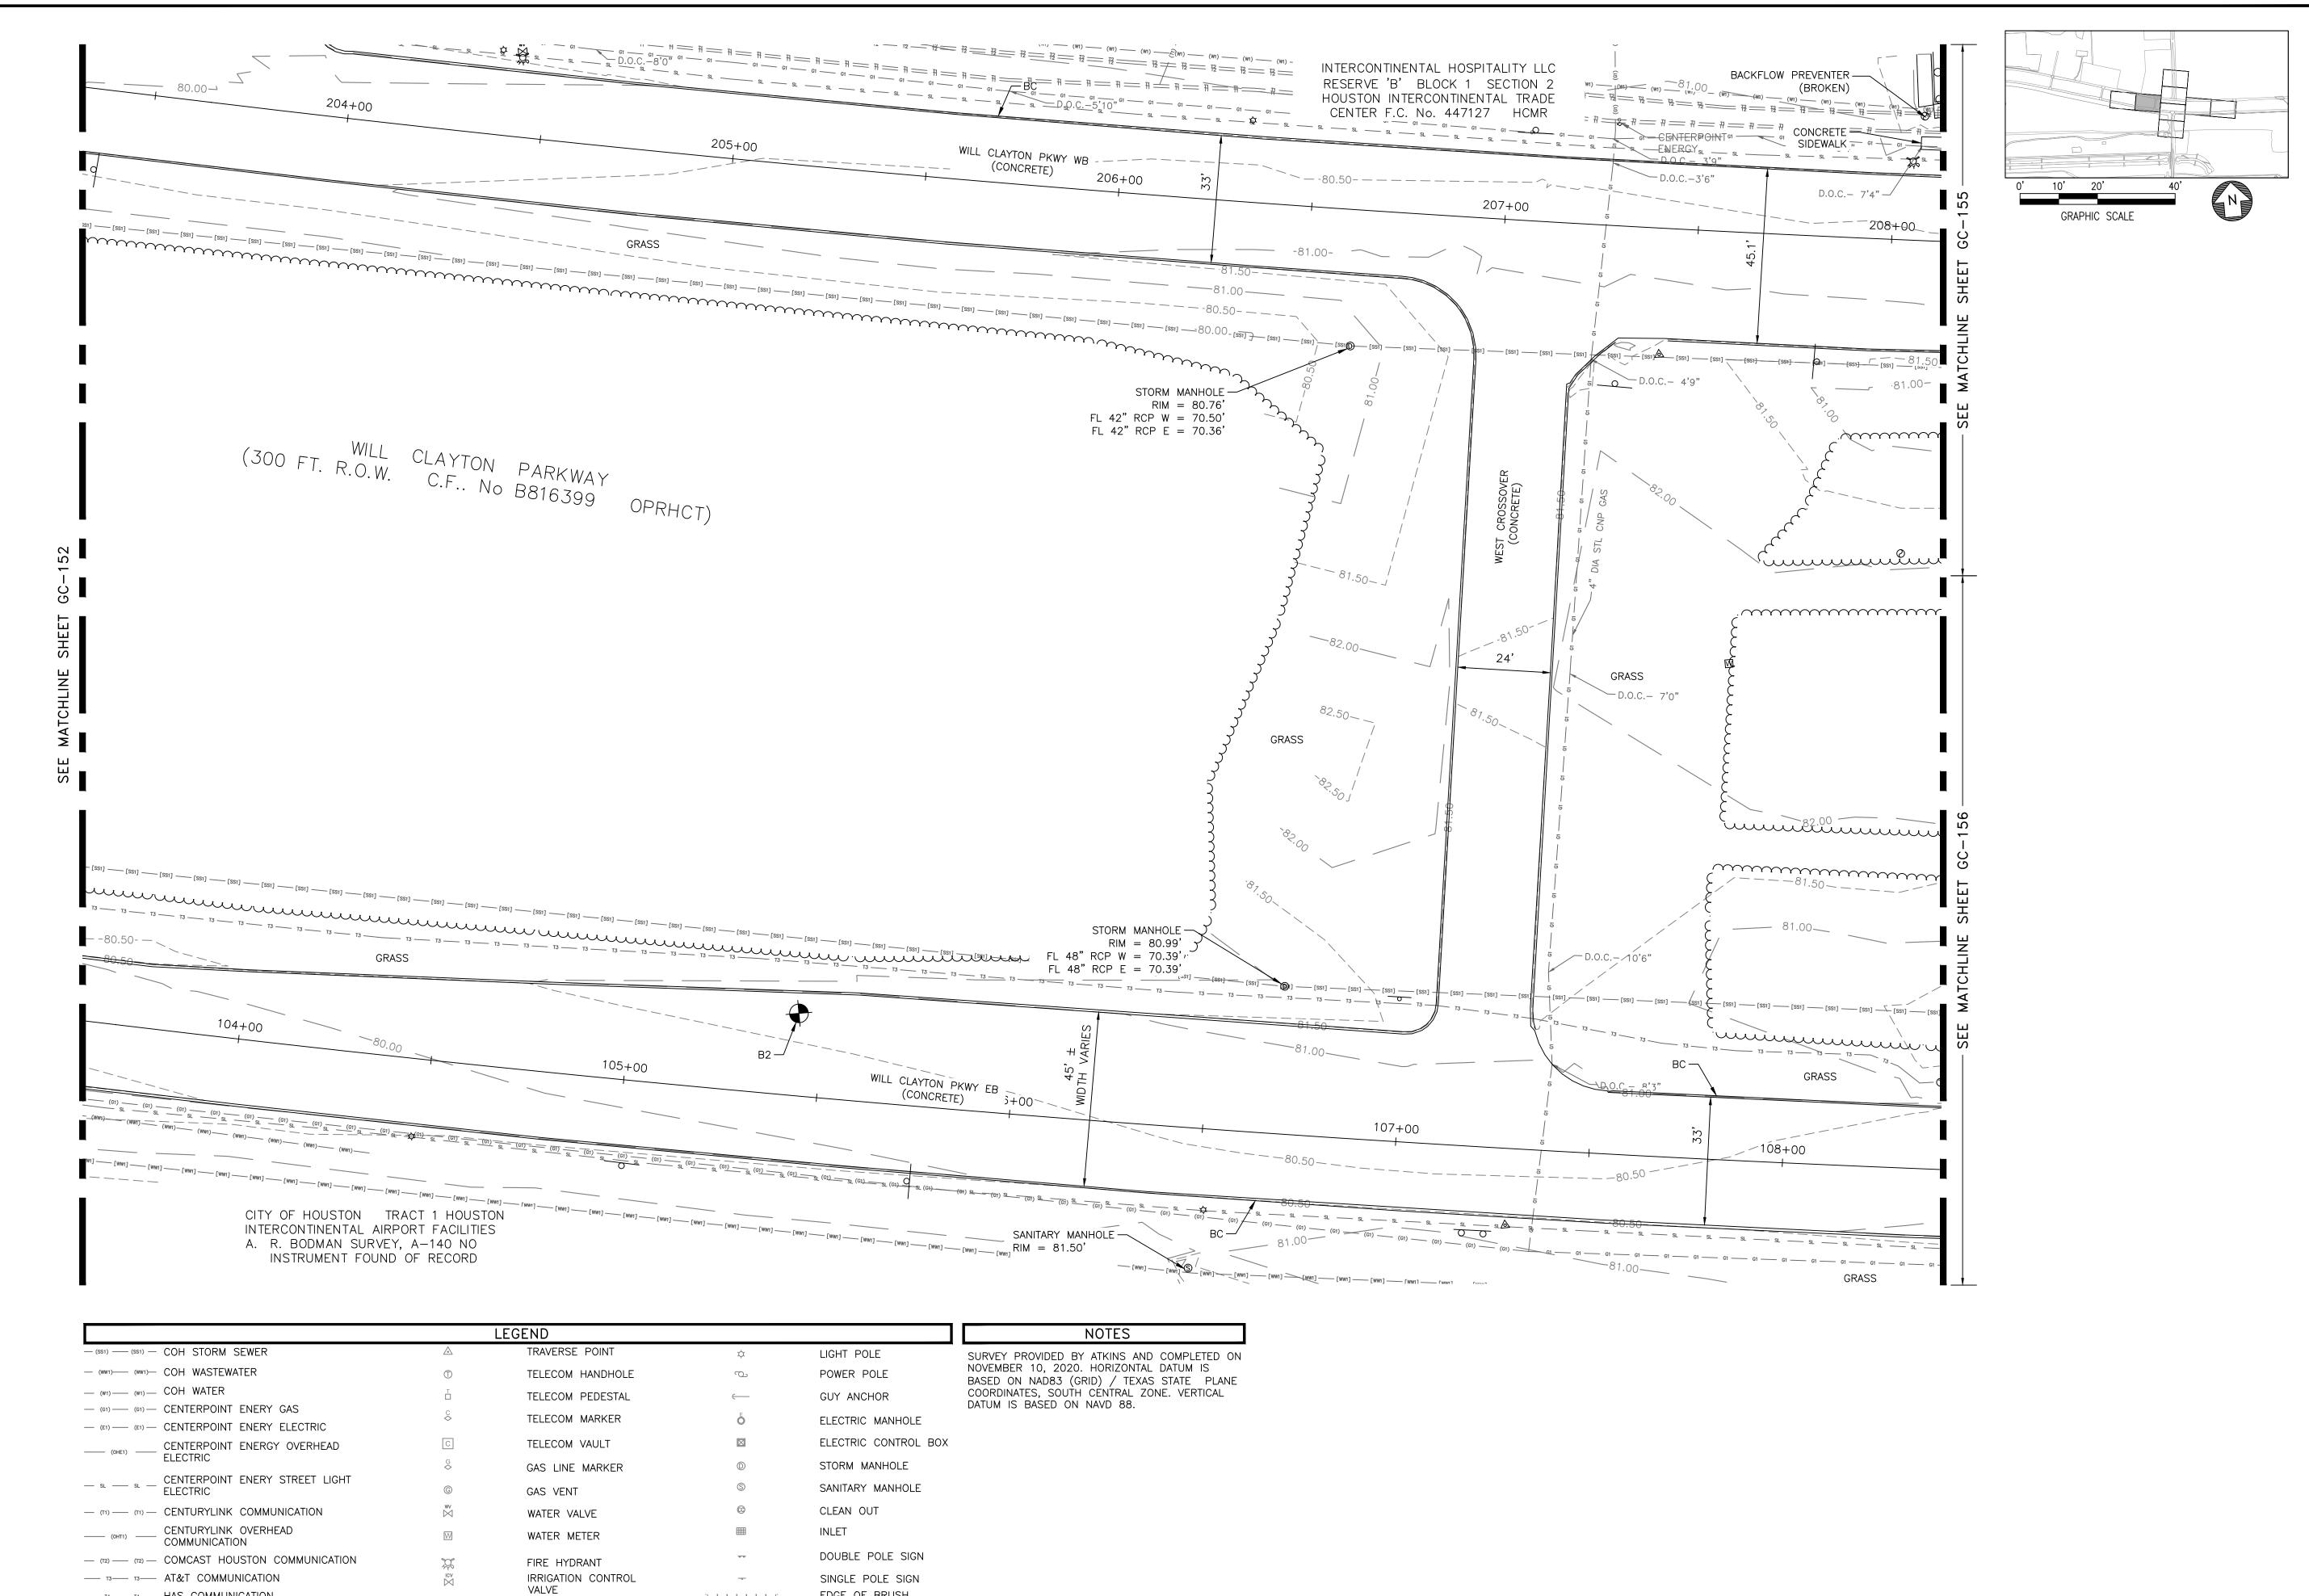
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HOUSTON AIRPORT SYSTEM GEORGE BUSH INTERCONTINENTAL AIRPORT

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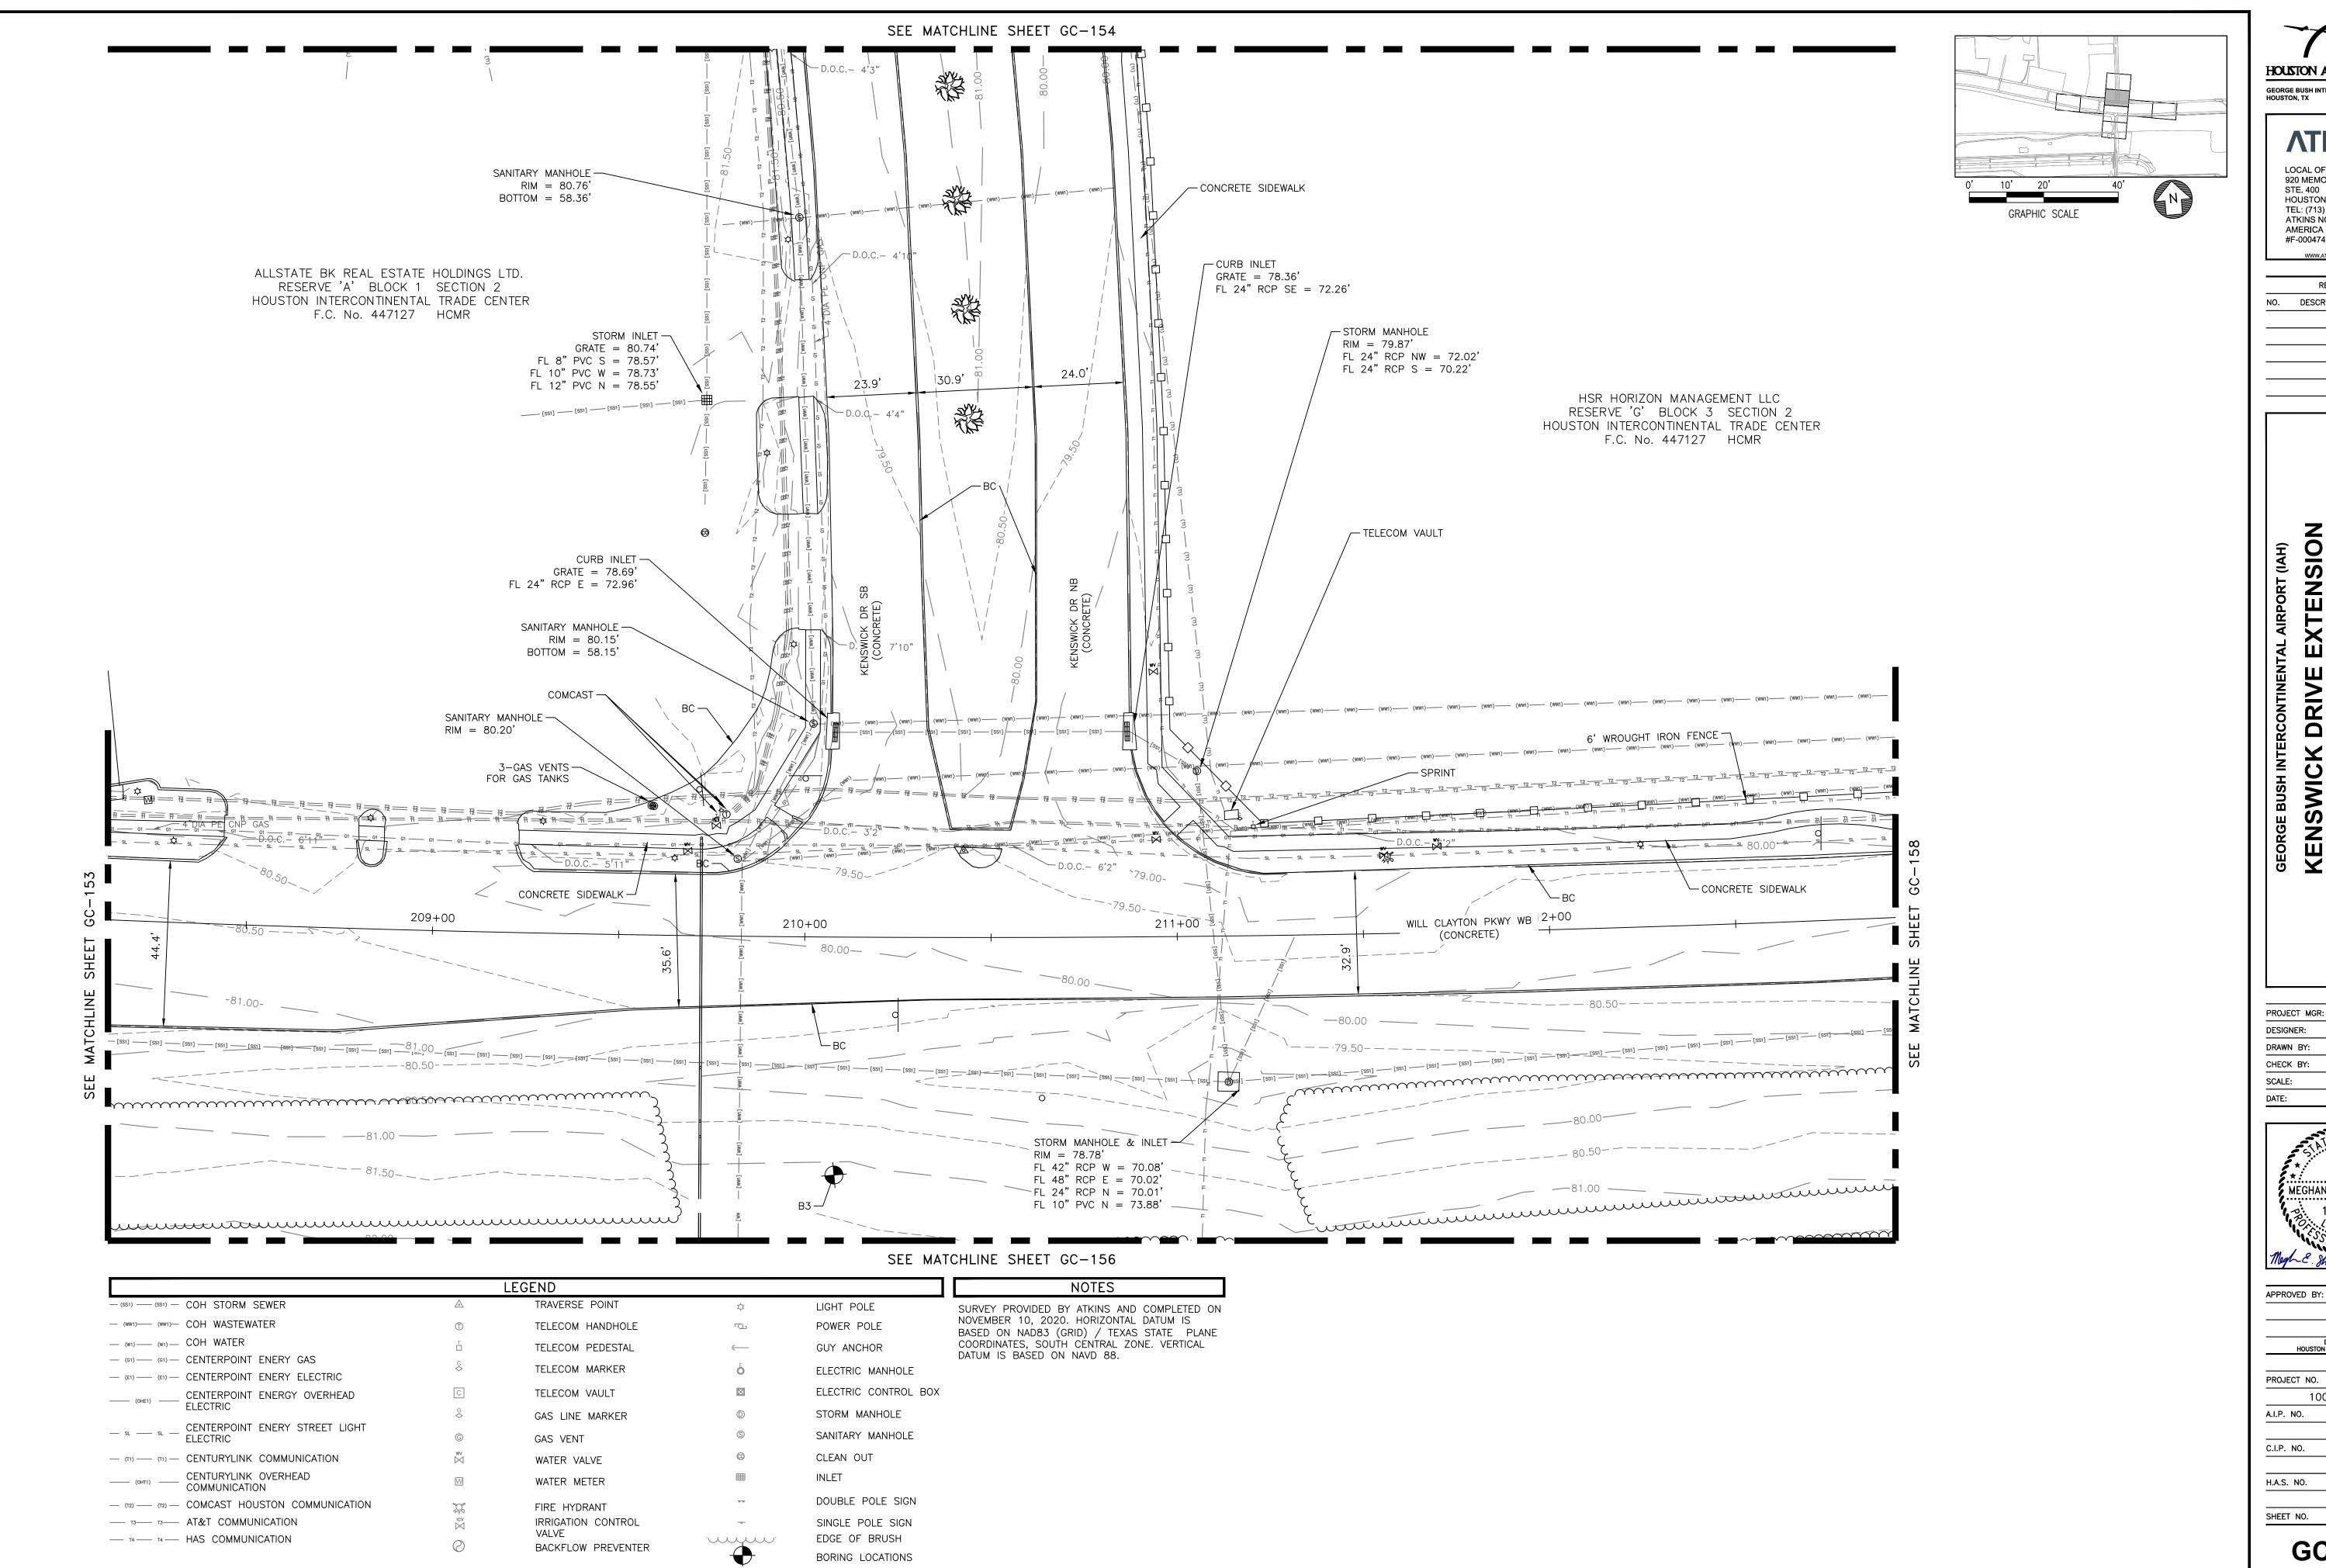
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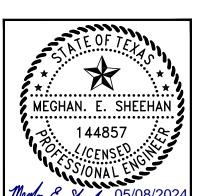
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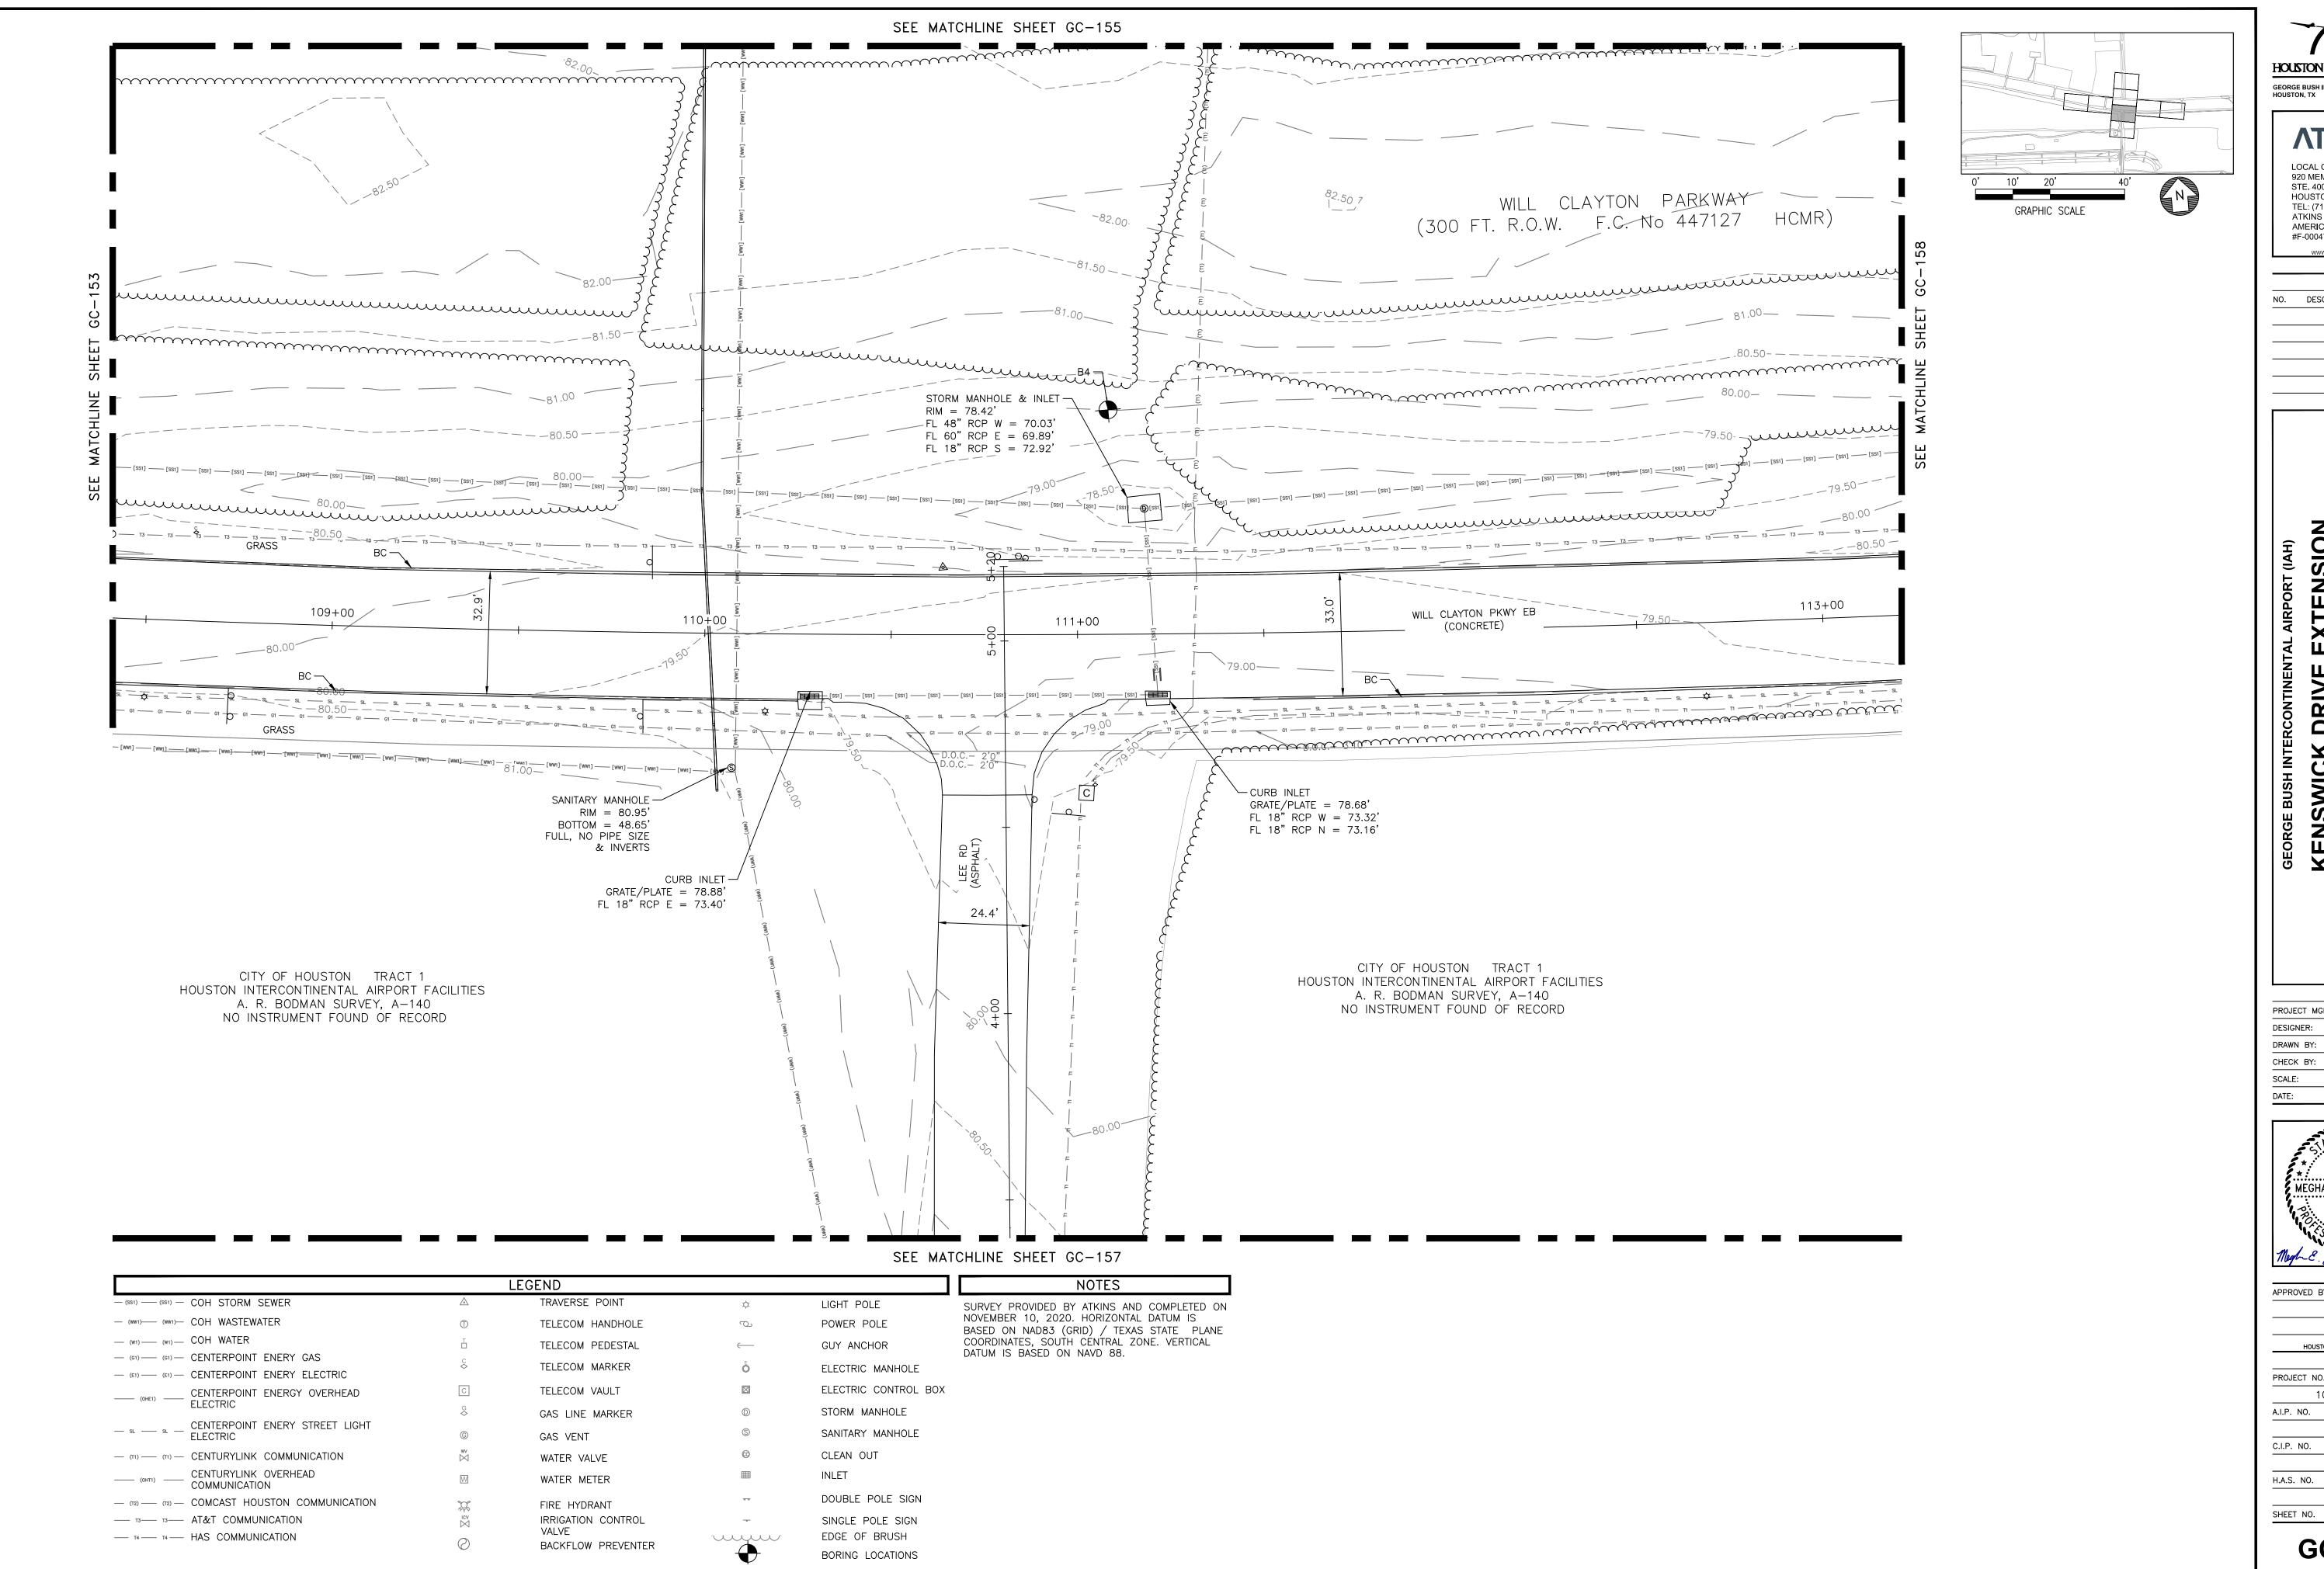
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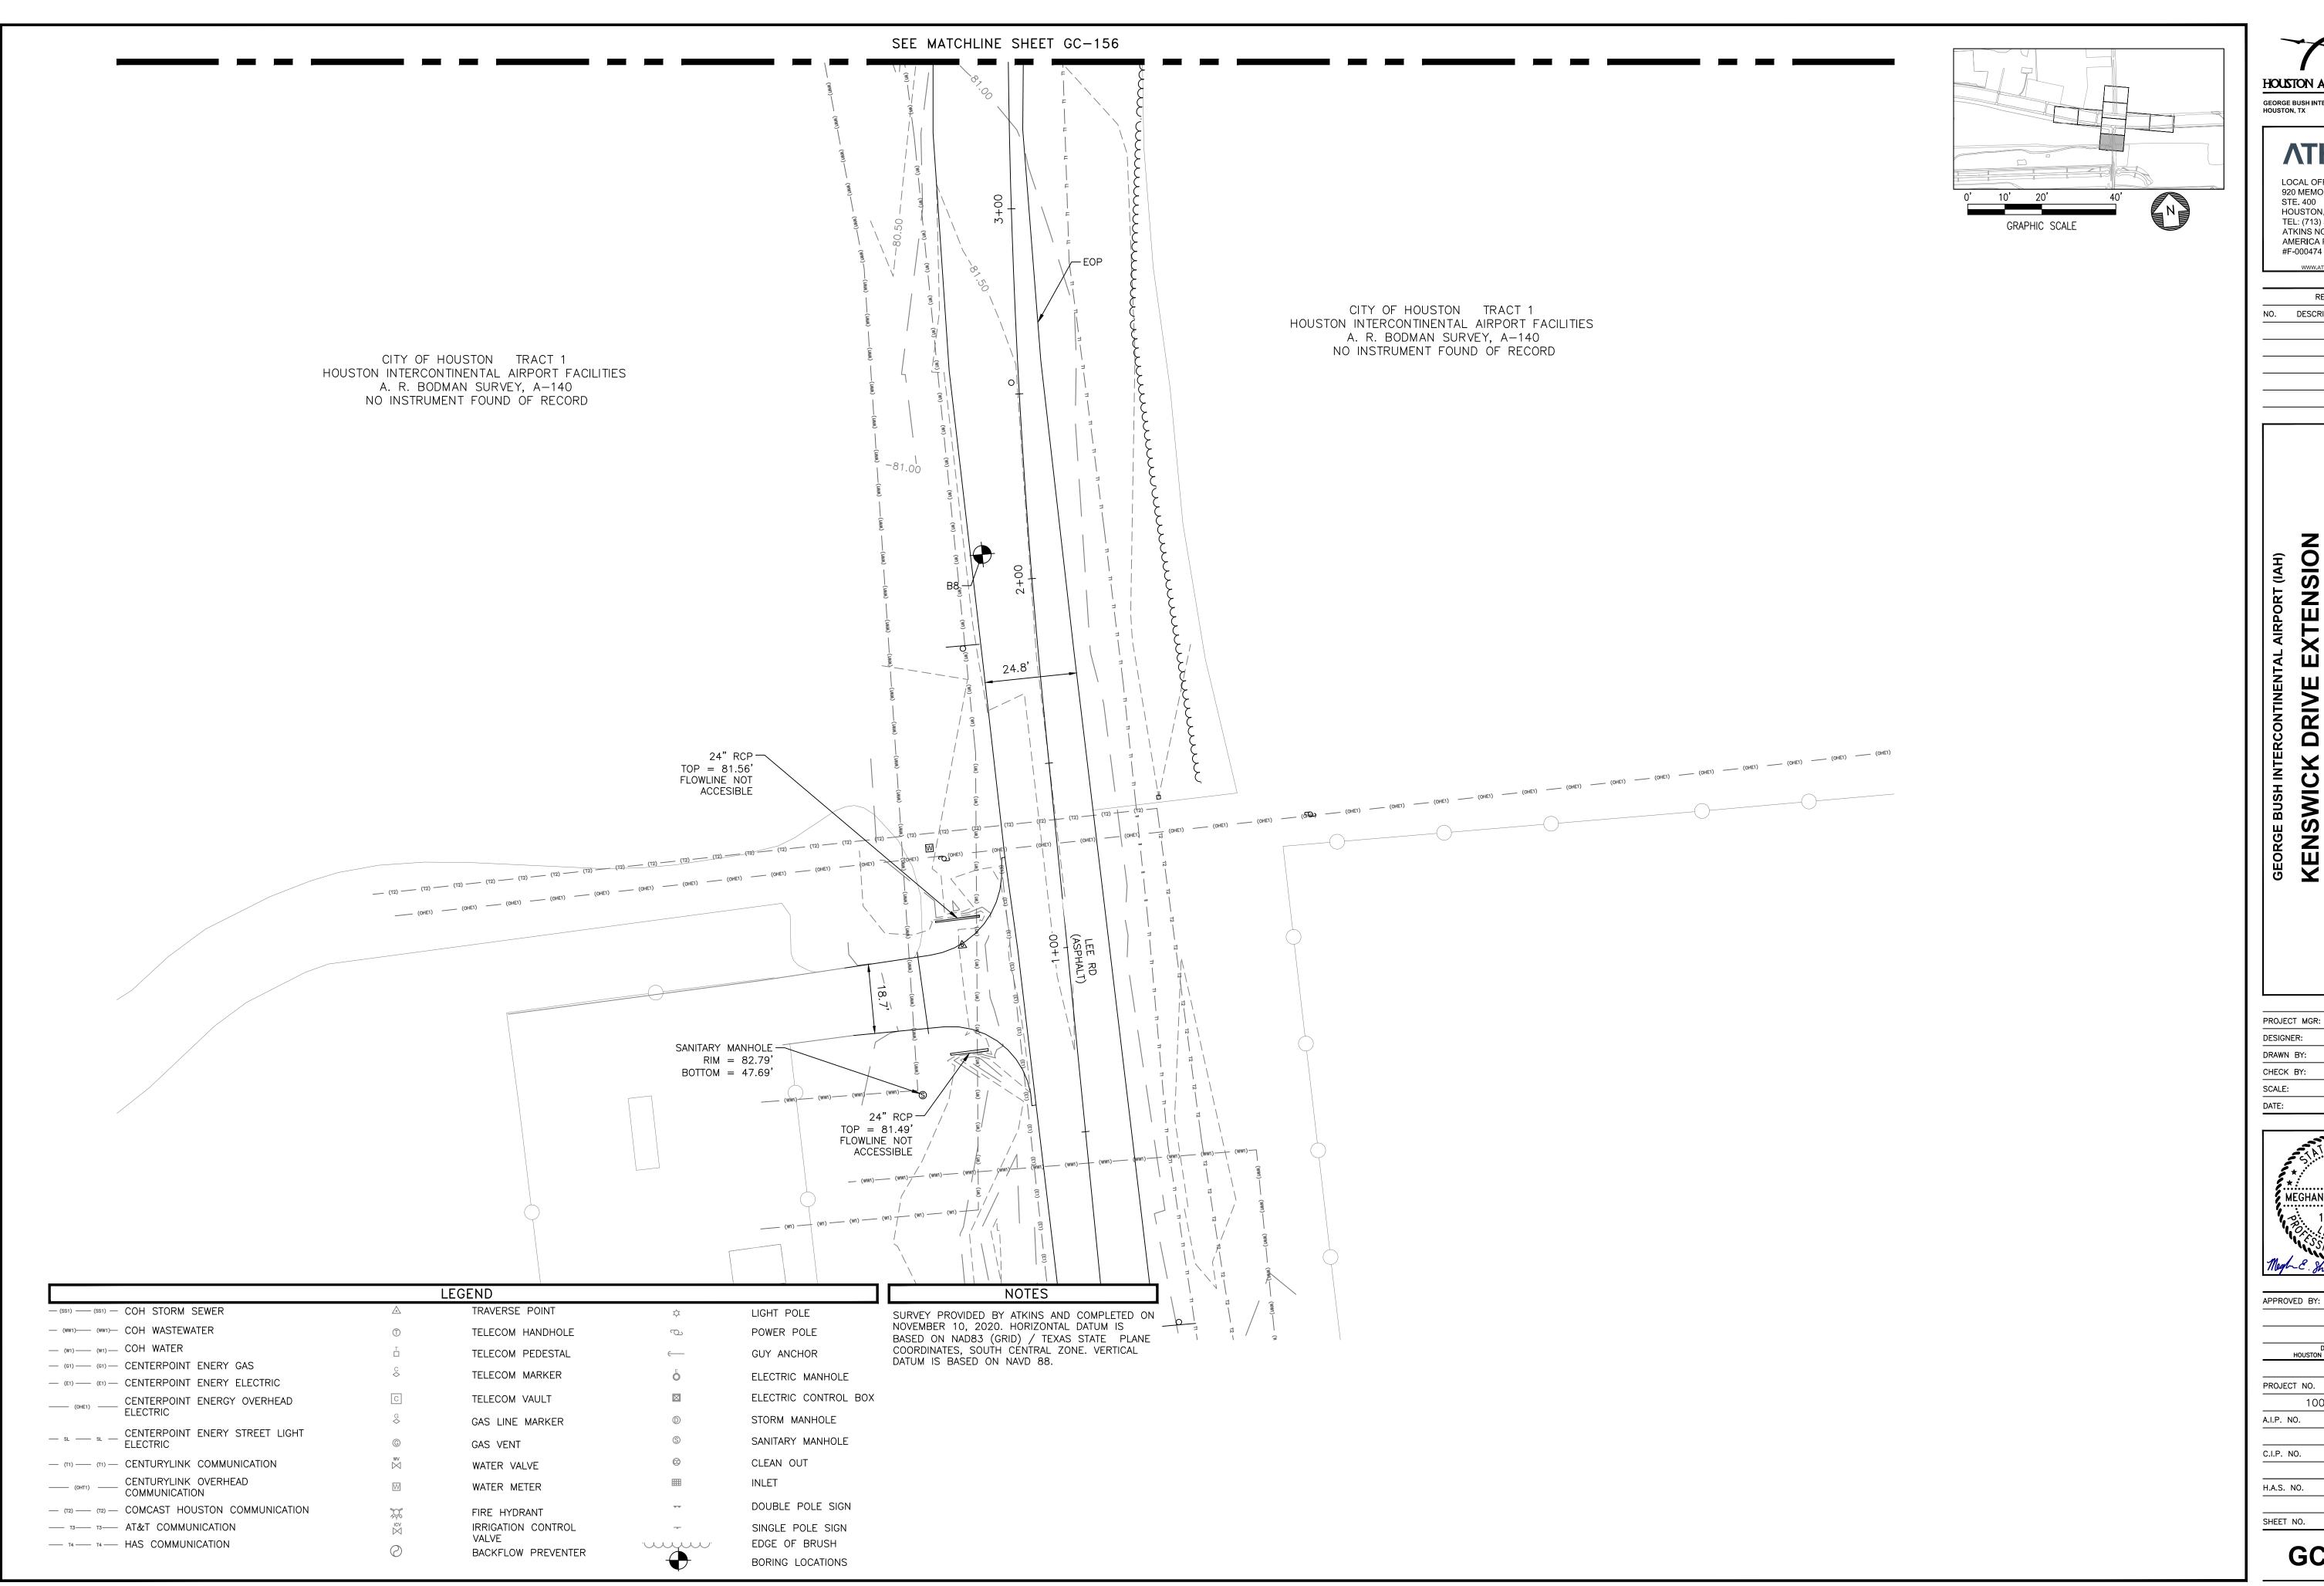


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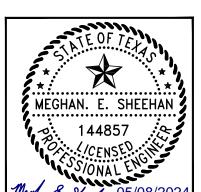


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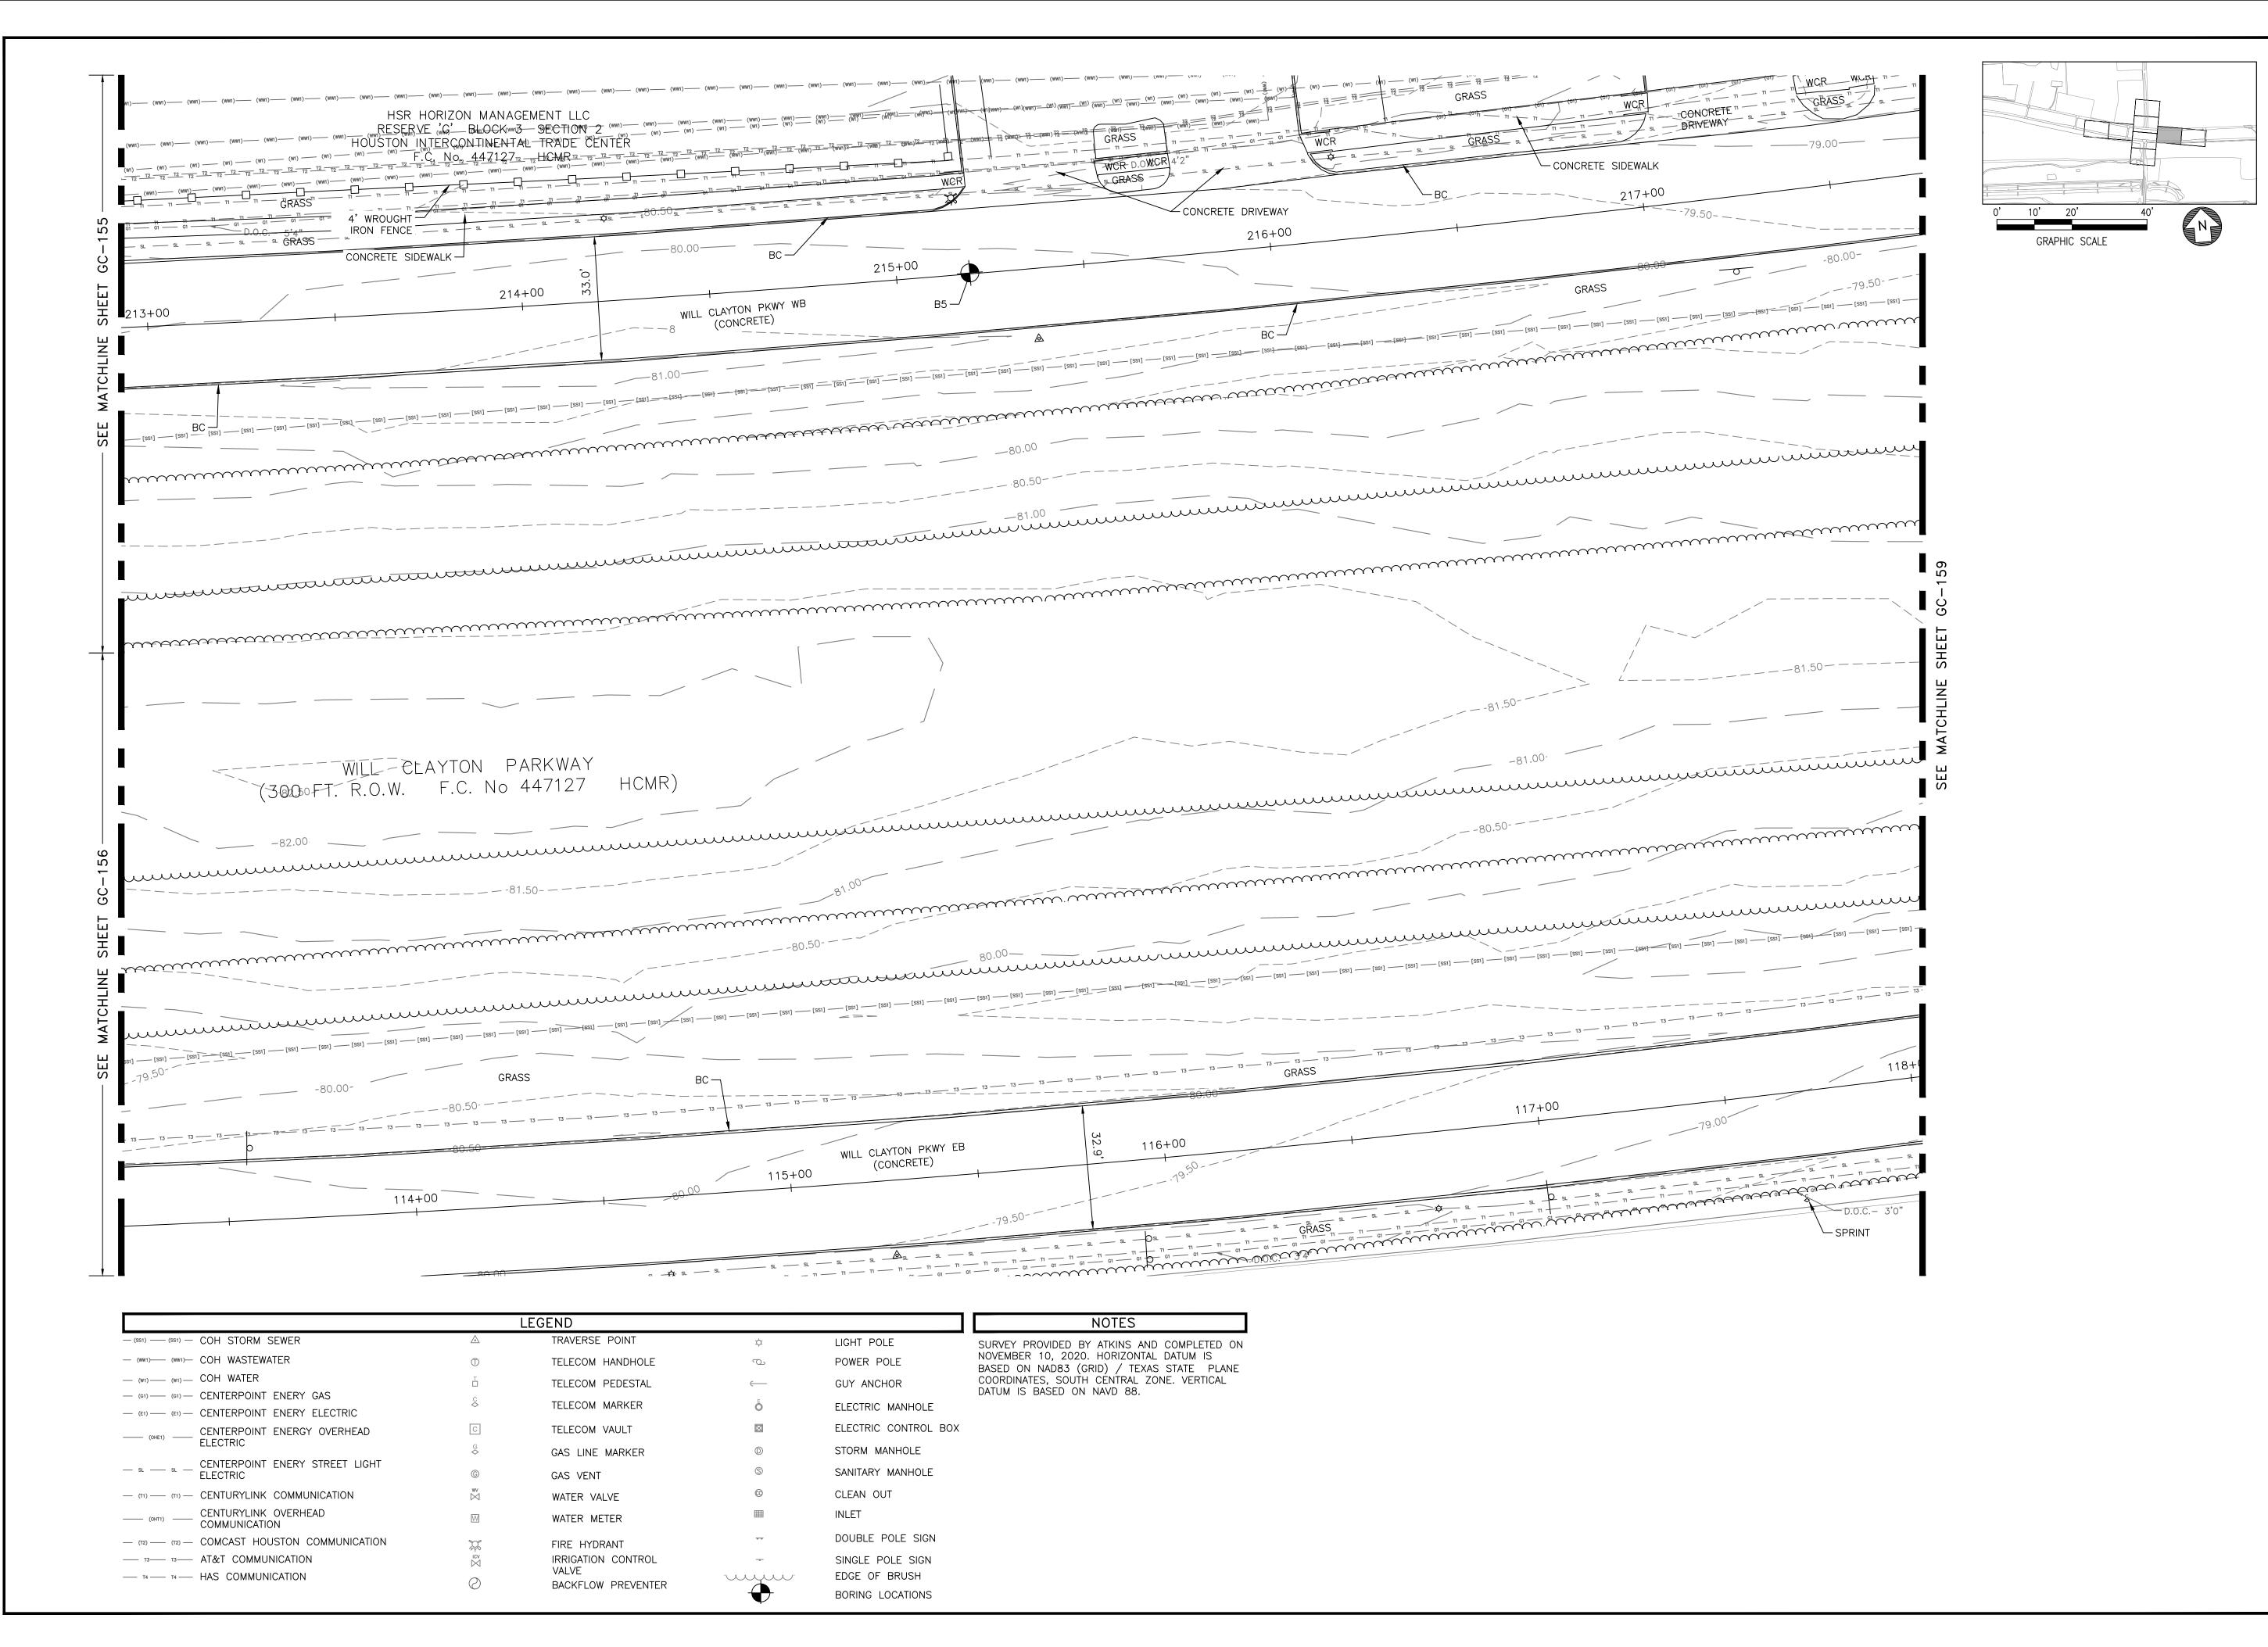
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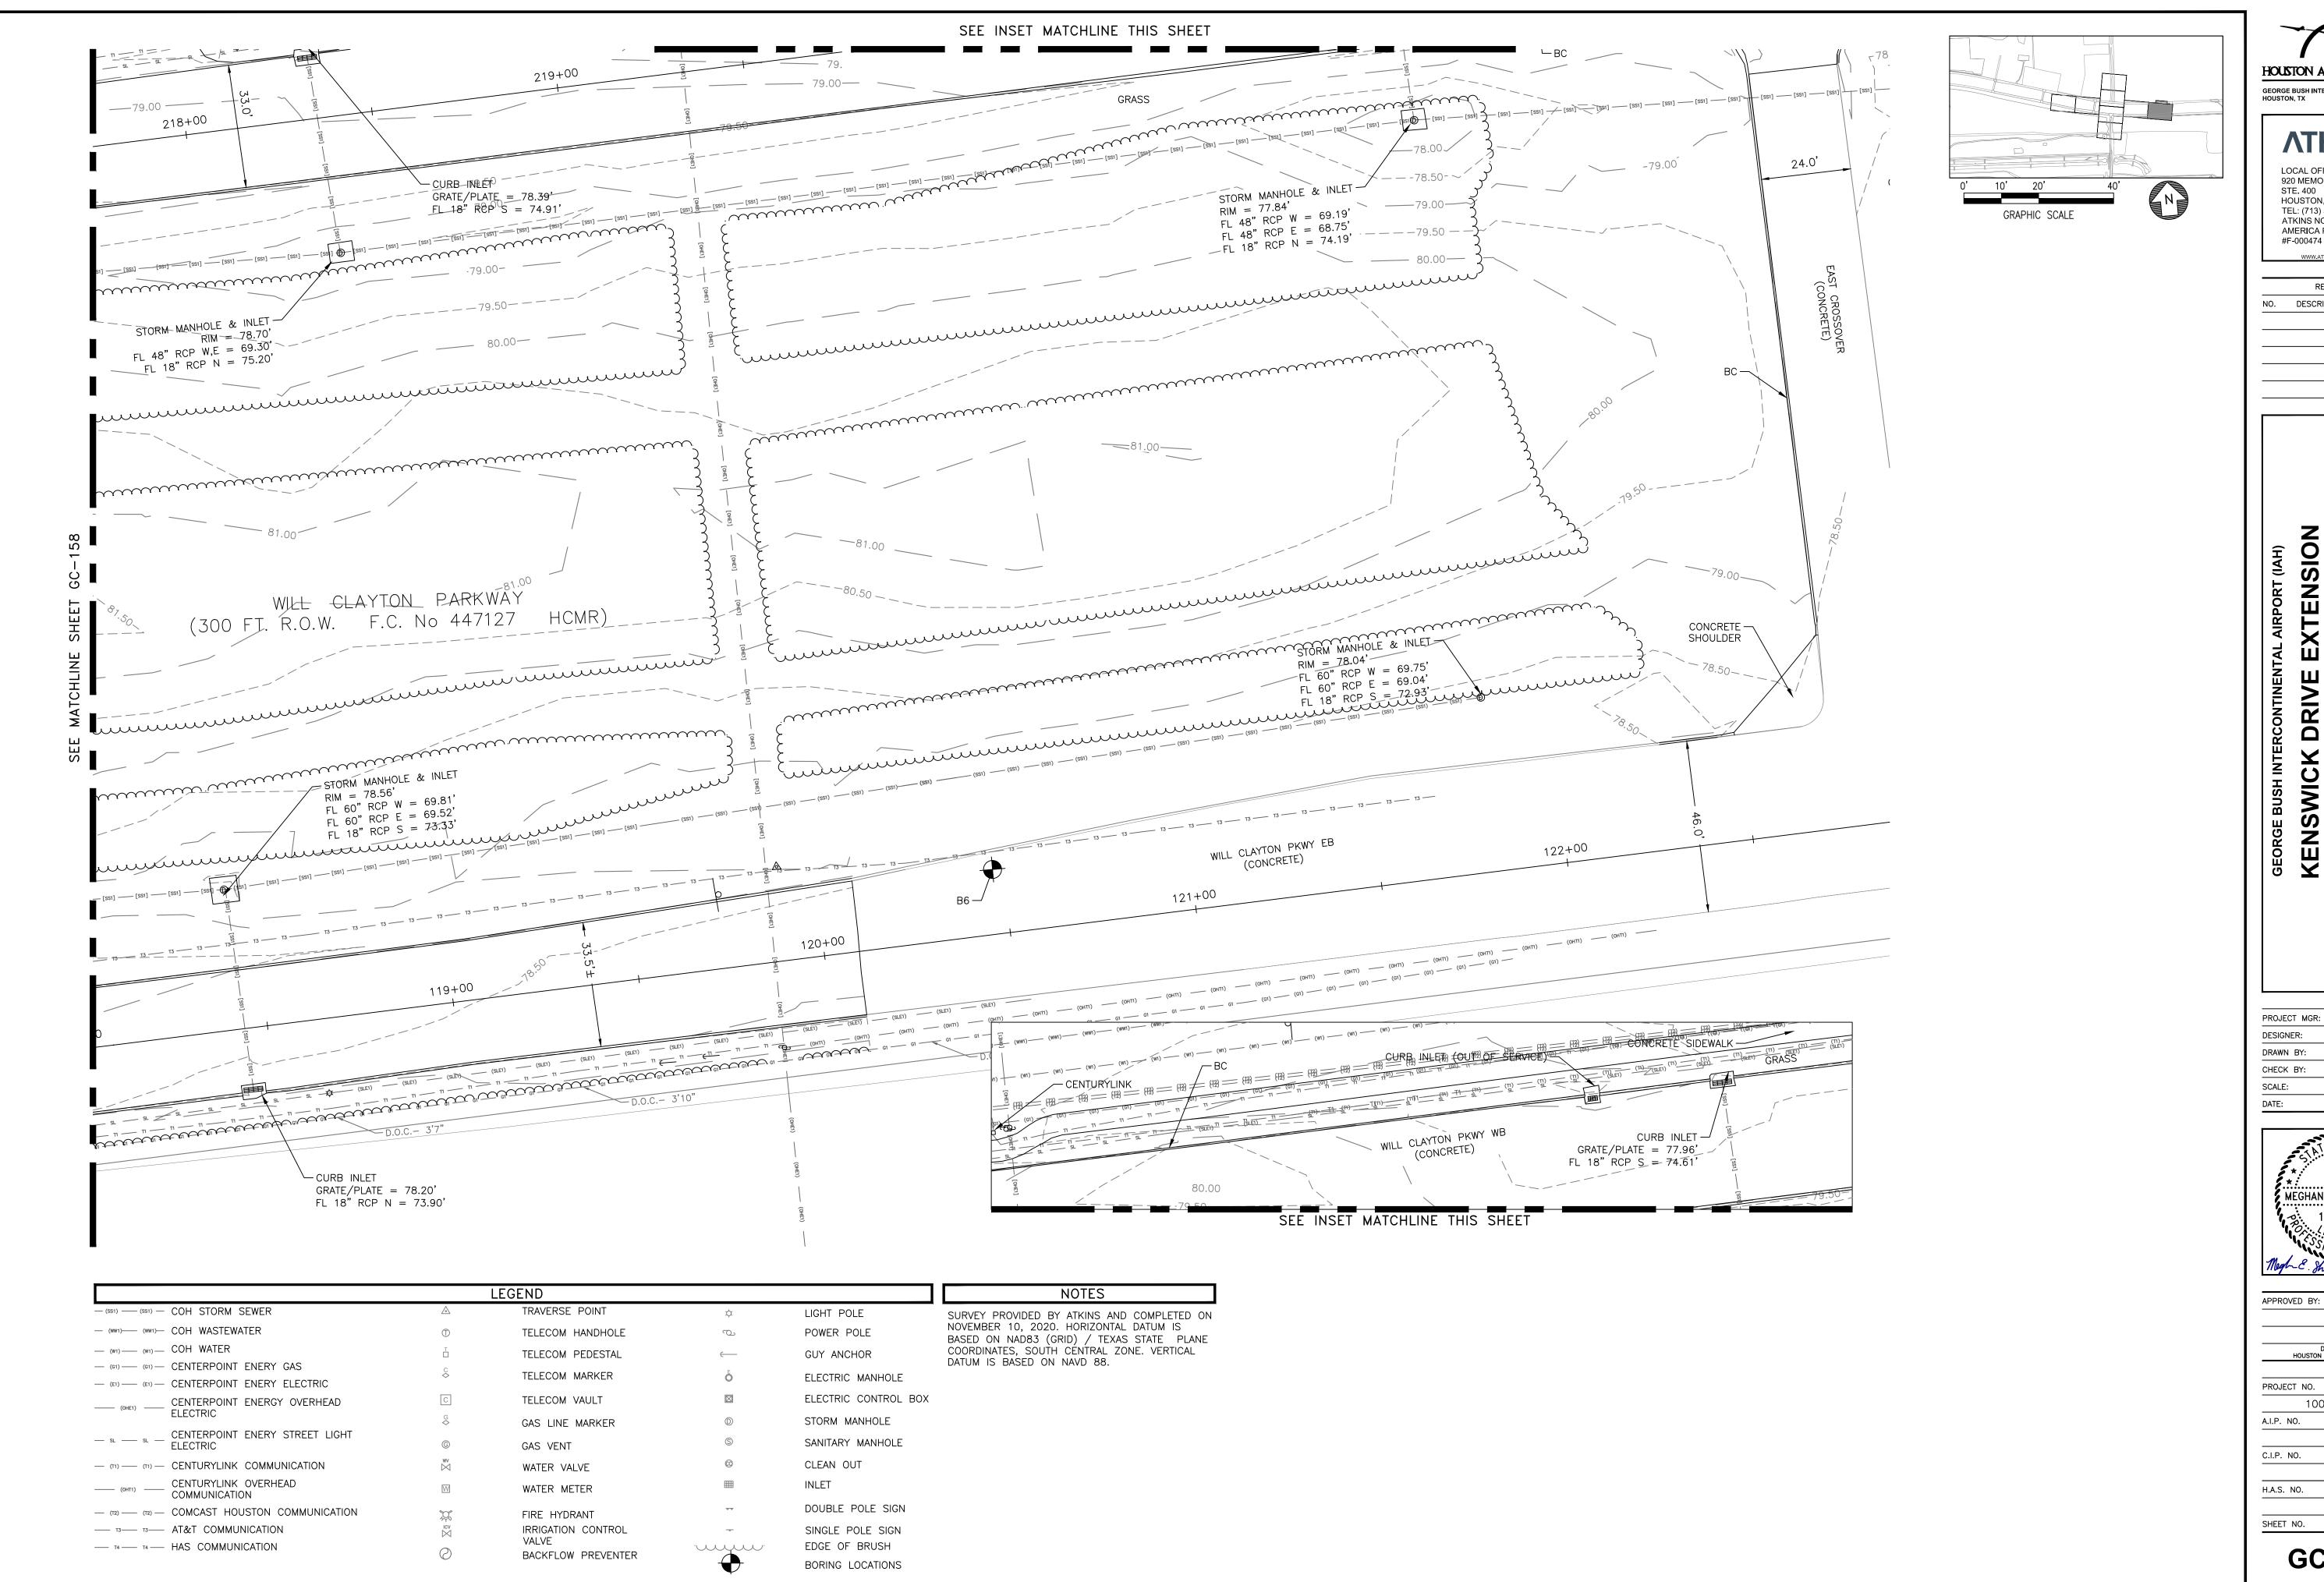
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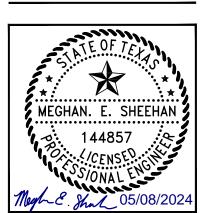
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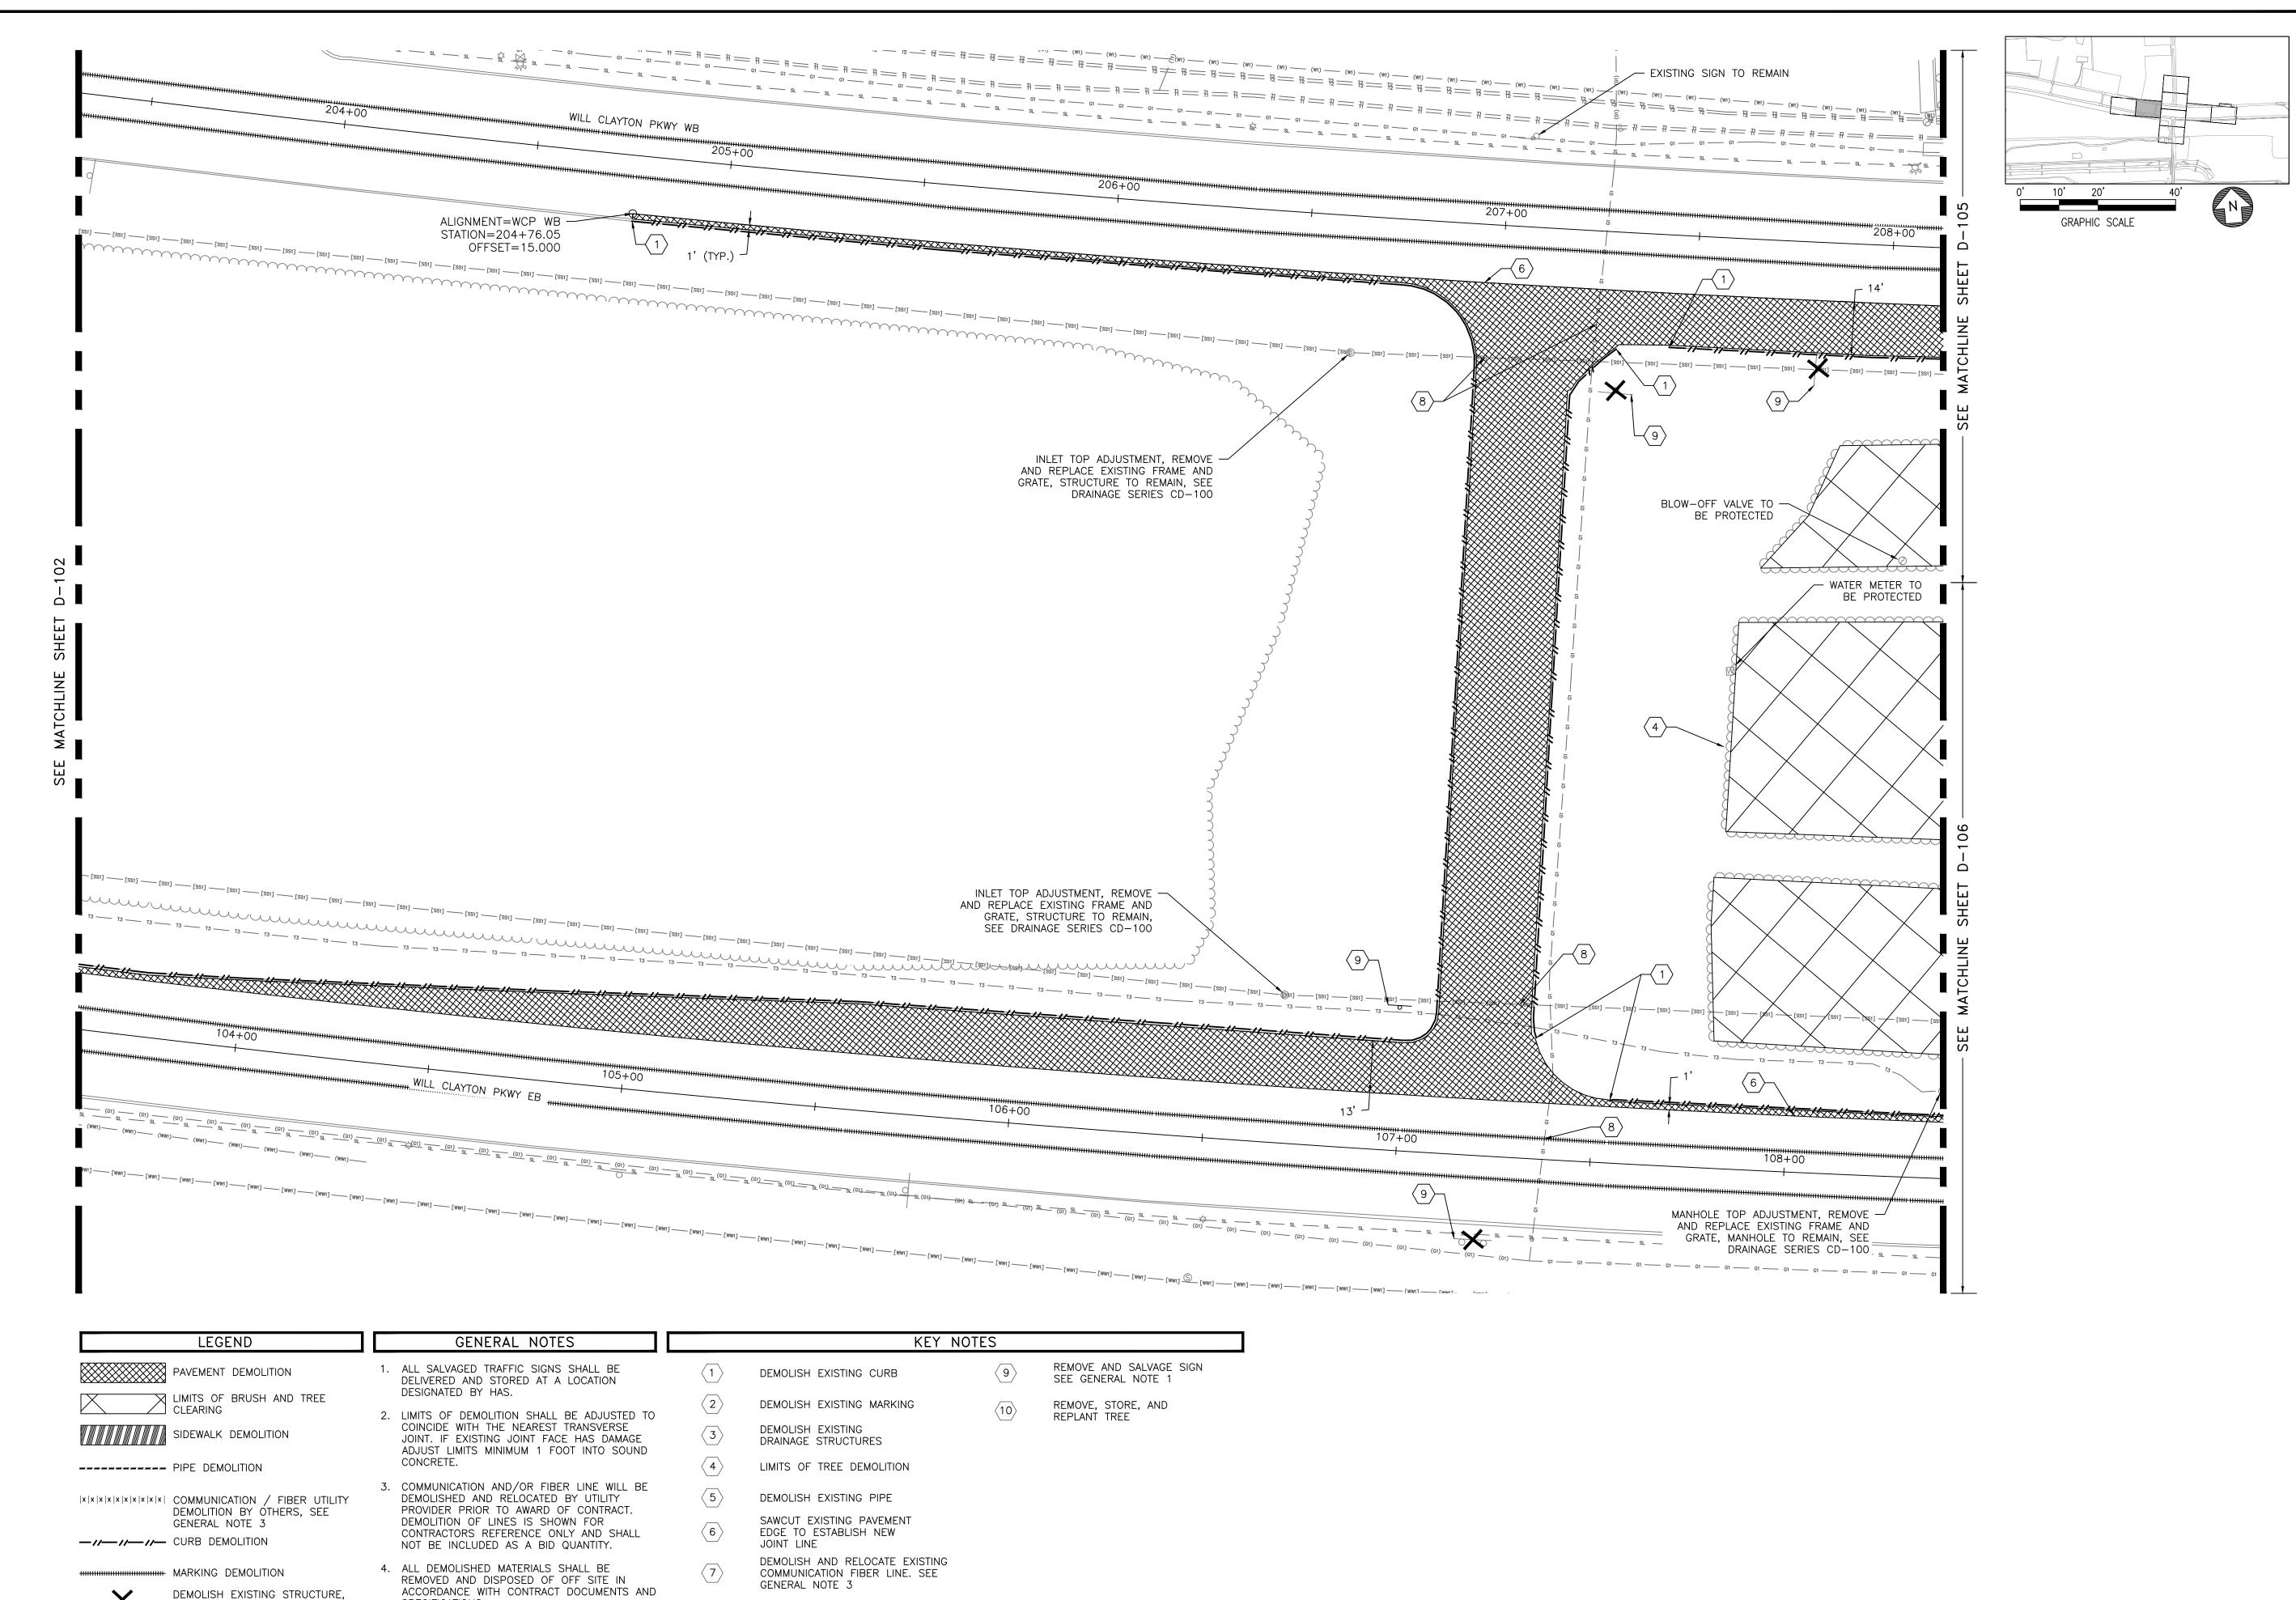
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PROJECT NO. 100072032

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SPECIFICATIONS.

PROTECT EXISTING UTILITIES

SIGN, TREE, ETC.

HOUSTON AIRPORT SYSTEM

GEORGE BUSH INTERCONTINENTAL AIRPORT

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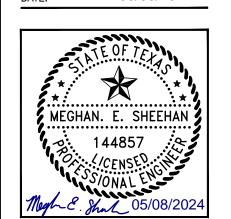
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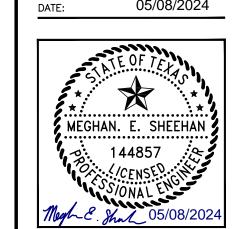
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----- PIPE DEMOLITION

|x|x|x|x|x|x|x|x|x| COMMUNICATION / FIBER UTILITY DEMOLITION BY ÓTHERS, SEE GENERAL NOTE 3 -//-//- CURB DEMOLITION

MARKING DEMOLITION DEMOLISH EXISTING STRUCTURE, SIGN, TREE, ETC.

3. COMMUNICATION AND/OR FIBER LINE WILL BE DEMOLISHED AND RÉLOCATED BY UTILITY PROVIDER PRIOR TO AWARD OF CONTRACT. DEMOLITION OF LINES IS SHOWN FOR CONTRACTORS REFERENCE ONLY AND SHALL

4. ALL DEMOLISHED MATERIALS SHALL BE REMOVED AND DISPOSED OF OFF SITE IN

JOINT LINE

NOT BE INCLUDED AS A BID QUANTITY.

ACCORDANCE WITH CONTRACT DOCUMENTS AND SPECIFICATIONS.

LIMITS OF TREE DEMOLITION

SAWCUT EXISTING PAVEMENT EDGE TO ESTABLISH NEW

GENERAL NOTE 3

DEMOLISH EXISTING PIPE

DEMOLISH AND RELOCATE EXISTING COMMUNICATION FIBER LINE. SEE

PROTECT EXISTING UTILITIES

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HOUSTON AIRPORT SYSTEM GEORGE BUSH INTERCONTINENTAL AIRPORT / HOUSTON, TX

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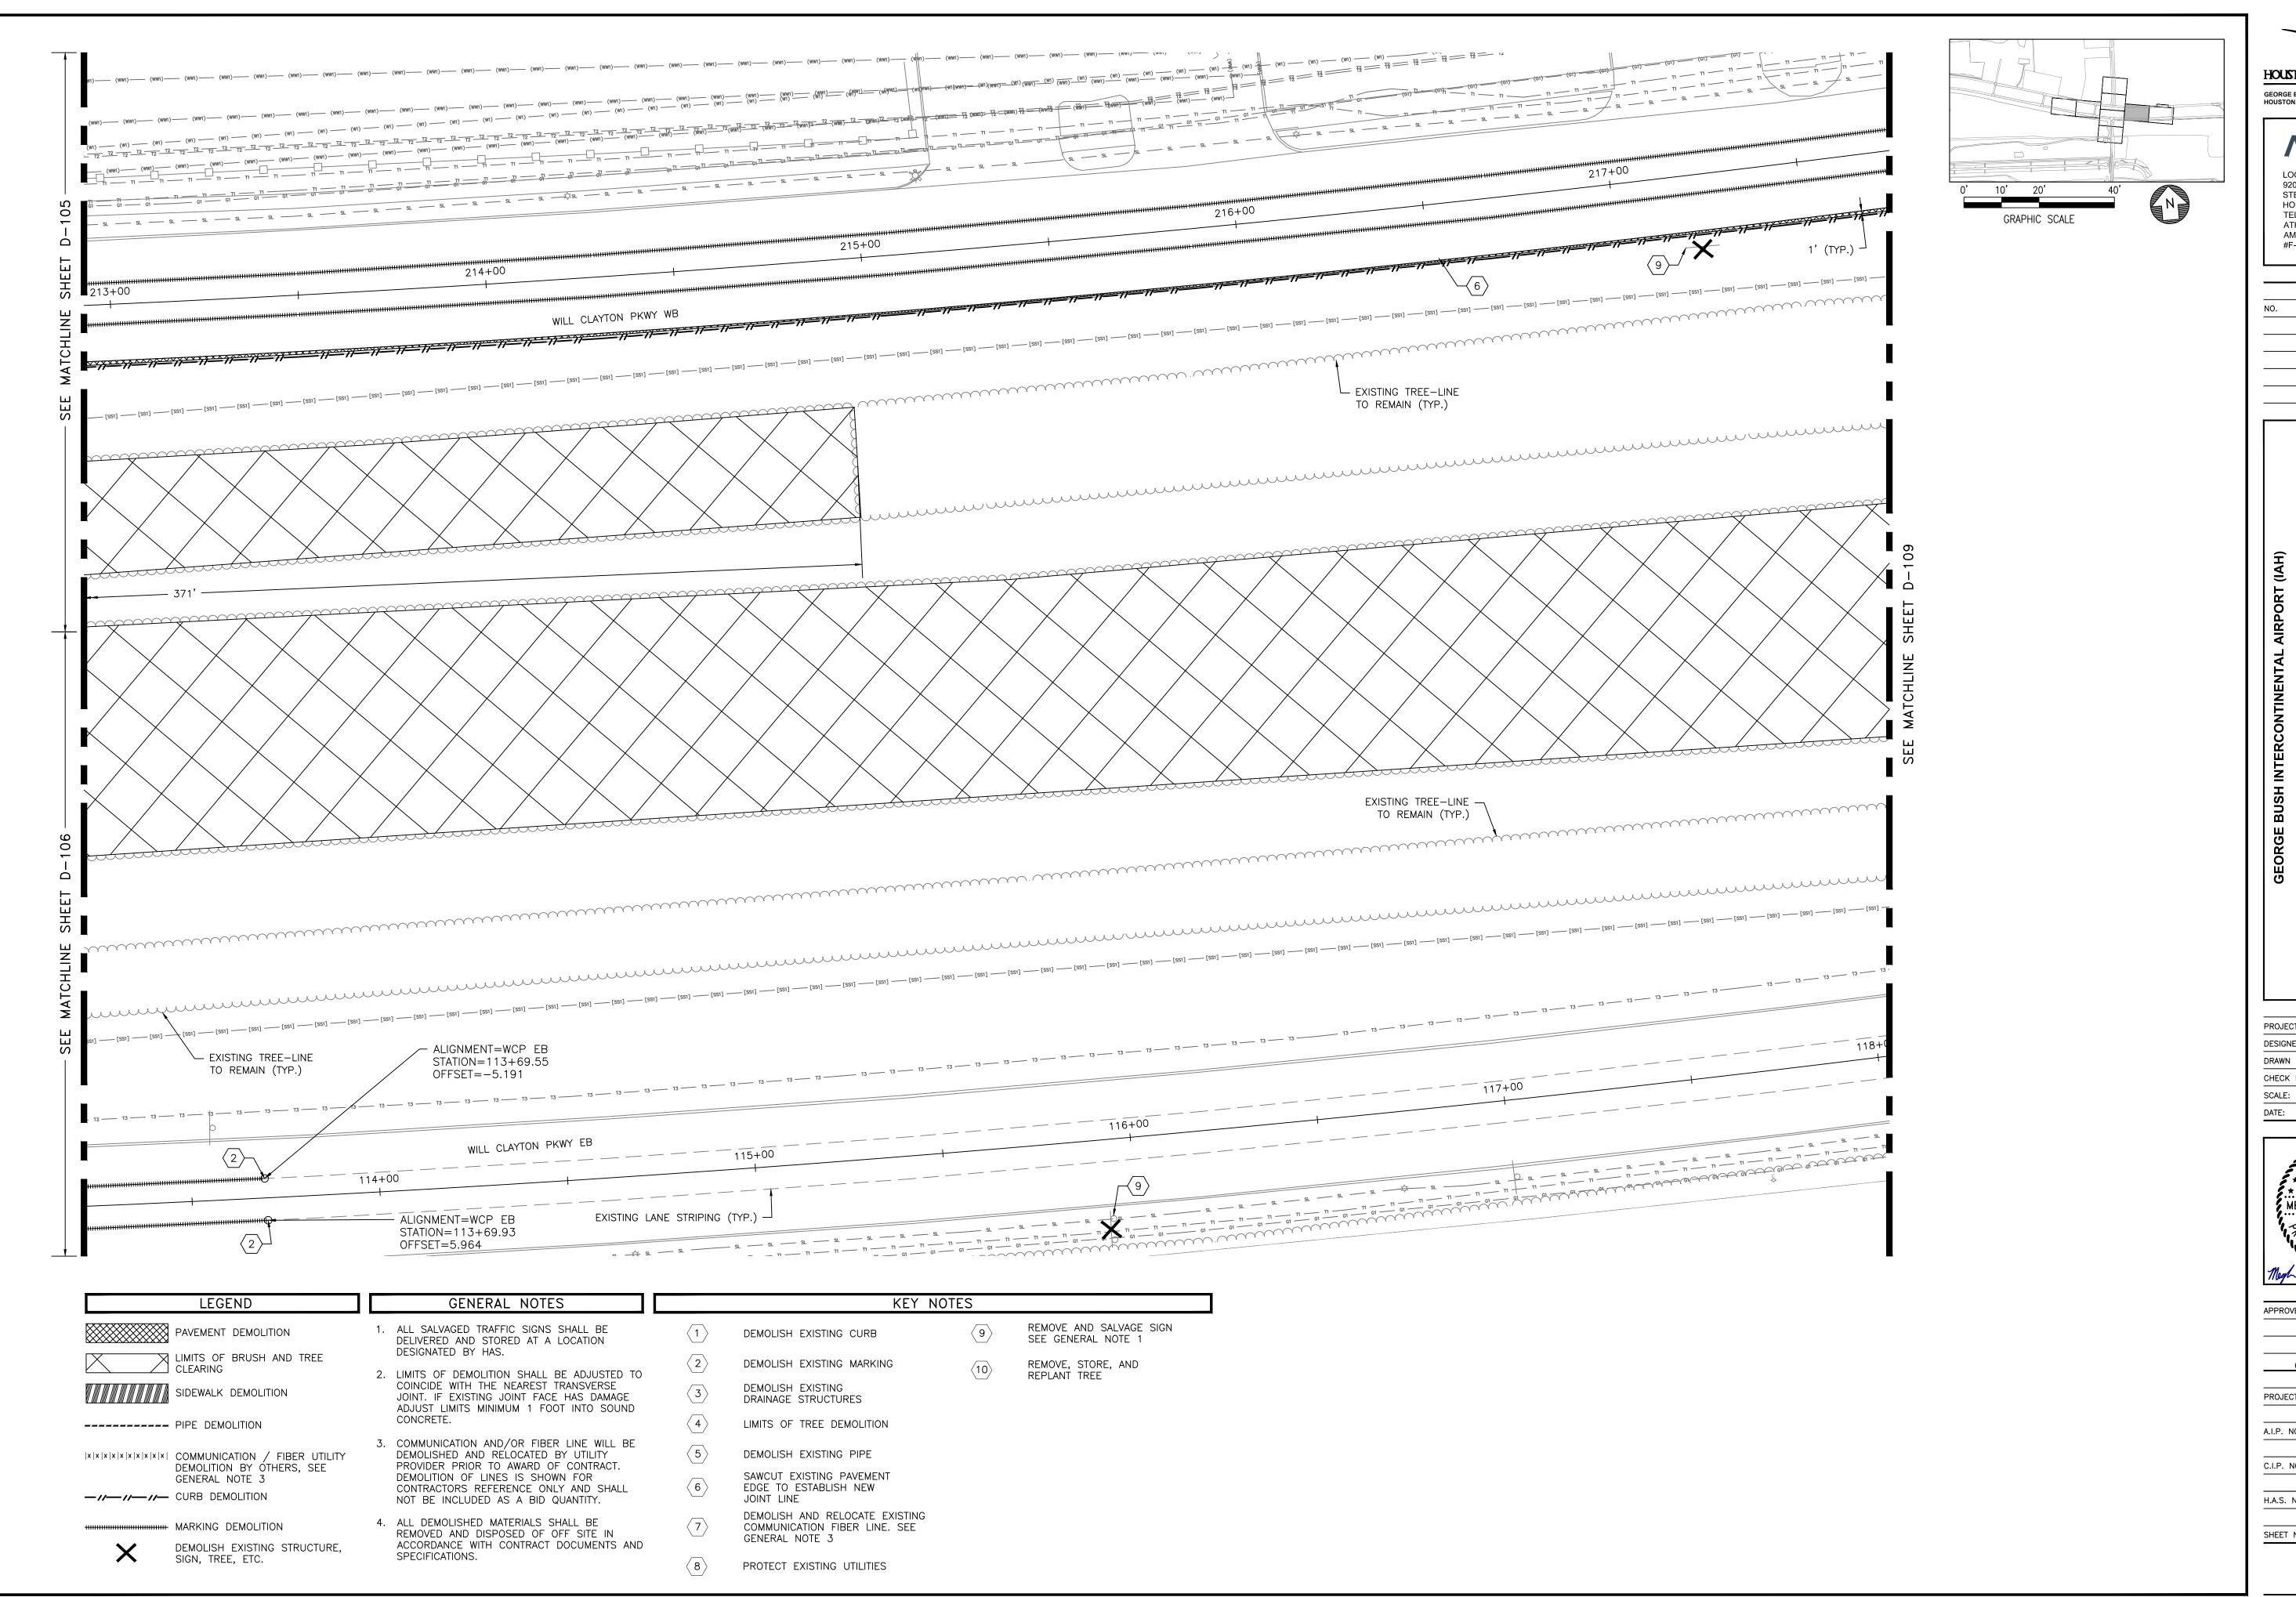
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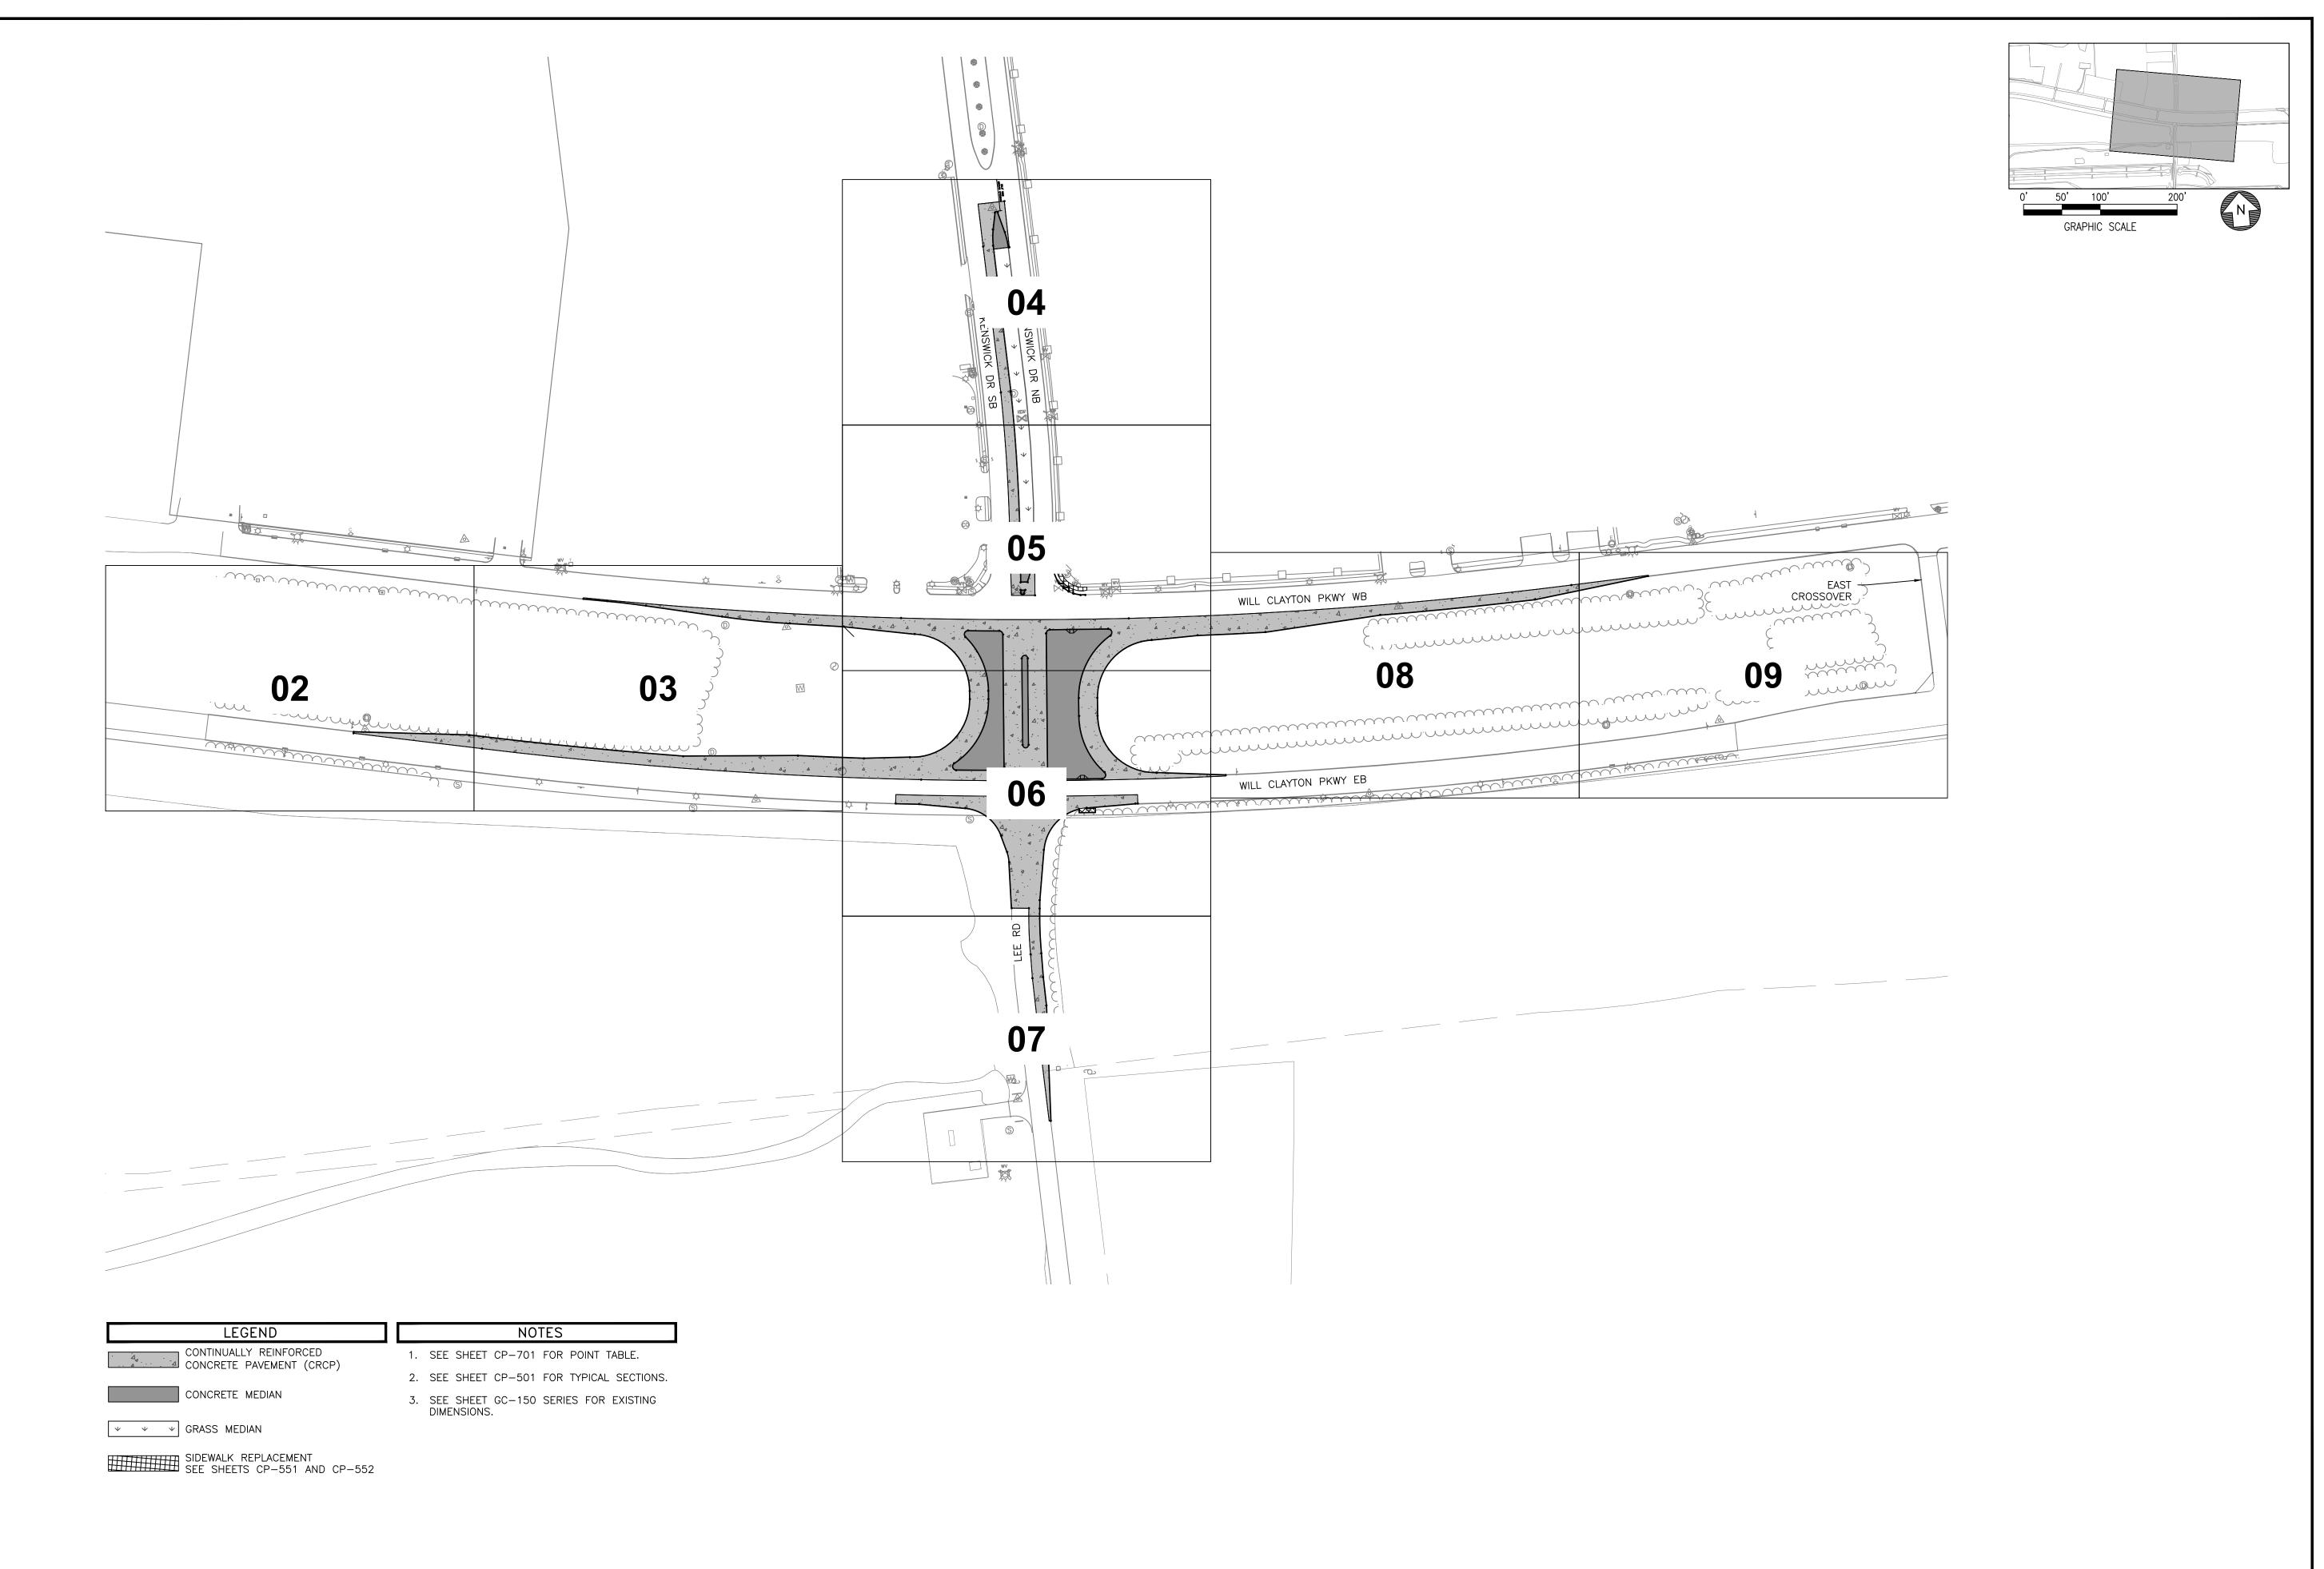
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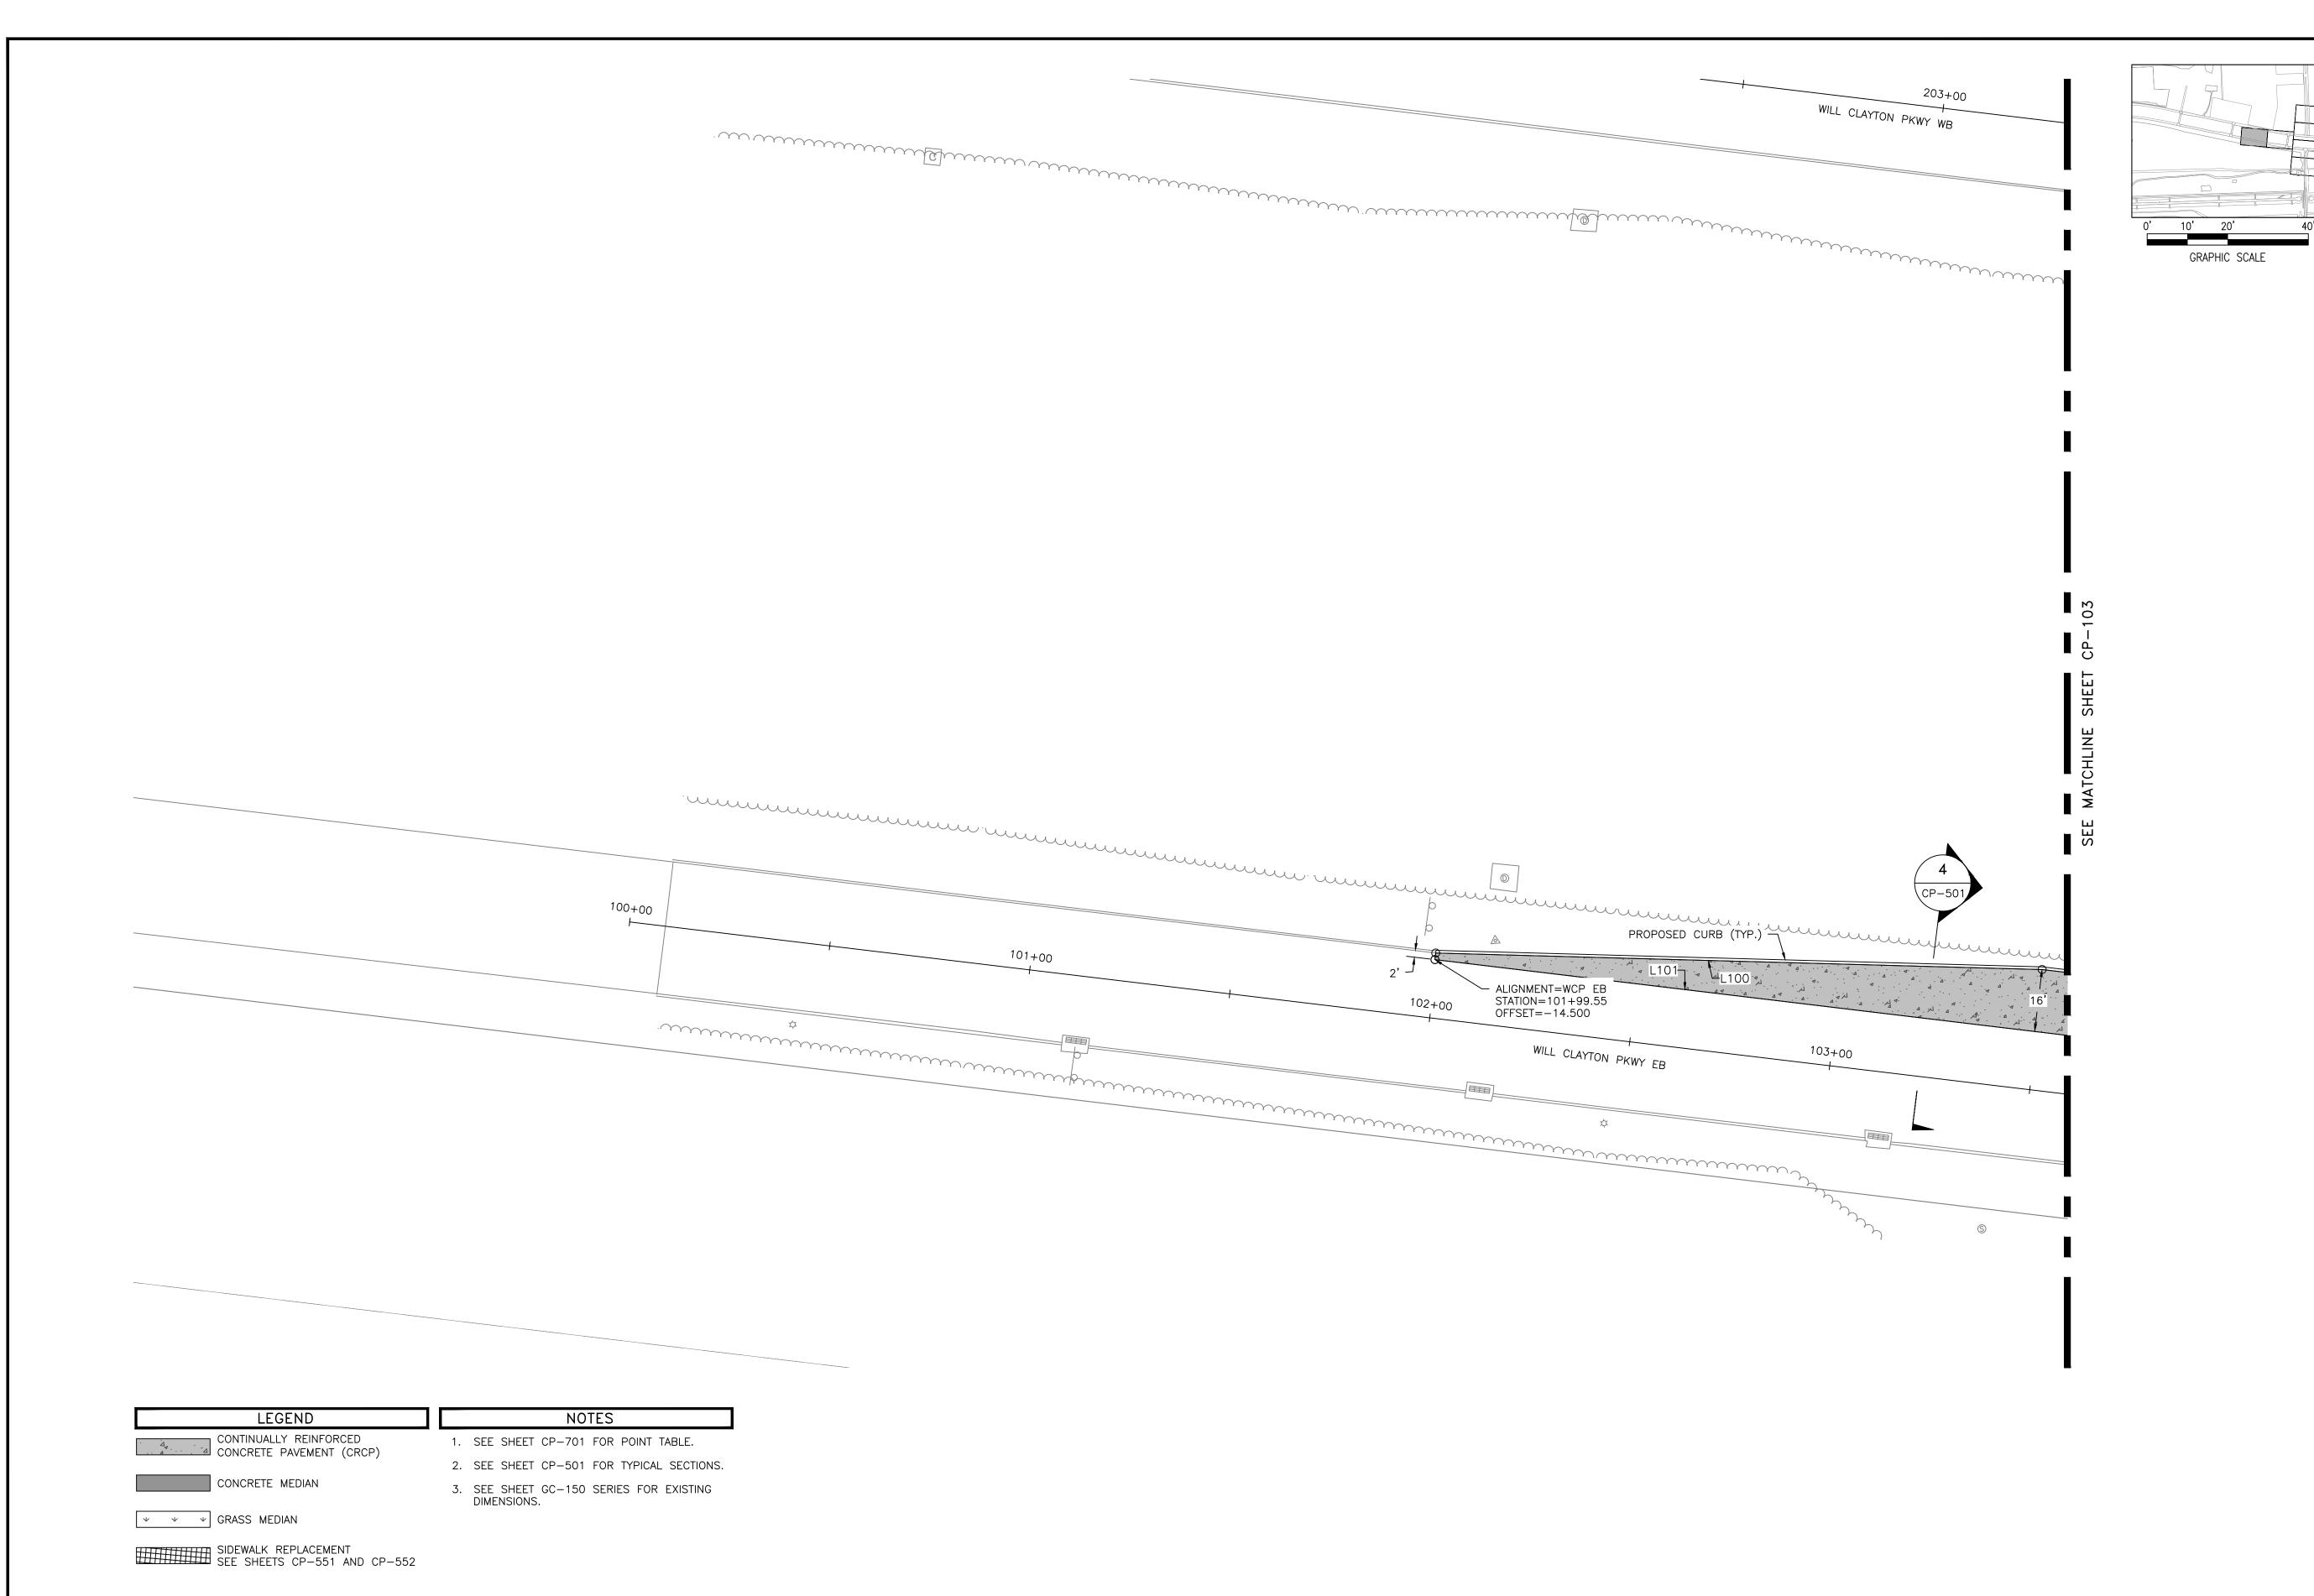
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LOCAL OFFICE:
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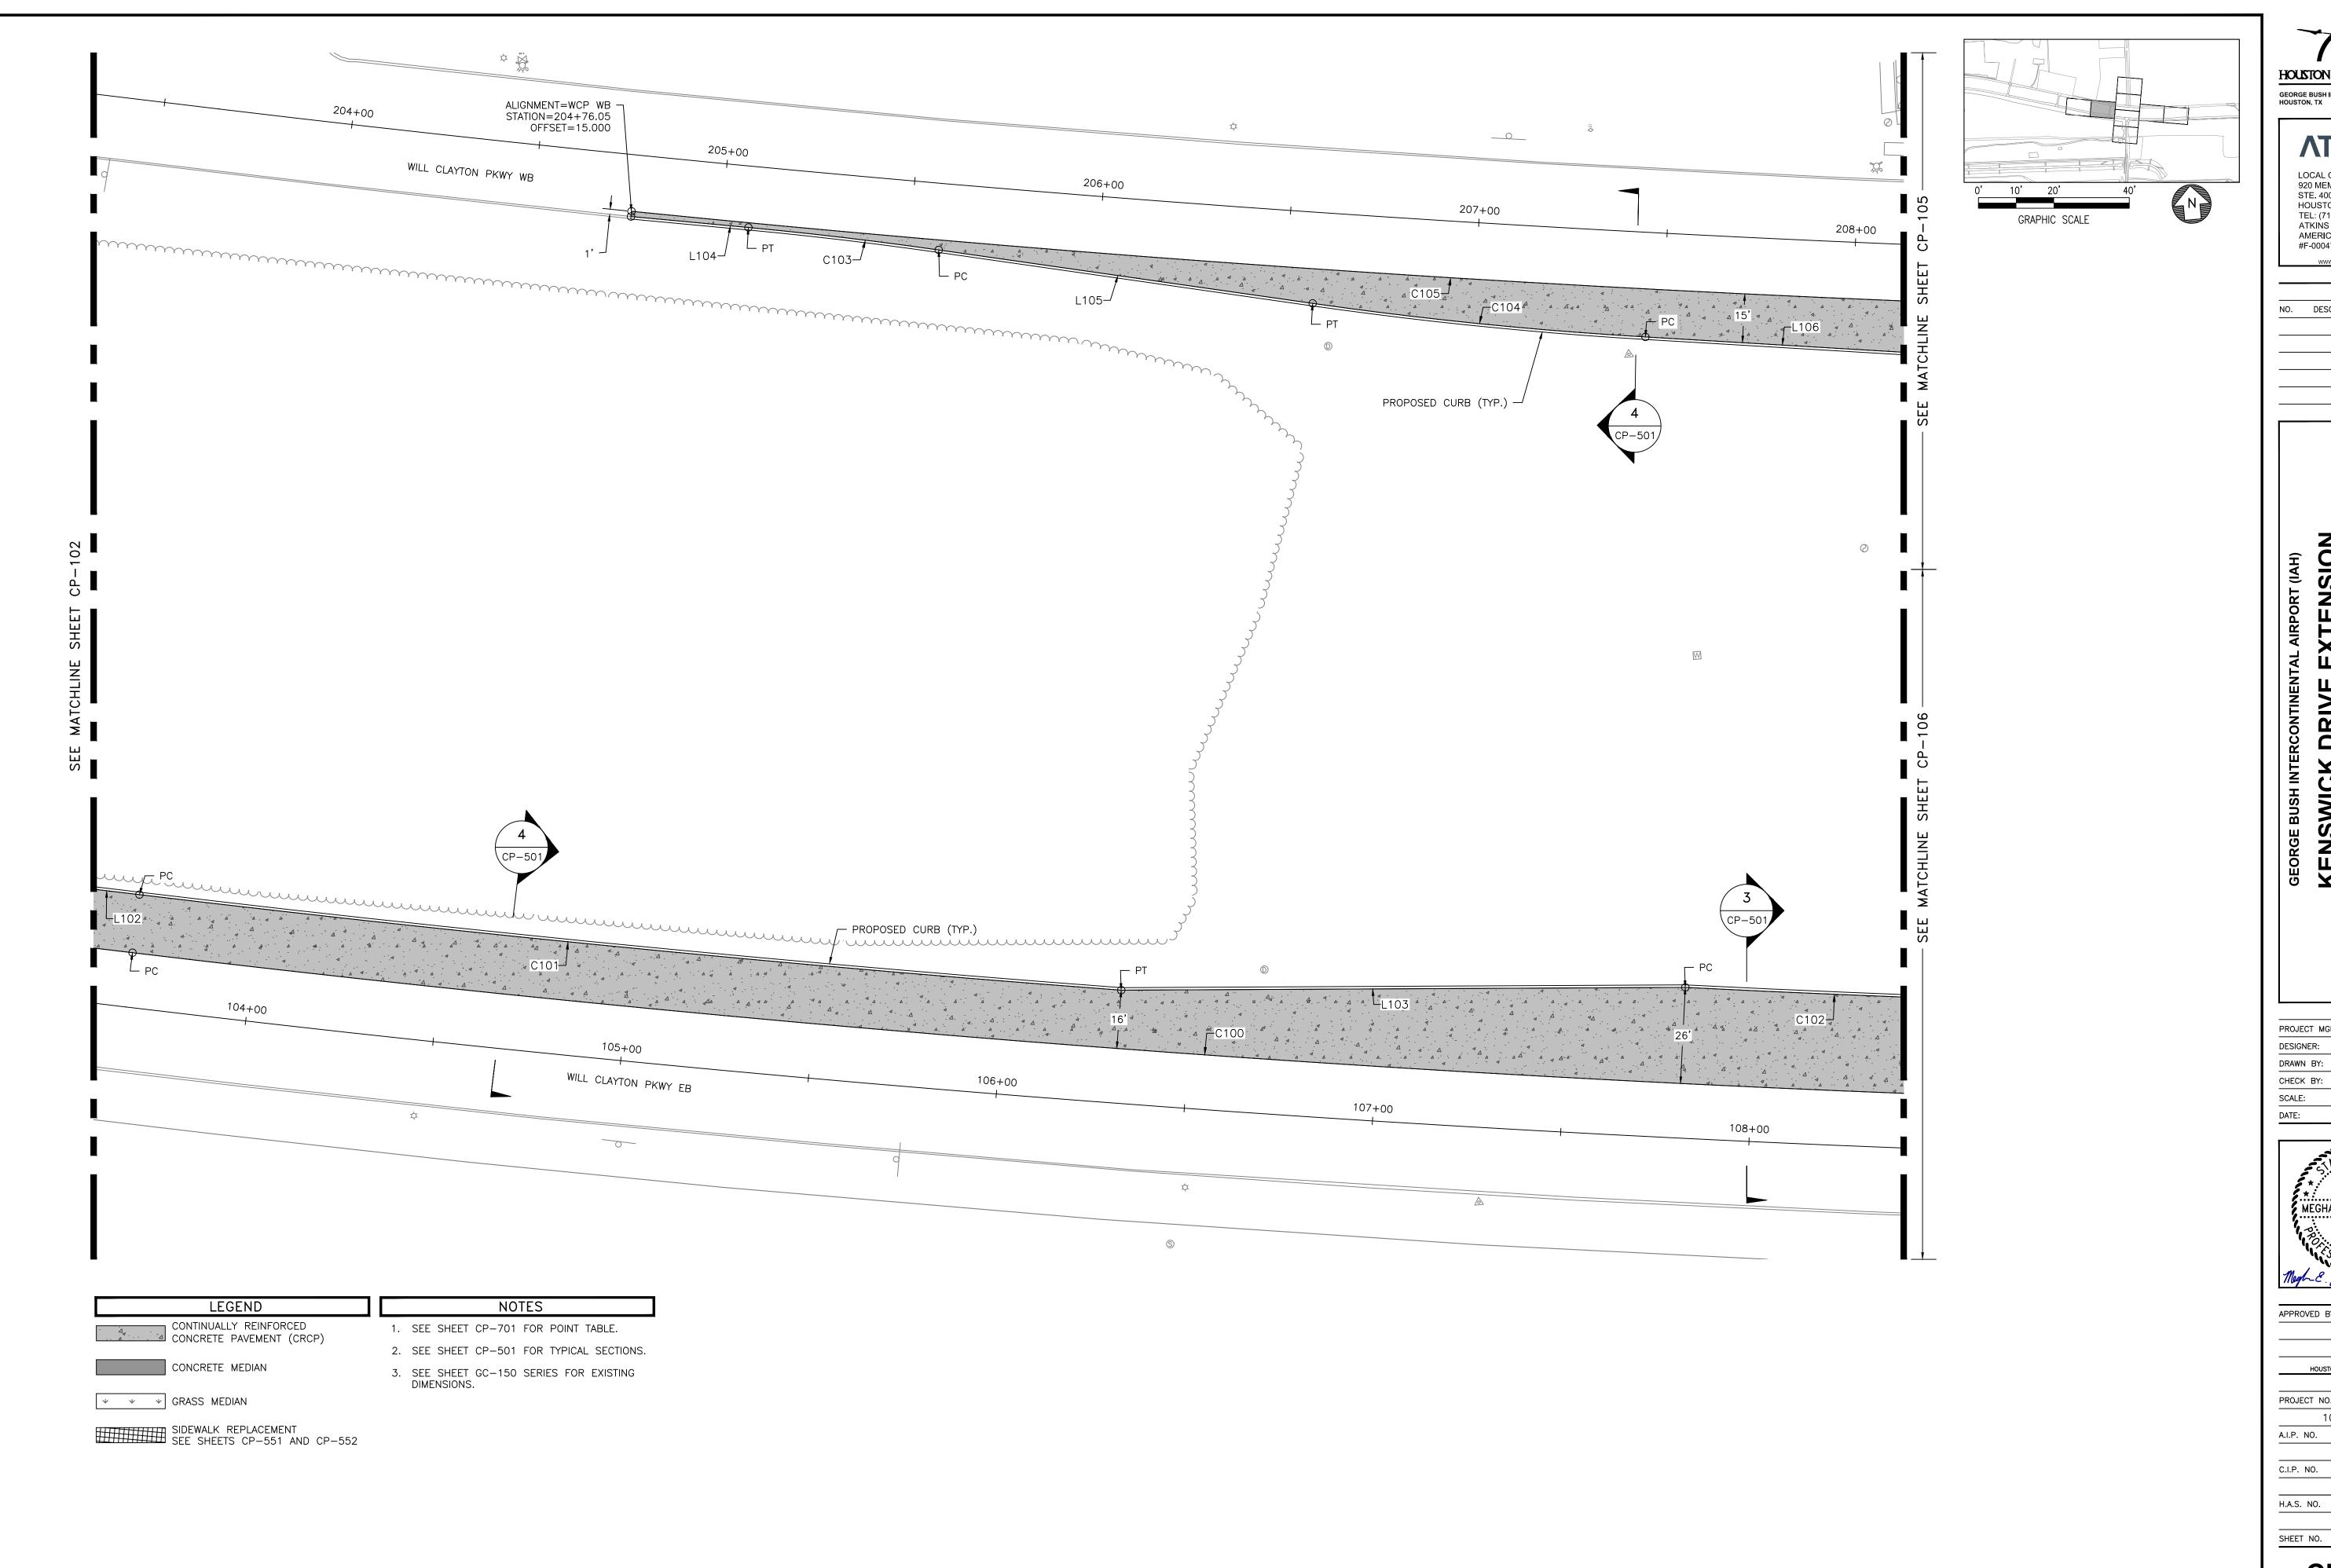
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HOUSTON AIRPORT SYSTEM GEORGE BUSH INTERCONTINENTAL AIRPORT /

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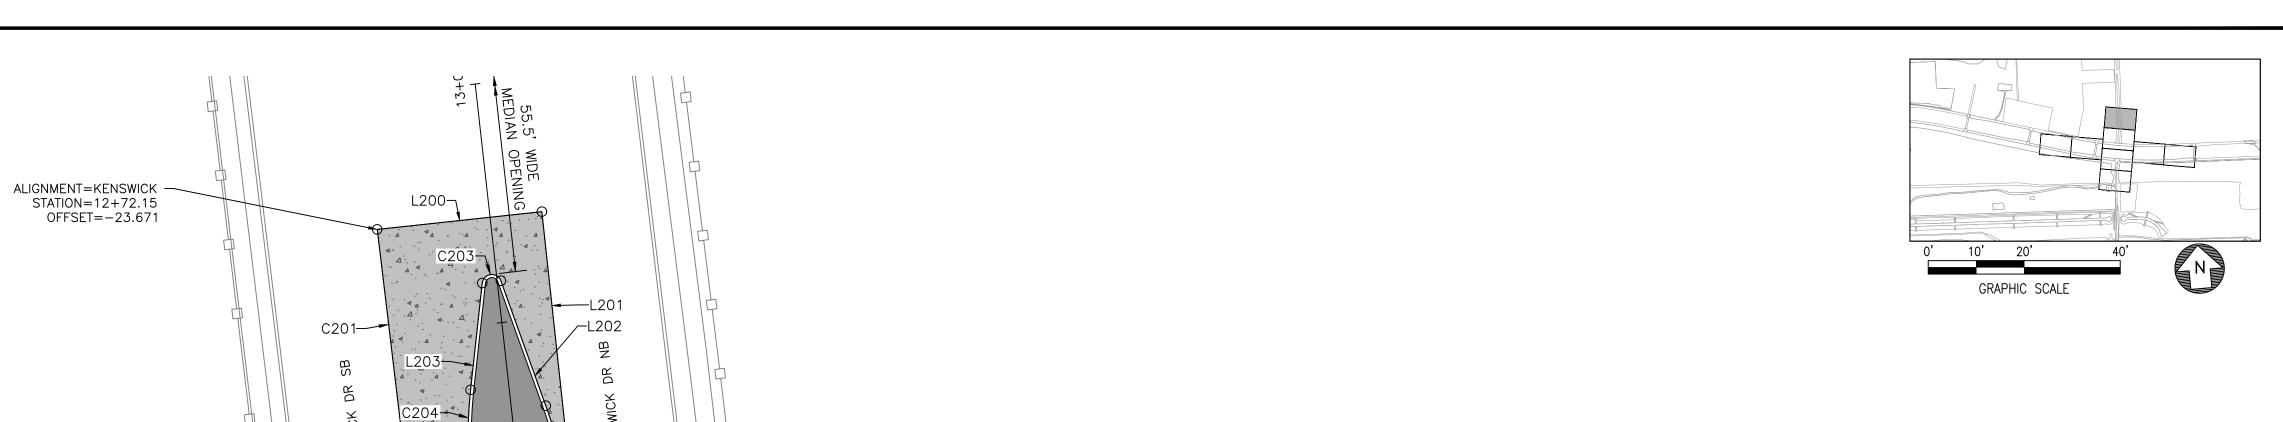
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SEE MATCHLINE SHEET CP-105

HOUSTON AIRPORT SYSTEM

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LOCAL OFFICE:

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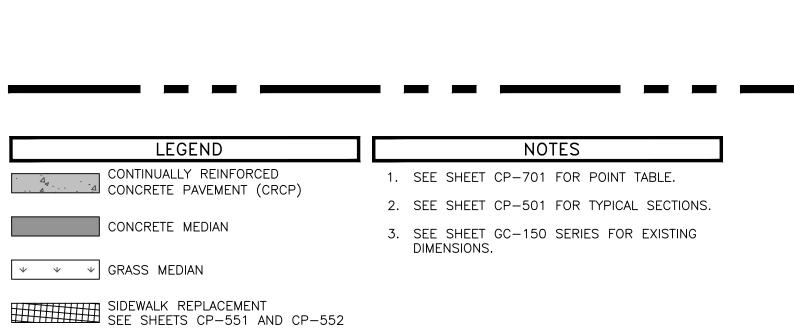
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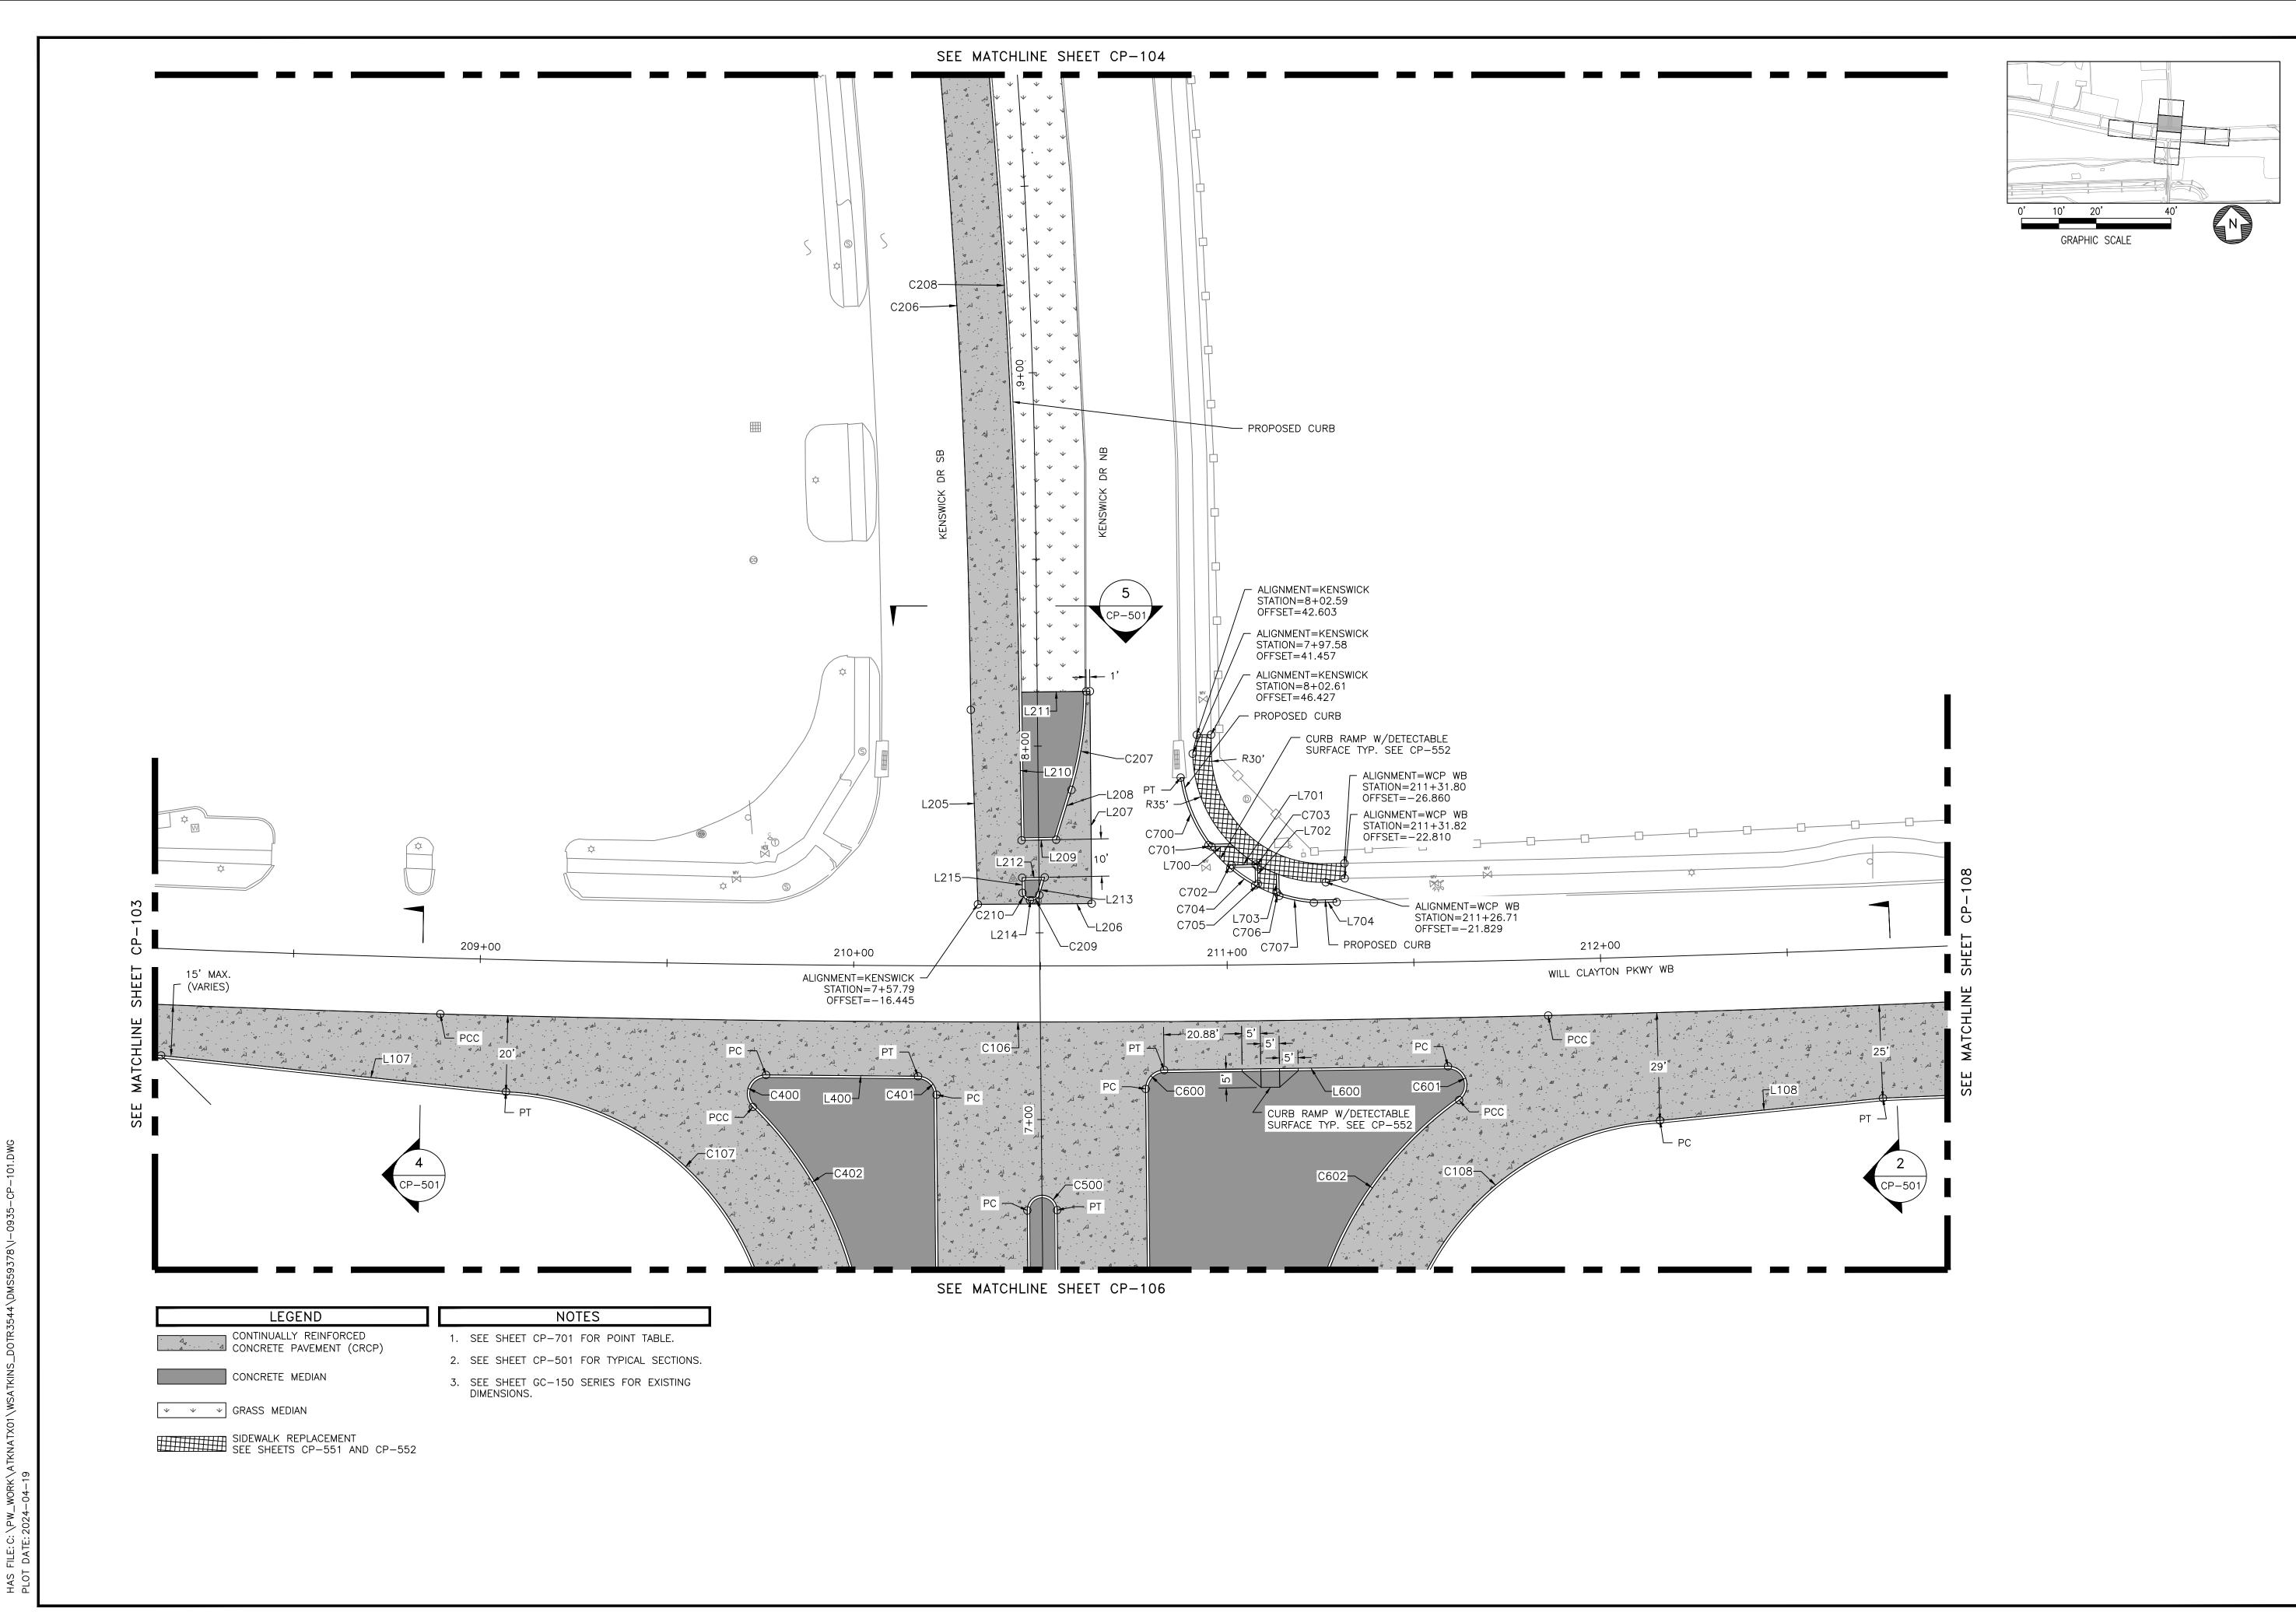
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REVISIONS

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PROJECT MGR: MES

DESIGNER: ALR

DRAWN BY: ALR

CHECK BY: PMW

SCALE:

DATE: 05/08/2024



APPROVED BY:

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PROJECT NO.

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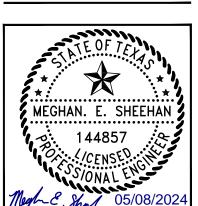
LOCAL OFFICE:
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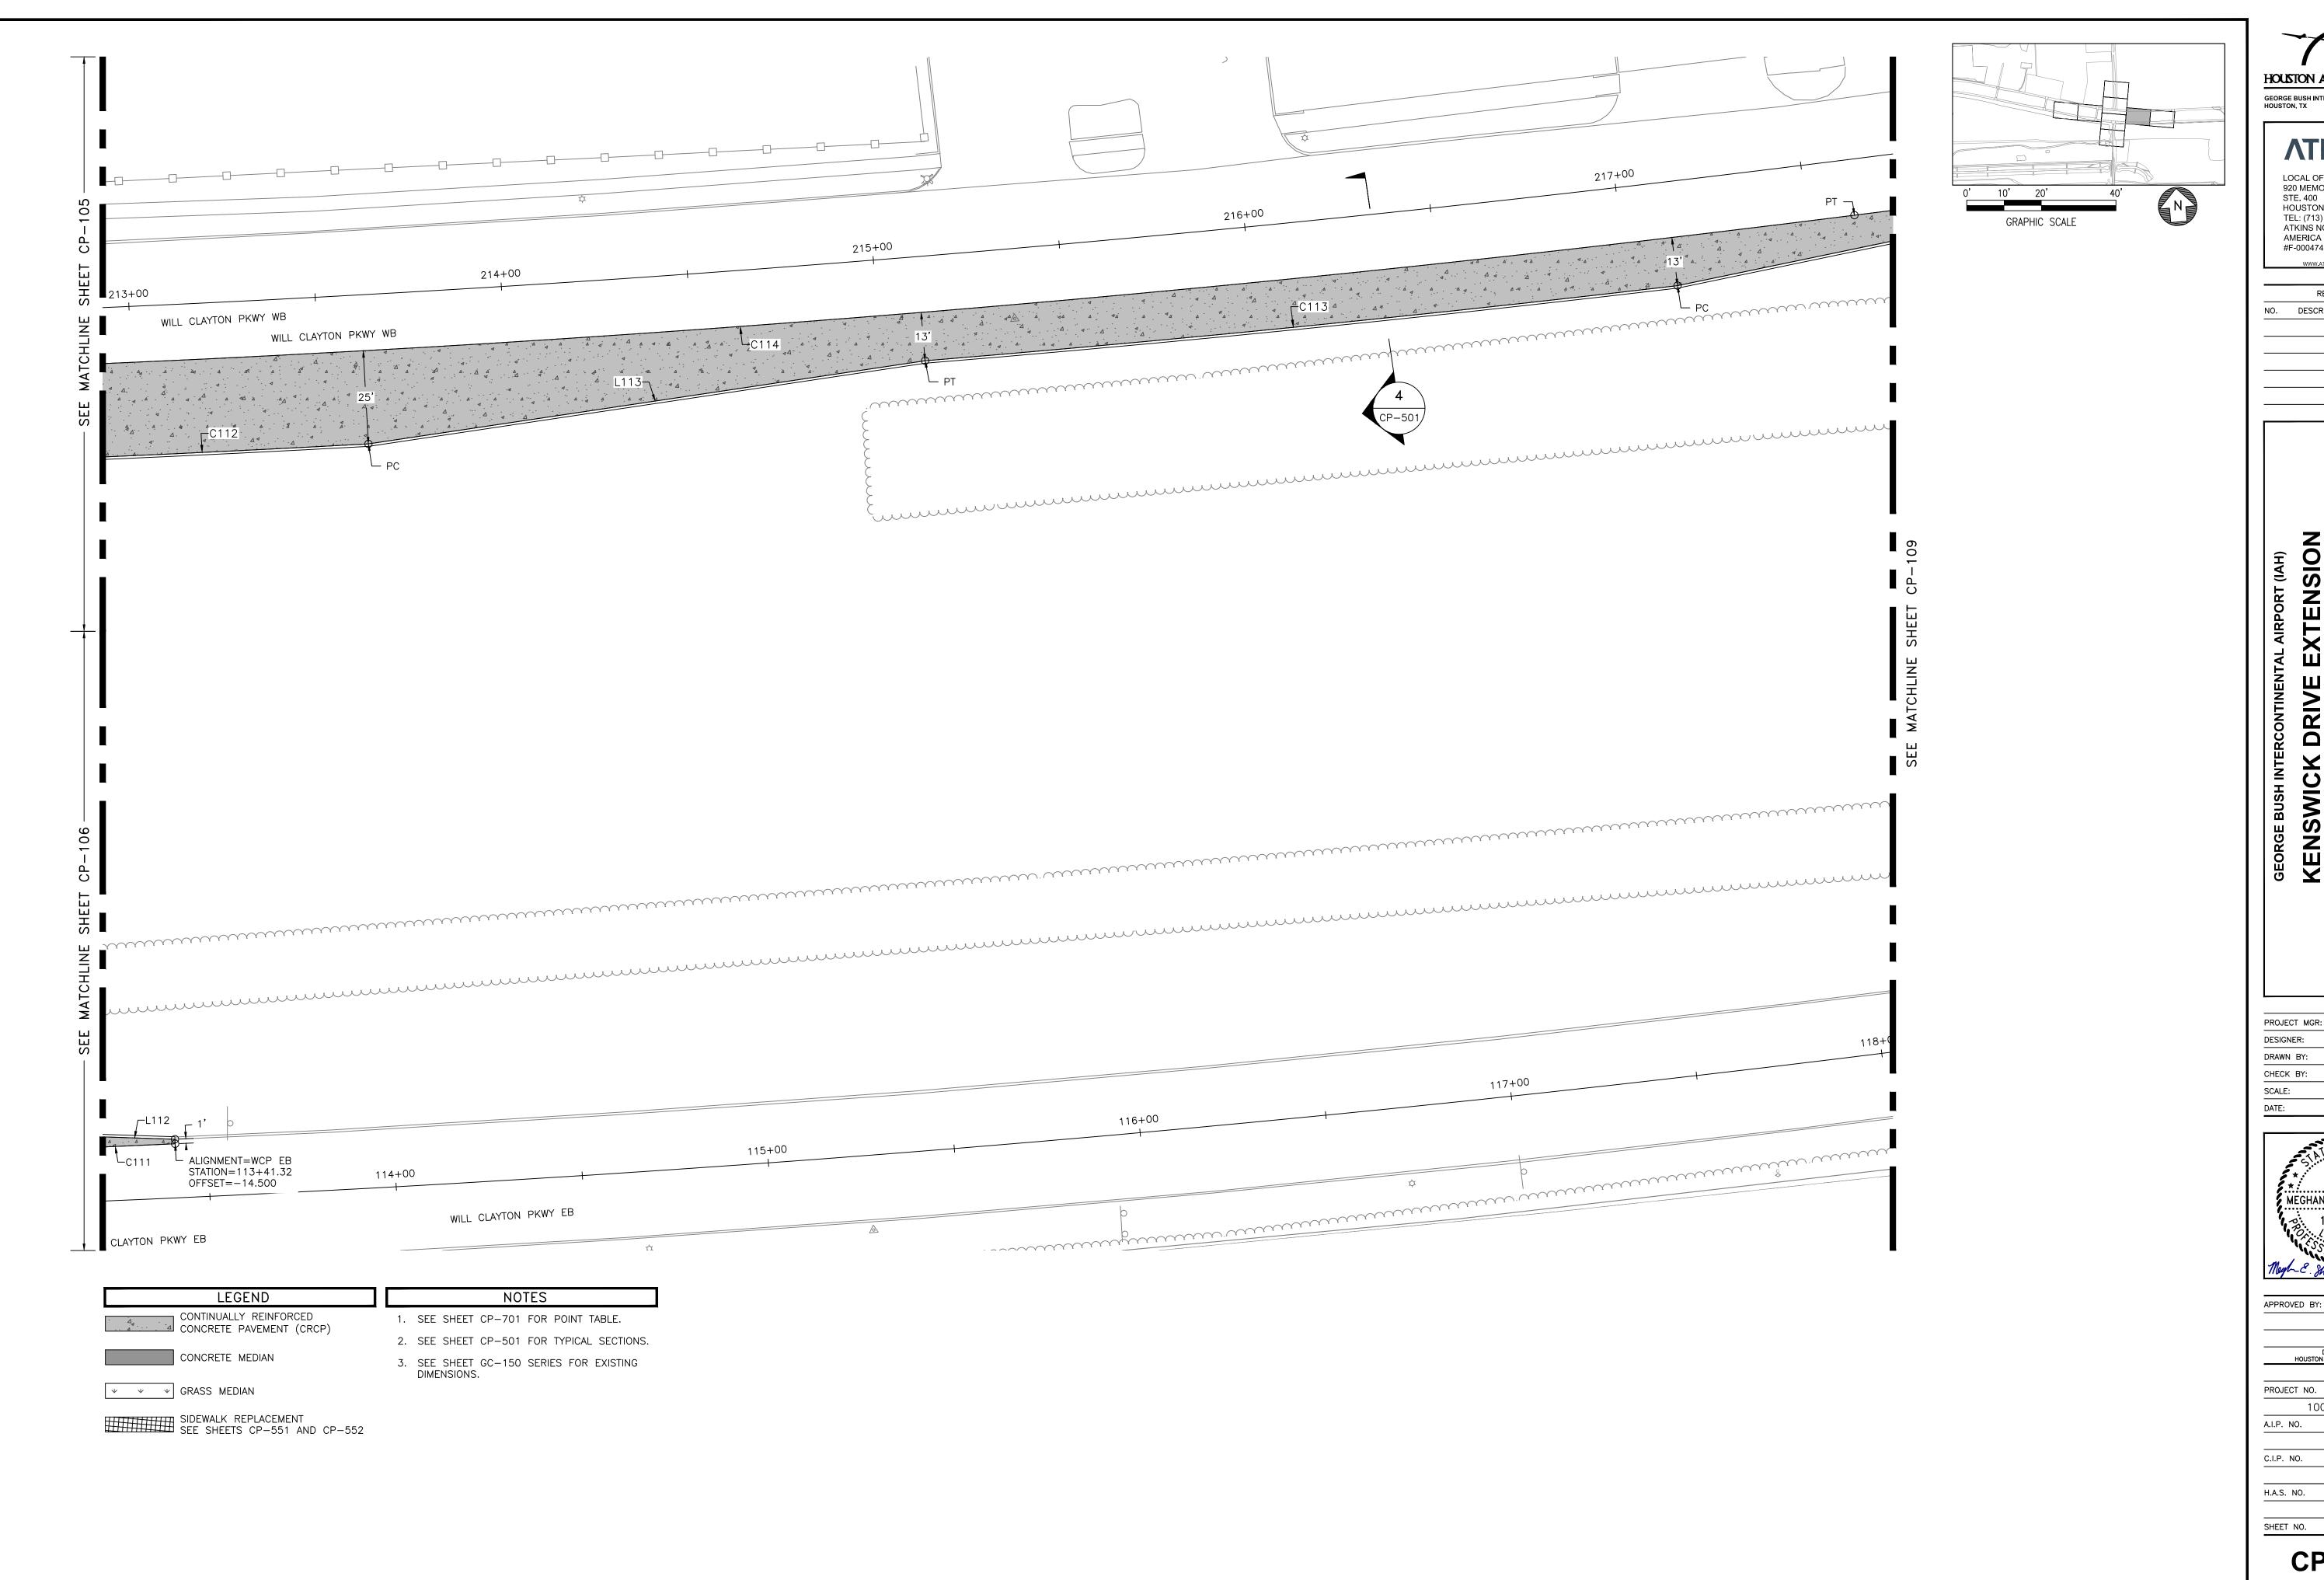
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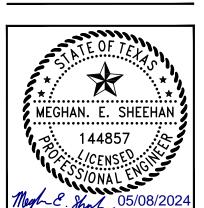


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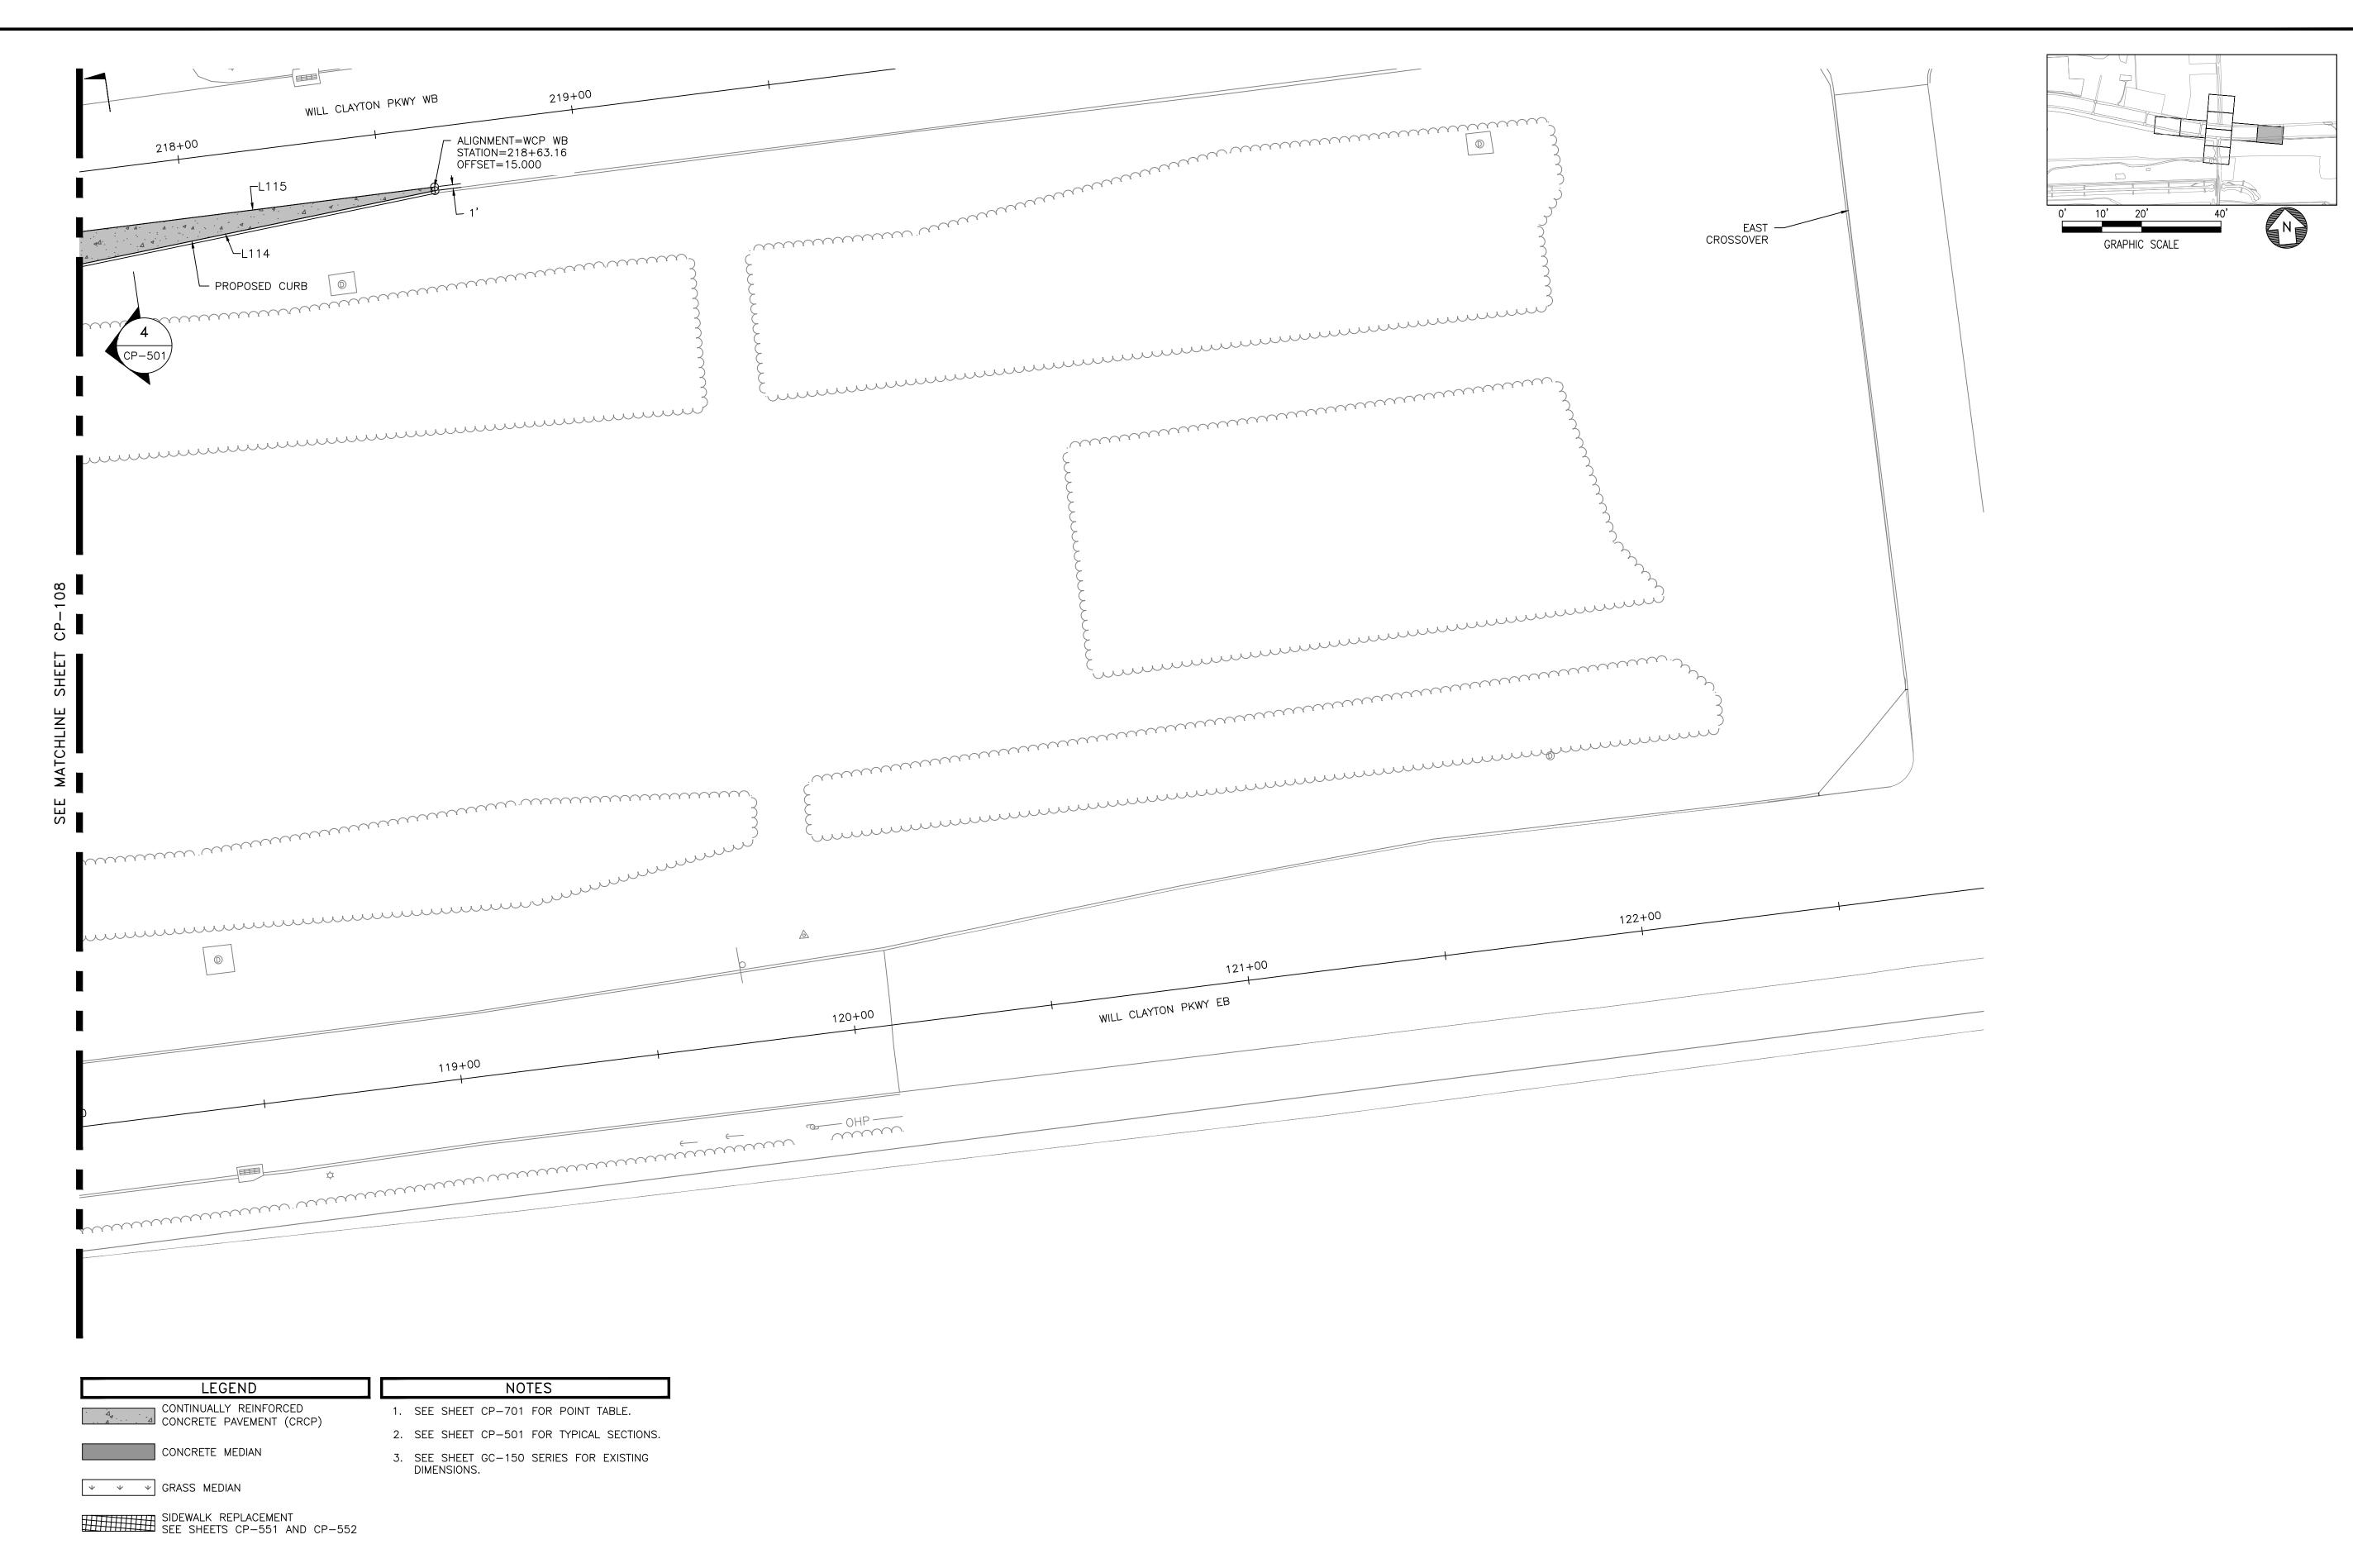


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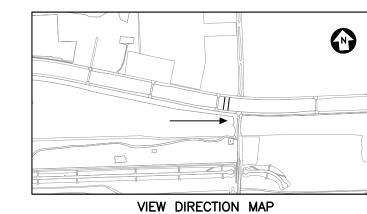
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WILL CLAYTON RD EB TO WB U-TURN ROADWAY PROFILE (STA.:500+00 TO 504+50)



### NOTE

1. SEE SHEET CP-501 FOR TYPICAL SECTIONS.

REFER TO CD-100 SERIES AND CD-200 SERIES FOR FULL UTILITY INFORMATION.


HOUSTON AIRPORT SYSTEM GEORGE BUSH INTERCONTINENTAL AIRPORT /

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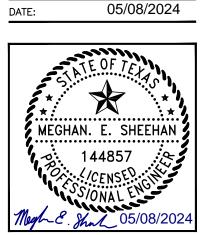
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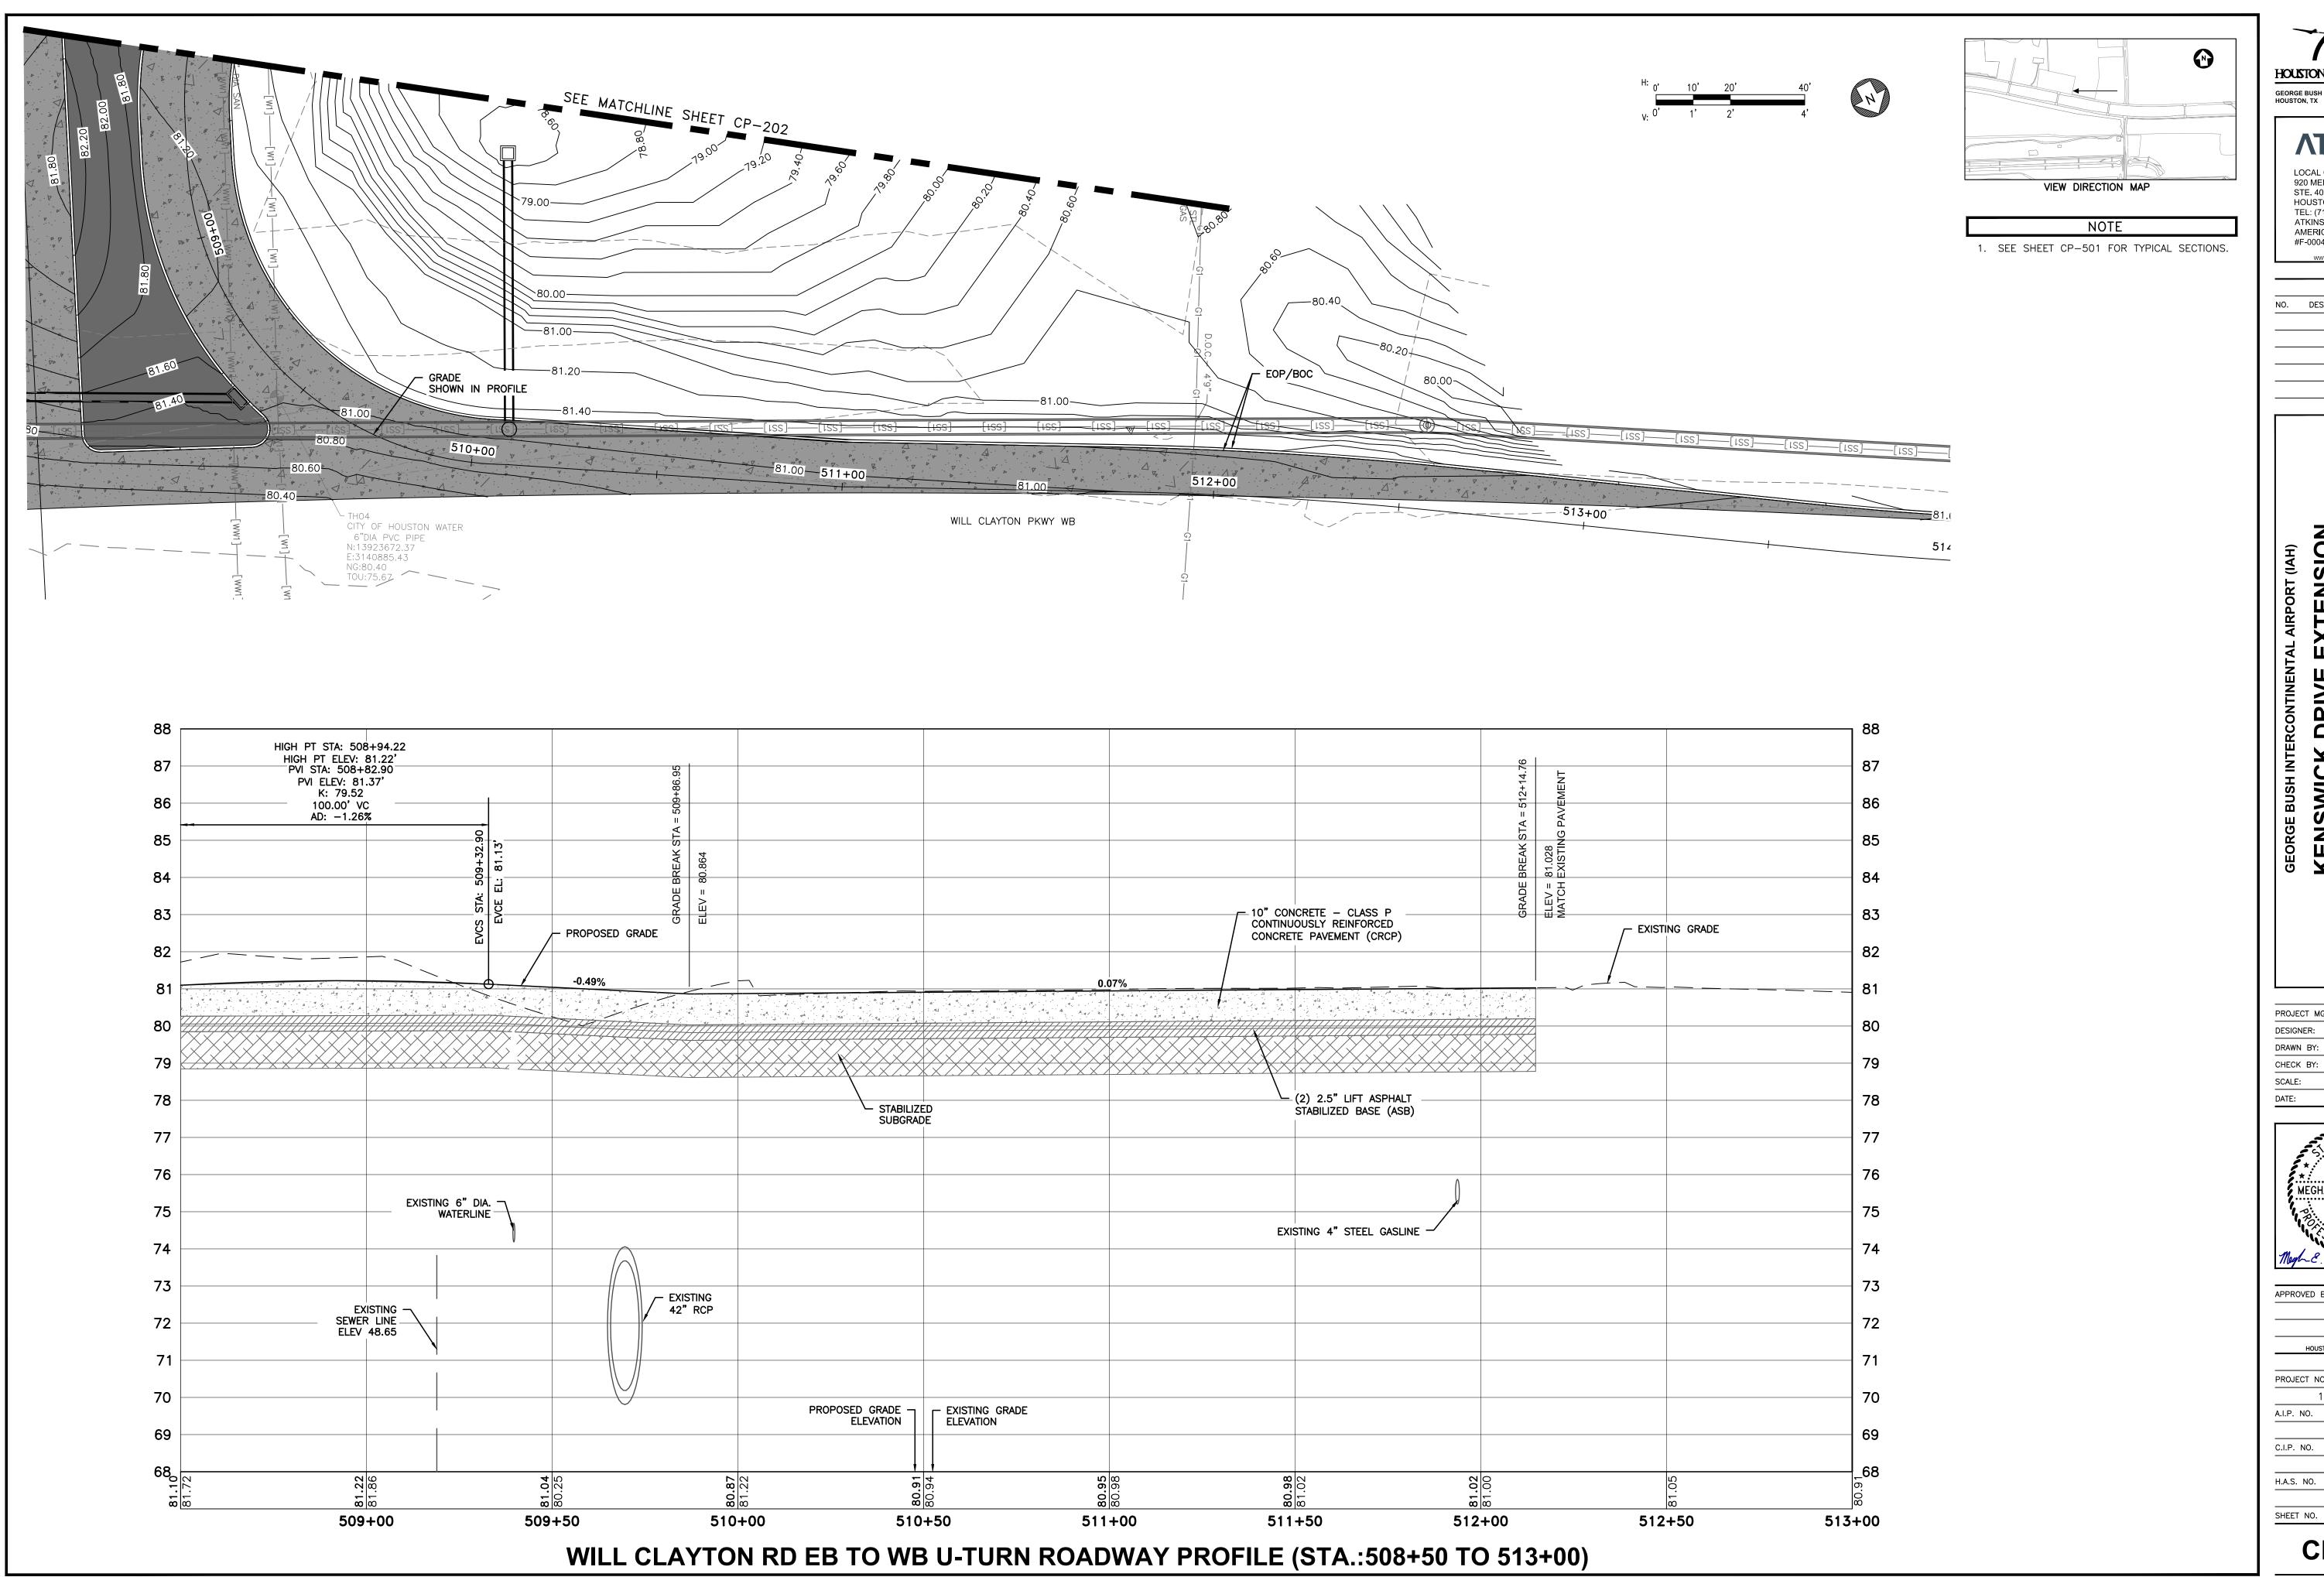
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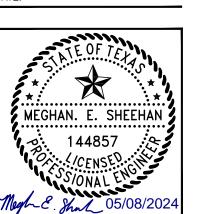
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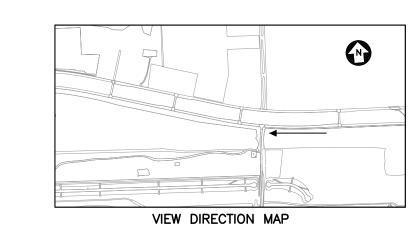
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PROJECT NO. 100072032

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WILL CLAYTON RD WB TO EB U-TURN ROADWAY PROFILE (STA.:600+00 TO 603+00)



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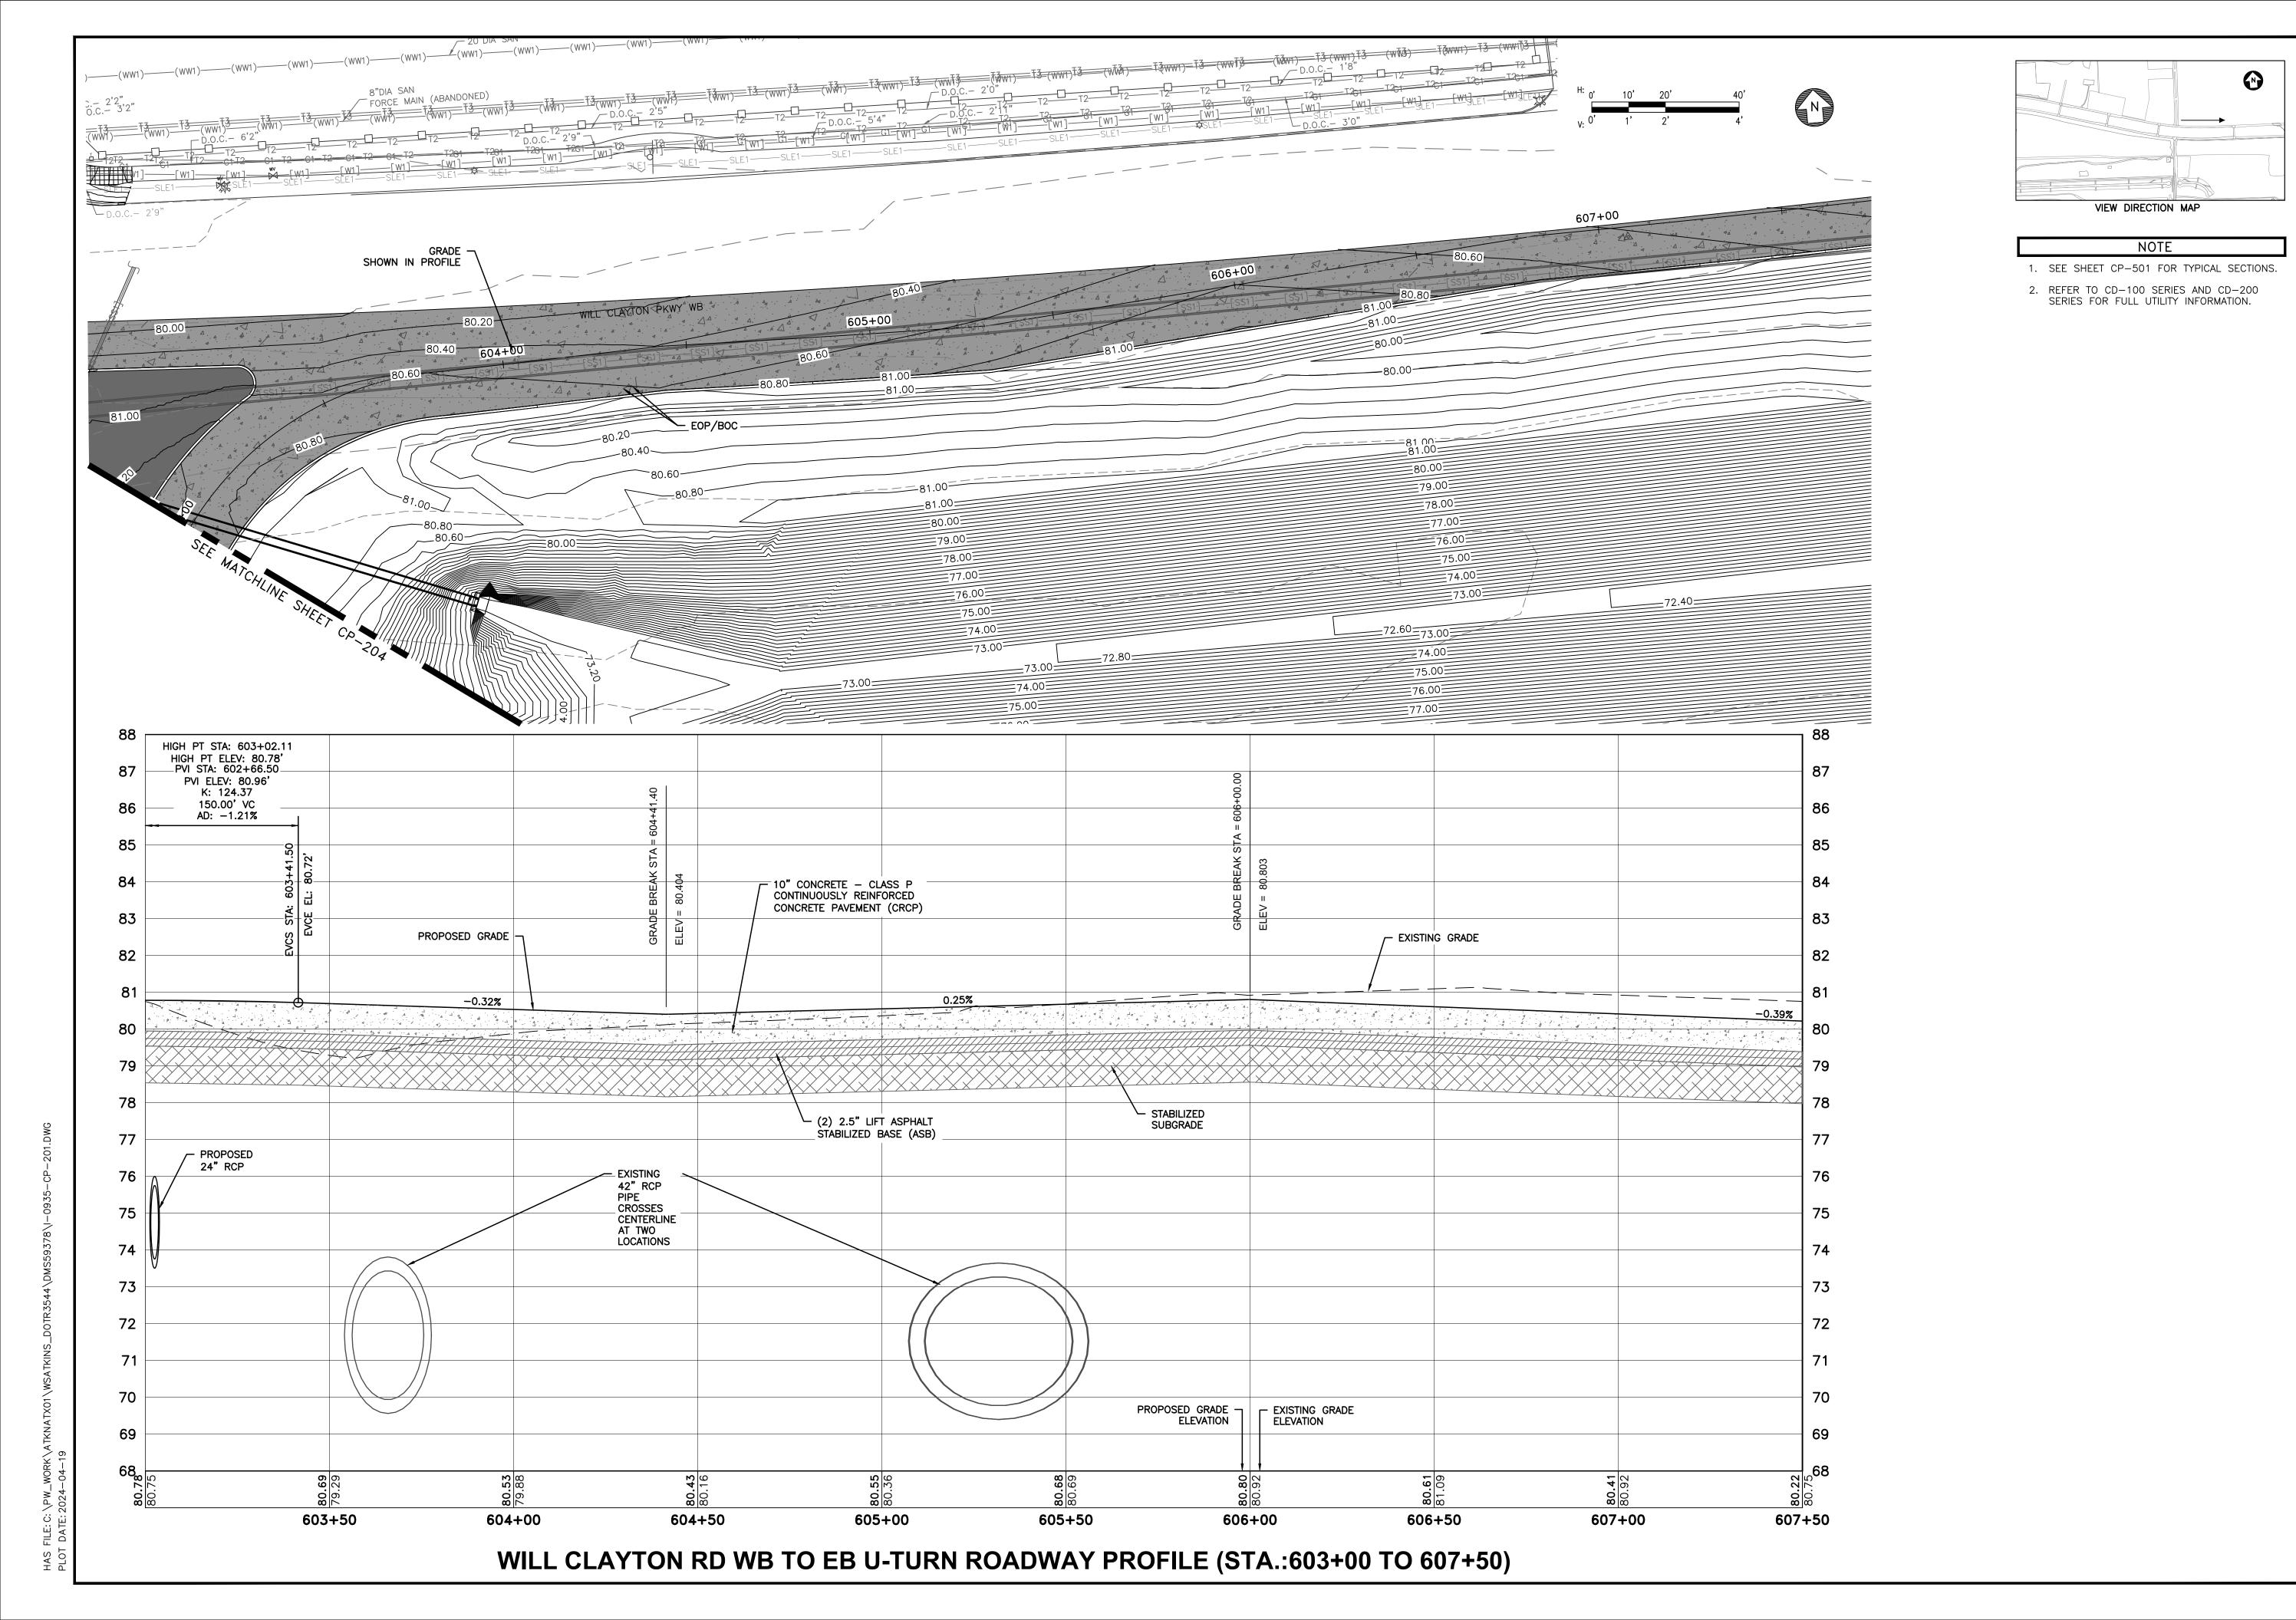
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NOTE

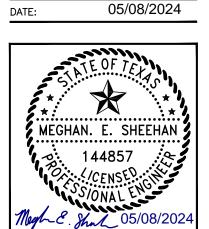1. SEE SHEET CP-501 FOR TYPICAL SECTIONS.

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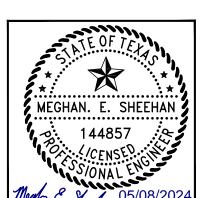
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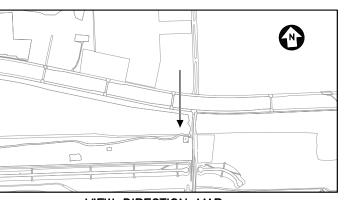
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PROJECT NO. 100072032

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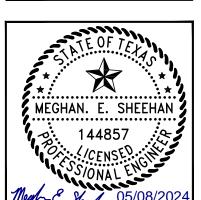
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DIRECTOR HOUSTON AIRPORT SYSTEM

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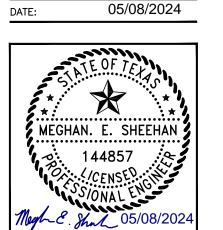
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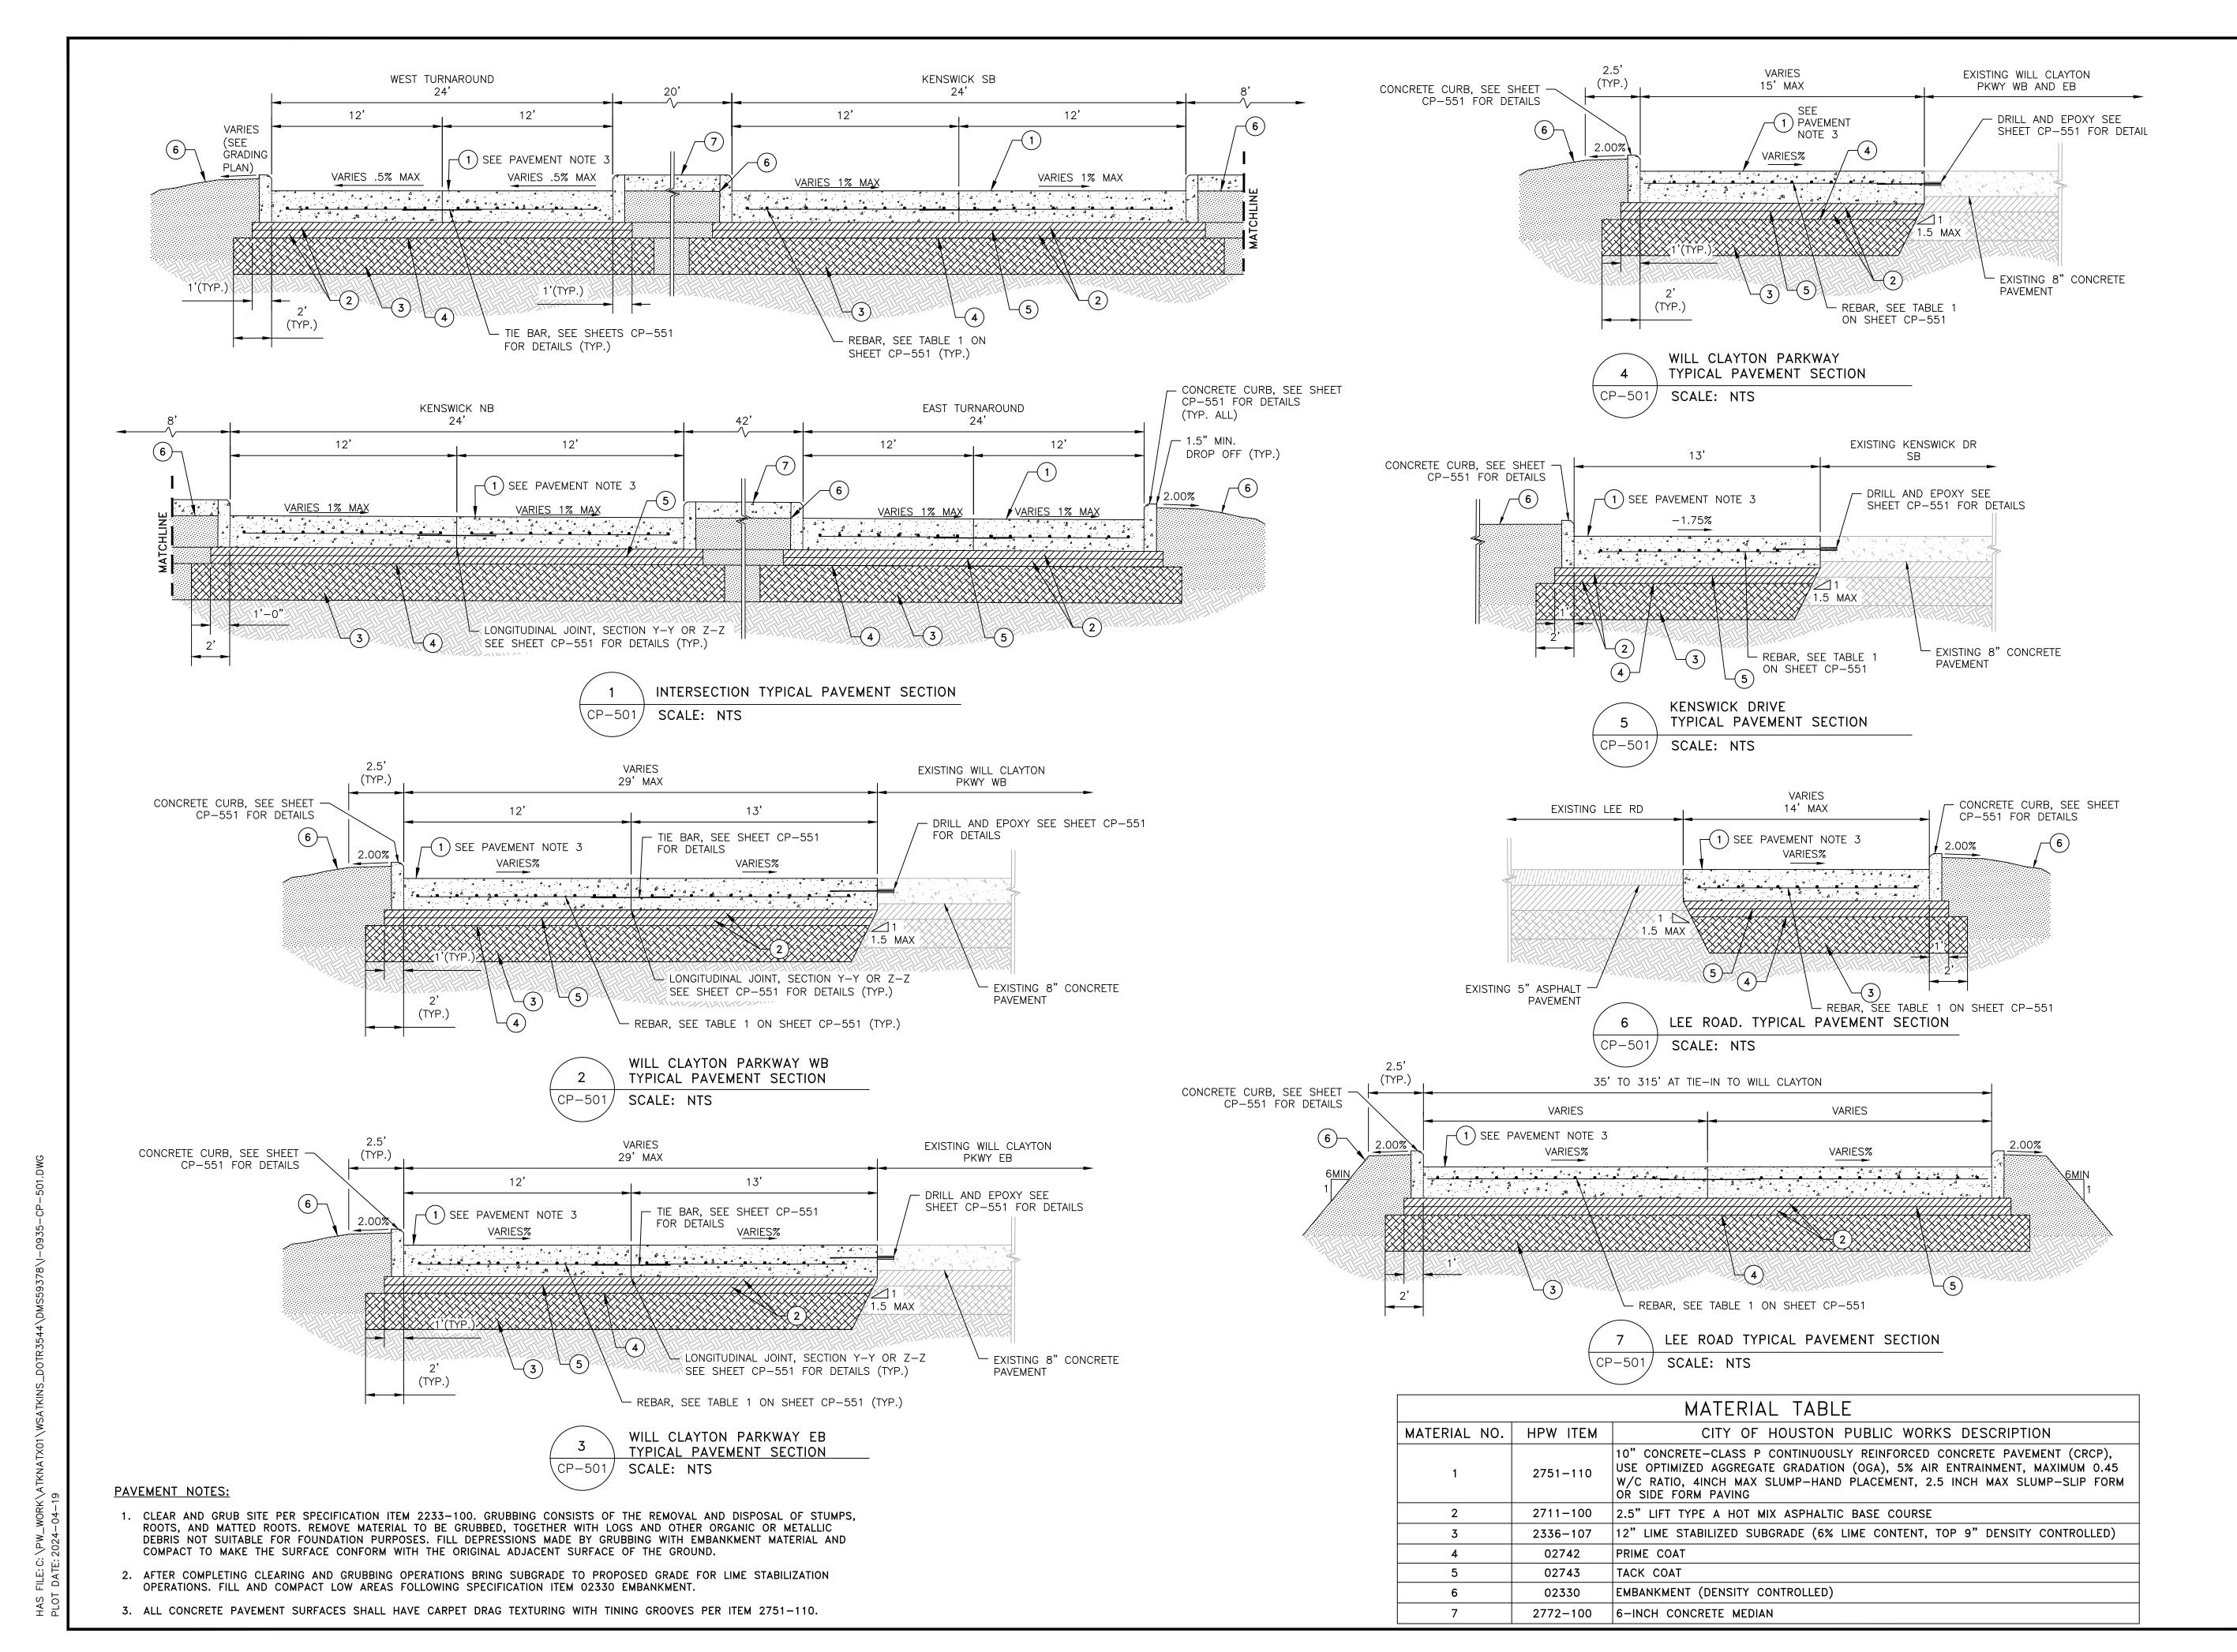
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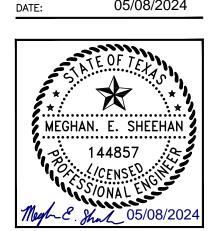
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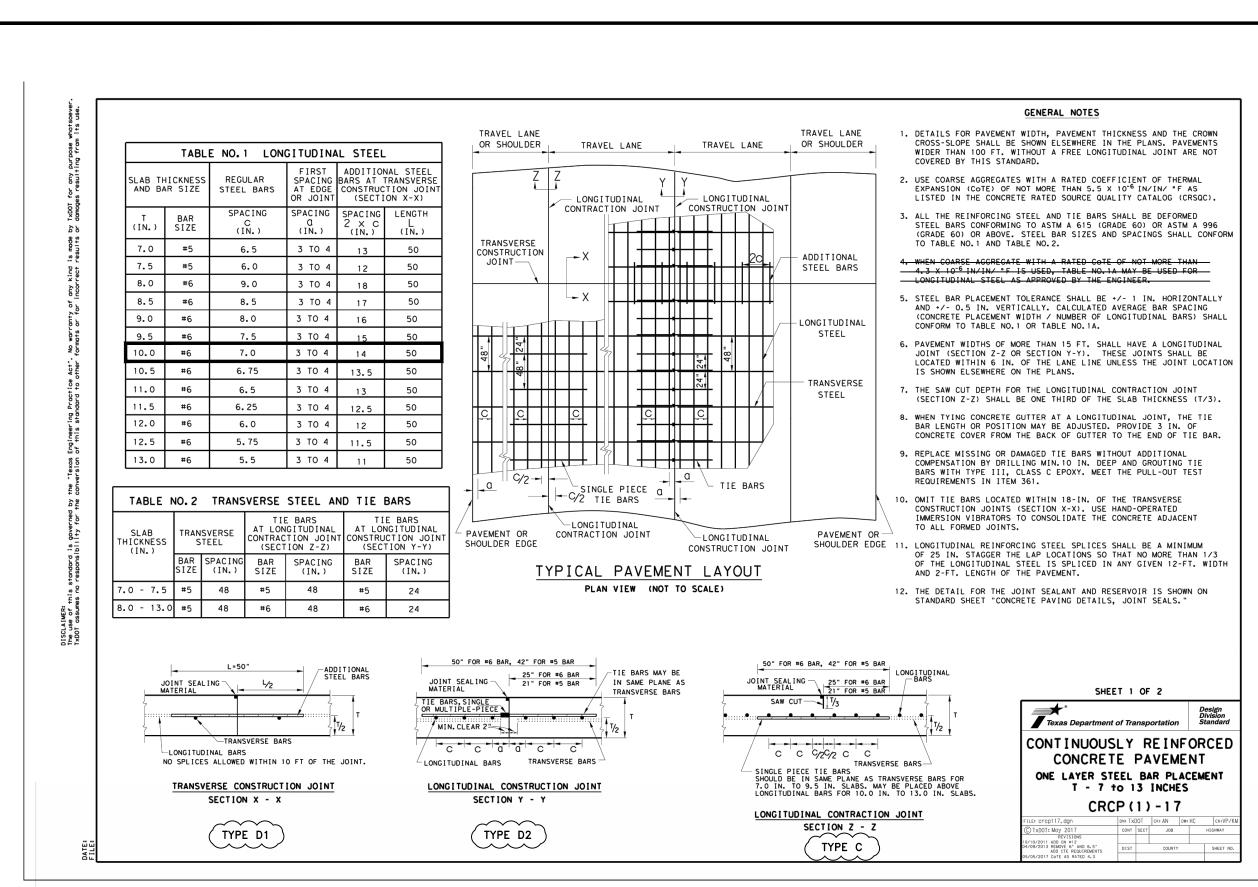
DIRECTOR HOUSTON AIRPORT SYSTEM


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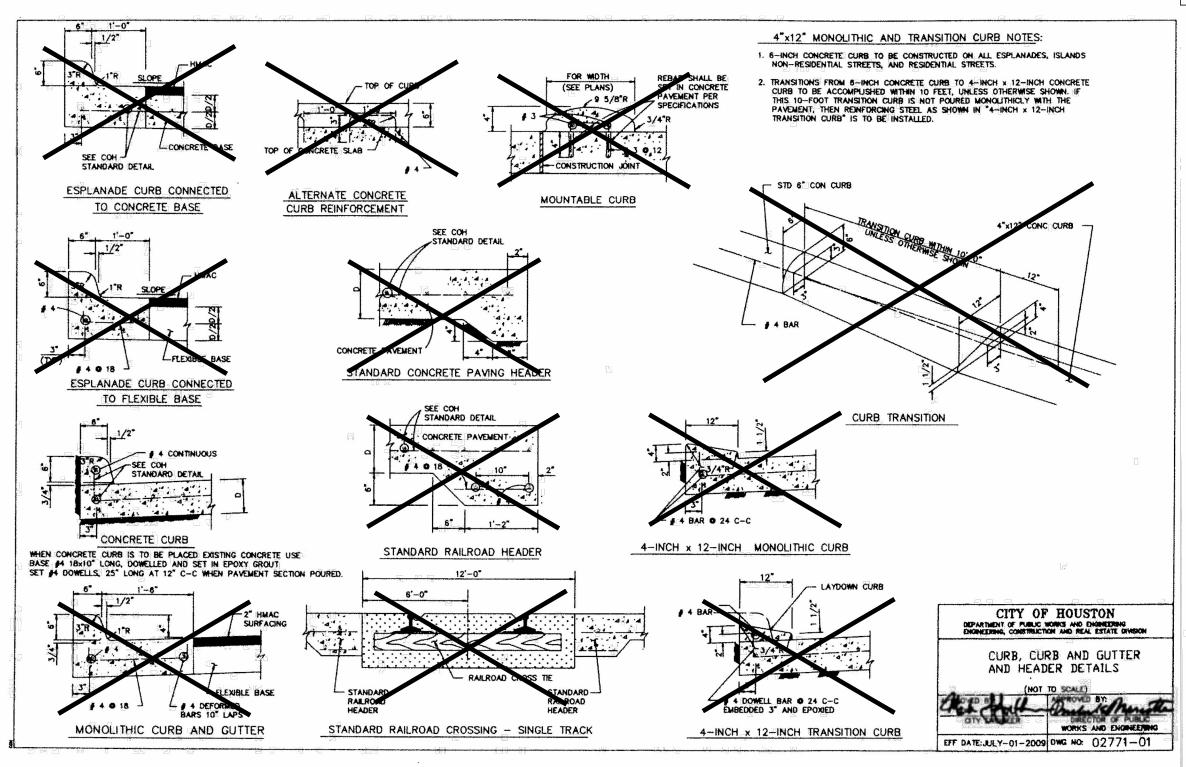
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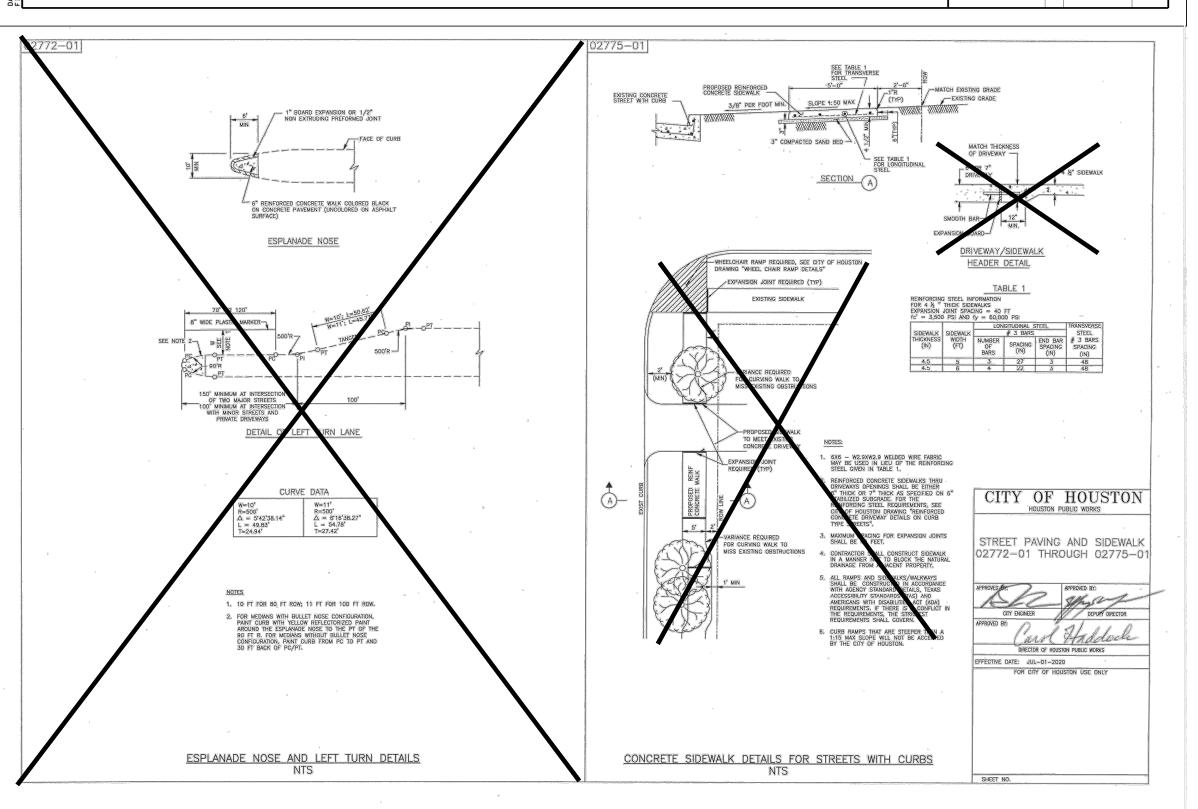
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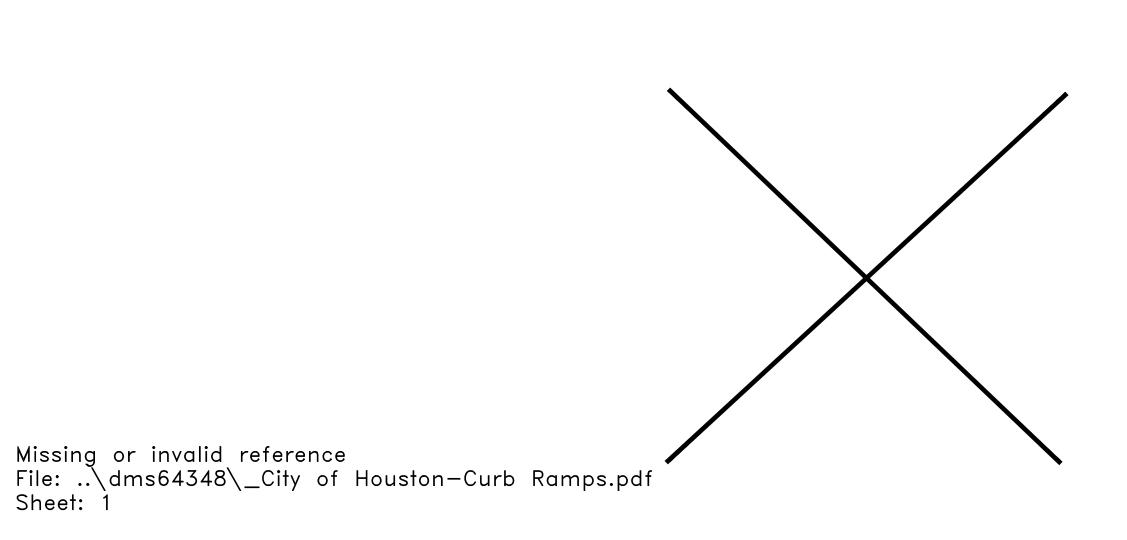
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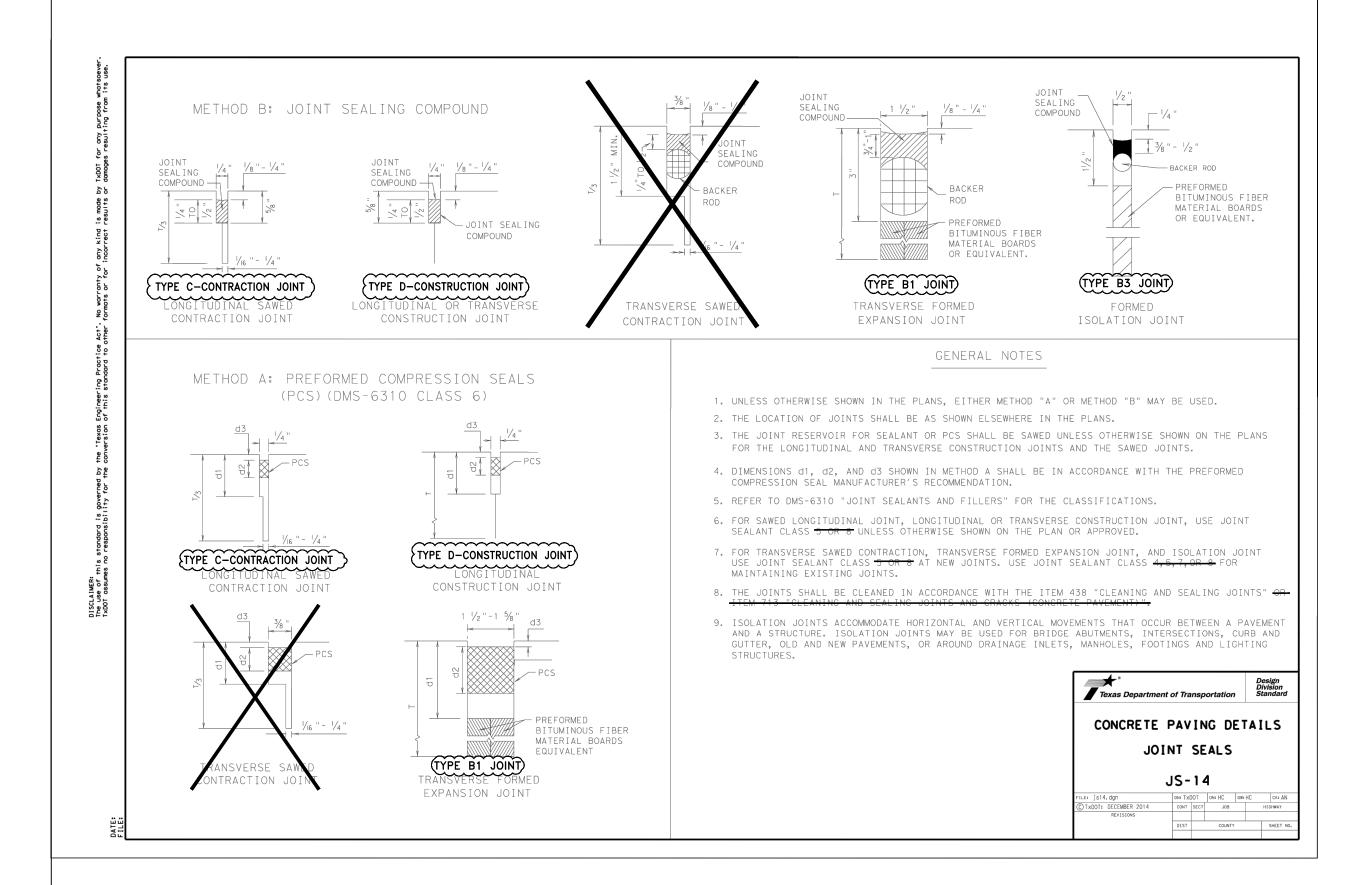
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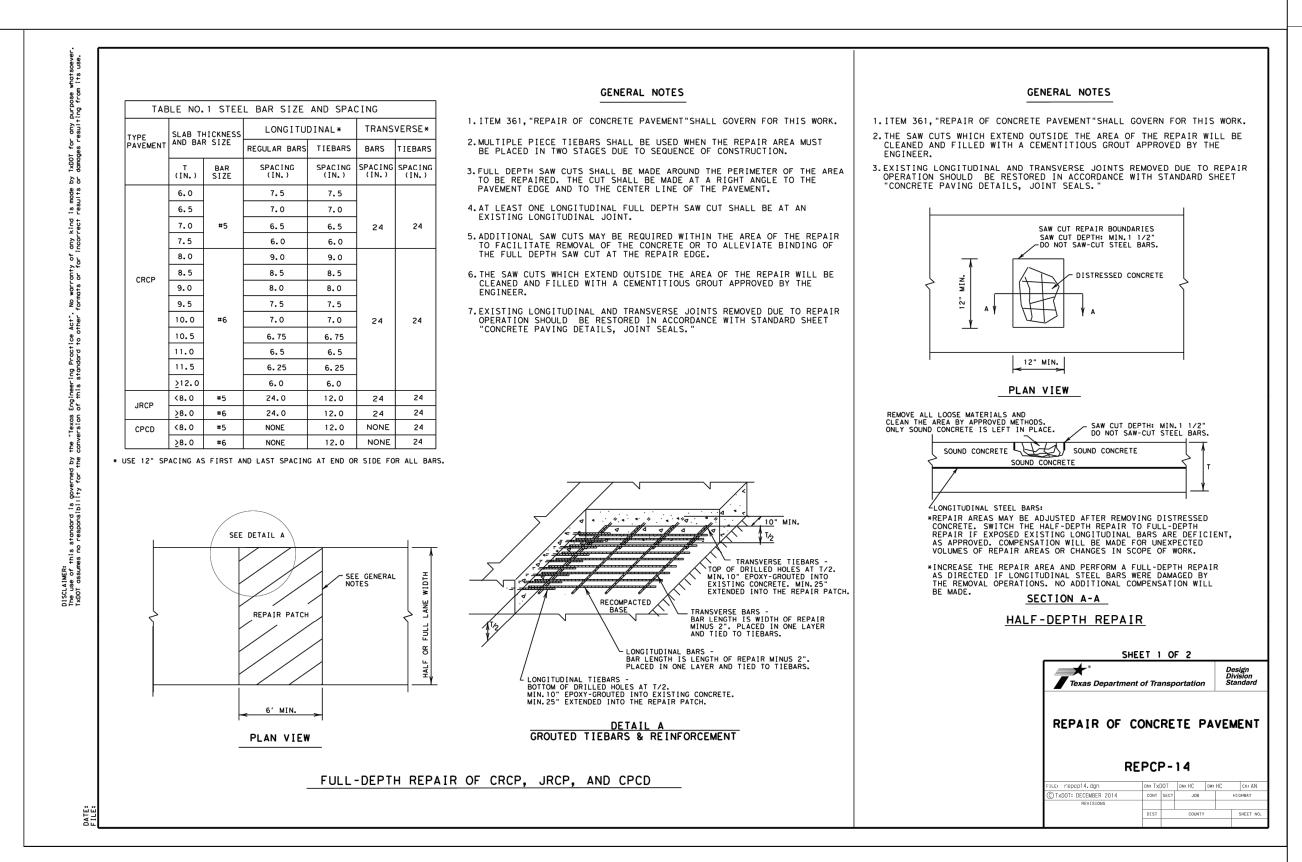
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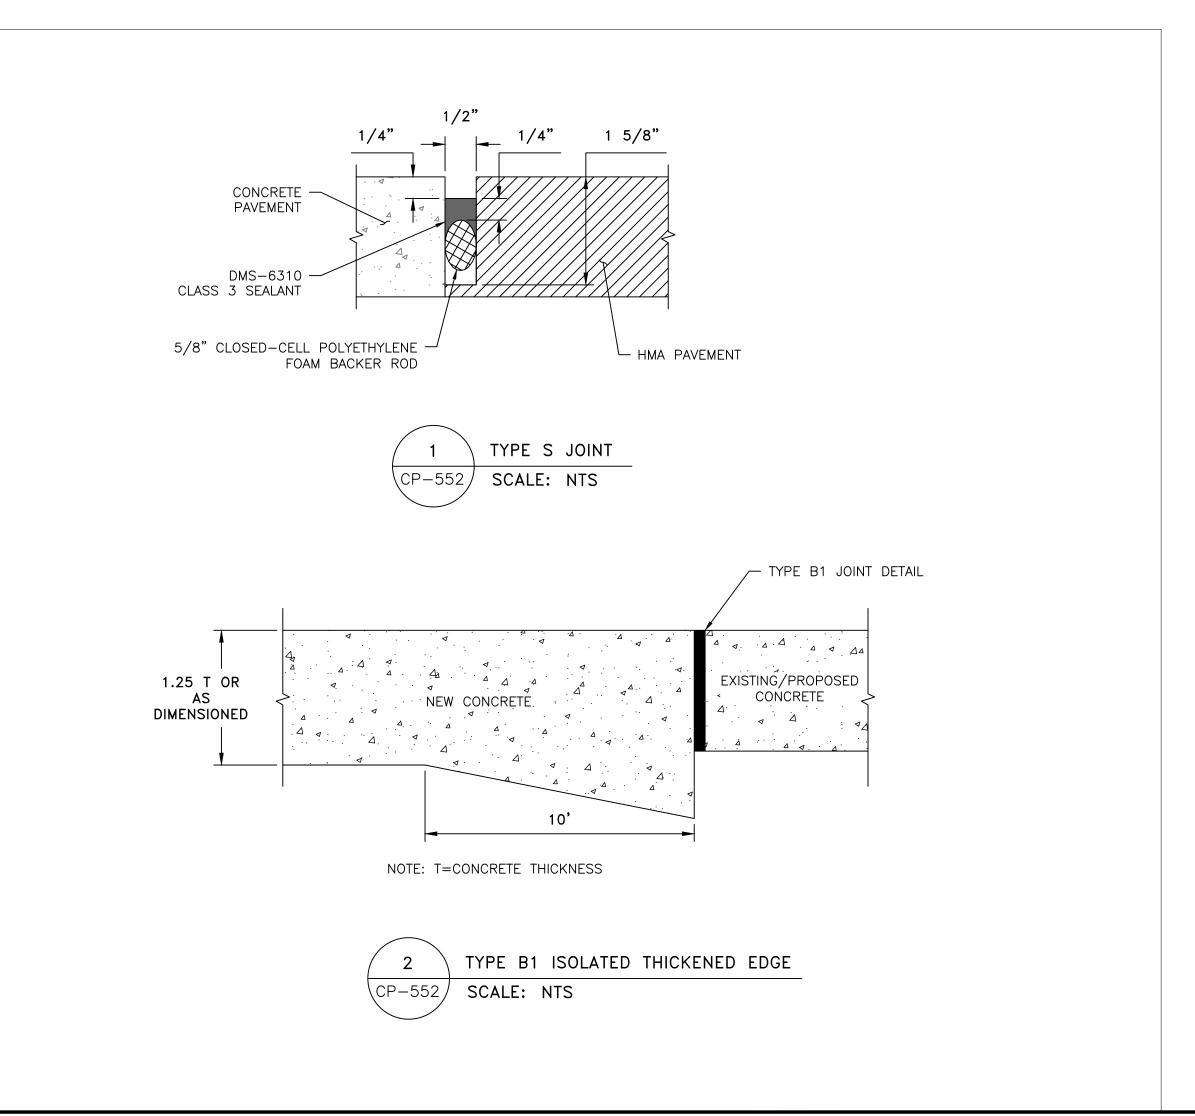
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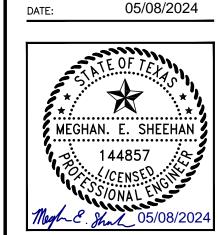
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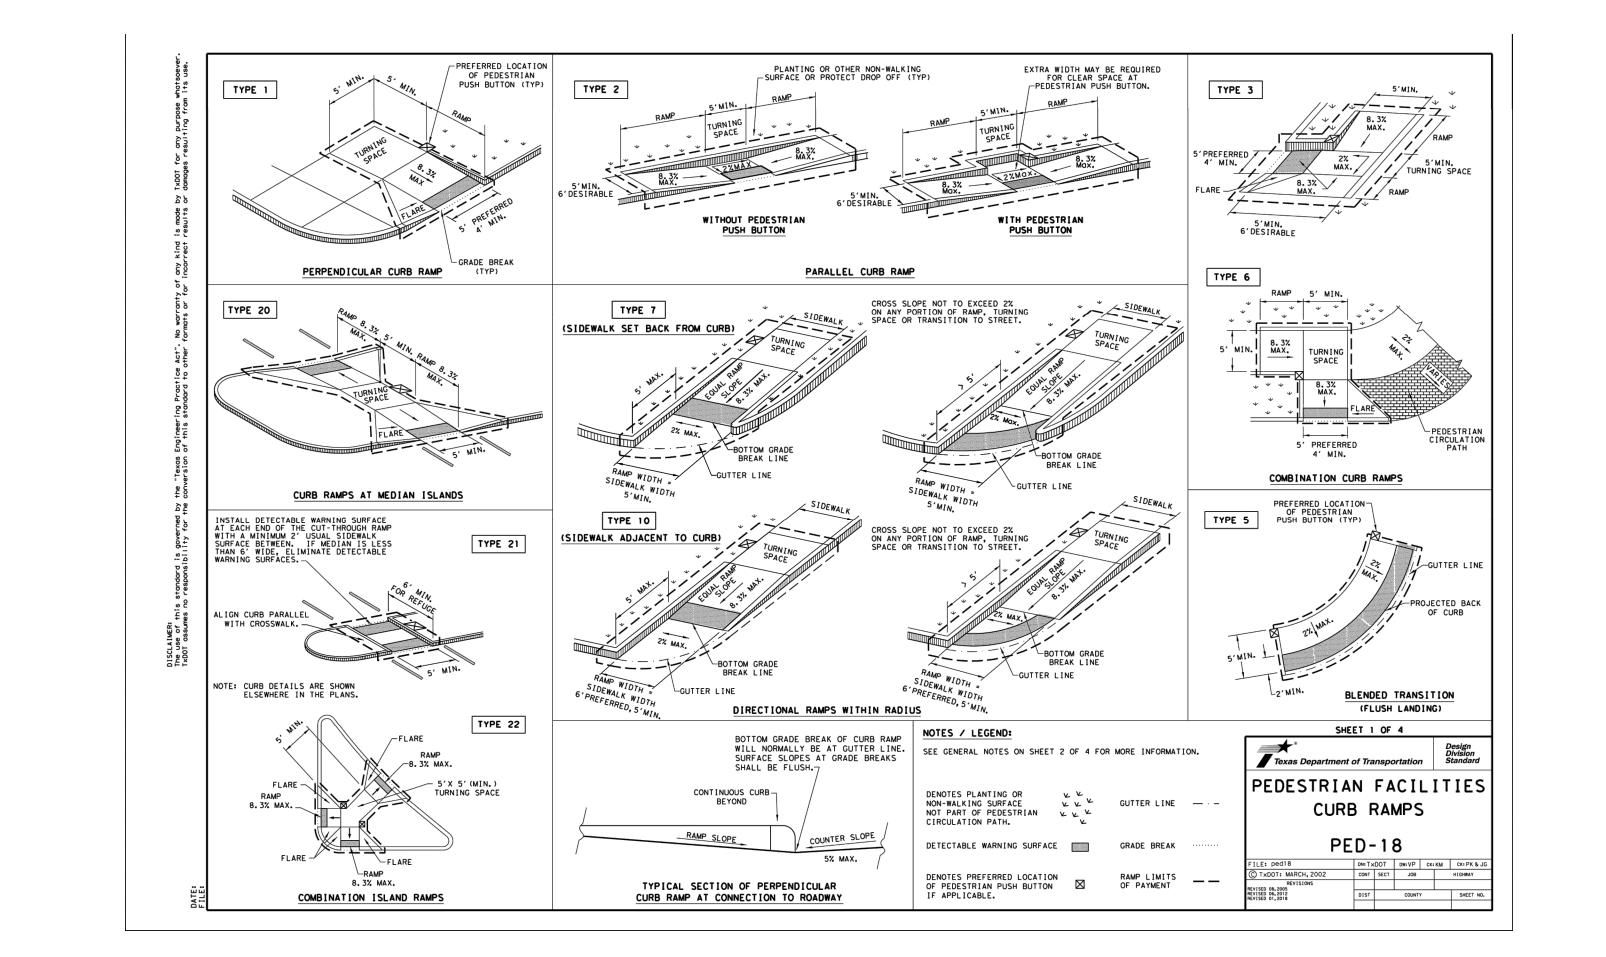
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CENTER MEDIAN LINE TABLE									
LINE NUMBER	LENGTH (FEET)	DIRECTION	SEGMENT START NORTHING	SEGMENT START EASTING	SEGMENT END NORTHING	SEGMENT END EASTING			
L500	112.8	NO4°E	13923530.4	3140951.6	13923642.8	3140960.4			
L501	112.8	S04°W	13923642.2	3140968.3	13923529.7	3140959.5			

	EAST MEDIAN LINE TABLE									
LINE NUMBER	LENGTH (FEET)	DIRECTION	SEGMENT START NORTHING	SEGMENT START EASTING	SEGMENT END NORTHING	SEGMENT END EASTING				
L600	76.0	S86°E	13923677.0	3141000.2	13923671.4	3141076.0				
L601	185.4	NO4°E	13923487.6	3140980.3	13923672.5	3140994.8				
L602	23.4	S04°W	13923584.8	3141030.0	13923561.5	3141028.2				

			WILL CLAYT	ON PKWY CUF	RVE TABLE		
CURVE NUMBER	LENGTH (FEET)	RADIUS (FEET)	DELTA (DEGREES)	SEGMENT START NORTHING	SEGMENT START EASTING	SEGMENT END NORTHING	SEGMENT END EASTING
C100	573.9	5886	006	13923496.8	3140816.0	13923586.9	3140249.5
C101	261.6	5870	003	13923602.1	3140252.7	13923554.1	3140509.8
C102	85.9	5860	001	13923541.8	3140658.9	13923530.8	3140744.C
C103	50.8	1039	003	13923753.9	3140478.7	13923764.3	3140429.0
C104	88.7	1072	005	13923714.6	3140663.4	13923731.2	3140576.3
C105	414.7	5715	004	13923771.2	3140398.4	13923708.9	3140808.4
C106	296.7	5715	003	13923708.9	3140808.4	13923682.6	3141103.9
C107	114.1	75	087	13923606.4	3140889.3	13923686.6	3140824.1
C108	114.5	75	087	13923652.0	3141131.2	13923582.9	3141054.0
C109	121.6	75	093	13923527.1	3140804.1	13923595.6	3140888.5
C110	119.1	75	091	13923559.6	3141052.1	13923478.9	3141122.4
C111	397.0	5886	004	13923466.9	3141211.8	13923496.8	3140816.0
C112	88.7	5740	001	13923649.3	3141279.8	13923652.8	3141191.2
C113	202.8	5728	002	13923660.9	3141633.2	13923658.5	3141430.4
C114	578.5	5715	006	13923682.6	3141103.9	13923675.6	3141682.1

			WEST M	EDIAN CURVE	TABLE		
CURVE NUMBER	LENGTH (FEET)	RADIUS (FEET)	DELTA (DEGREES)	SEGMENT START NORTHING	SEGMENT START EASTING	SEGMENT END NORTHING	SEGMEN END EASTING
C400	11.9	5	136	13923685.0	3140893.8	13923676.8	3140889
C401	7.8	5	089	13923675.8	3140938.9	13923681.2	3140934
C402	78.1	99	045	13923676.8	3140889.6	13923604.5	3140913
C403	98.8	99	057	13923593.7	3140912.4	13923514.3	3140860
C404	12.8	5	146	13923514.3	3140860.7	13923504.9	3140862
C405	7.9	5	091	13923499.5	3140920.0	13923504.1	3140925

						1
		KE	ENSWICK DR L	INE TABLE		
LINE NUMBER	LENGTH (FEET)	DIRECTION	SEGMENT START NORTHING	SEGMENT START EASTING	SEGMENT END NORTHING	SEGMENT END EASTING
L200	34.5	N89°E	13924237.6	3140955.3	13924238.3	3140989.7
L201	60.4	S01°E	13924238.3	3140989.7	13924177.9	3140991.0
L202	27.7	N15°W	13924198.0	3140987.0	13924224.7	3140980.0
L203	22.4	S11°W	13924224.6	3140976.1	13924202.6	3140971.7
L204	19.1	S88°W	13924177.9	3140990.0	13924177.3	3140970.9
L205	52.1	NO3°E	13923725.6	3140954.4	13923777.7	3140957.0
L206	30.5	N85°W	13923723.1	3140984.7	13923725.6	3140954.3
L207	56.9	S05°W	13923779.8	3140989.2	13923723.1	3140984.7
L208	14.0	N22°E	13923741.0	3140976.7	13923753.9	3140982.0
L209	9.3	S86°E	13923741.7	3140967.5	13923741.0	3140976.7
L210	35.1	S04°W	13923776.7	3140969.9	13923741.7	3140967.5
L211	17.3	N86°W	13923779.9	3140988.2	13923781.2	3140971.0
L212	6.0	N86°W	13923731.3	3140972.8	13923731.7	3140966.8
L213	4.9	N22°E	13923726.7	3140970.9	13923731.3	3140972.8
L214	0.6	S85°E	13923725.5	3140968.3	13923725.4	3140968.9
L215	4.1	S04°W	13923731.7	3140966.8	13923727.6	3140966.5

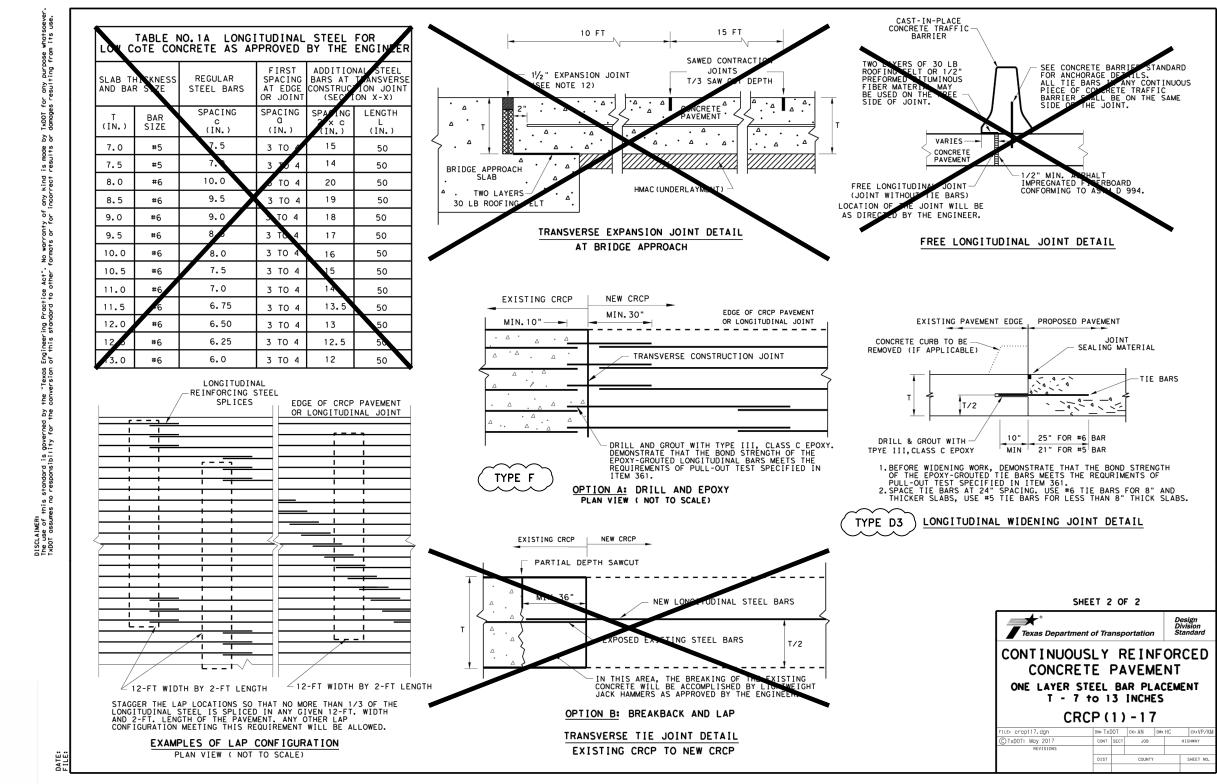	CURB REPAIR LINE TABLE								
LINE NUMBER	LENGTH (FEET)	DIRECTION	SEGMENT START NORTHING	SEGMENT START EASTING	SEGMENT END NORTHING	SEGMENT END EASTING			
L700	5.8	N86°W	13923735.1	3141023.8	13923735.5	3141018.0			
L701	6.5	S86°E	13923730.2	3141022.9	13923729.7	3141029.4			
L702	4.6	S04°W	13923729.2	3141029.8	13923724.6	3141029.5			
L703	5.0	NO4°E	13923721.8	3141034.3	13923726.8	3141034.7			
L704	6.1	N87°W	13923717.8	3141050.1	13923718.2	3141044.0			

	KENSWICK DR CURVE TABLE										
CURVE NUMBER	LENGTH (FEET)	RADIUS (FEET)	DELTA (DEGREES)	SEGMENT START NORTHING	SEGMENT START EASTING	SEGMENT END NORTHING	SEGMENT END EASTING				
C200	191.7	2162675	000	13923990.2	3140963.4	13924181.8	3140957.1				
C201	55.9	105423	000	13924181.8	3140957.1	13924237.6	3140955.3				
C202	20.3	90	013	13924177.9	3140990.0	13924198.0	3140987.0				
C203	5.4	2	154	13924224.7	3140980.0	13924224.6	3140976.1				
C204	20.8	90	013	13924202.6	3140971.7	13924181.9	3140970.1				
C205	191.6	2162663	000	13924181.9	3140970.1	13923990.5	3140976.4				
C206	212.7	2324	005	13923777.7	3140957.0	13923990.2	3140963.4				
C207	26.8	90	017	13923753.9	3140982.0	13923779.9	3140988.2				
C208	214.0	2337	005	13923990.5	3140976.4	13923776.7	3140969.9				
C209	2.5	2	073	13923725.4	3140968.9	13923726.7	3140970.9				
C210	3.1	2	089	13923727.6	3140966.5	13923725.5	3140968.3				

CENTER MEDIAN CURVE TABLE									
CURVE NUMBER	LENGTH (FEET)	RADIUS (FEET)	DELTA (DEGREES)	SEGMENT START NORTHING	SEGMENT START EASTING	SEGMENT END NORTHING	SEGMENT END EASTING		
C500	12.6	4	180	13923642.8	3140960.4	13923642.2	3140968.3		
C501	12.6	4	180	13923529.7	3140959.5	13923530.4	3140951.6		
			_	_					

	CURB REPAIR CURVE TABLE										
CURVE NUMBER	LENGTH (FEET)	RADIUS (FEET)	DELTA (DEGREES)	SEGMENT START NORTHING	SEGMENT START EASTING	SEGMENT END NORTHING	SEGMENT END EASTING				
C700	19.8	39	029	13923736.0	3141017.2	13923754.7	3141011.4				
C701	0.9	1	054	13923735.5	3141018.0	13923736.0	3141017.2				
C702	1.2	0	139	13923729.3	3141022.5	13923730.2	3141022.9				
C703	0.8	0	090	13923729.7	3141029.4	13923729.2	3141029.8				
C704	8.1	39	012	13923724.2	3141028.7	13923729.3	3141022.5				
C705	1.0	0	119	13923724.6	3141029.5	13923724.2	3141028.7				
C706	1.2	1	071	13923720.8	3141034.9	13923721.8	3141034.3				
C707	9.5	39	014	13923718.2	3141044.0	13923720.8	3141034.9				

			LEE RD LINE	TABLE		
LINE NUMBER	LENGTH (FEET)	DIRECTION	SEGMENT START NORTHING	SEGMENT START EASTING	SEGMENT END NORTHING	SEGMENT END EASTING
L300	11.7	N07°E	13923468.7	3140780.2	13923480.3	3140781.5
L301	11.5	S04°W	13923452.6	3141095.3	13923441.1	3141094.6
L302	3.2	N86°W	13923441.1	3141094.6	13923441.3	3141091.4
L303	63.7	N90°W	13923441.3	3141091.4	13923441.4	3141027.7
L304	0.5	S04°W	13923440.9	3141027.2	13923440.4	3141027.1
L305	12.0	S86°E	13923440.4	3141027.1	13923439.5	3141039.2
L306	5.0	S04°W	13923439.5	3141039.2	13923434.5	3141038.8
L307	21.1	N86°W	13923434.5	3141038.8	13923436.1	3141017.8
L308	4.2	NO4°E	13923436.1	3141017.8	13923440.2	3141018.1
L309	65.5	S10°W	13923391.5	3140967.2	13923326.9	3140956.2
L310	11.0	S05°W	13923326.9	3140956.2	13923316.0	3140955.1
L311	22.4	N85°W	13923317.5	3140941.2	13923319.7	3140918.9
L312	60.1	N02°E	13923319.7	3140918.9	13923379.7	3140920.9
L313	22.6	N15°W	13923393.1	3140919.4	13923414.9	3140913.5
L314	60.2	N80°W	13923454.7	3140869.9	13923465.4	3140810.6
L315	30.6	N84°W	13923465.4	3140810.6	13923468.7	3140780.2
L316	31.2	S01°W	13923257.7	3140952.2	13923226.4	3140951.9
L317	150.4	S03°W	13923189.3	3140952.9	13923039.0	3140945.5
L318	2.0	S87°W	13923039.0	3140945.5	13923038.9	3140943.5
L319	31.3	NO1°E	13923226.3	3140937.9	13923257.7	3140938.2
L320	20.3	S05°W	13923481.0	3140980.9	13923460.9	3140979.3
L321	20.3	S04°W	13923479.4	3141002.1	13923459.2	3141000.6

LEE RD CURVE TABLE

DELTA

(DEGREES)

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065

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001

007

DELTA

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145

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090

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137

048

LENGTH RADIUS

5906

45

55

493

37.1 | 15445

187.5 | 15459

NUMBER (FEET) (FEET) (DEGREES)

99

5884

99

NUMBER | (FEET) | (FEET) |

315.0

0.9

75.3

13.6

62.3

58.4

C309 60.0 507

CURVE | LENGTH | RADIUS |

7.9

12.7

94.7

7.8

66.3

12.0

82.8

CURVE

C300

C304

C305

C306

C600

C602

C604

C605

C606

SEGMENT

START

NORTHING

13923480.3

EAST MEDIAN CURVE TABLE

START NORTHING

SEGMENT

START

EASTING

SEGMENT

END

NORTHING

3140781.5 | 13923452.6

13923441.4 | 3141027.7 | 13923440.9 | 3141027.2

13923440.2 | 3141018.1 | 13923440.7 | 3141017.5

13923440.7 | 3141017.5 | 13923391.5 | 3140967.2

13923379.7 | 3140920.9 | 13923393.1 | 3140919.4

13923414.9 | 3140913.5 | 13923454.7 | 3140869.9

13923316.0 | 3140955.1 | 13923257.7 | 3140952.2

13923226.4 | 3140951.9 | 13923189.3 | 3140952.9

13923038.9 3140943.5 13923226.3 3140937.9

13923257.7 3140938.2 13923317.5 3140941.2

13923672.5 | 3140994.8 | 13923677.0 | 3141000.2

13923671.4 | 3141076.0 | 13923662.1 | 3141078.1

13923662.1 3141078.1 13923584.8 3141030.0

13923482.2 | 3140984.9 | 13923487.6 | 3140980.3

13923477.3 | 3141051.1 | 13923482.2 | 3140984.9

13923485.7 | 3141055.0 | 13923477.3 | 3141051.1

13923561.5 | 3141028.2 | 13923485.7 | 3141055.0

END NORTHING

SEGMENT SEGMENT SEGMENT START START END

EASTING

SEGMENT


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EASTING

3141095.3


SEGMENT

EASTING

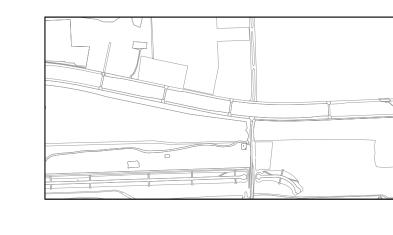

	WEST MEDIAN LINE TABLE									
LINE NUMBER	LENGTH (FEET)	DIRECTION	SEGMENT START NORTHING	SEGMENT START EASTING	SEGMENT END NORTHING	SEGMENT END EASTING				
L400	40.7	N85°W	13923681.2	3140934.4	13923685.0	3140893.8				
L401	10.8	S04°W	13923604.5	3140913.2	13923593.7	3140912.4				
L402	57.7	S85°E	13923504.9	3140862.6	13923499.5	3140920.0				
L403	172.3	N04°E	13923504.1	3140925.4	13923675.8	3140938.9				

CURB REPAIR LINE TABLE										
LINE NUMBER	LENGTH (FEET)	DIRECTION	SEGMENT START NORTHING	SEGMENT START EASTING	SEGMENT END NORTHING	SEGMENT END EASTING				
L700	5.8	N86°W	13923735.1	3141023.8	13923735.5	3141018.0				
L701	6.5	S86°E	13923730.2	3141022.9	13923729.7	3141029.4				
L702	4.6	S04°W	13923729.2	3141029.8	13923724.6	3141029.5				
L703	5.0	N04°E	13923721.8	3141034.3	13923726.8	3141034.7				
L704	6.1	N87°W	13923717.8	3141050.1	13923718.2	3141044.0				

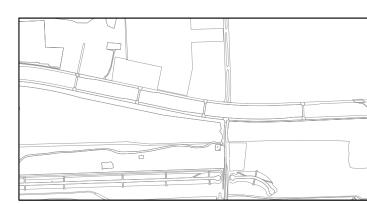

LTOS	172.5	NOTL	1032004.1	3170323.7	10323073.0	3170330.3	
CURB REPAIR LINE TABLE							
LINE NUMBER	LENGTH (FEET)	DIRECTION	SEGMENT START NORTHING	SEGMENT START EASTING	SEGMENT END NORTHING	SEGMENT END EASTING	
L700	5.8	N86°W	13923735.1	3141023.8	13923735.5	3141018.0	
L701	6.5	S86°E	13923730.2	3141022.9	13923729.7	3141029.4	
L702	4.6	S04°W	13923729.2	3141029.8	13923724.6	3141029.5	
L703	5.0	NO4°E	13923721.8	3141034.3	13923726.8	3141034.7	

HOUSTON AIRPORT SYSTEM

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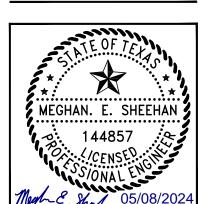
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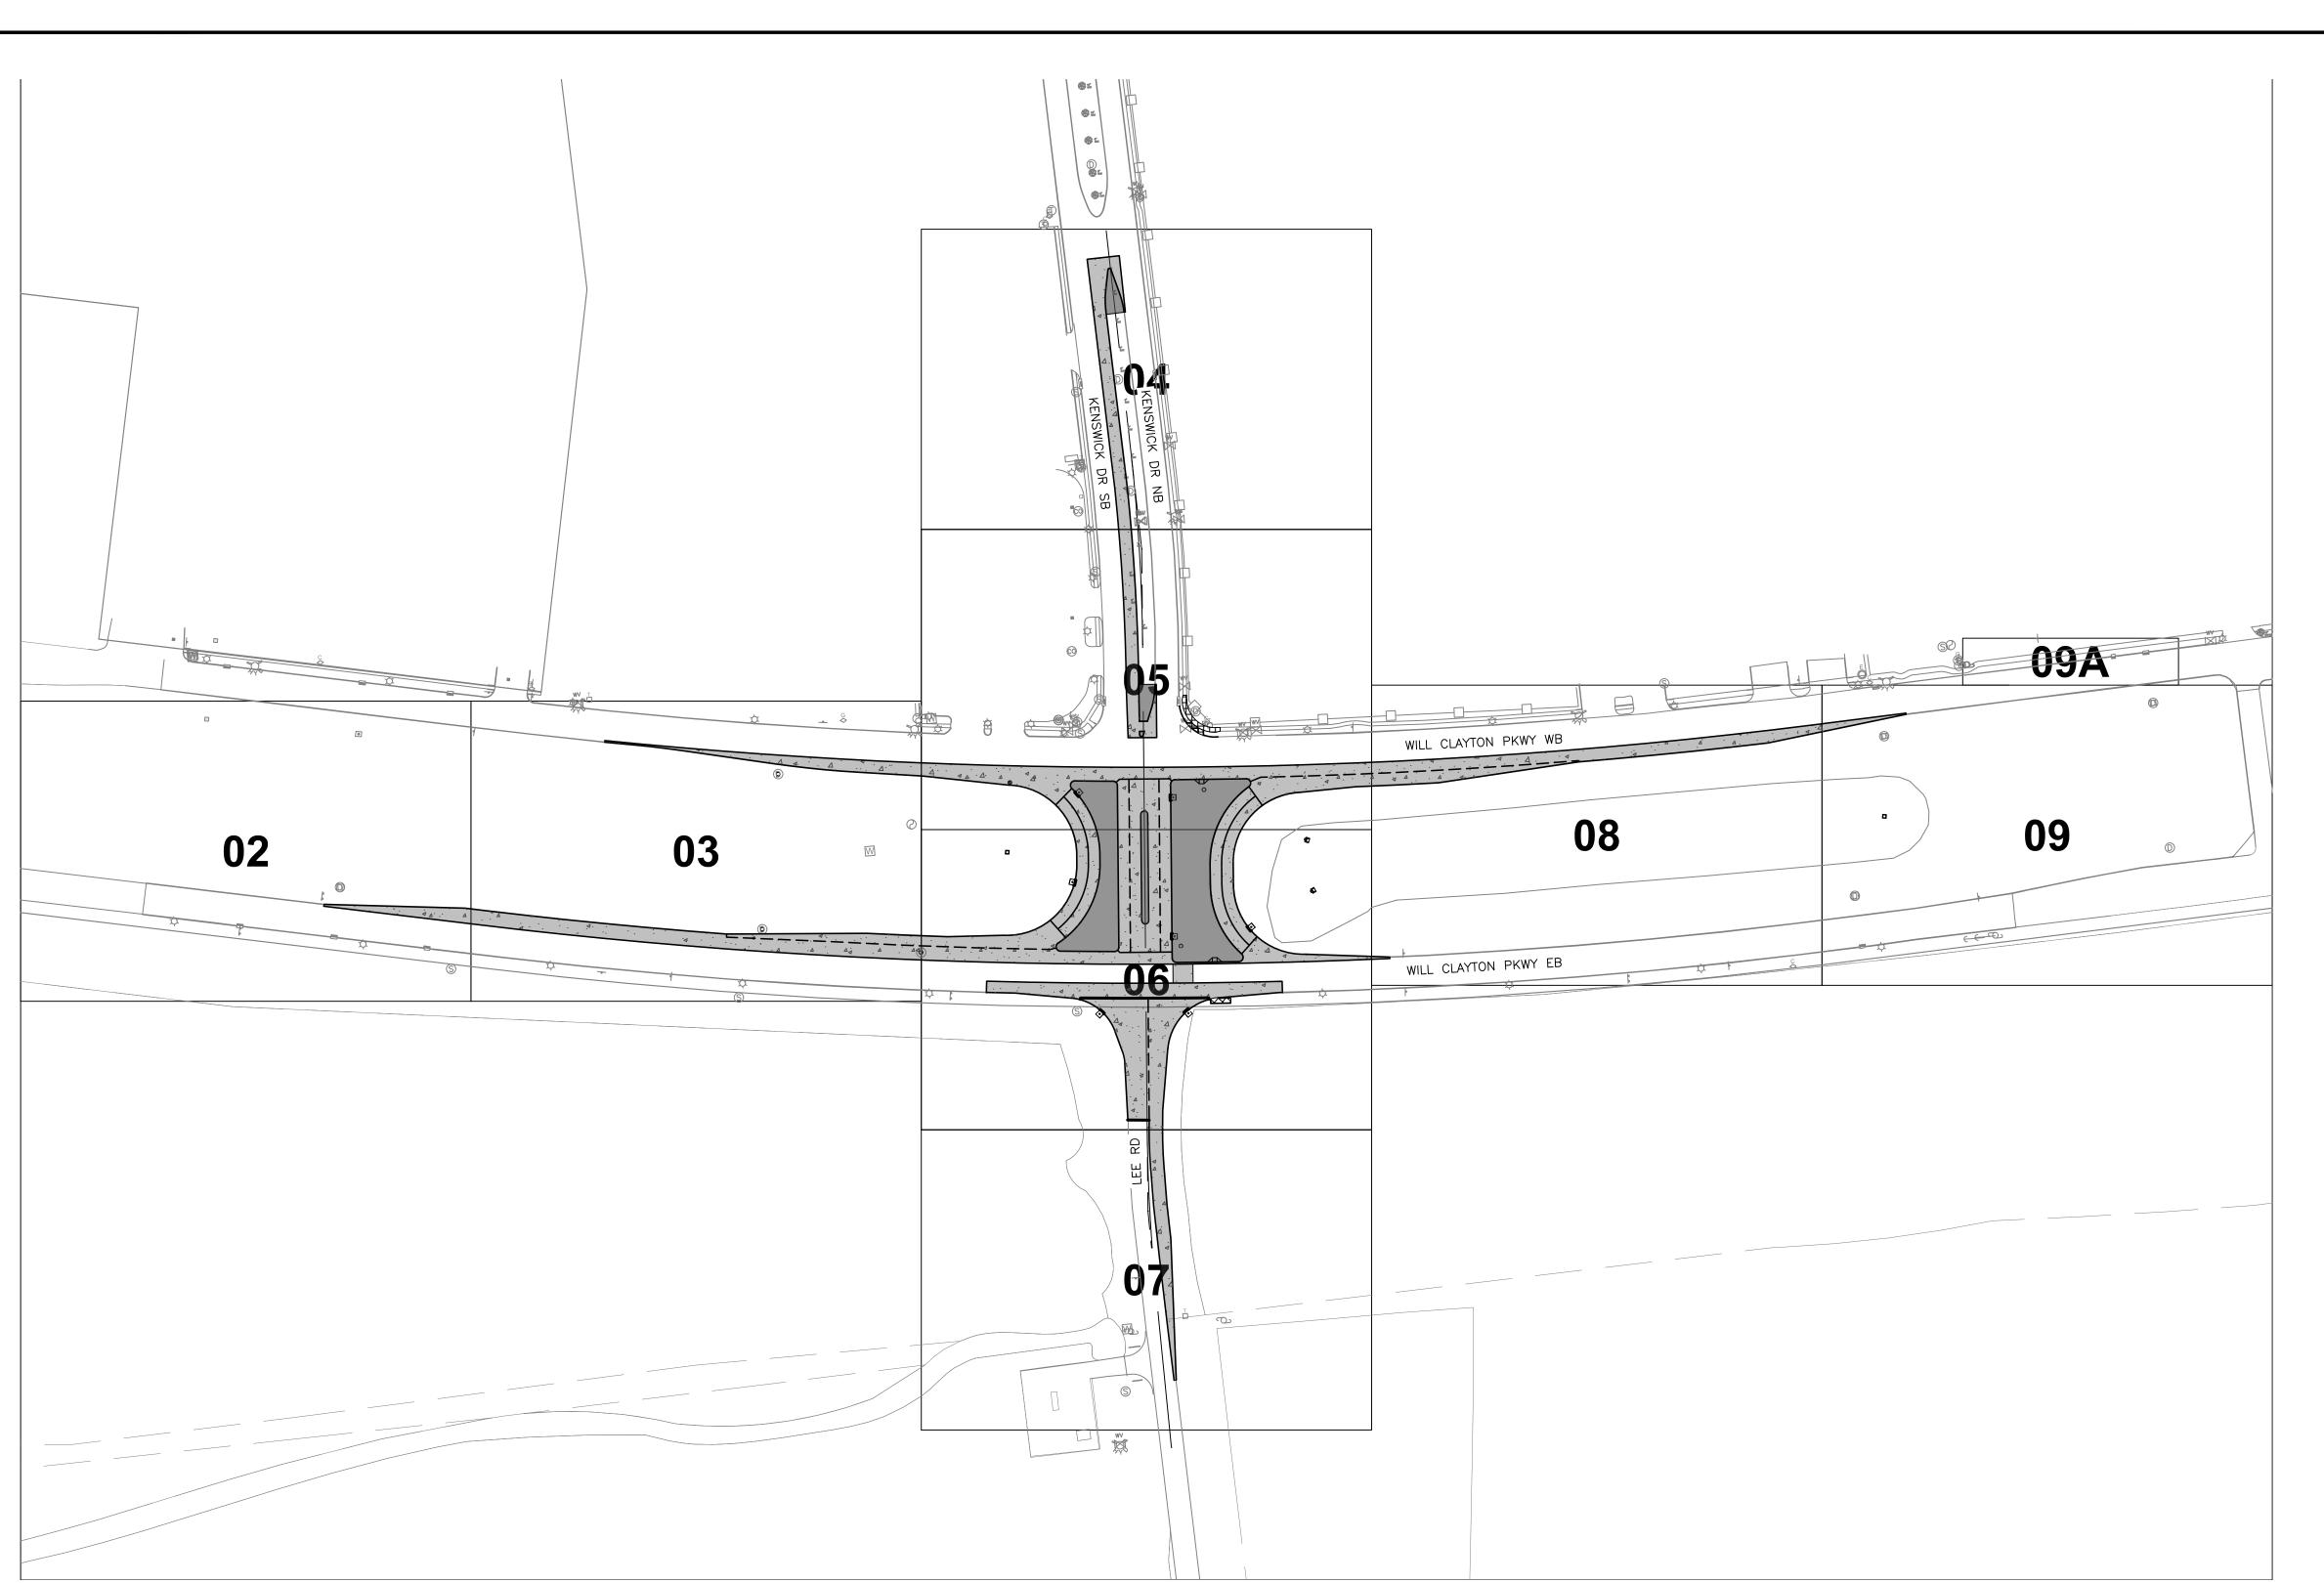
PROJECT MGR:	MES
DESIGNER:	ALR
DRAWN BY:	ALR
CHECK BY:	PMW
SCALE:	
DATE:	05/08/2024




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100072032
I.P. NO.
I.P. NO.

H.A.S. NO. SHEET NO.





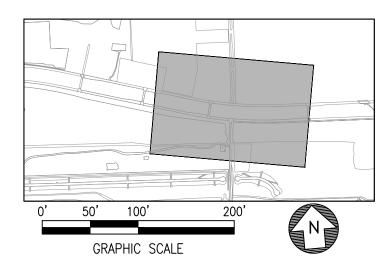

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Recommended

Society of the State of the State

EXTENSION TING PLAN

KENSWICK DRIVE OVERALL JOINT

PROJECT MGR:	MES
DESIGNER:	ALR
DRAWN BY:	ALR
CHECK BY:	PMW
SCALE:	
DATE:	05/08/2024



APPROVED BY:

DIRECTOR HOUSTON AIRPORT S


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A.I.P. NO.

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SHEET NO.

CJ-101




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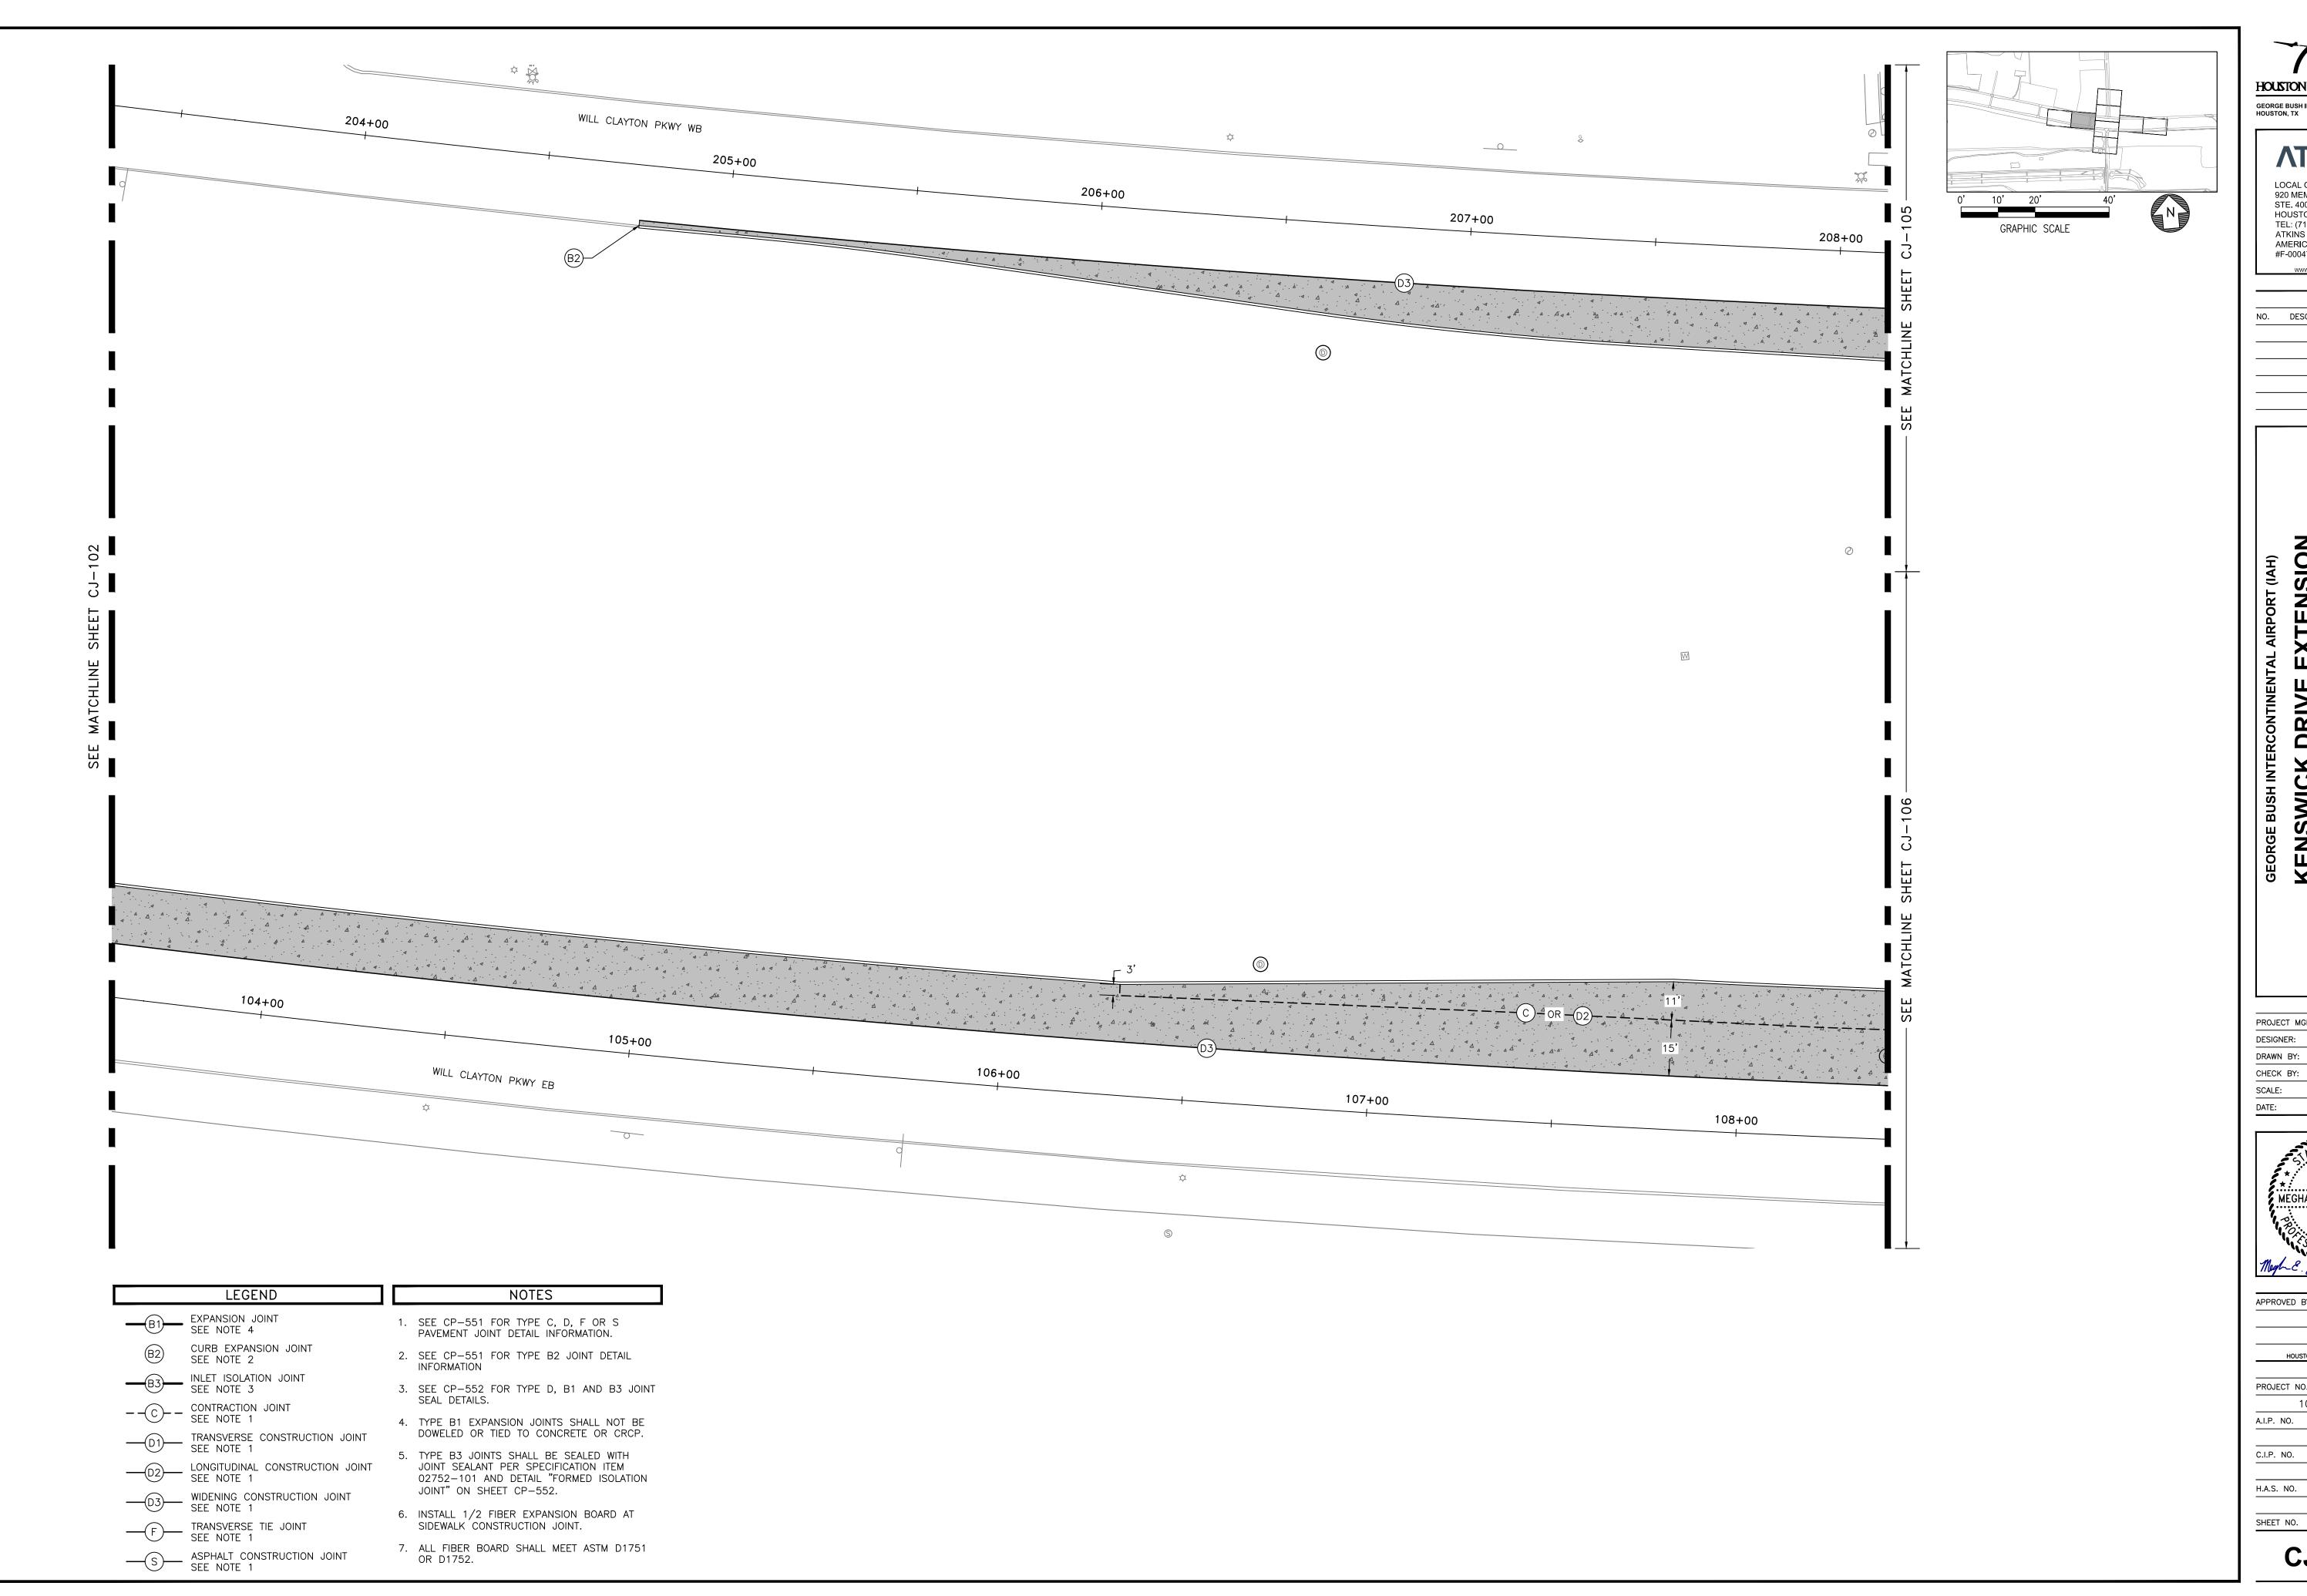
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PROJECT NO. 100072032
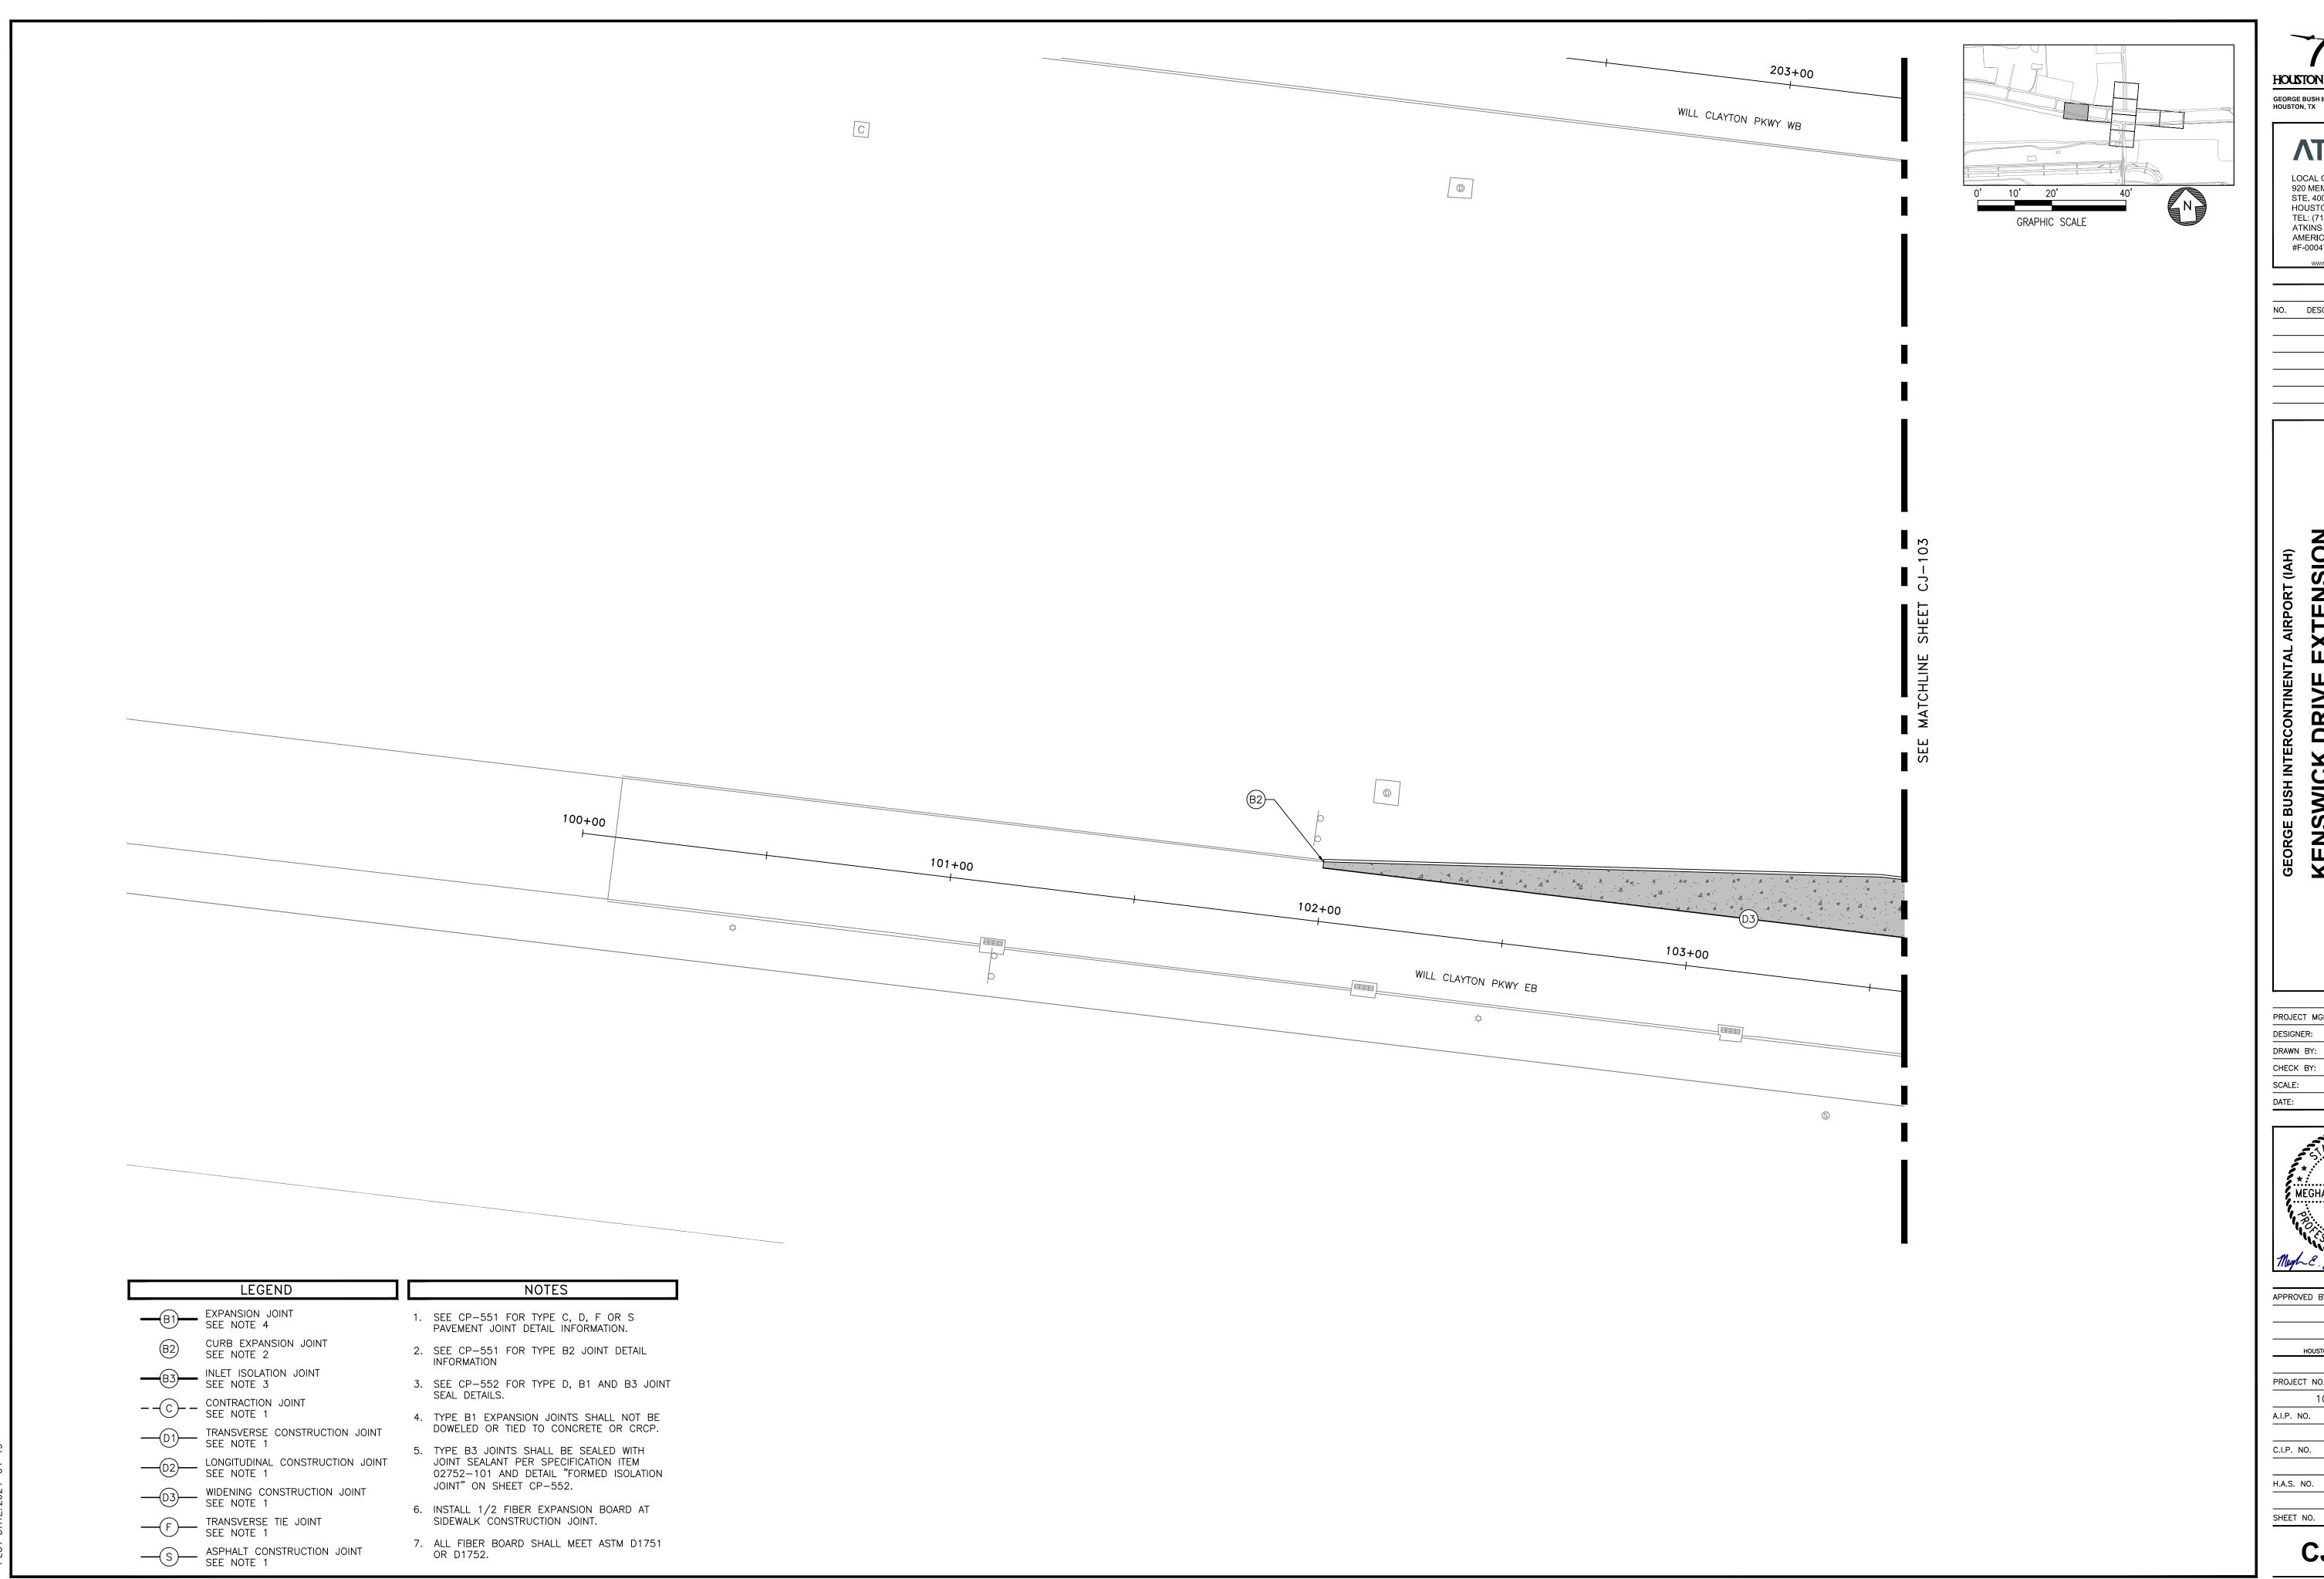
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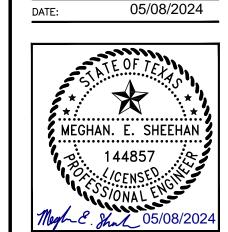
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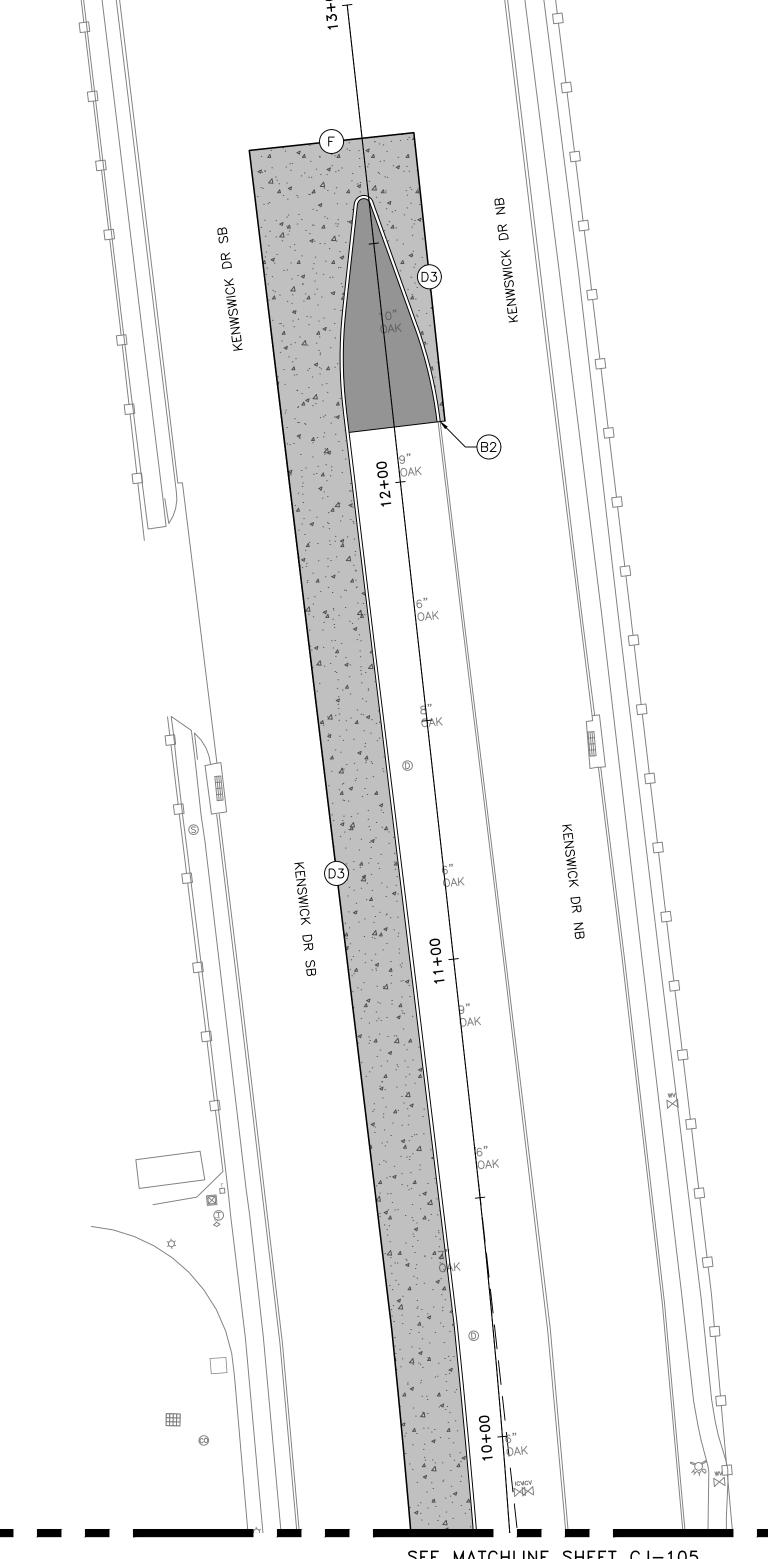
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C.I.P. NO.

H.A.S. NO. 935

SHEET NO. **CJ-104** 

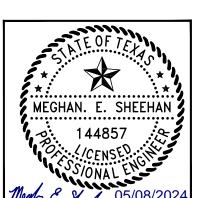

SEE MATCHLINE SHEET CJ-105

## LEGEND





--C-- CONTRACTION JOINT SEE NOTE 1



_______ LONGITUDINAL CONSTRUCTION JOINT SEE NOTE 1



TRANSVERSE TIE JOINT SEE NOTE 1

NOTES

SEE CP-551 FOR TYPE C, D, F OR S PAVEMENT JOINT DETAIL INFORMATION.

2. SEE CP-551 FOR TYPE B2 JOINT DETAIL INFORMATION


3. SEE CP-552 FOR TYPE D, B1 AND B3 JOINT SEAL DETAILS.


4. TYPE B1 EXPANSION JOINTS SHALL NOT BE DOWELED OR TIED TO CONCRETE OR CRCP.


5. TYPE B3 JOINTS SHALL BE SEALED WITH JOINT SEALANT PER SPECIFICATION ITEM 02752-101 AND DETAIL "FORMED ISOLATION JOINT" ON SHEET CP-552.


INSTALL 1/2 FIBER EXPANSION BOARD AT SIDEWALK CONSTRUCTION JOINT.


## B1 EXPANSION JOINT SEE NOTE 4

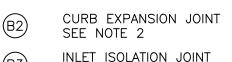


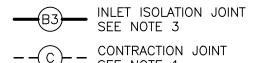

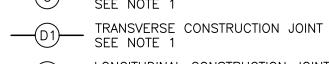

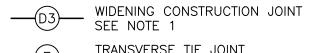

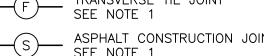

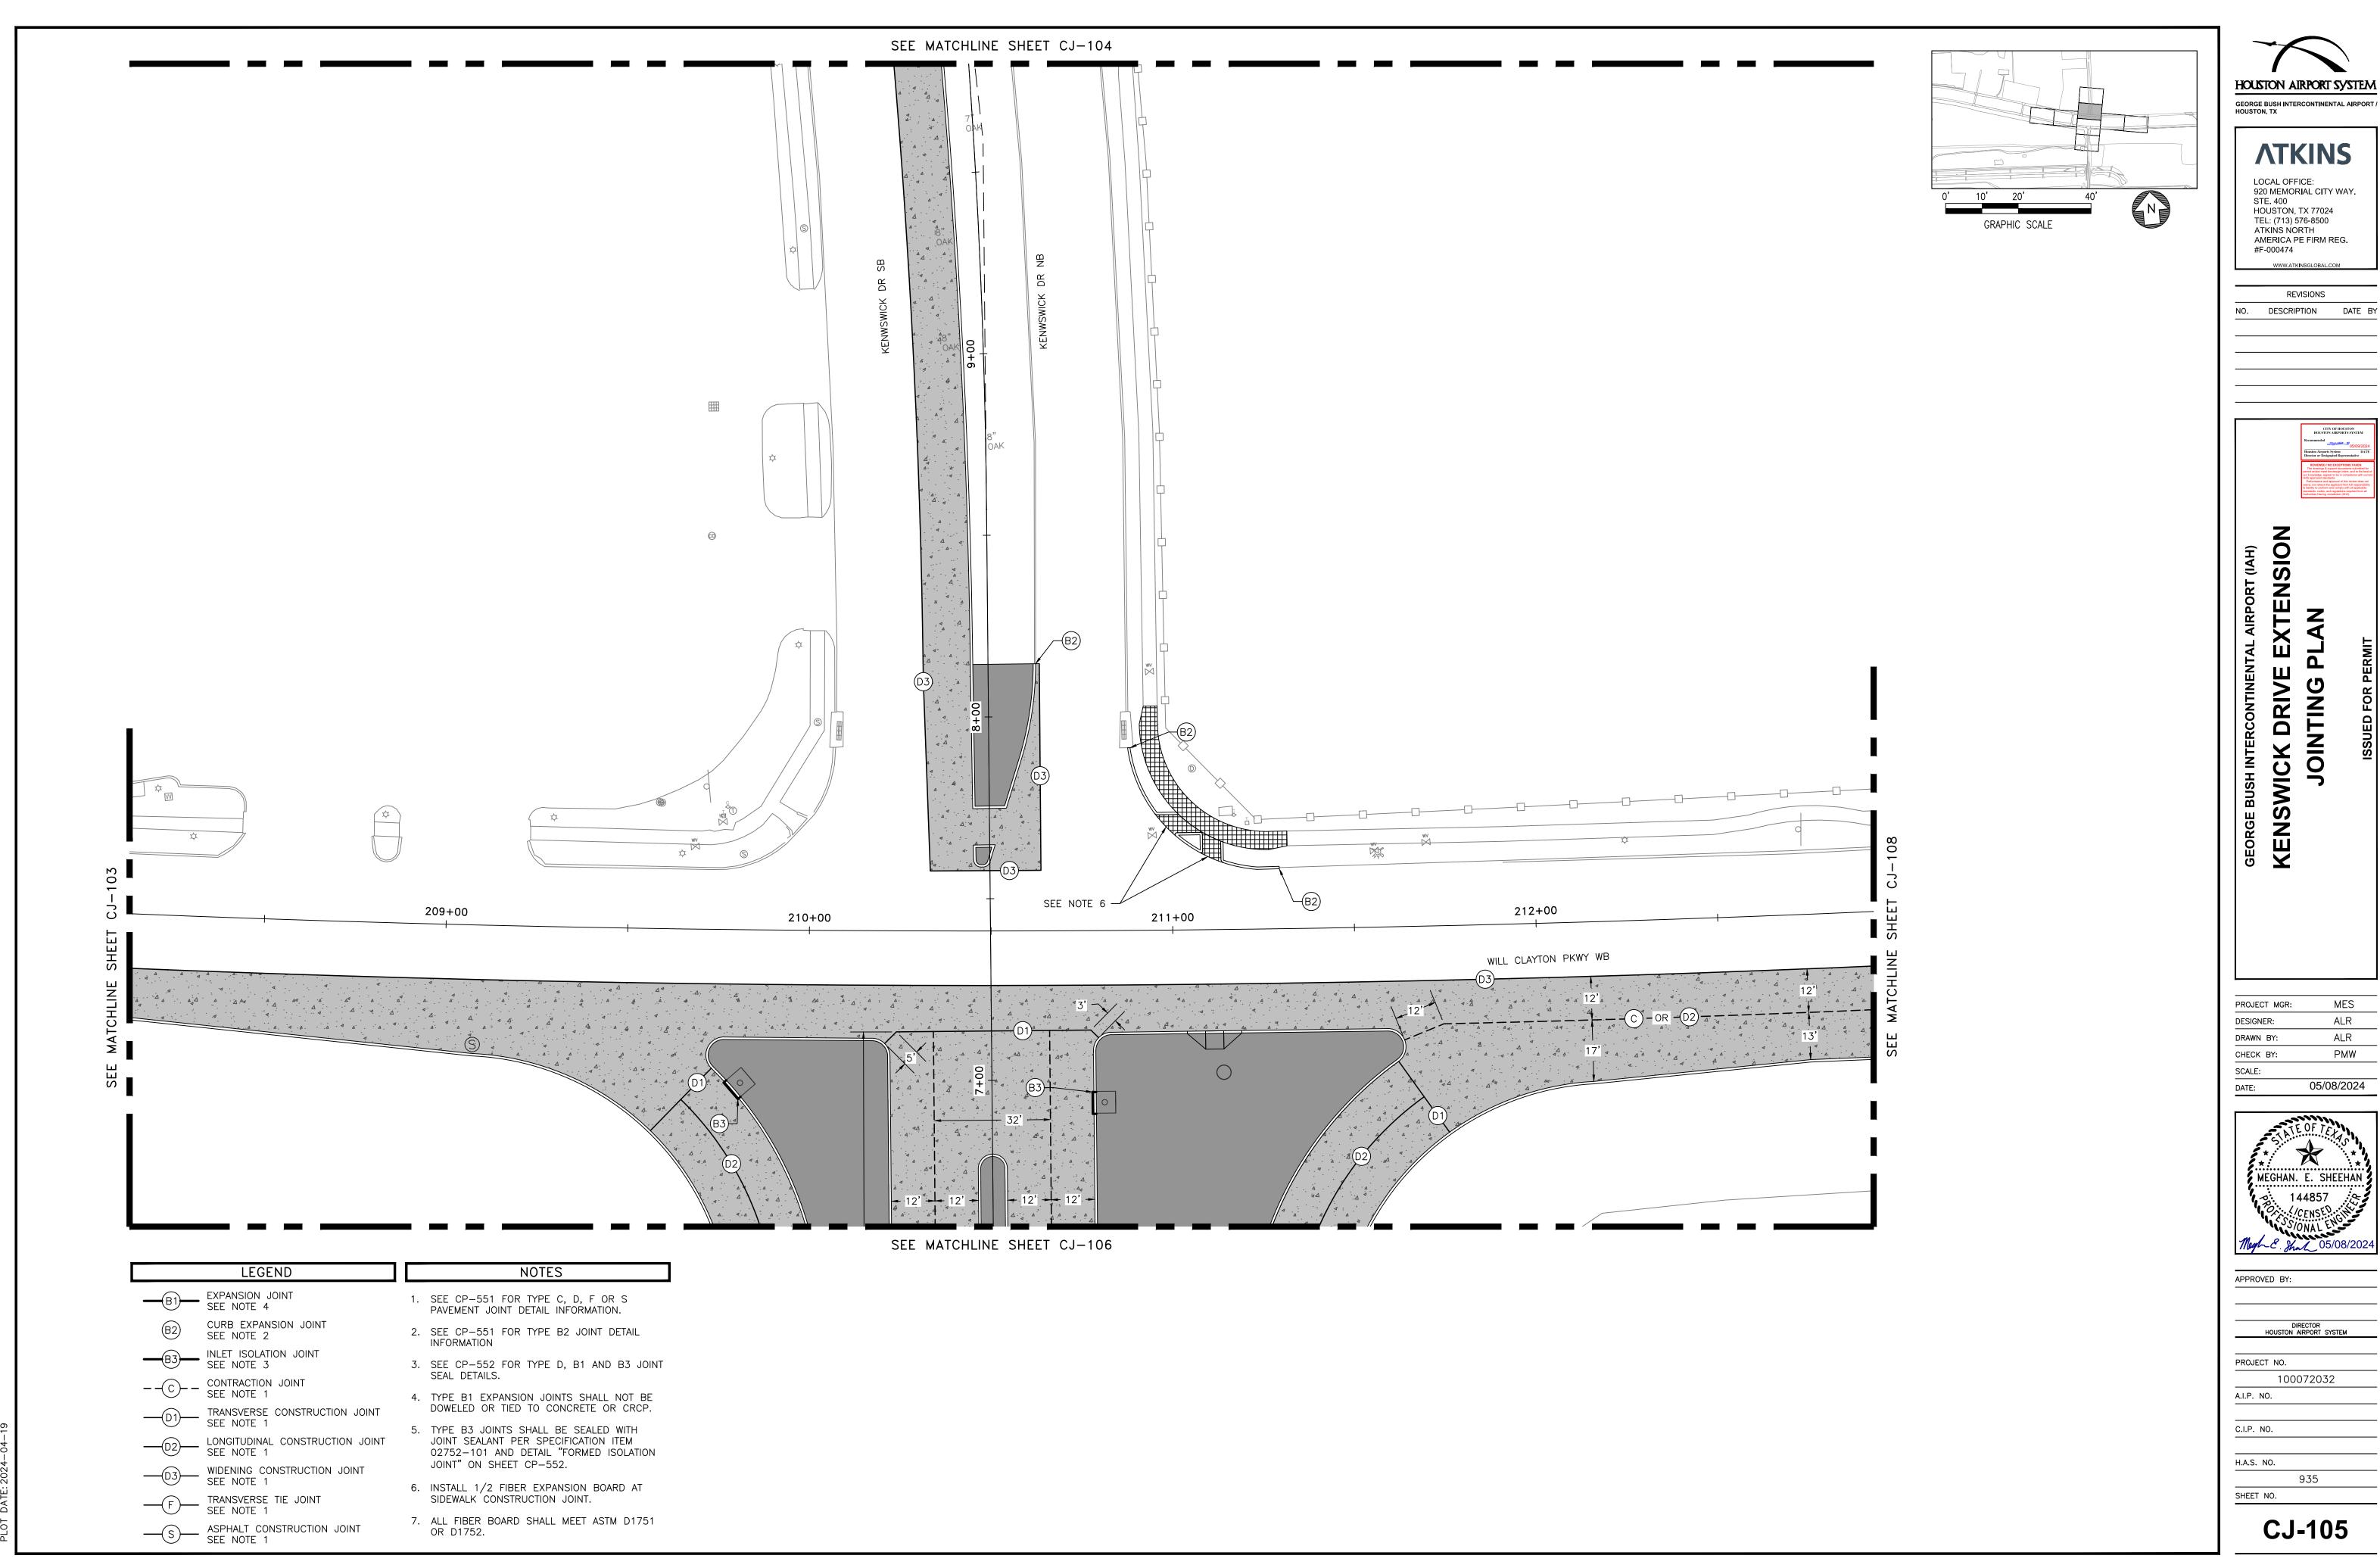

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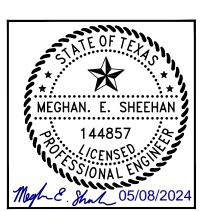
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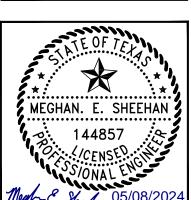
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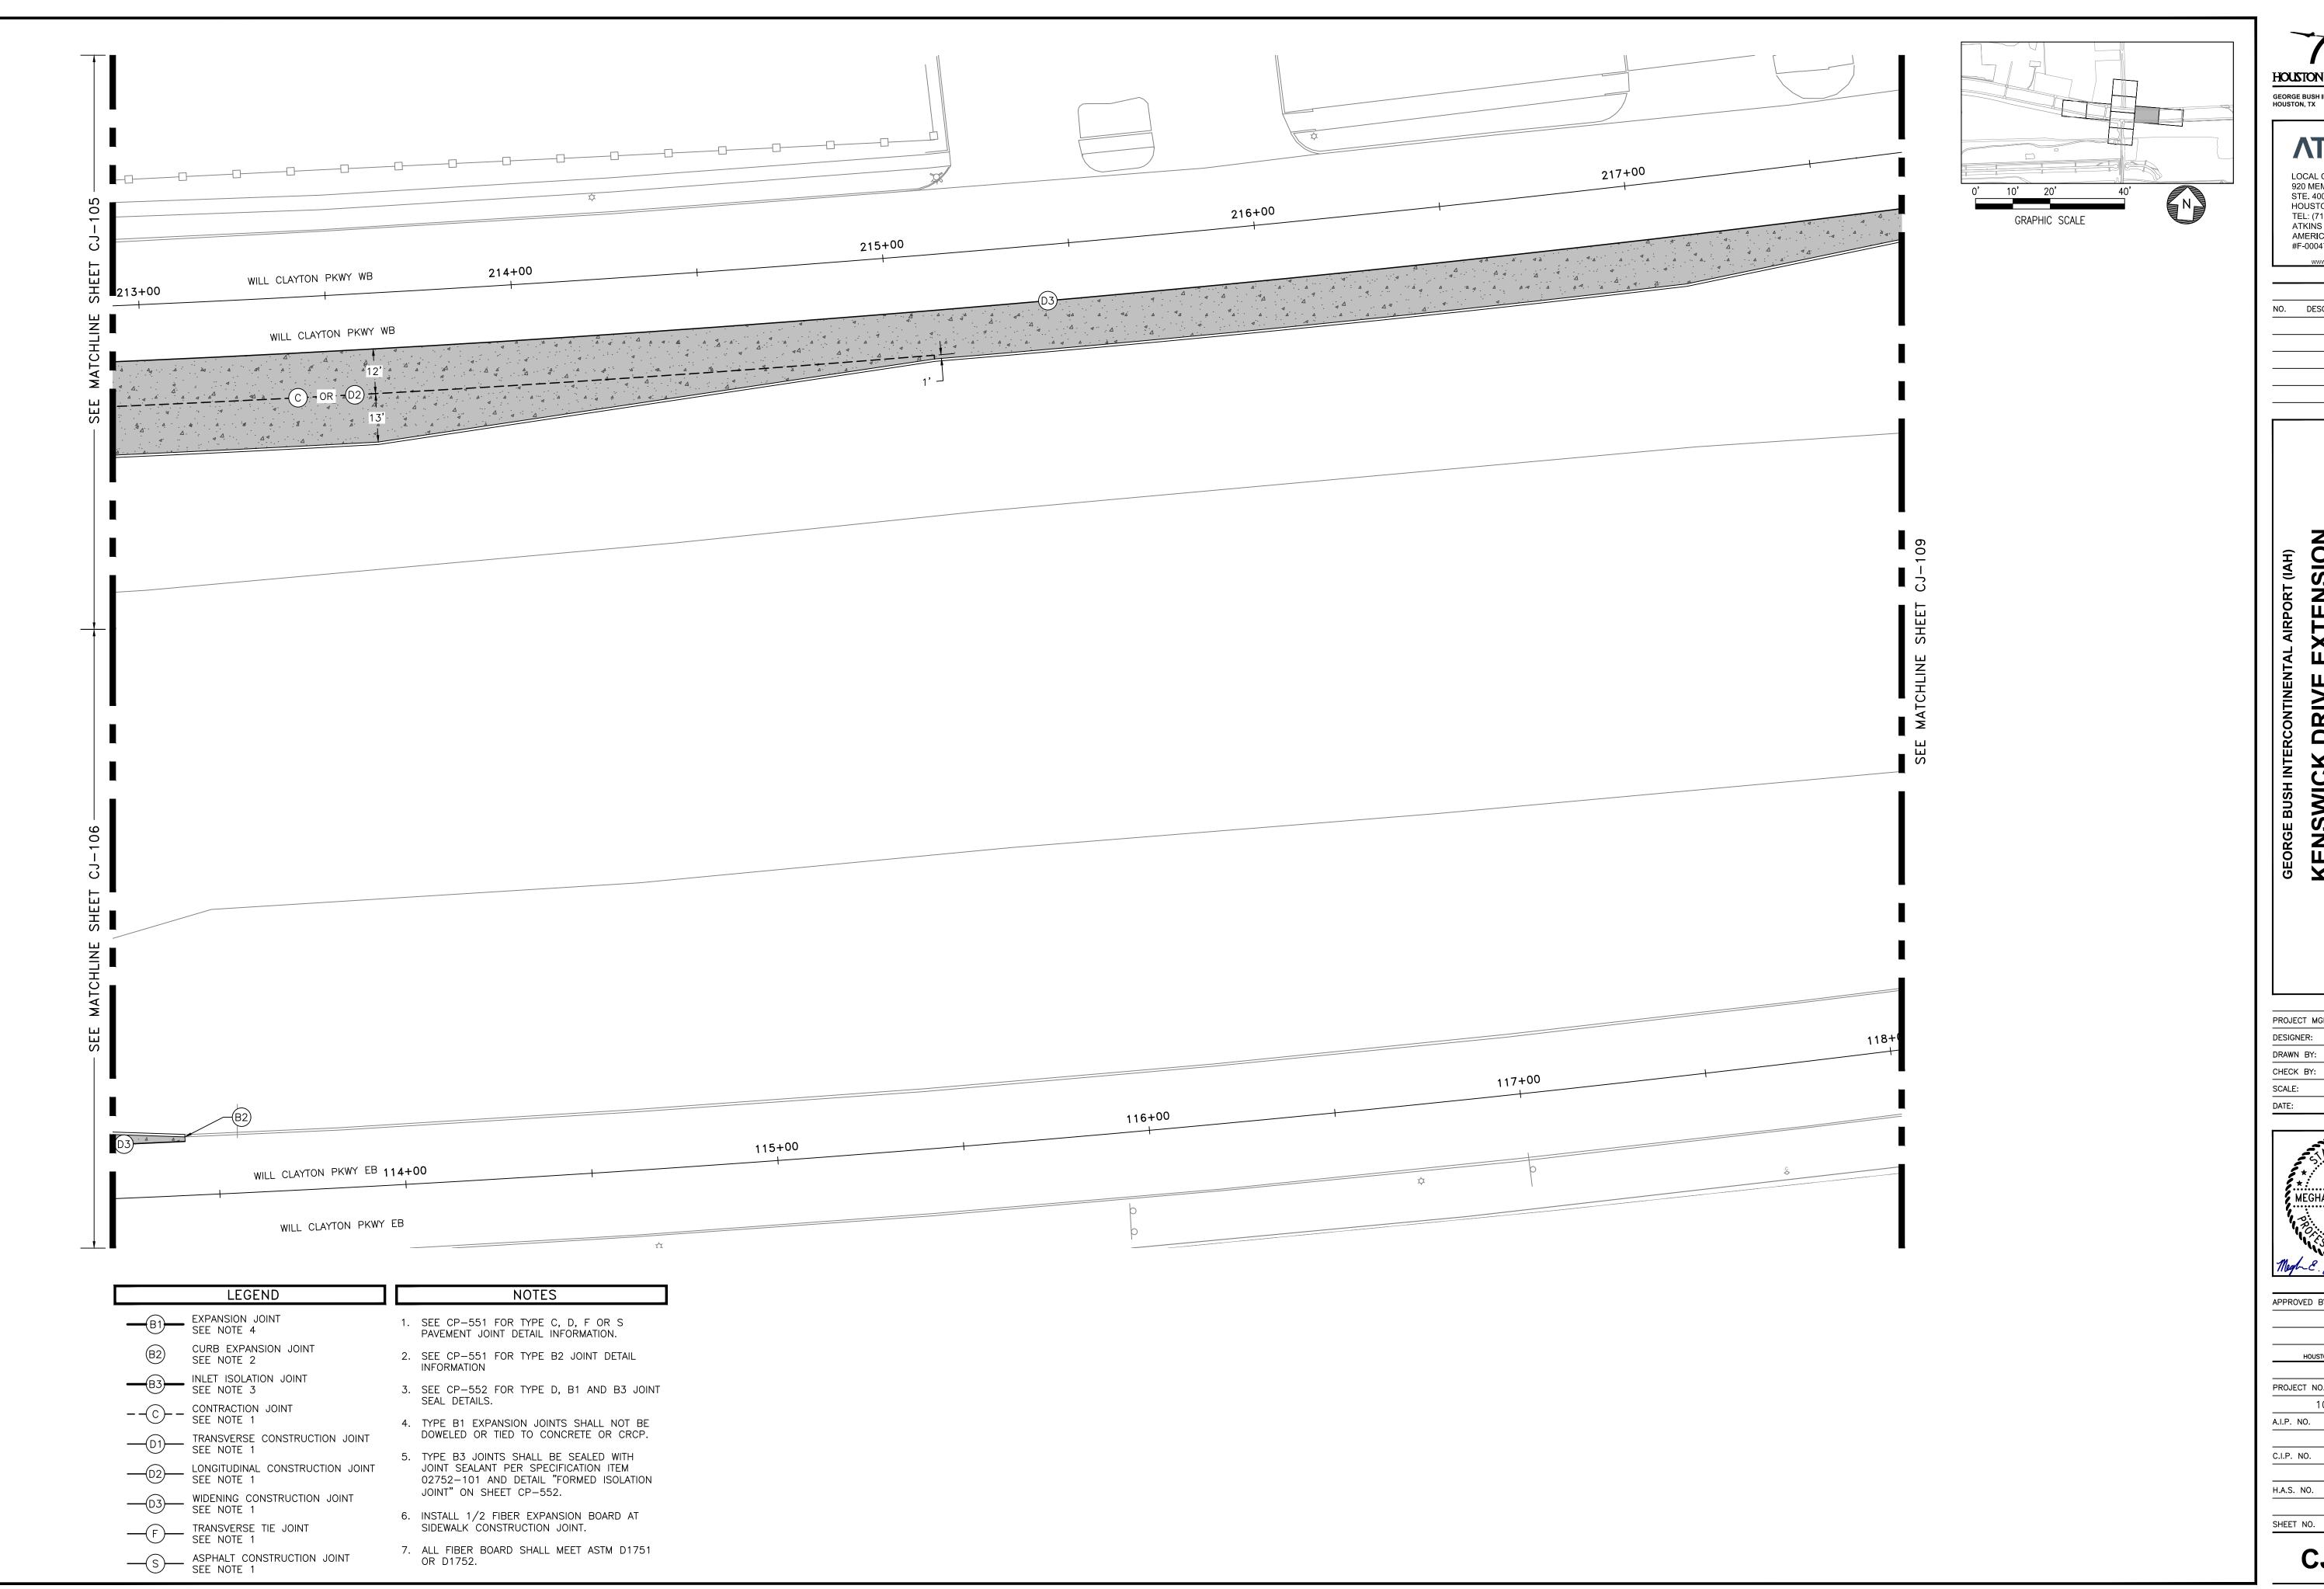
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PMW


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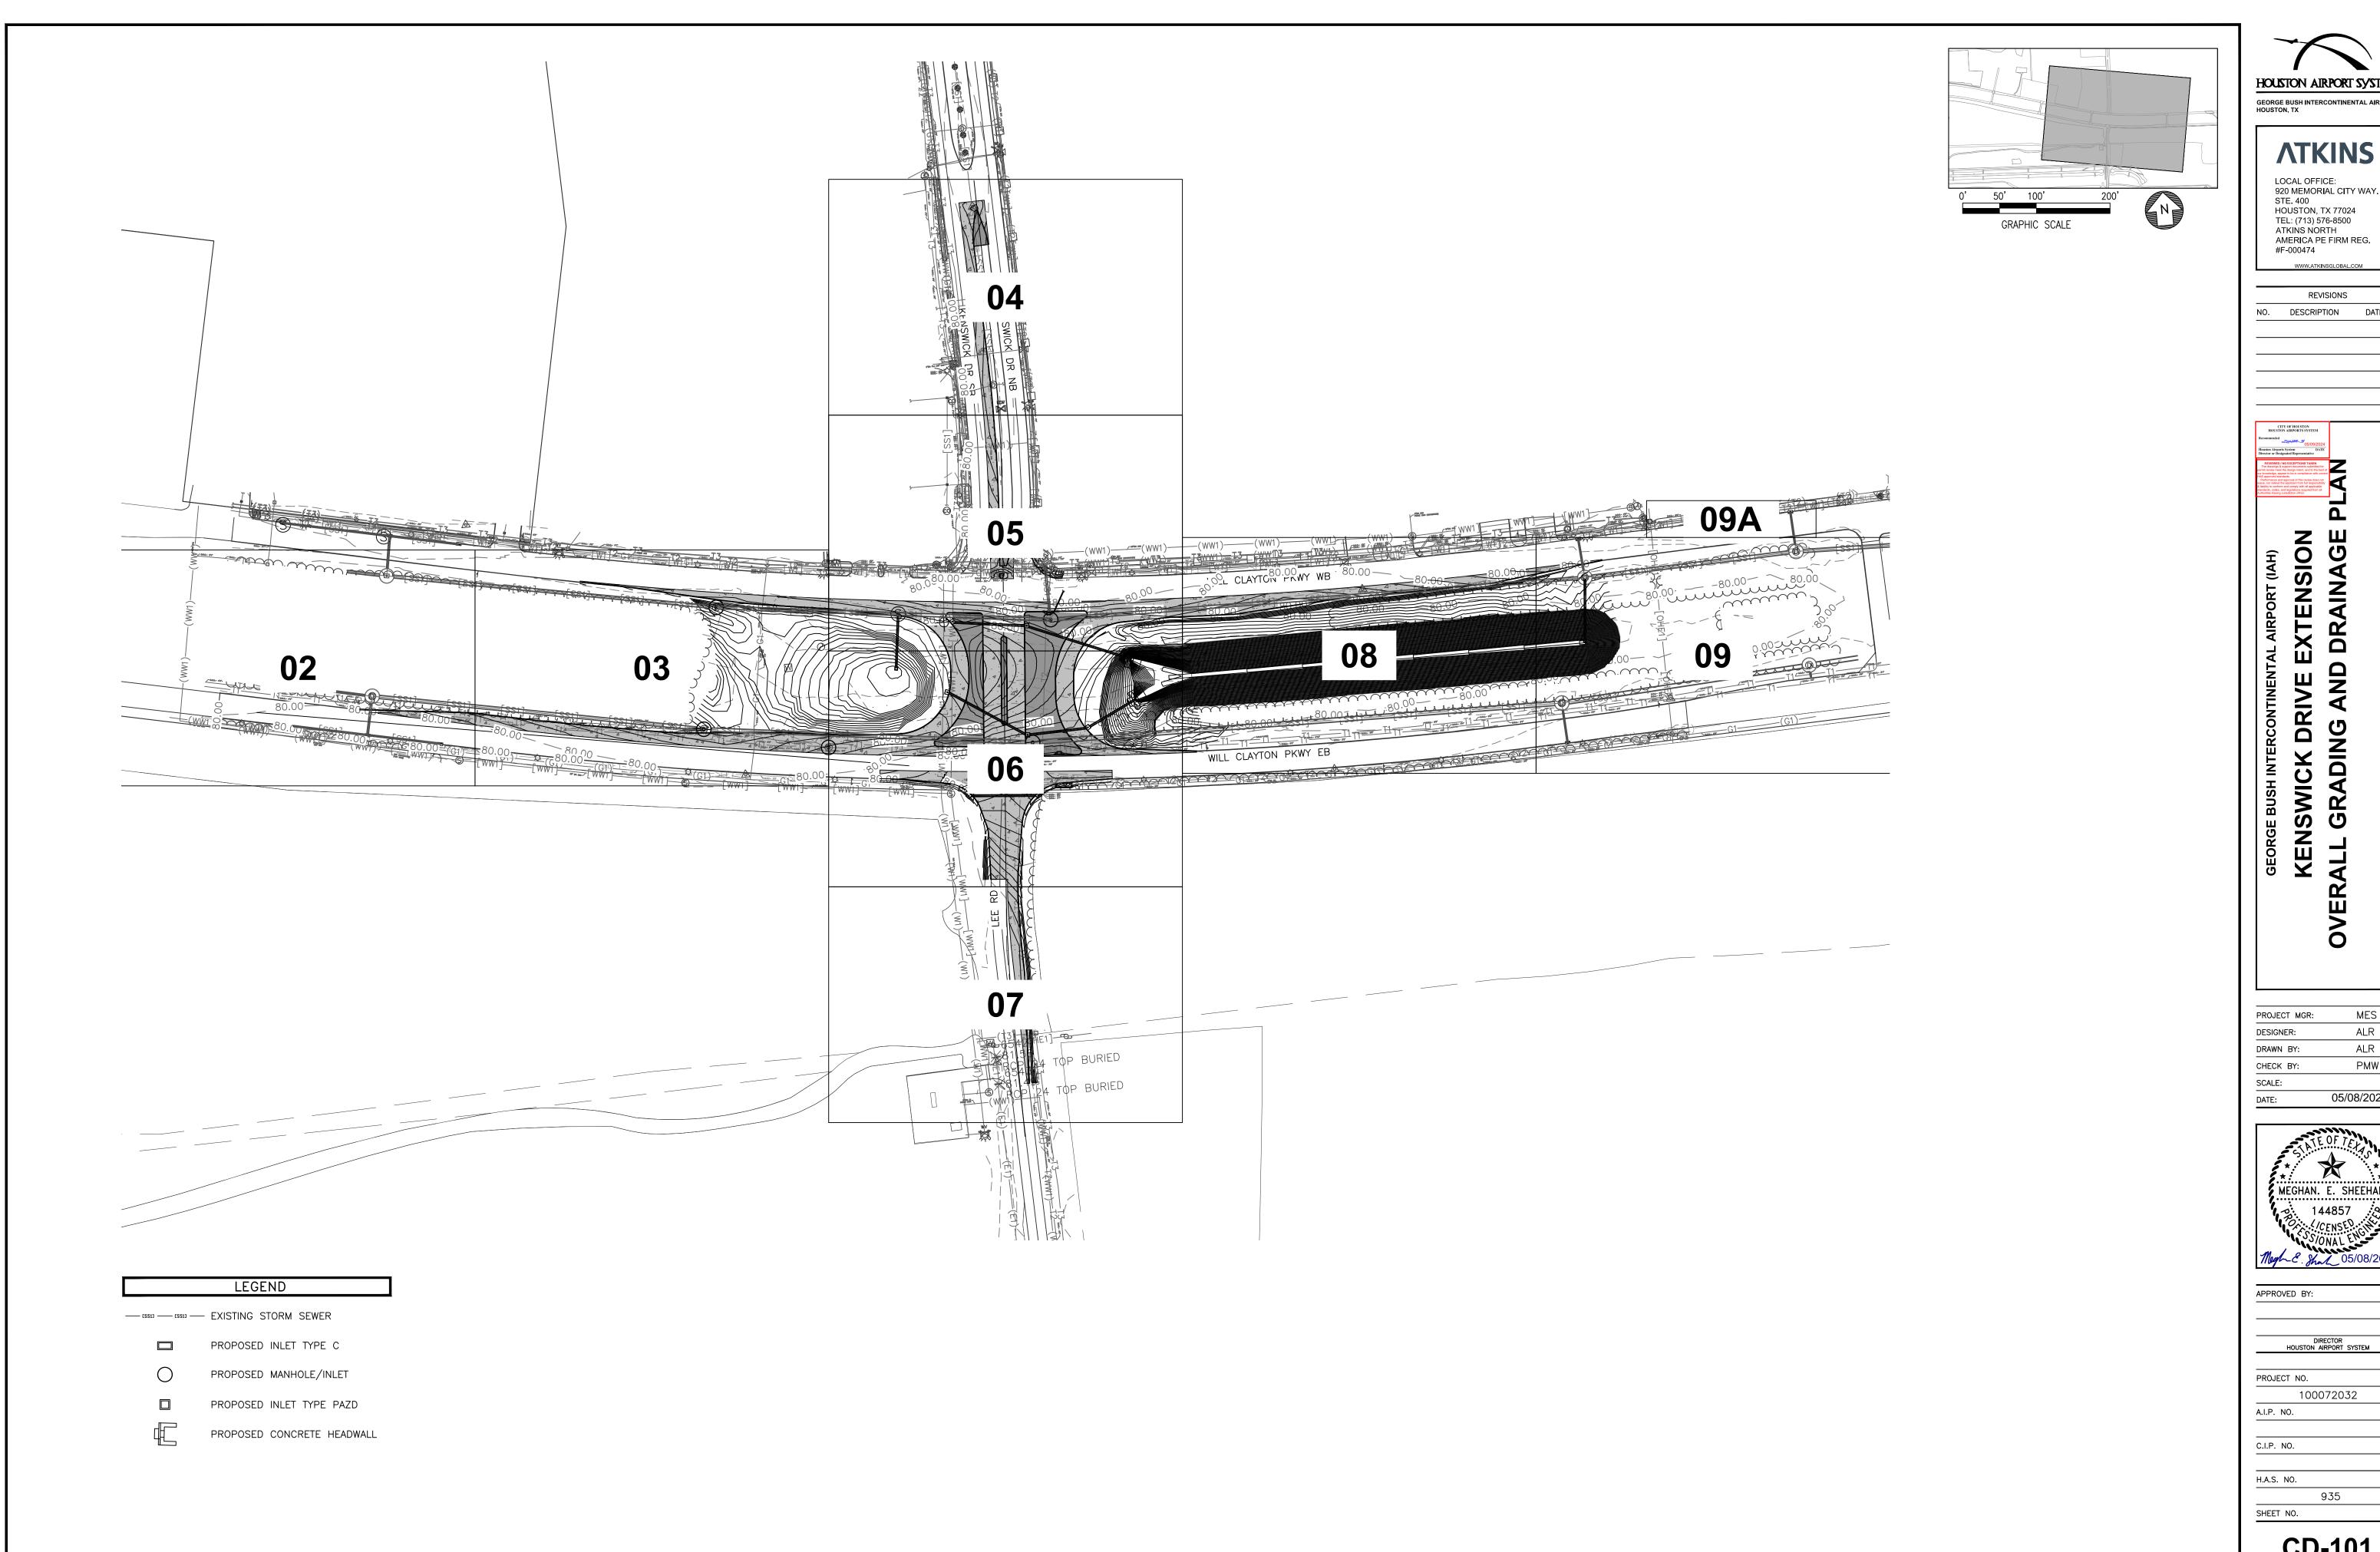


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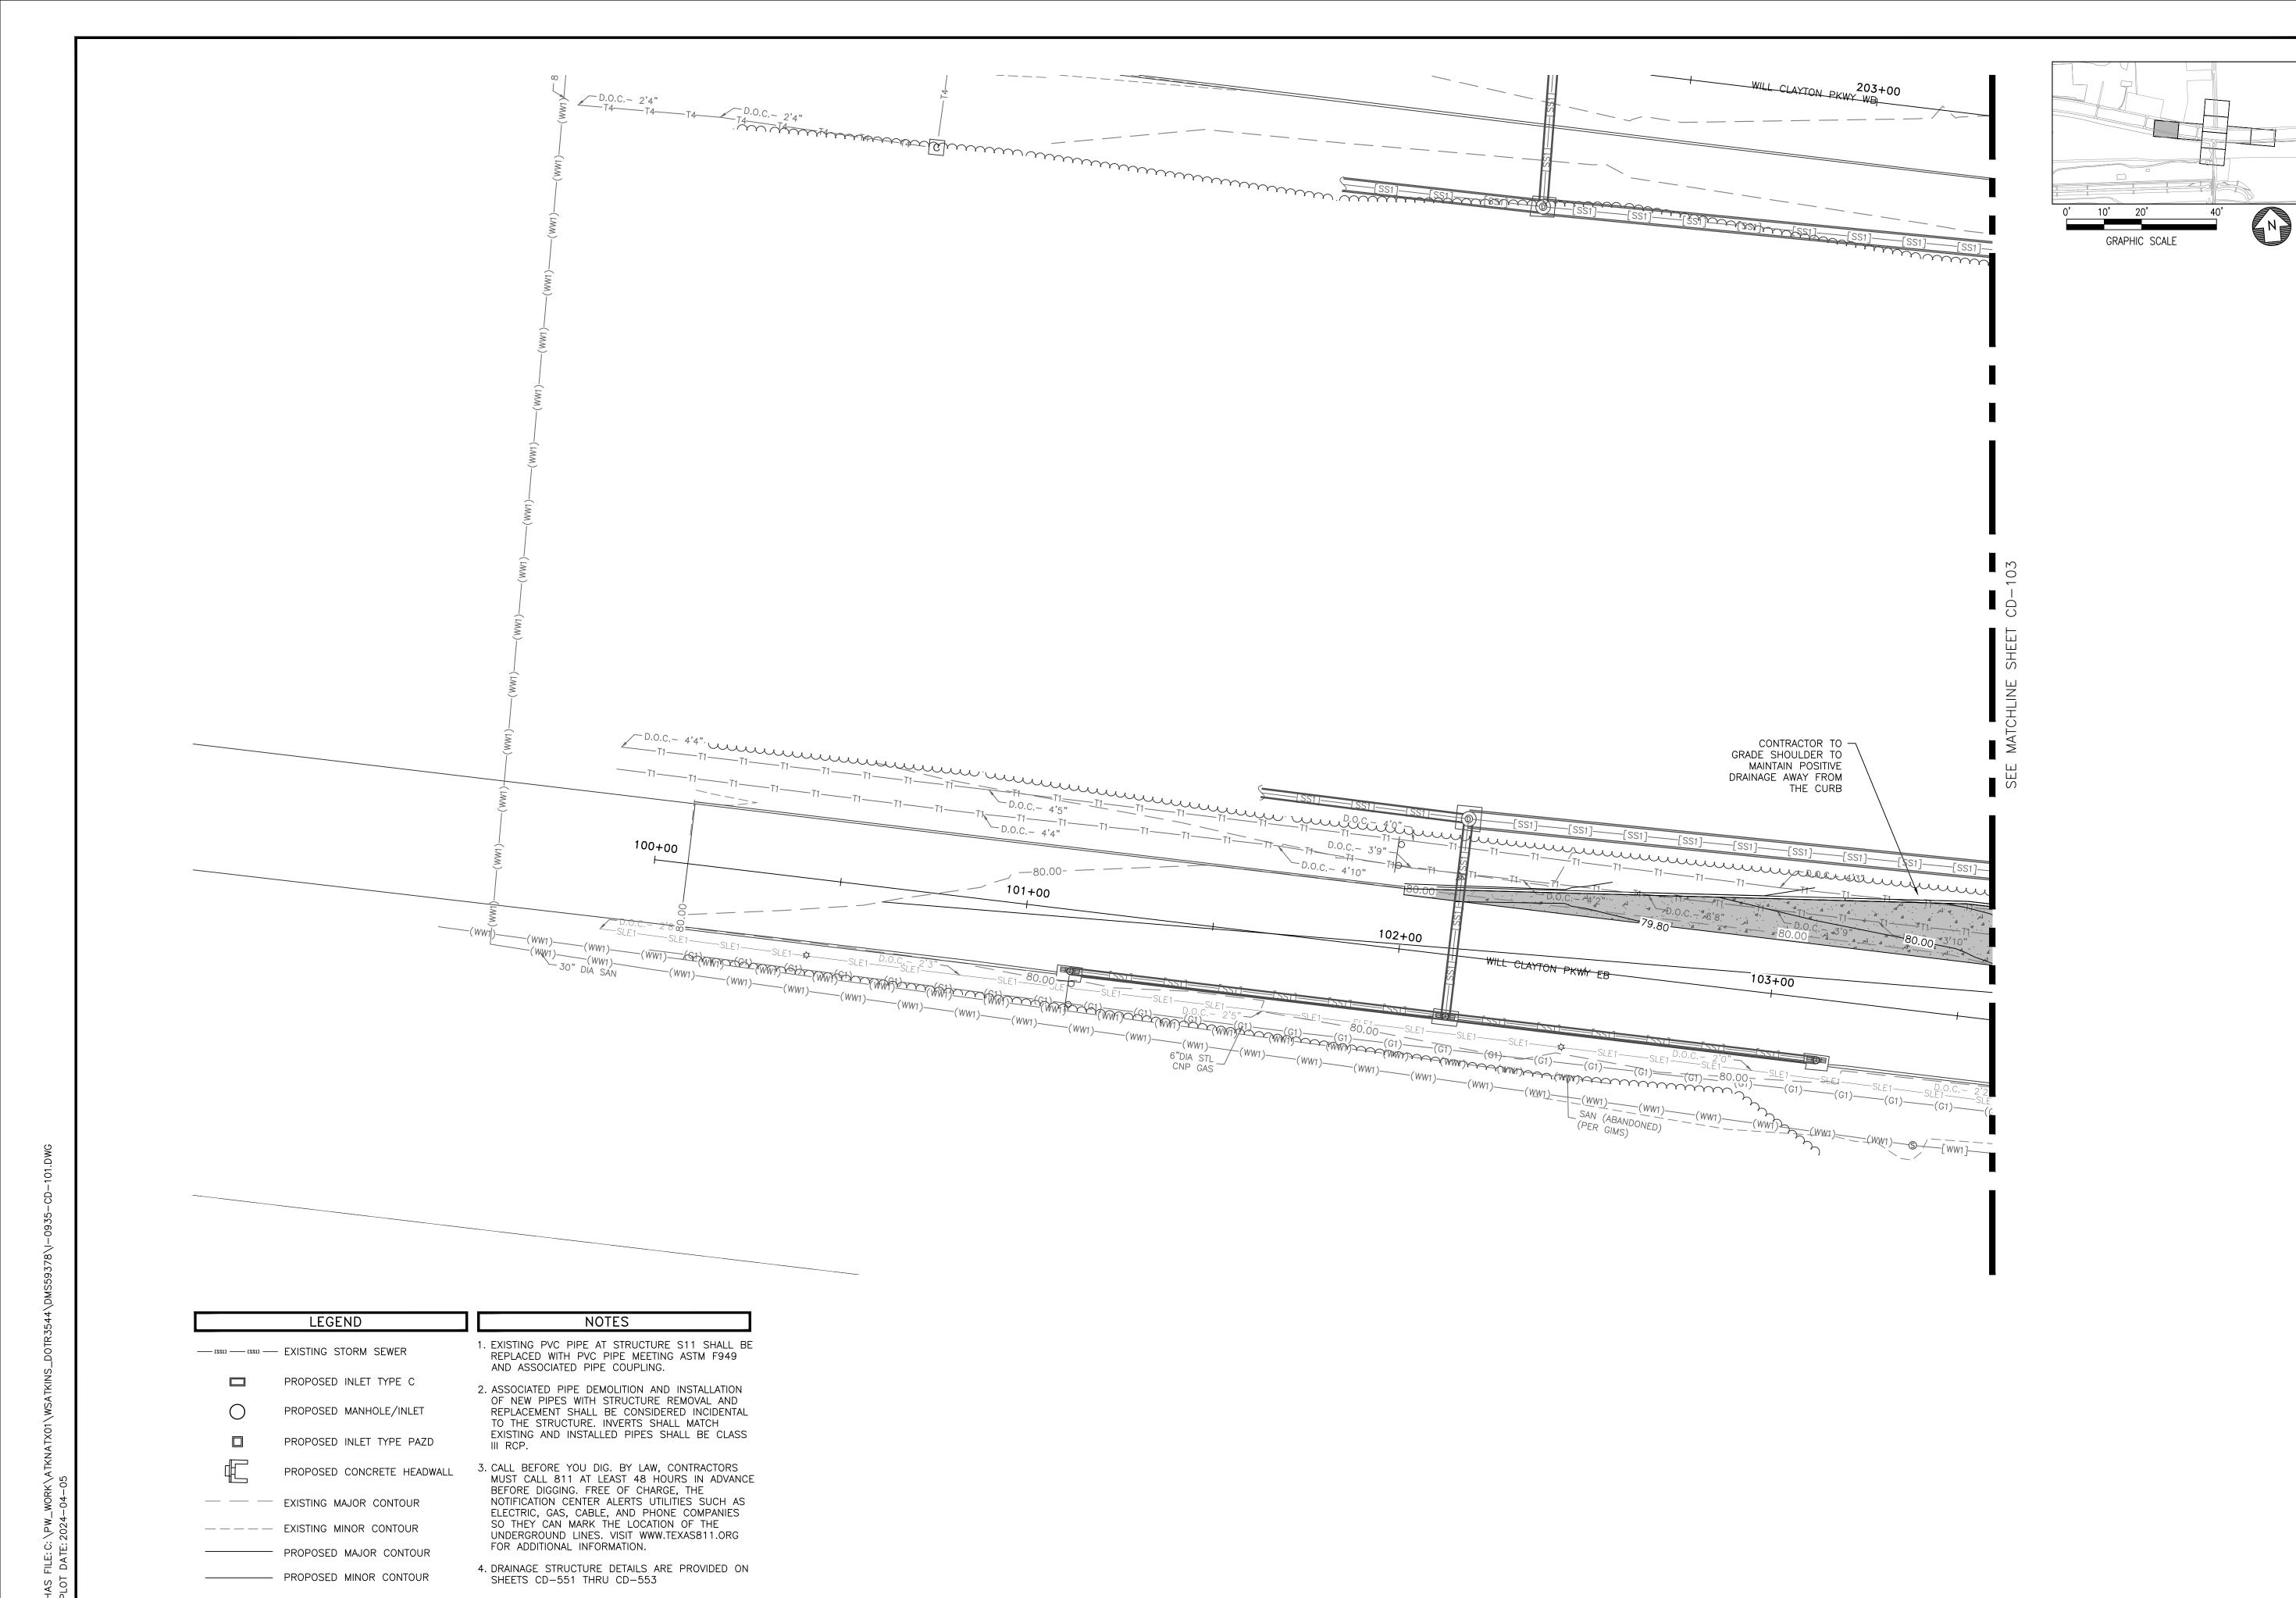
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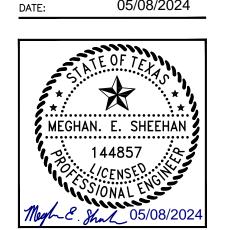


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REVISIONS NO. DESCRIPTION DATE BY

MES PROJECT MGR: DESIGNER: ALR ALR DRAWN BY: CHECK BY: PMWSCALE: 05/08/2024

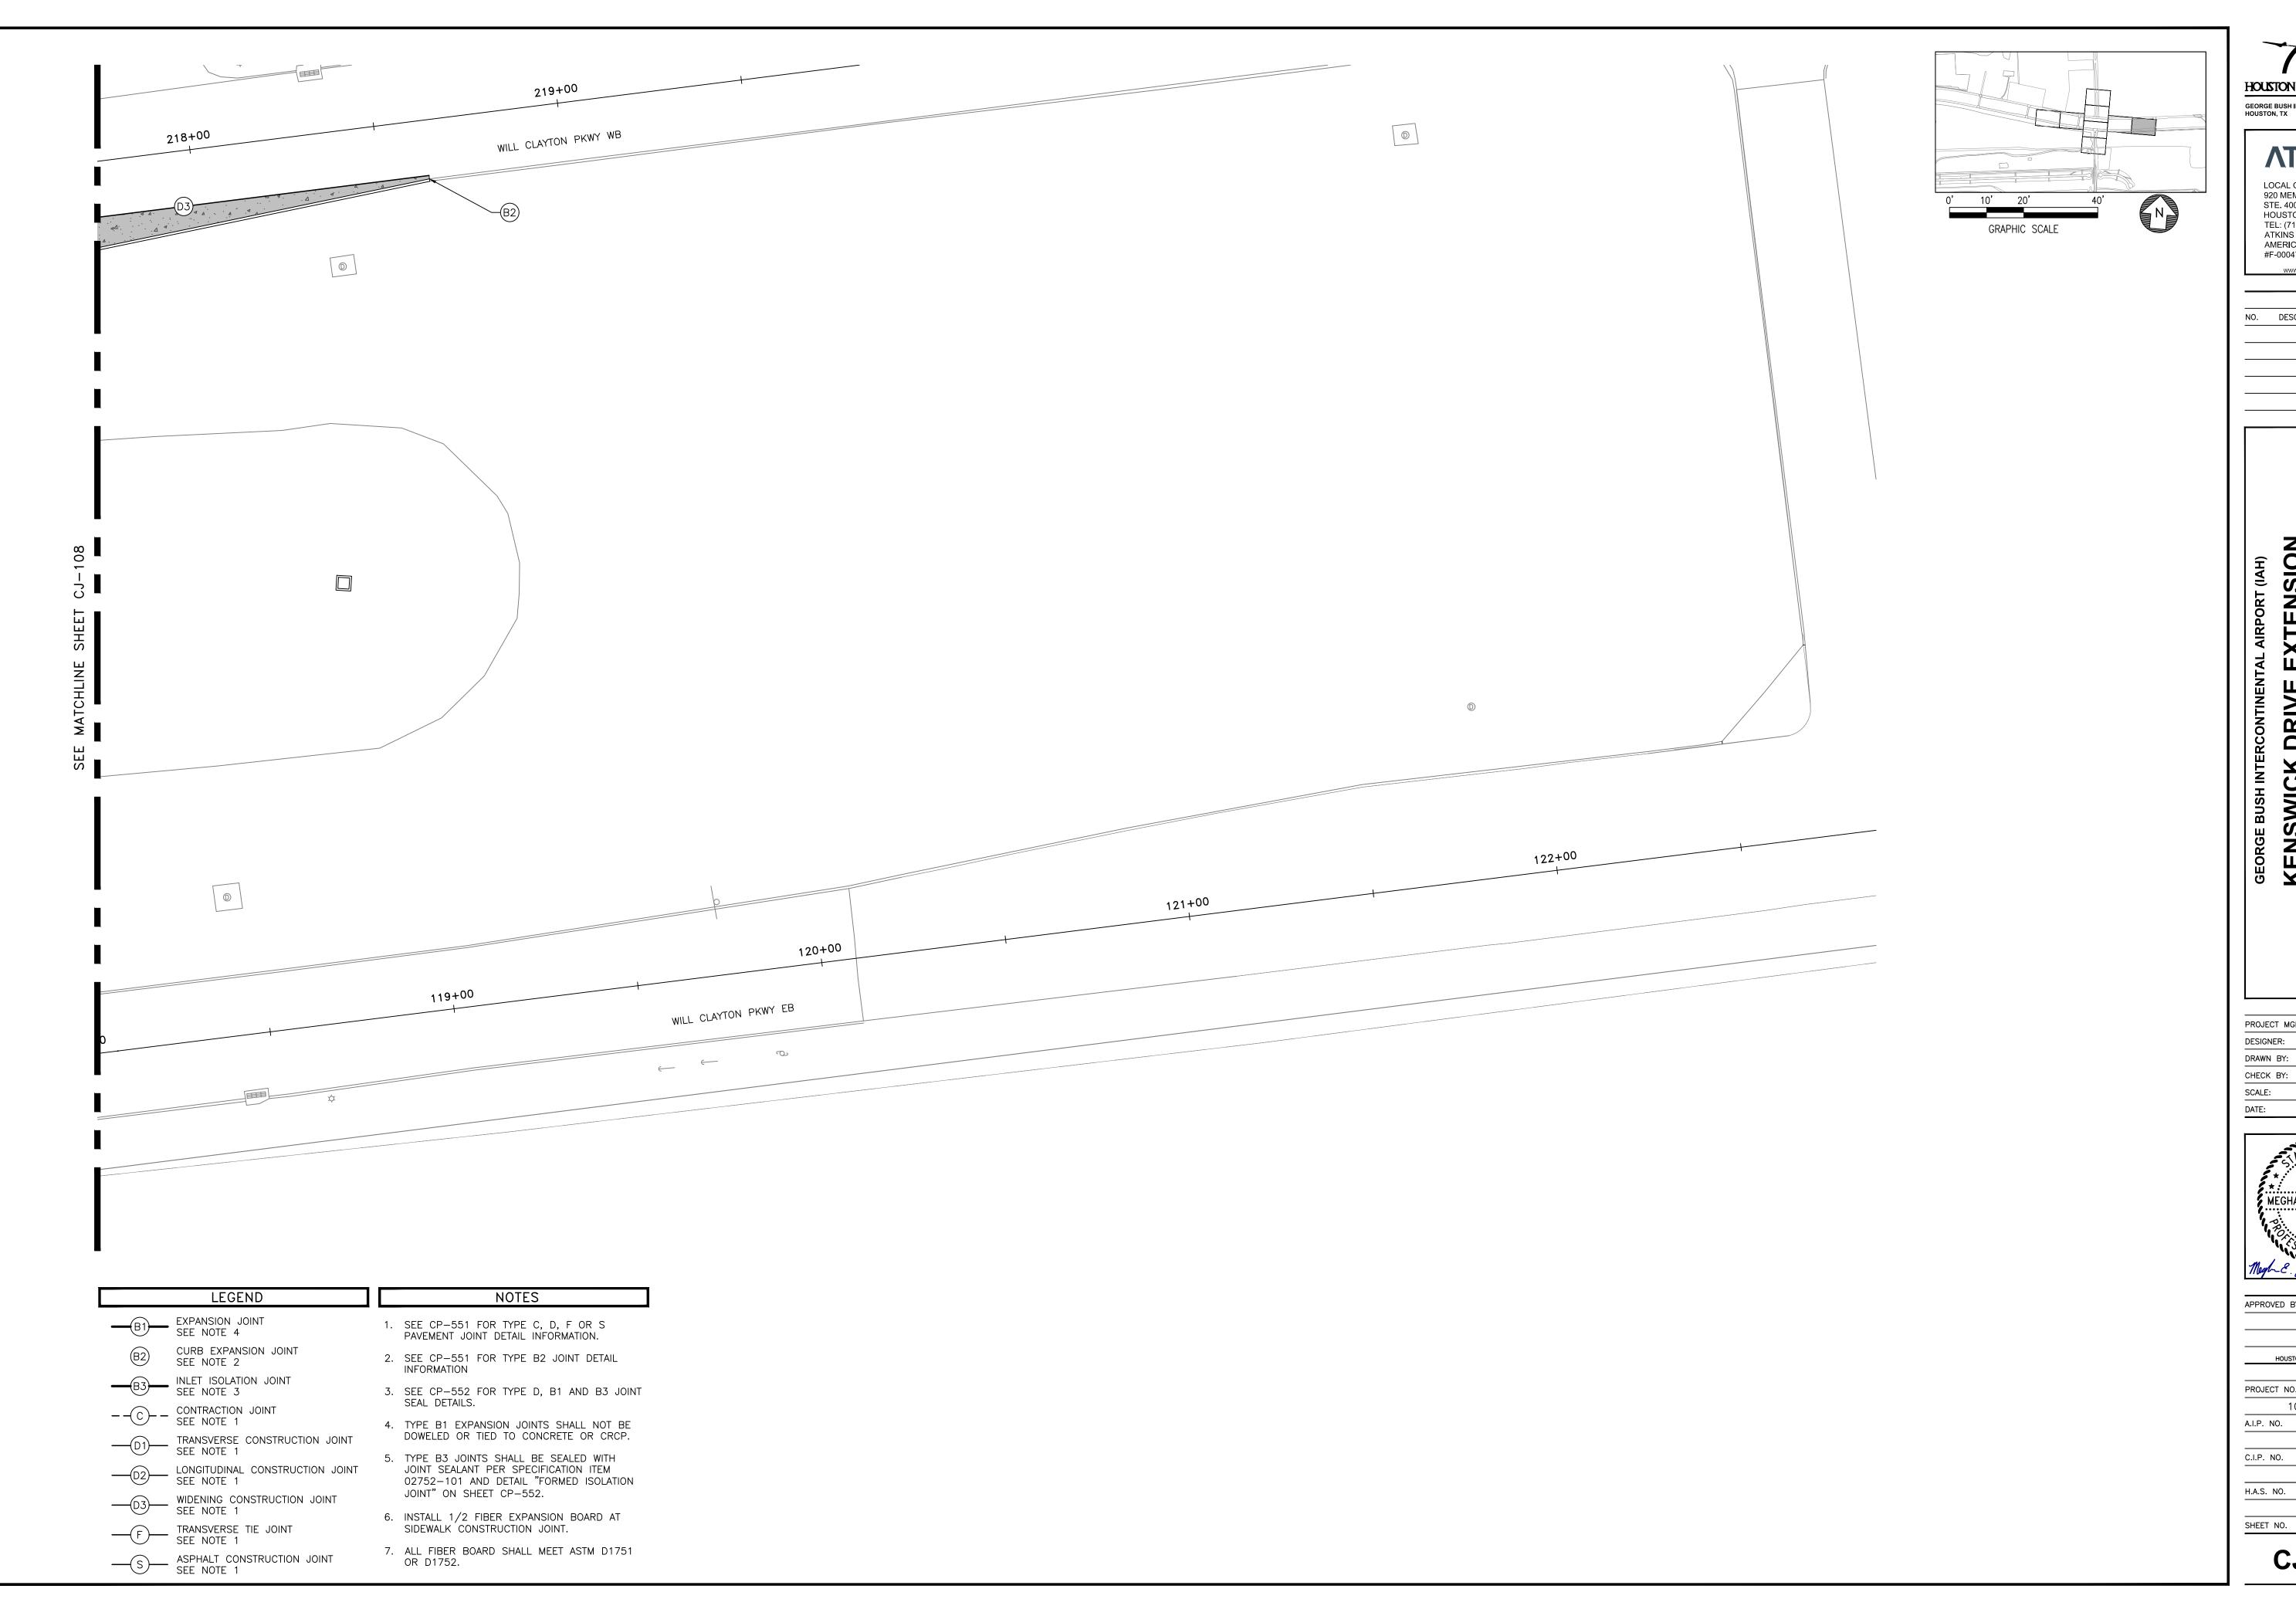

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PROJECT NO.


100072032 A.I.P. NO.

C.I.P. NO.

H.A.S. NO.

SHEET NO.

935

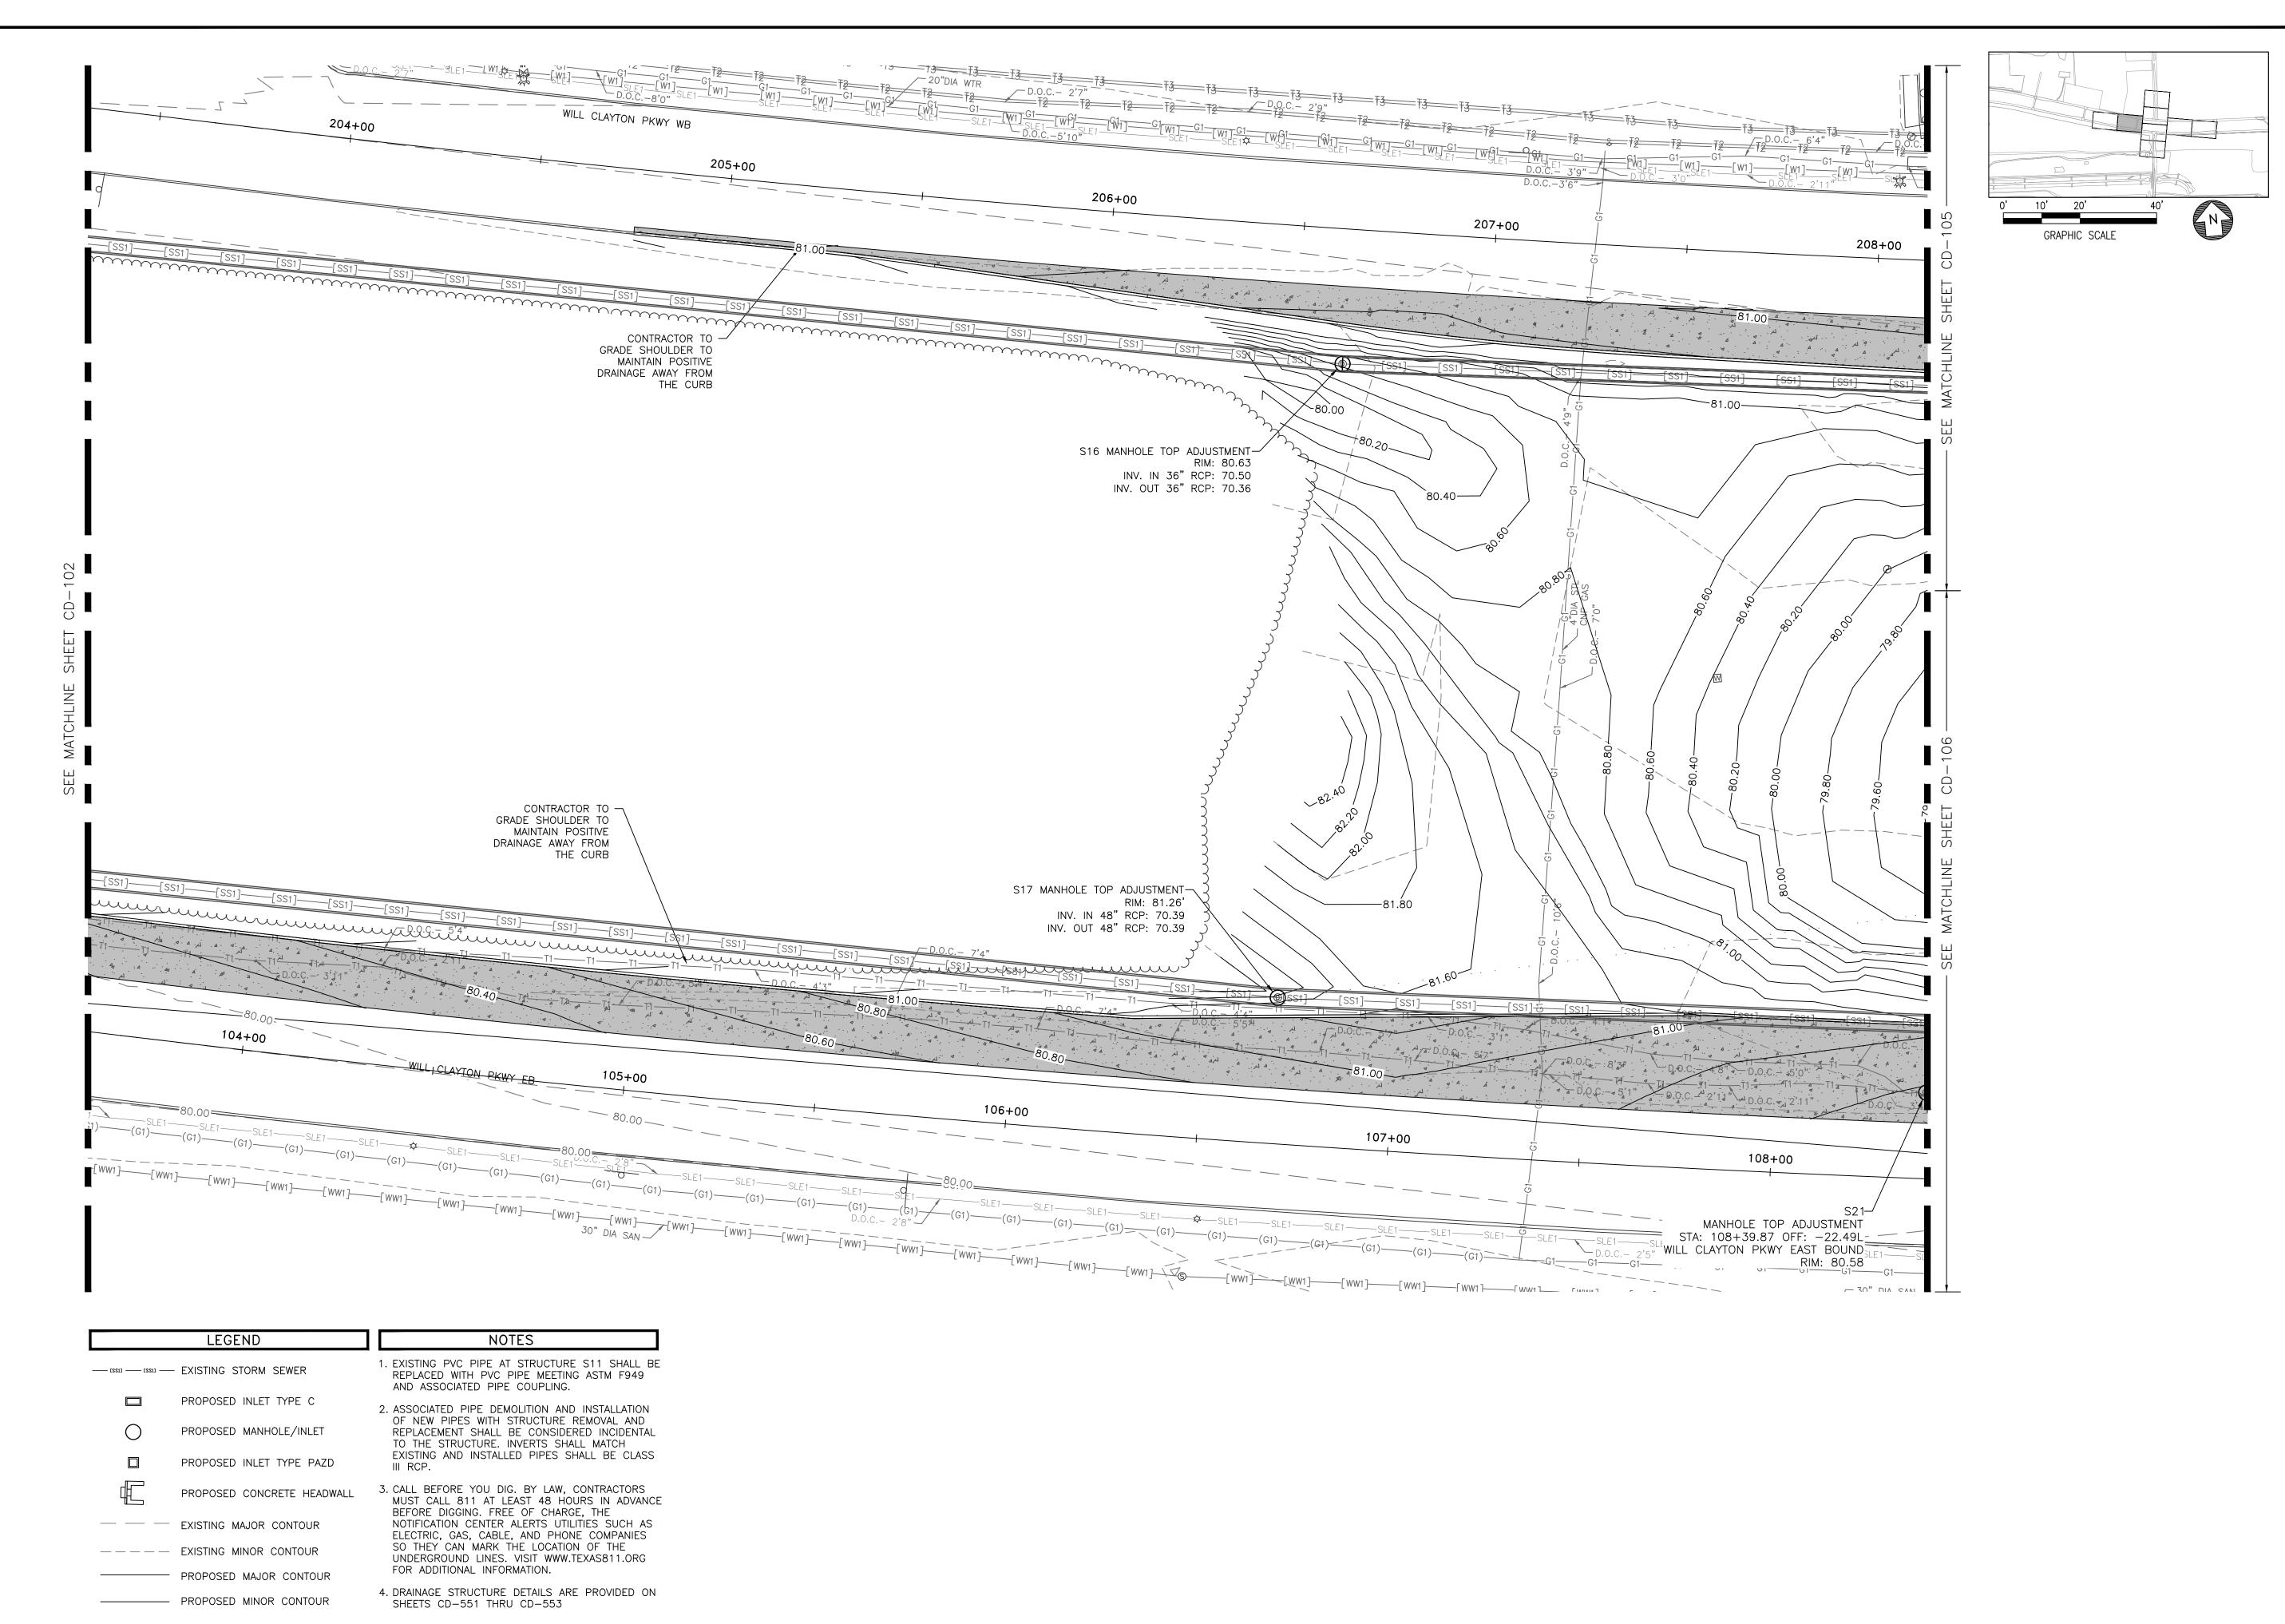

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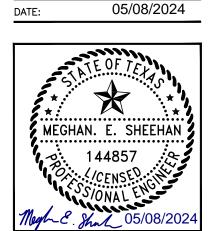
ATKINS NORTH AMERICA PE FIRM REG. #F-000474

REVISIONS NO. DESCRIPTION DATE BY

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APPROVED BY:

DESIGNER:

DRAWN BY:

CHECK BY:

SCALE:

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PROJECT NO. 100072032 A.I.P. NO.

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H.A.S. NO. 935

SHEET NO. **CD-103** 



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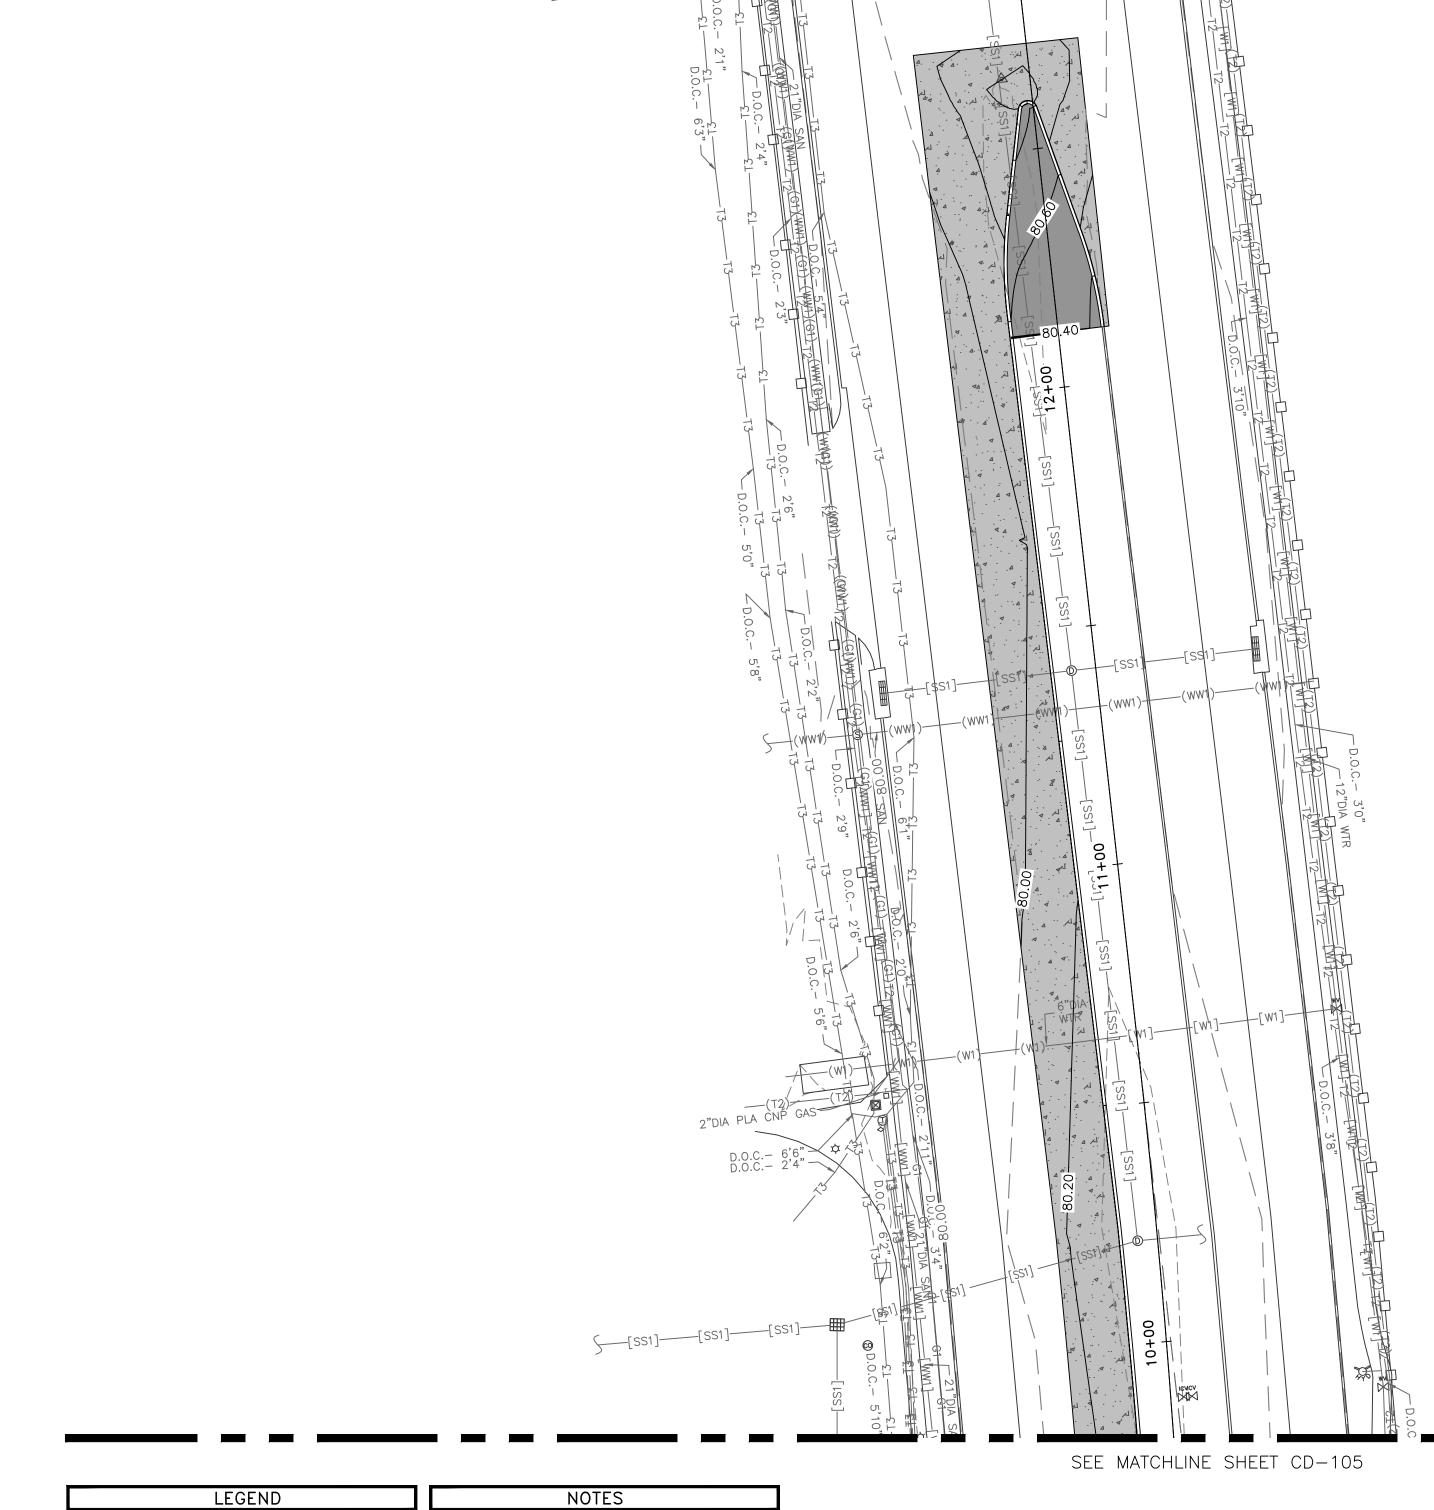
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SHEET NO.

H.A.S. NO.

**CD-104** 



— [551] — [551] — EXISTING STORM SEWER


PROPOSED INLET TYPE C PROPOSED MANHOLE/INLET

PROPOSED INLET TYPE PAZD



PROPOSED CONCRETE HEADWALL



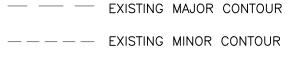

— — — — EXISTING MINOR CONTOUR

---- PROPOSED MINOR CONTOUR

PROPOSED MAJOR CONTOUR

EXISTING PVC PIPE AT STRUCTURE S11 SHALL BE REPLACED WITH PVC PIPE MEETING ASTM F949 AND ASSOCIATED PIPE COUPLING.

2. ASSOCIATED PIPE DEMOLITION AND INSTALLATION OF NEW PIPES WITH STRUCTURE REMOVAL AND REPLACEMENT SHALL BE CONSIDERED INCIDENTAL TO THE STRUCTURE. INVERTS SHALL MATCH EXISTING AND INSTALLED PIPES SHALL BE CLASS III RCP.

3. CALL BEFORE YOU DIG. BY LAW, CONTRACTORS MUST CALL 811 AT LEAST 48 HOURS IN ADVANCE BEFORE DIGGING. FREE OF CHARGE, THE NOTIFICATION CENTER ALERTS UTILITIES SUCH AS ELECTRIC, GAS, CABLE, AND PHONE COMPANIES SO THEY CAN MARK THE LOCATION OF THE UNDERGROUND LINES. VISIT WWW.TEXAS811.ORG FOR ADDITIONAL INFORMATION.

4. DRAINAGE STRUCTURE DETAILS ARE PROVIDED ON

**ATKINS** LOCAL OFFICE:


920 MEMORIAL CITY WAY. STE. 400 HOUSTON, TX 77024 TEL: (713) 576-8500 ATKINS NORTH AMERICA PE FIRM REG.

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C.I.P. NO.

H.A.S. NO. 935 SHEET NO.

**CD-105** 

PROPOSED MAJOR CONTOUR ——— PROPOSED MINOR CONTOUR

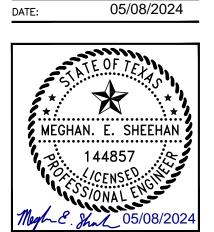4. DRAINAGE STRUCTURE DETAILS ARE PROVIDED ON SHEETS CD-551 THRU CD-553

1. EXISTING PVC PIPE AT STRUCTURE S11 SHALL BE — [SS1] — [SS1] — EXISTING STORM SEWER REPLACED WITH PVC PIPE MEETING ASTM F949 AND ASSOCIATED PIPE COUPLING. PROPOSED INLET TYPE C 2. ASSOCIATED PIPE DEMOLITION AND INSTALLATION OF NEW PIPES WITH STRUCTURE REMOVAL AND PROPOSED MANHOLE/INLET REPLACEMENT SHALL BE CONSIDERED INCIDENTAL TO THE STRUCTURE. INVERTS SHALL MATCH EXISTING AND INSTALLED PIPES SHALL BE CLASS PROPOSED INLET TYPE PAZD III RCP. 3. CALL BEFORE YOU DIG. BY LAW, CONTRACTORS PROPOSED CONCRETE HEADWALL MUST CALL 811 AT LEAST 48 HOURS IN ADVANCE BEFORE DIGGING. FREE OF CHARGE, THE NOTIFICATION CENTER ALERTS UTILITIES SUCH AS — — EXISTING MAJOR CONTOUR ELECTRIC, GAS, CABLE, AND PHONE COMPANIES SO THEY CAN MARK THE LOCATION OF THE — — — — EXISTING MINOR CONTOUR UNDERGROUND LINES. VISIT WWW.TEXAS811.ORG FOR ADDITIONAL INFORMATION. PROPOSED MAJOR CONTOUR

----- PROPOSED MINOR CONTOUR

4. DRAINAGE STRUCTURE DETAILS ARE PROVIDED ON

SHEETS CD-551 THRU CD-553

0' 10' 20' 40'
GRAPHIC SCALE

HOUSTON AIRPORT SYSTEM
GEORGE BUSH INTERCONTINENTAL AIRPORT /
HOUSTON, TX

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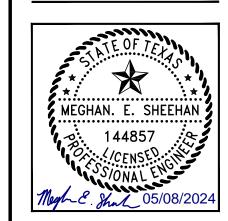
DESIGNER: ALR

DRAWN BY: ALR

CHECK BY: PMW

SCALE:

DATE: 05/08/2024



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DIRECTOR HOUSTON AIRPORT SYSTEM


PROJECT NO. 100072032

A.I.P. NO.

C.I.P. NO.

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SHEET NO.

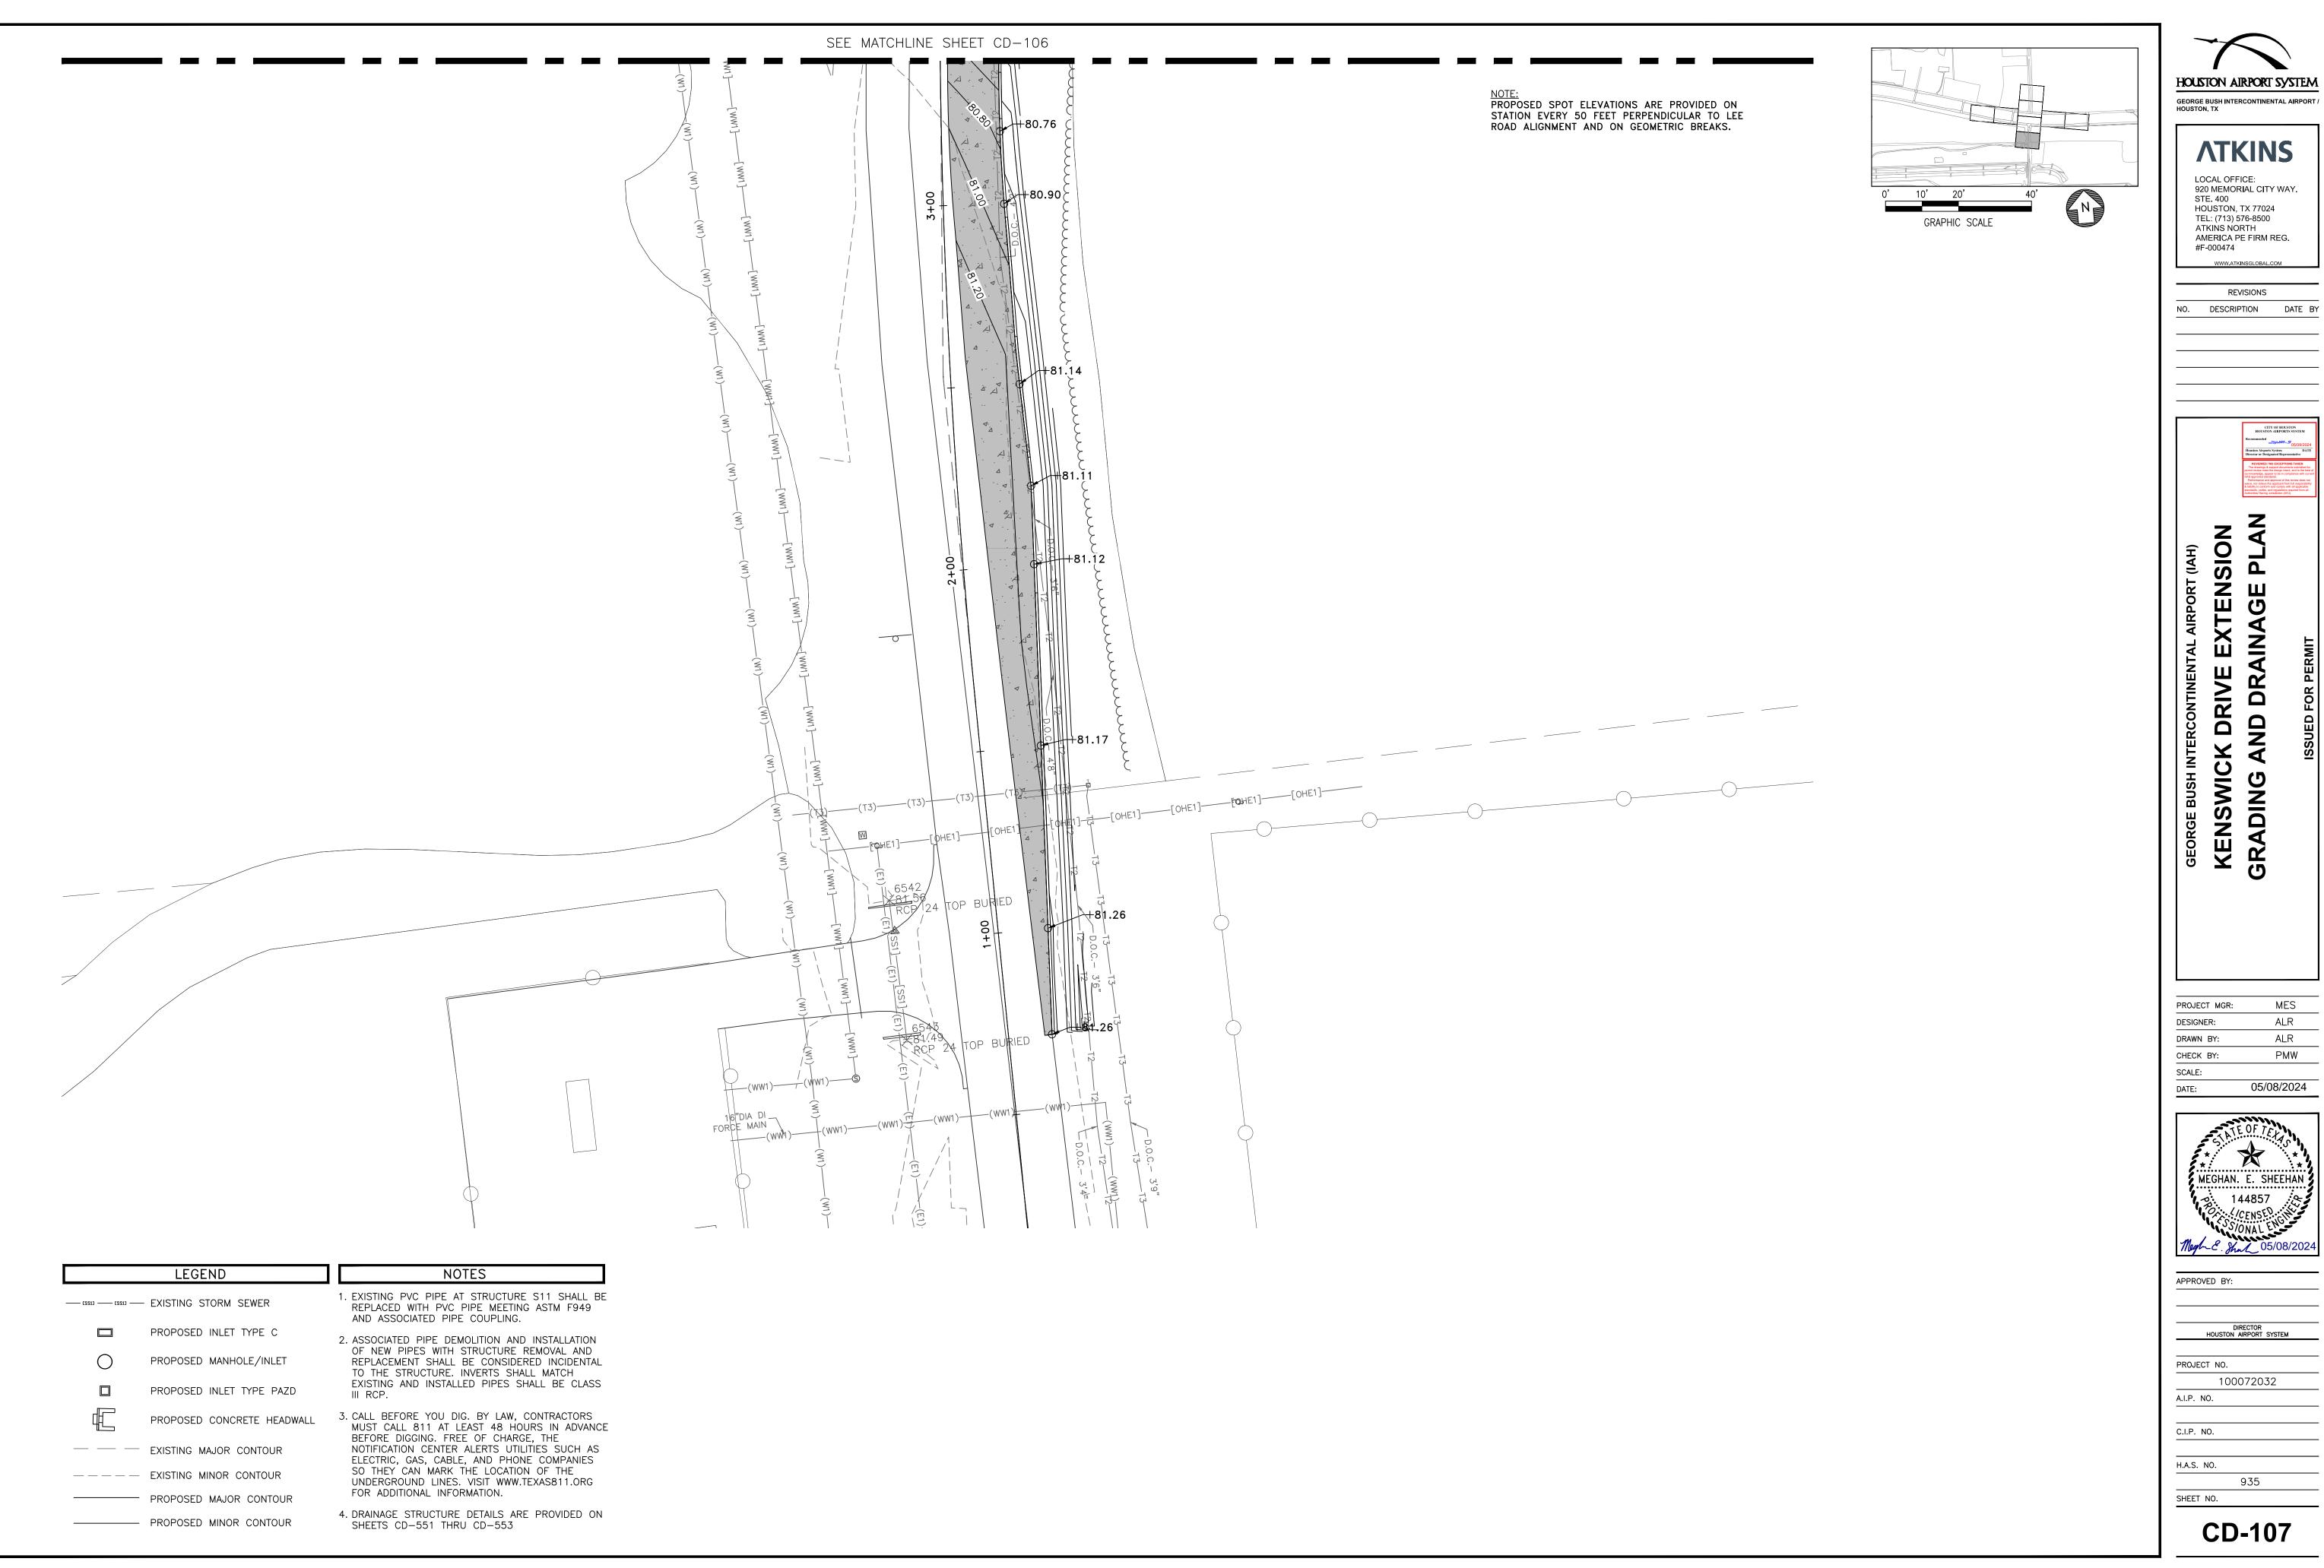


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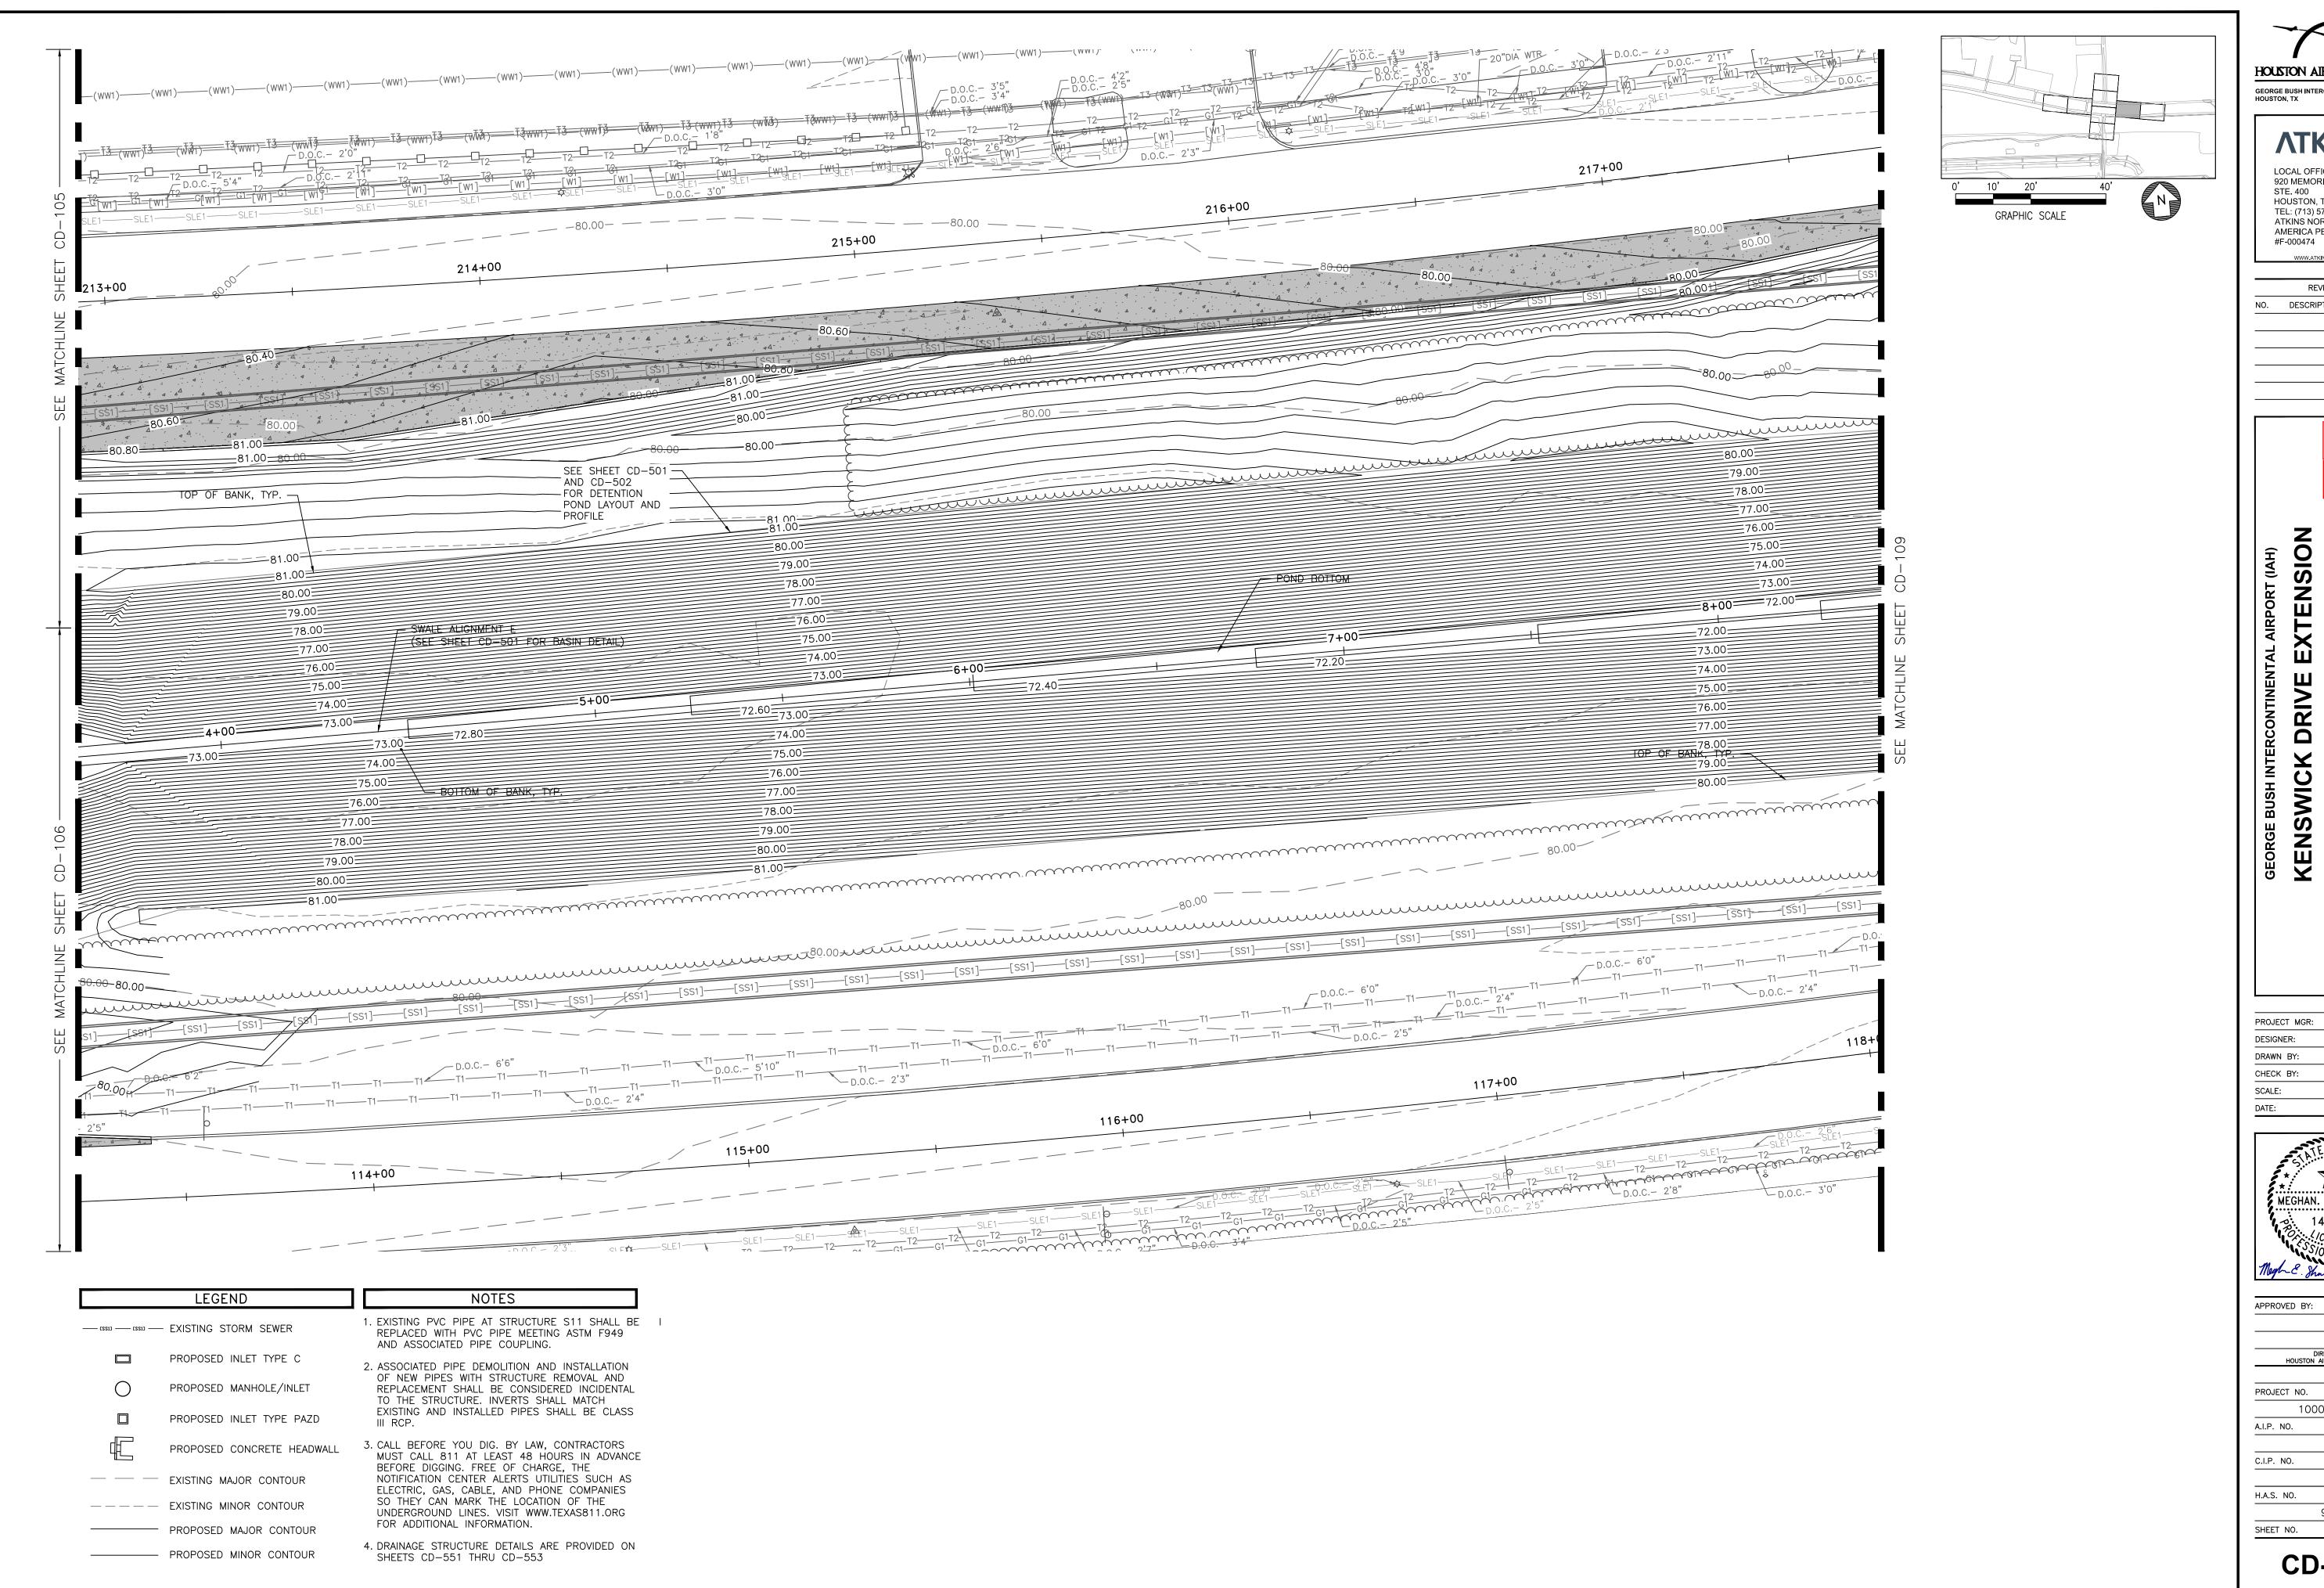
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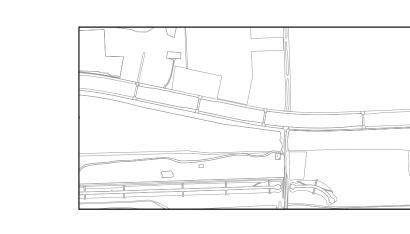
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PROJECT NO.

100072032

935 SHEET NO.



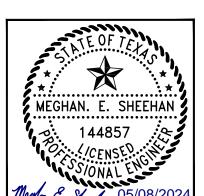

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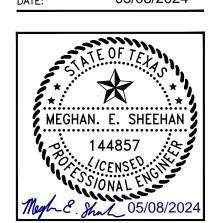
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PROJECT NO. 100072032

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H.A.S. NO.

SHEET NO. CD-110

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1 PIPE ALIGNMENT A — NORTH MEDIAN CD-201 SCALE: AS SHOWN

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2+50

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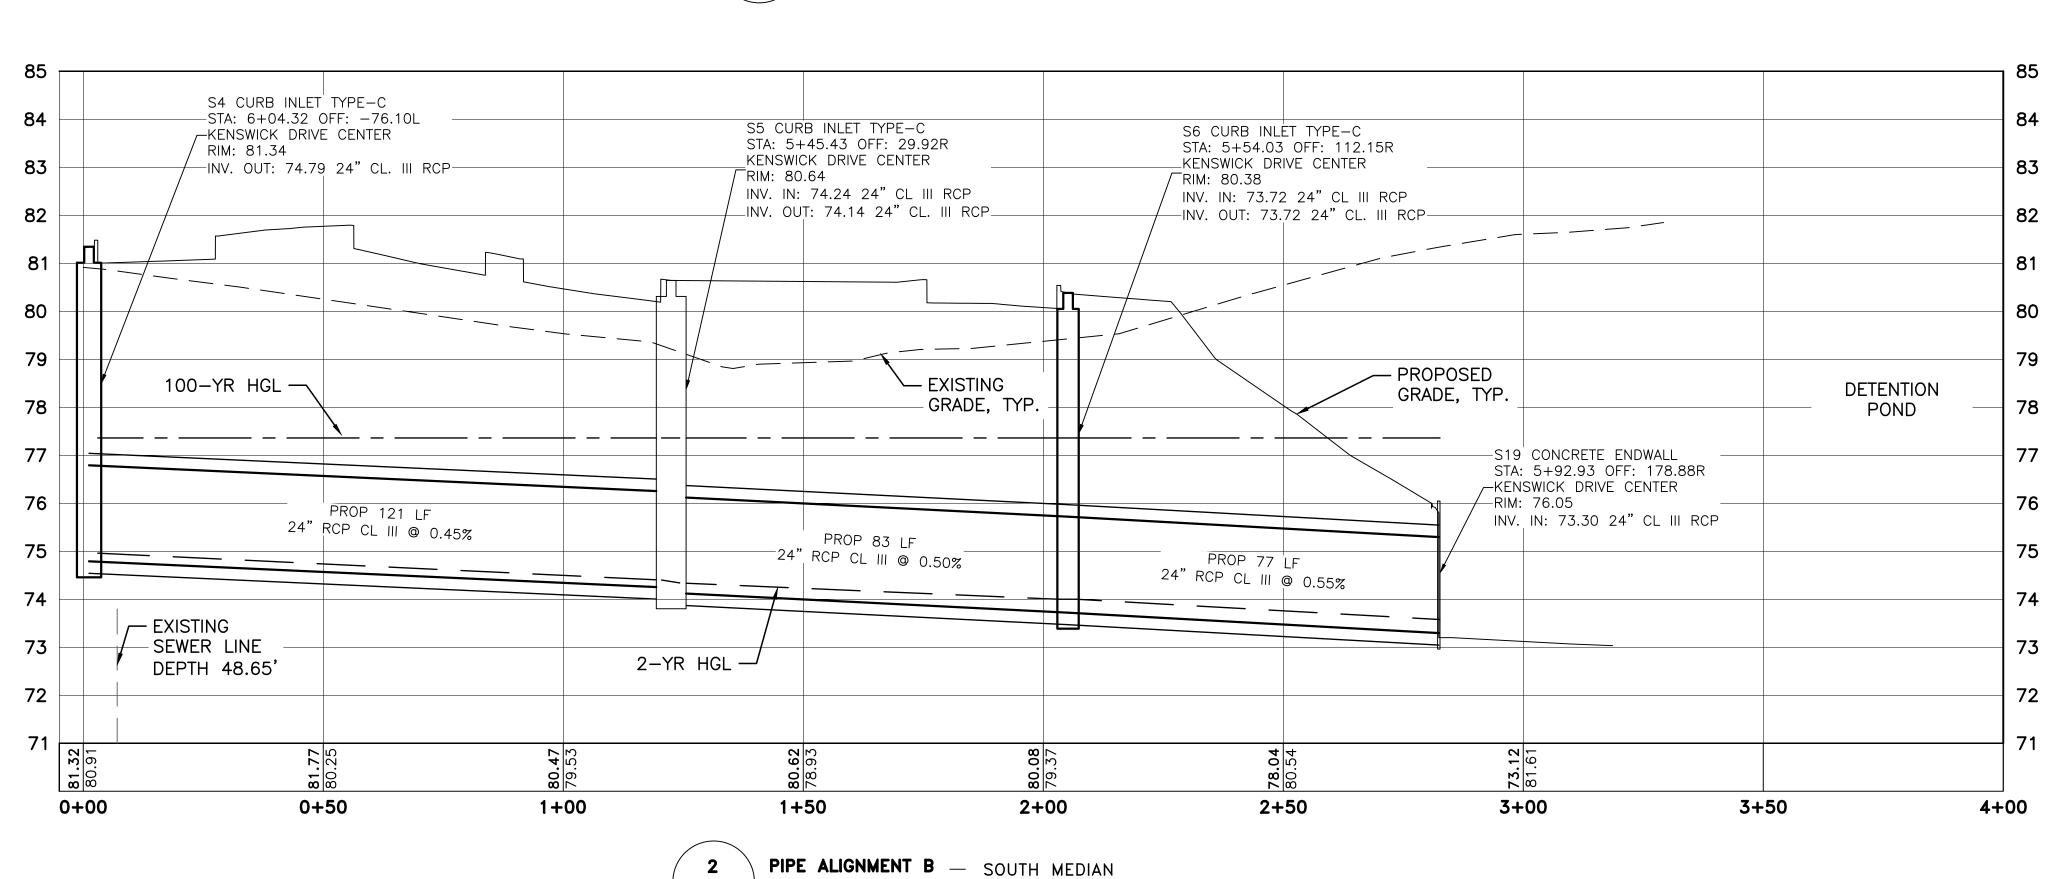
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CD-201/ SCALE: AS SHOWN

0+50

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1+00





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AMERICA PE FIRM REG.
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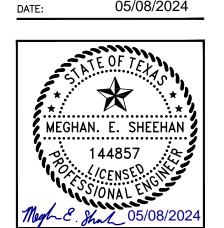
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SCALE:

DATE: 05/08/2024



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PROJECT MGR: MES

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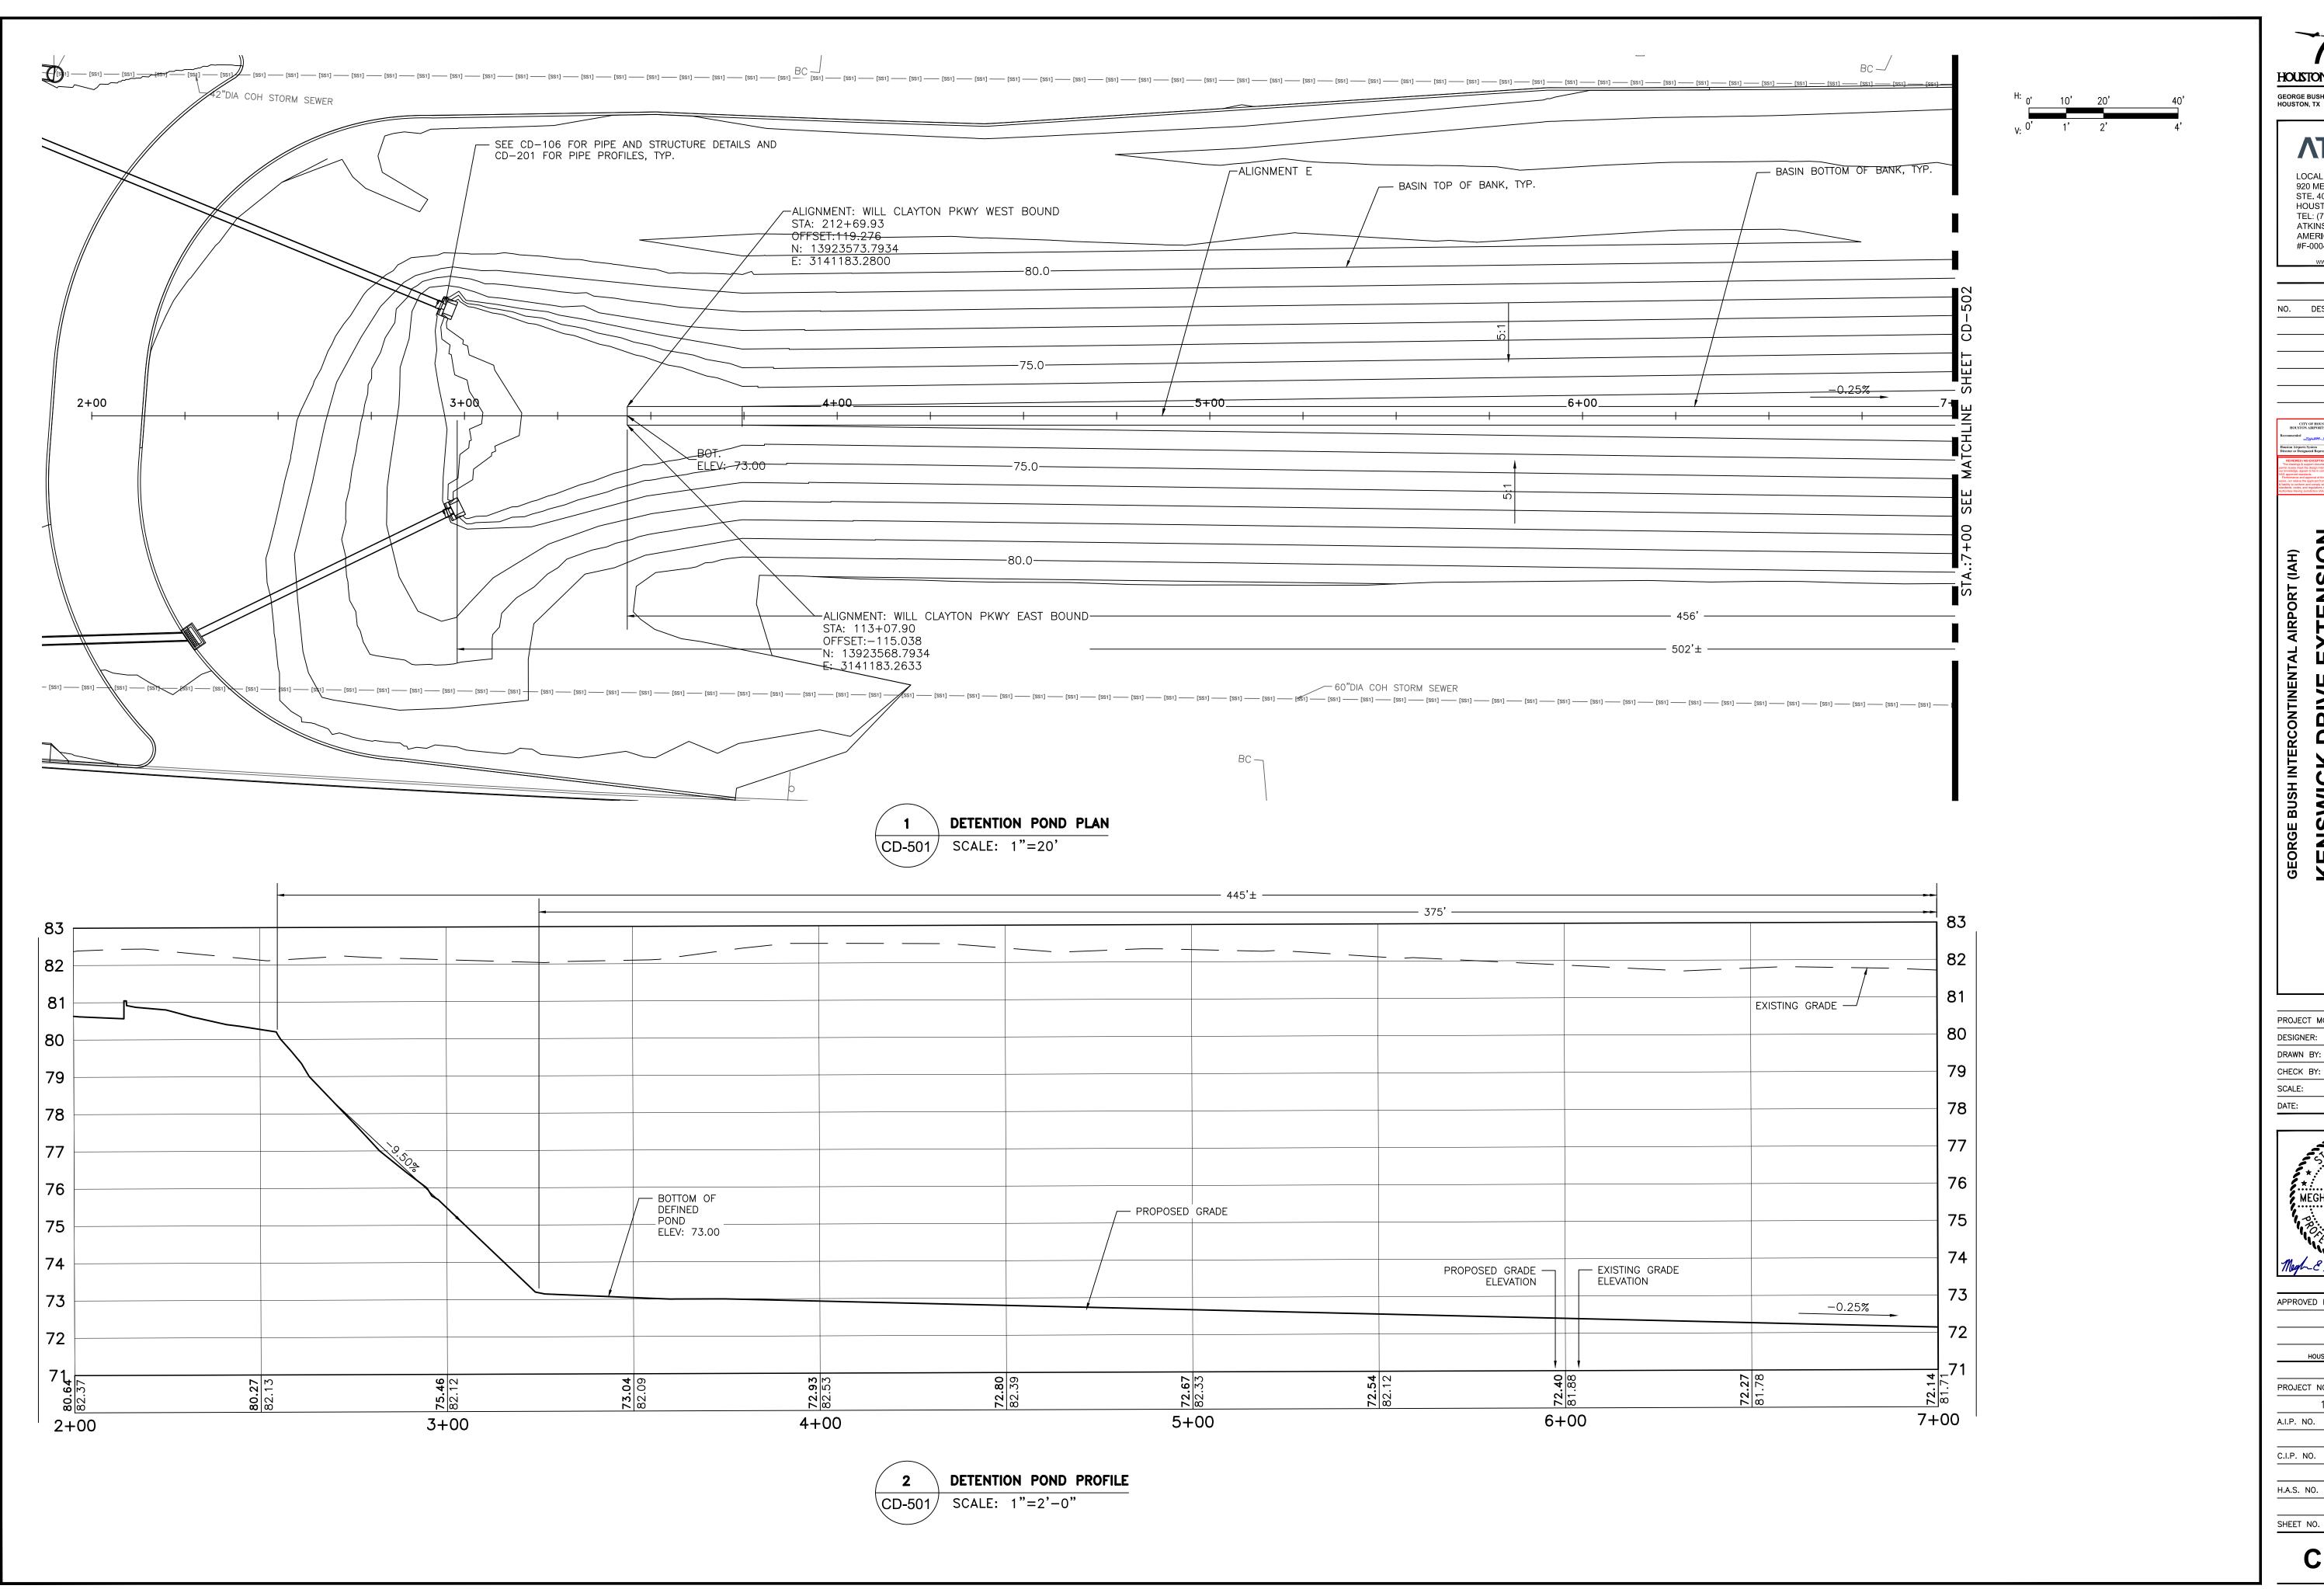
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SHEET NO.





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PROJECT NO. 100072032 A.I.P. NO.

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935 SHEET NO.

HOUSTON AIRPORT SYSTEM GEORGE BUSH INTERCONTINENTAL AIRPORT

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CITY OF HOUSTON HOUSTON AIRPORTS SYSTEM Houston Airports System
Director or Designated Representative

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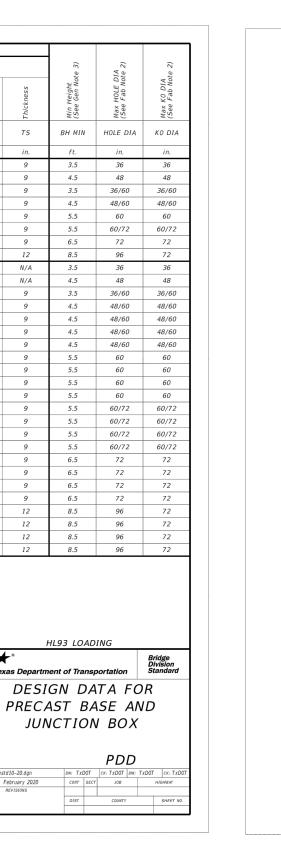
DIRECTOR HOUSTON AIRPORT SYSTEM

PROJECT NO.

100072032

SHEET NO.

(3) VERTICAL REBAR IN BASE & RISERS - C #4 @ 2" O.C. EACH CORNER



Ashort Along BS Bshort Blong W RWSxRWL Or ID Dshort Dlong TS

** Unless otherwise indicated.

FABRICATION NOTES:

1. Maximum spacing of reinforcement is 8".

2. At manufacturer's option, provide cast or cored holes or thin wall panels (KO) to the maximum diameter shown for each. When no penetration is required, it is acceptable to provide a wall with no sectional reduction.


GENERAL NOTES:


1. Precast Junction Box consists of base slab, base unit, risers (as required), and below grade slab. See sheet PJB for details.

2. Precast Base consists of base slab, base unit, risers (as required), reducing slab (as required), and reduced risers (as required). See sheet PB for details.

3. Min Height shown is for stock base units. Use stock base units whenever practical. Smaller height base units can be used in special installation circumstances, when noted elsewhere in the plans. Absolute minimum height of base units is 2'-6".

GENERAL NOTES:

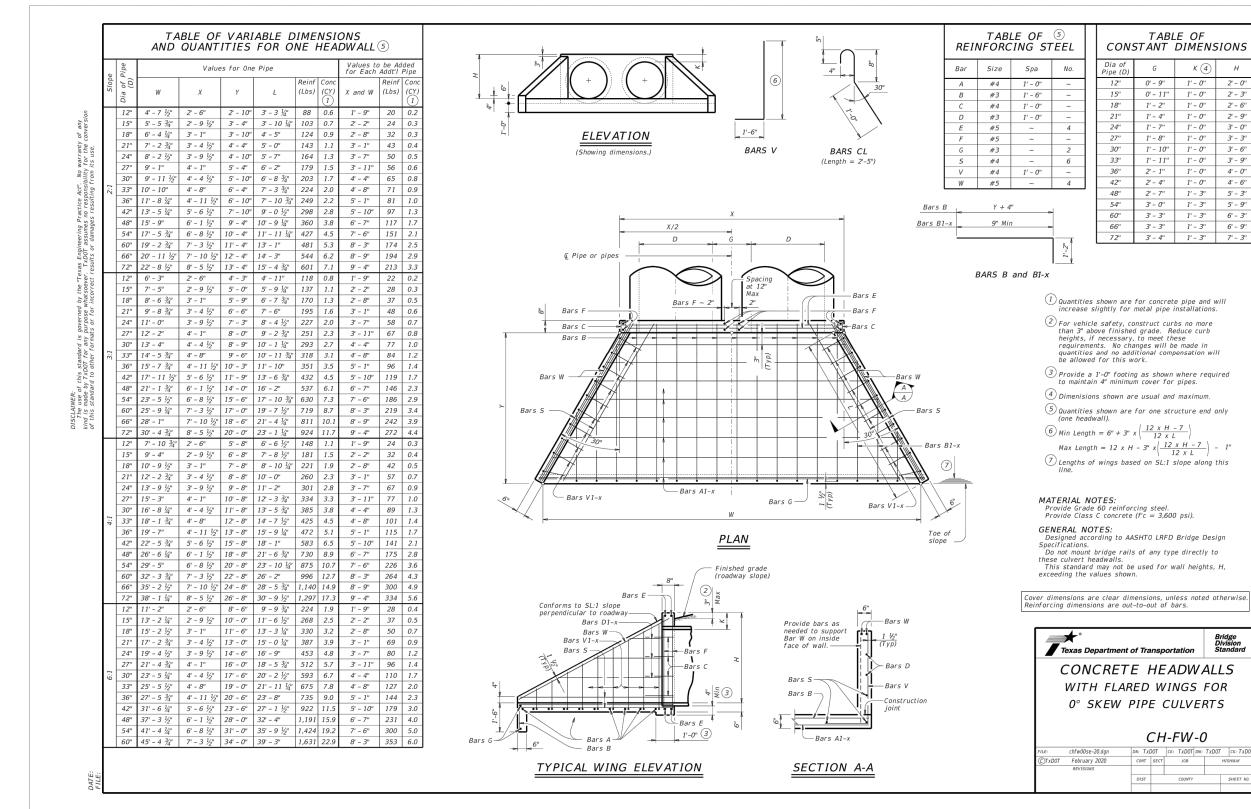

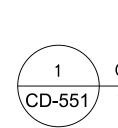

CONCRETE ENDWALL WITH U-TYPE WINGS FOR PIPE CULVERTS

SCALE: NONE


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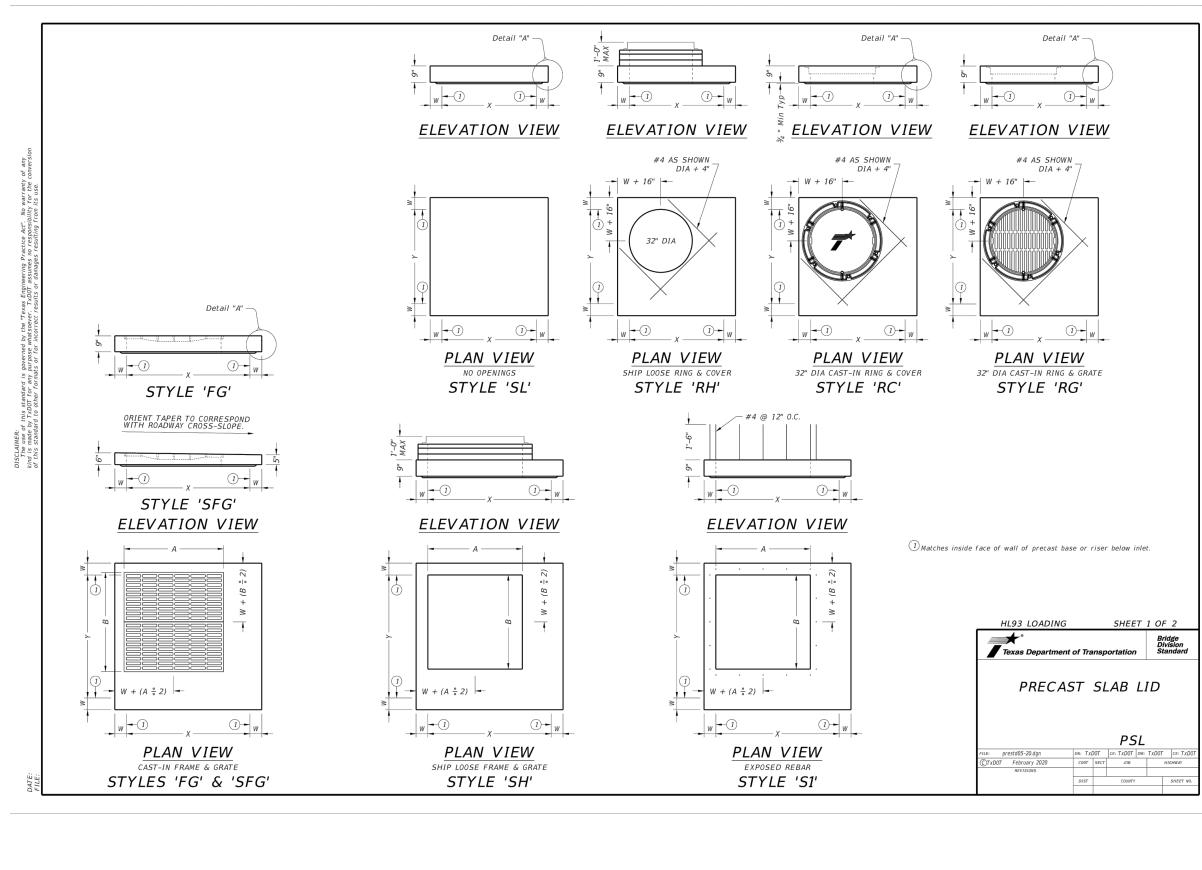
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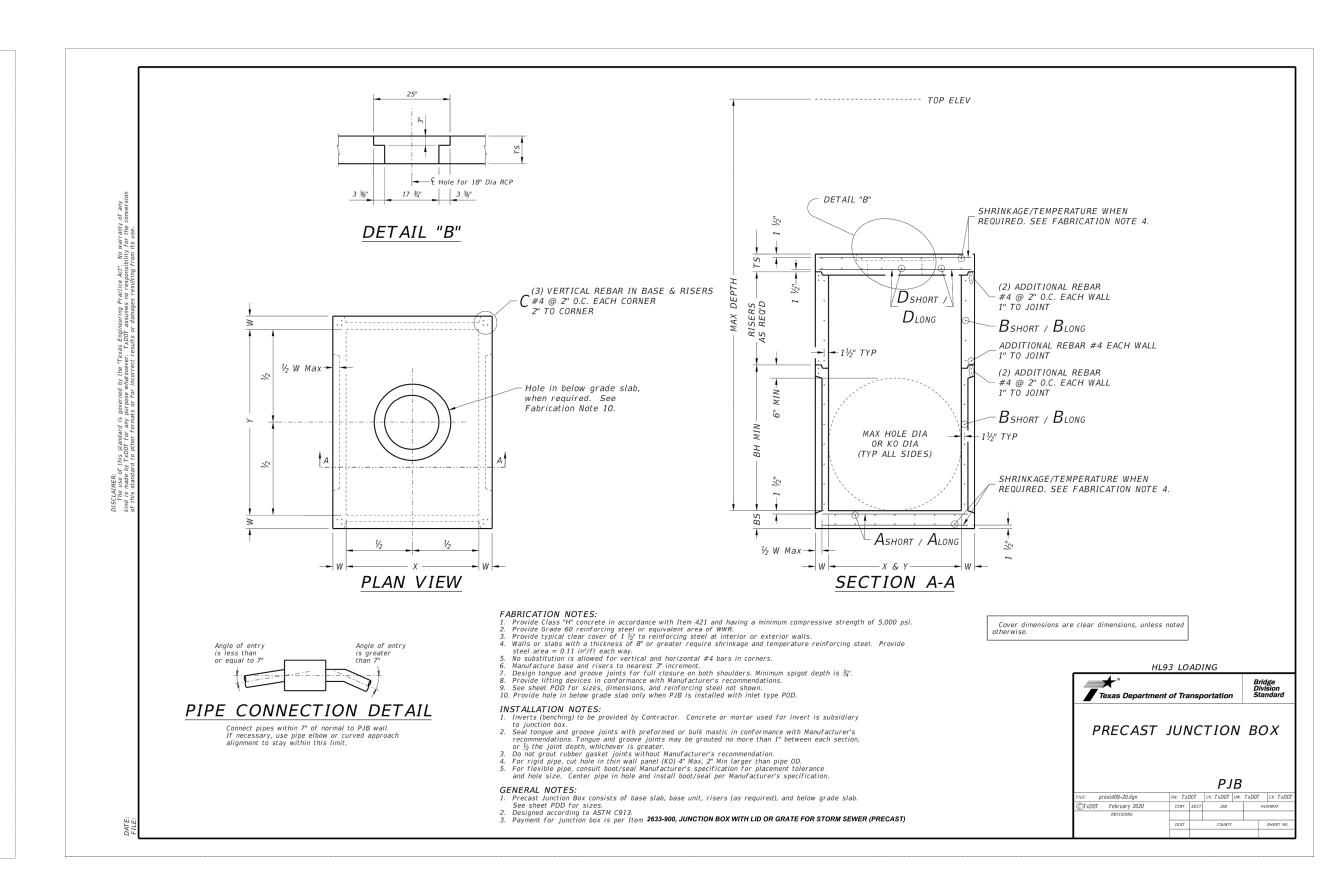
CD-551


Ashort Along BS Bshort Blong W RWSxRWL Dshort Dlong TS


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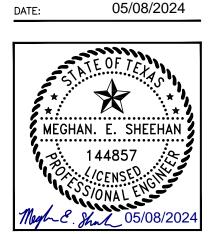
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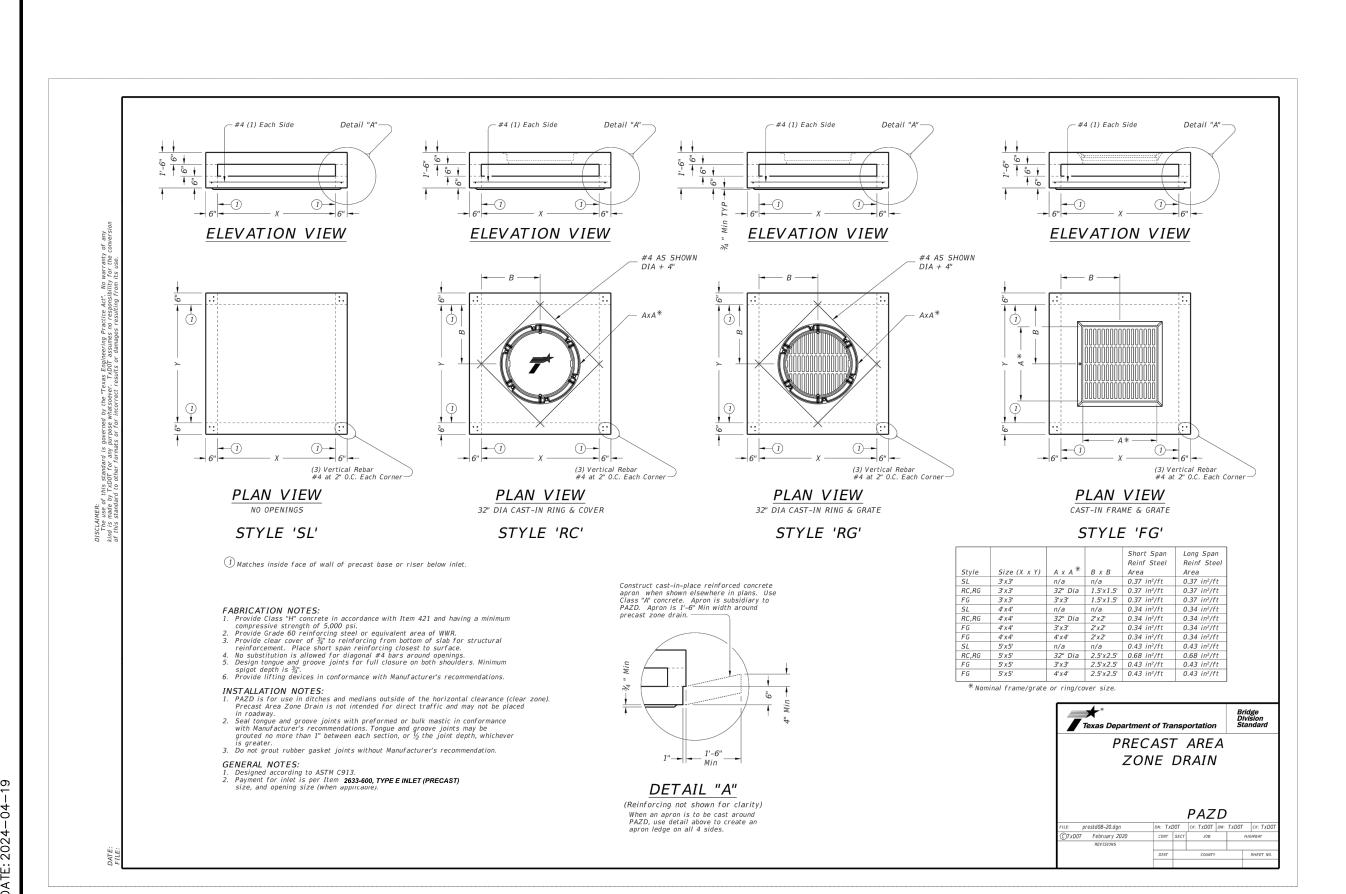
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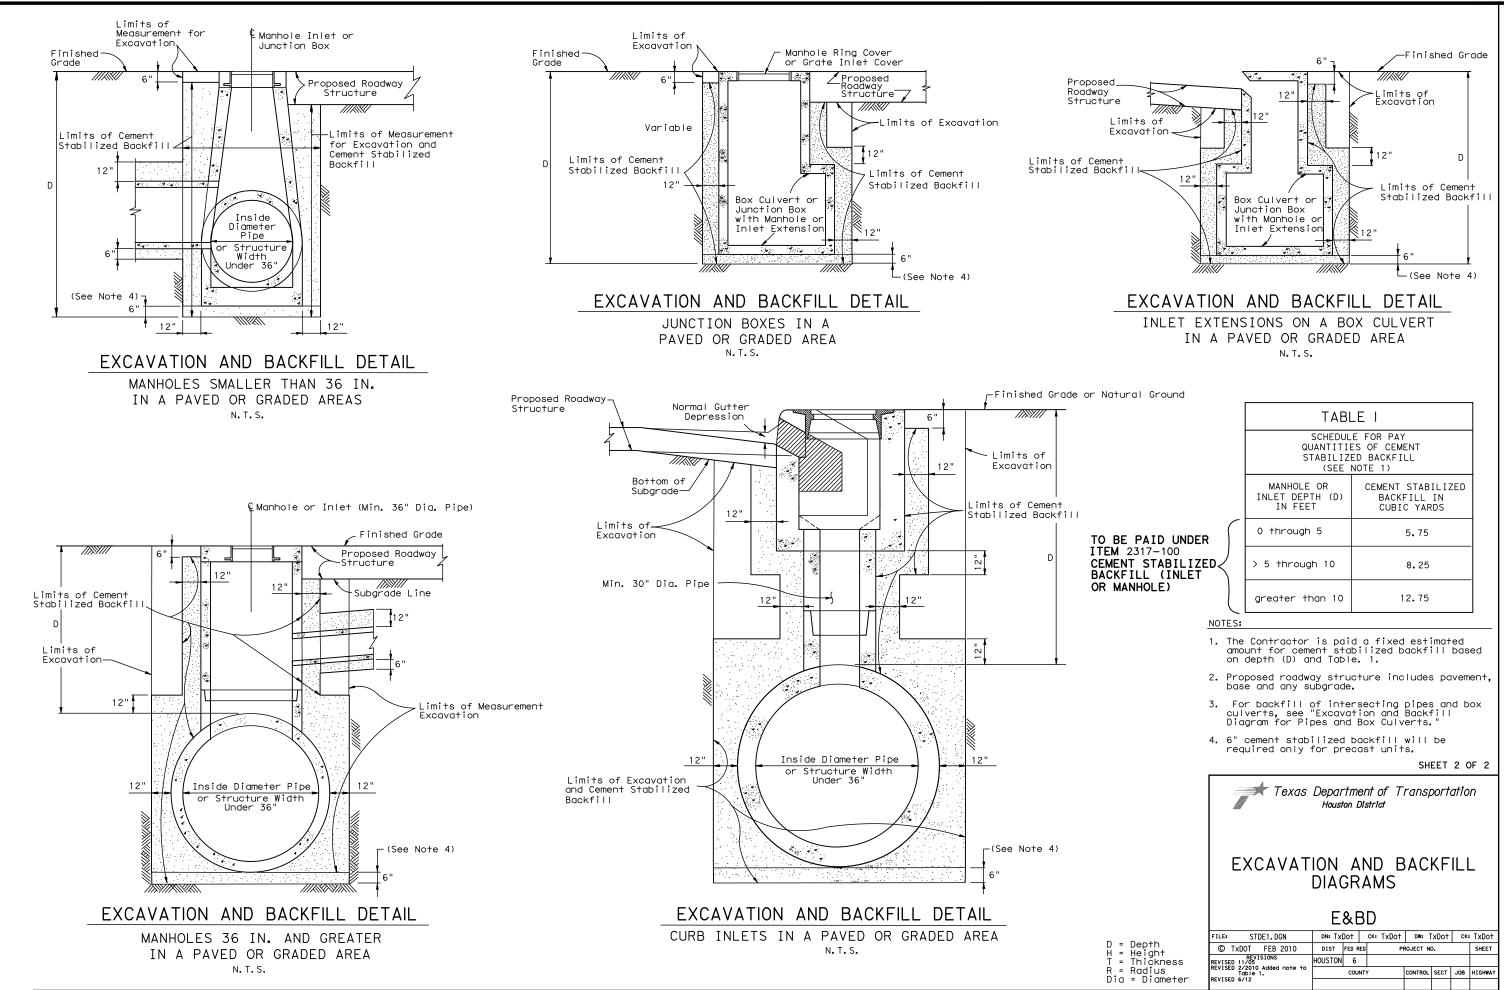
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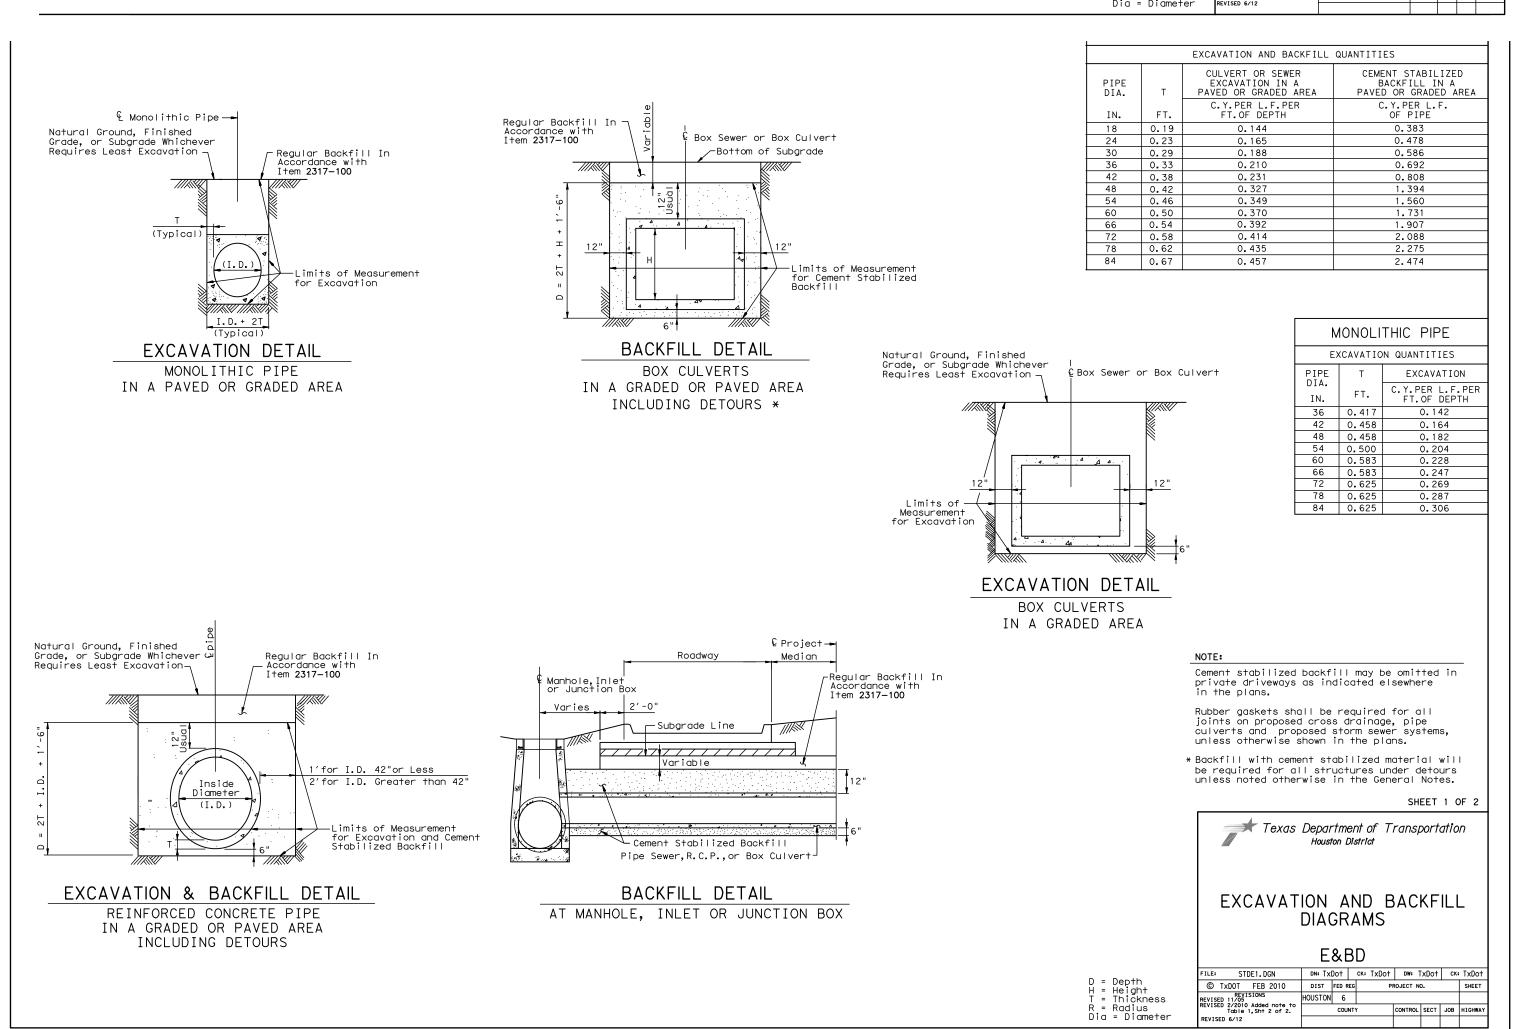
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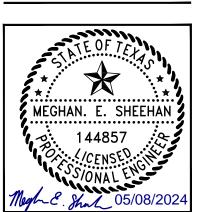
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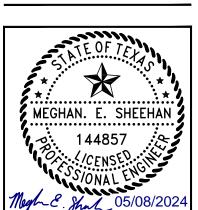
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PROJECT NO. 100072032

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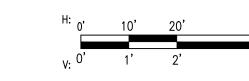
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PROJECT NO.

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H.A.S. NO.

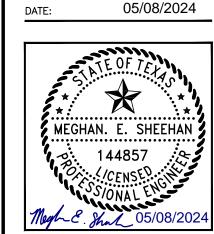SHEET NO. **CD-602** 

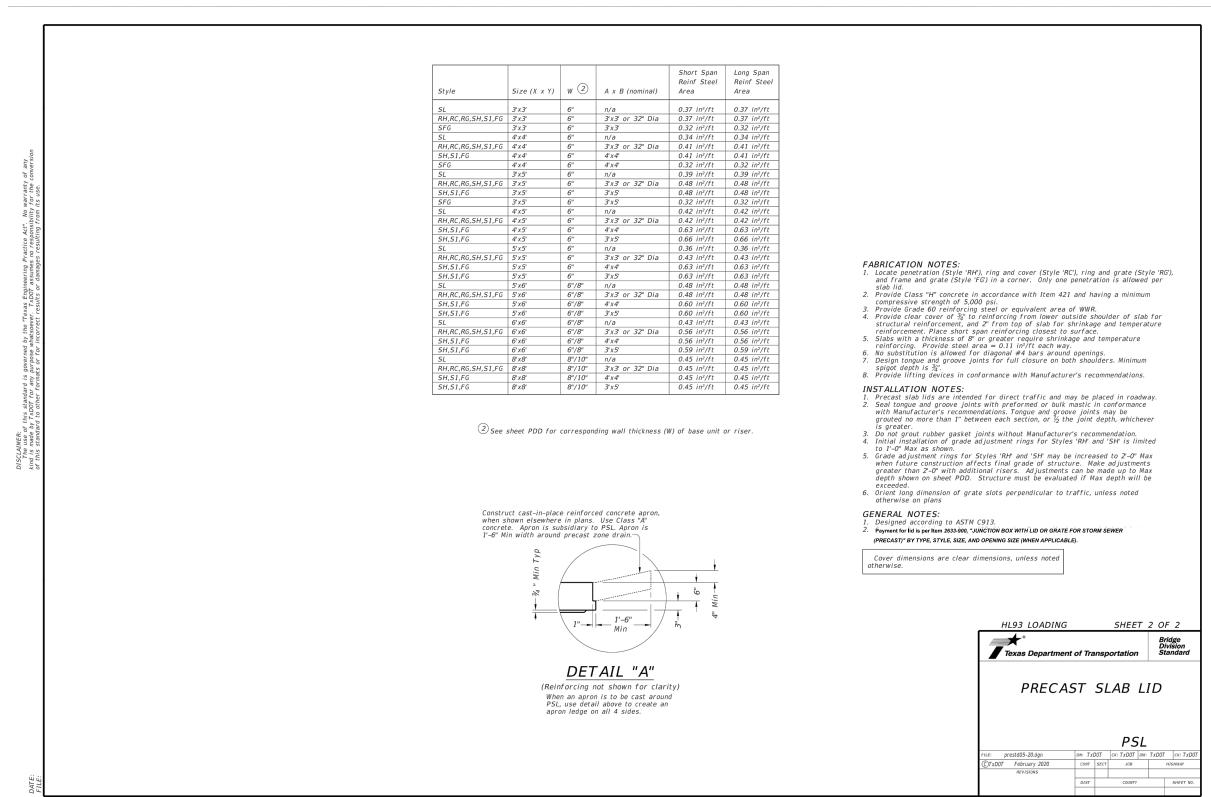

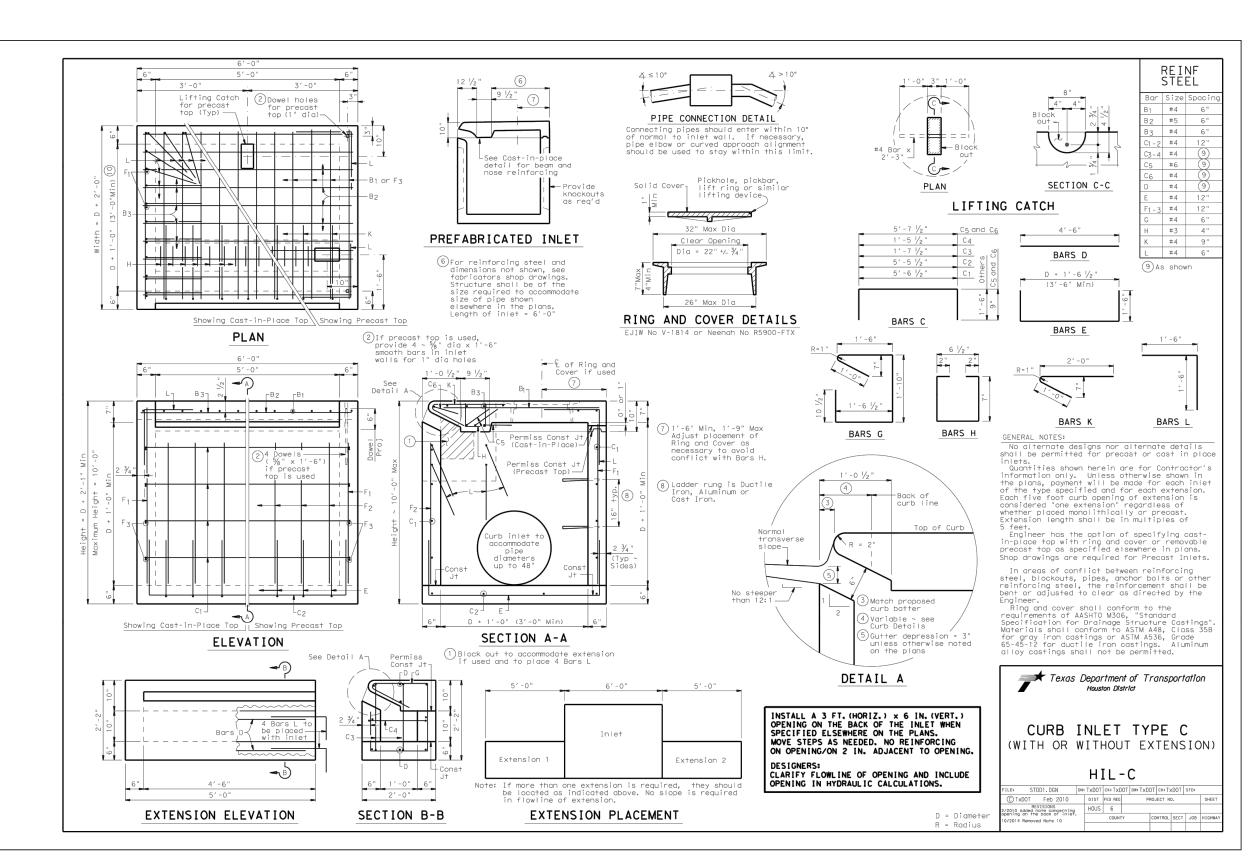


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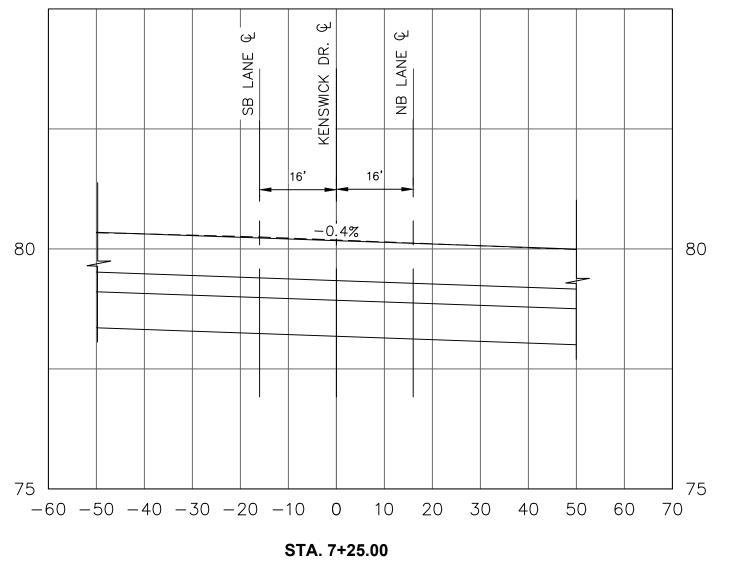
DIRECTOR HOUSTON AIRPORT SYSTEM

PROJECT NO.

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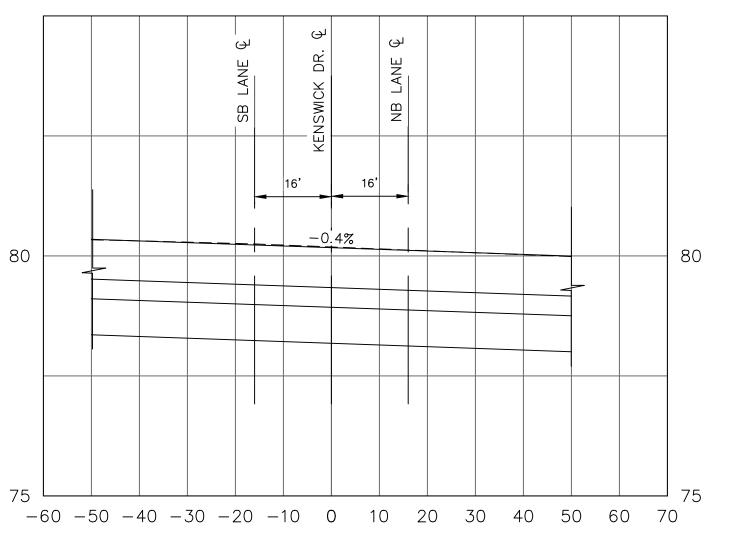
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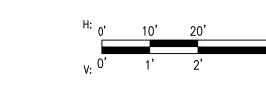
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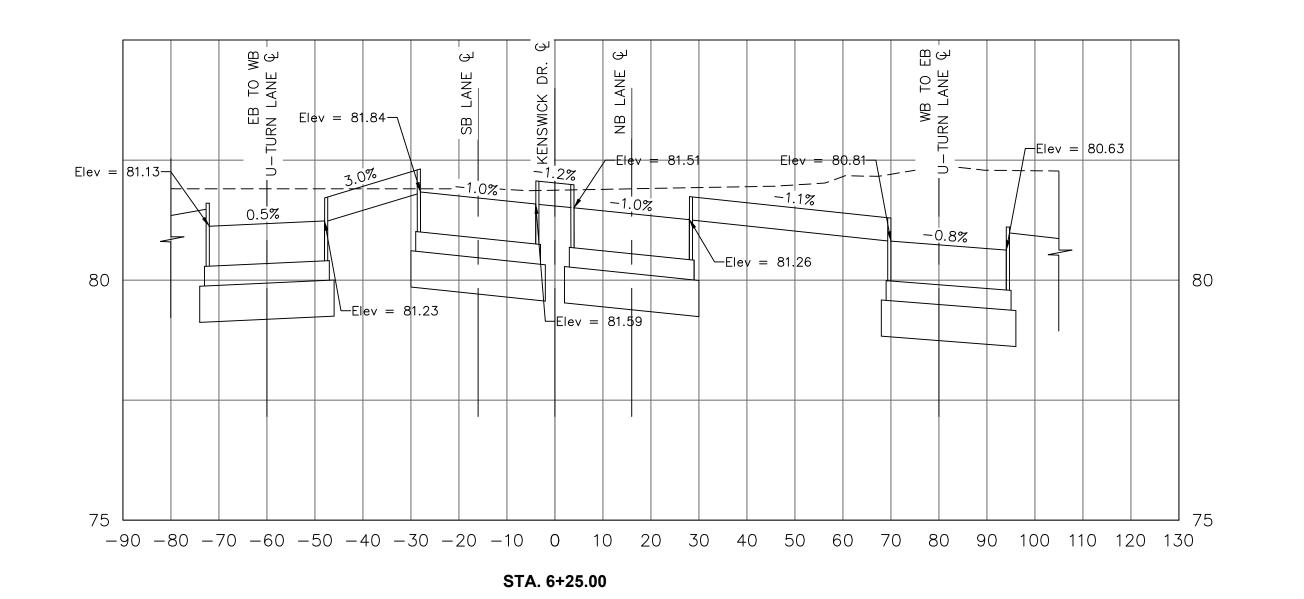
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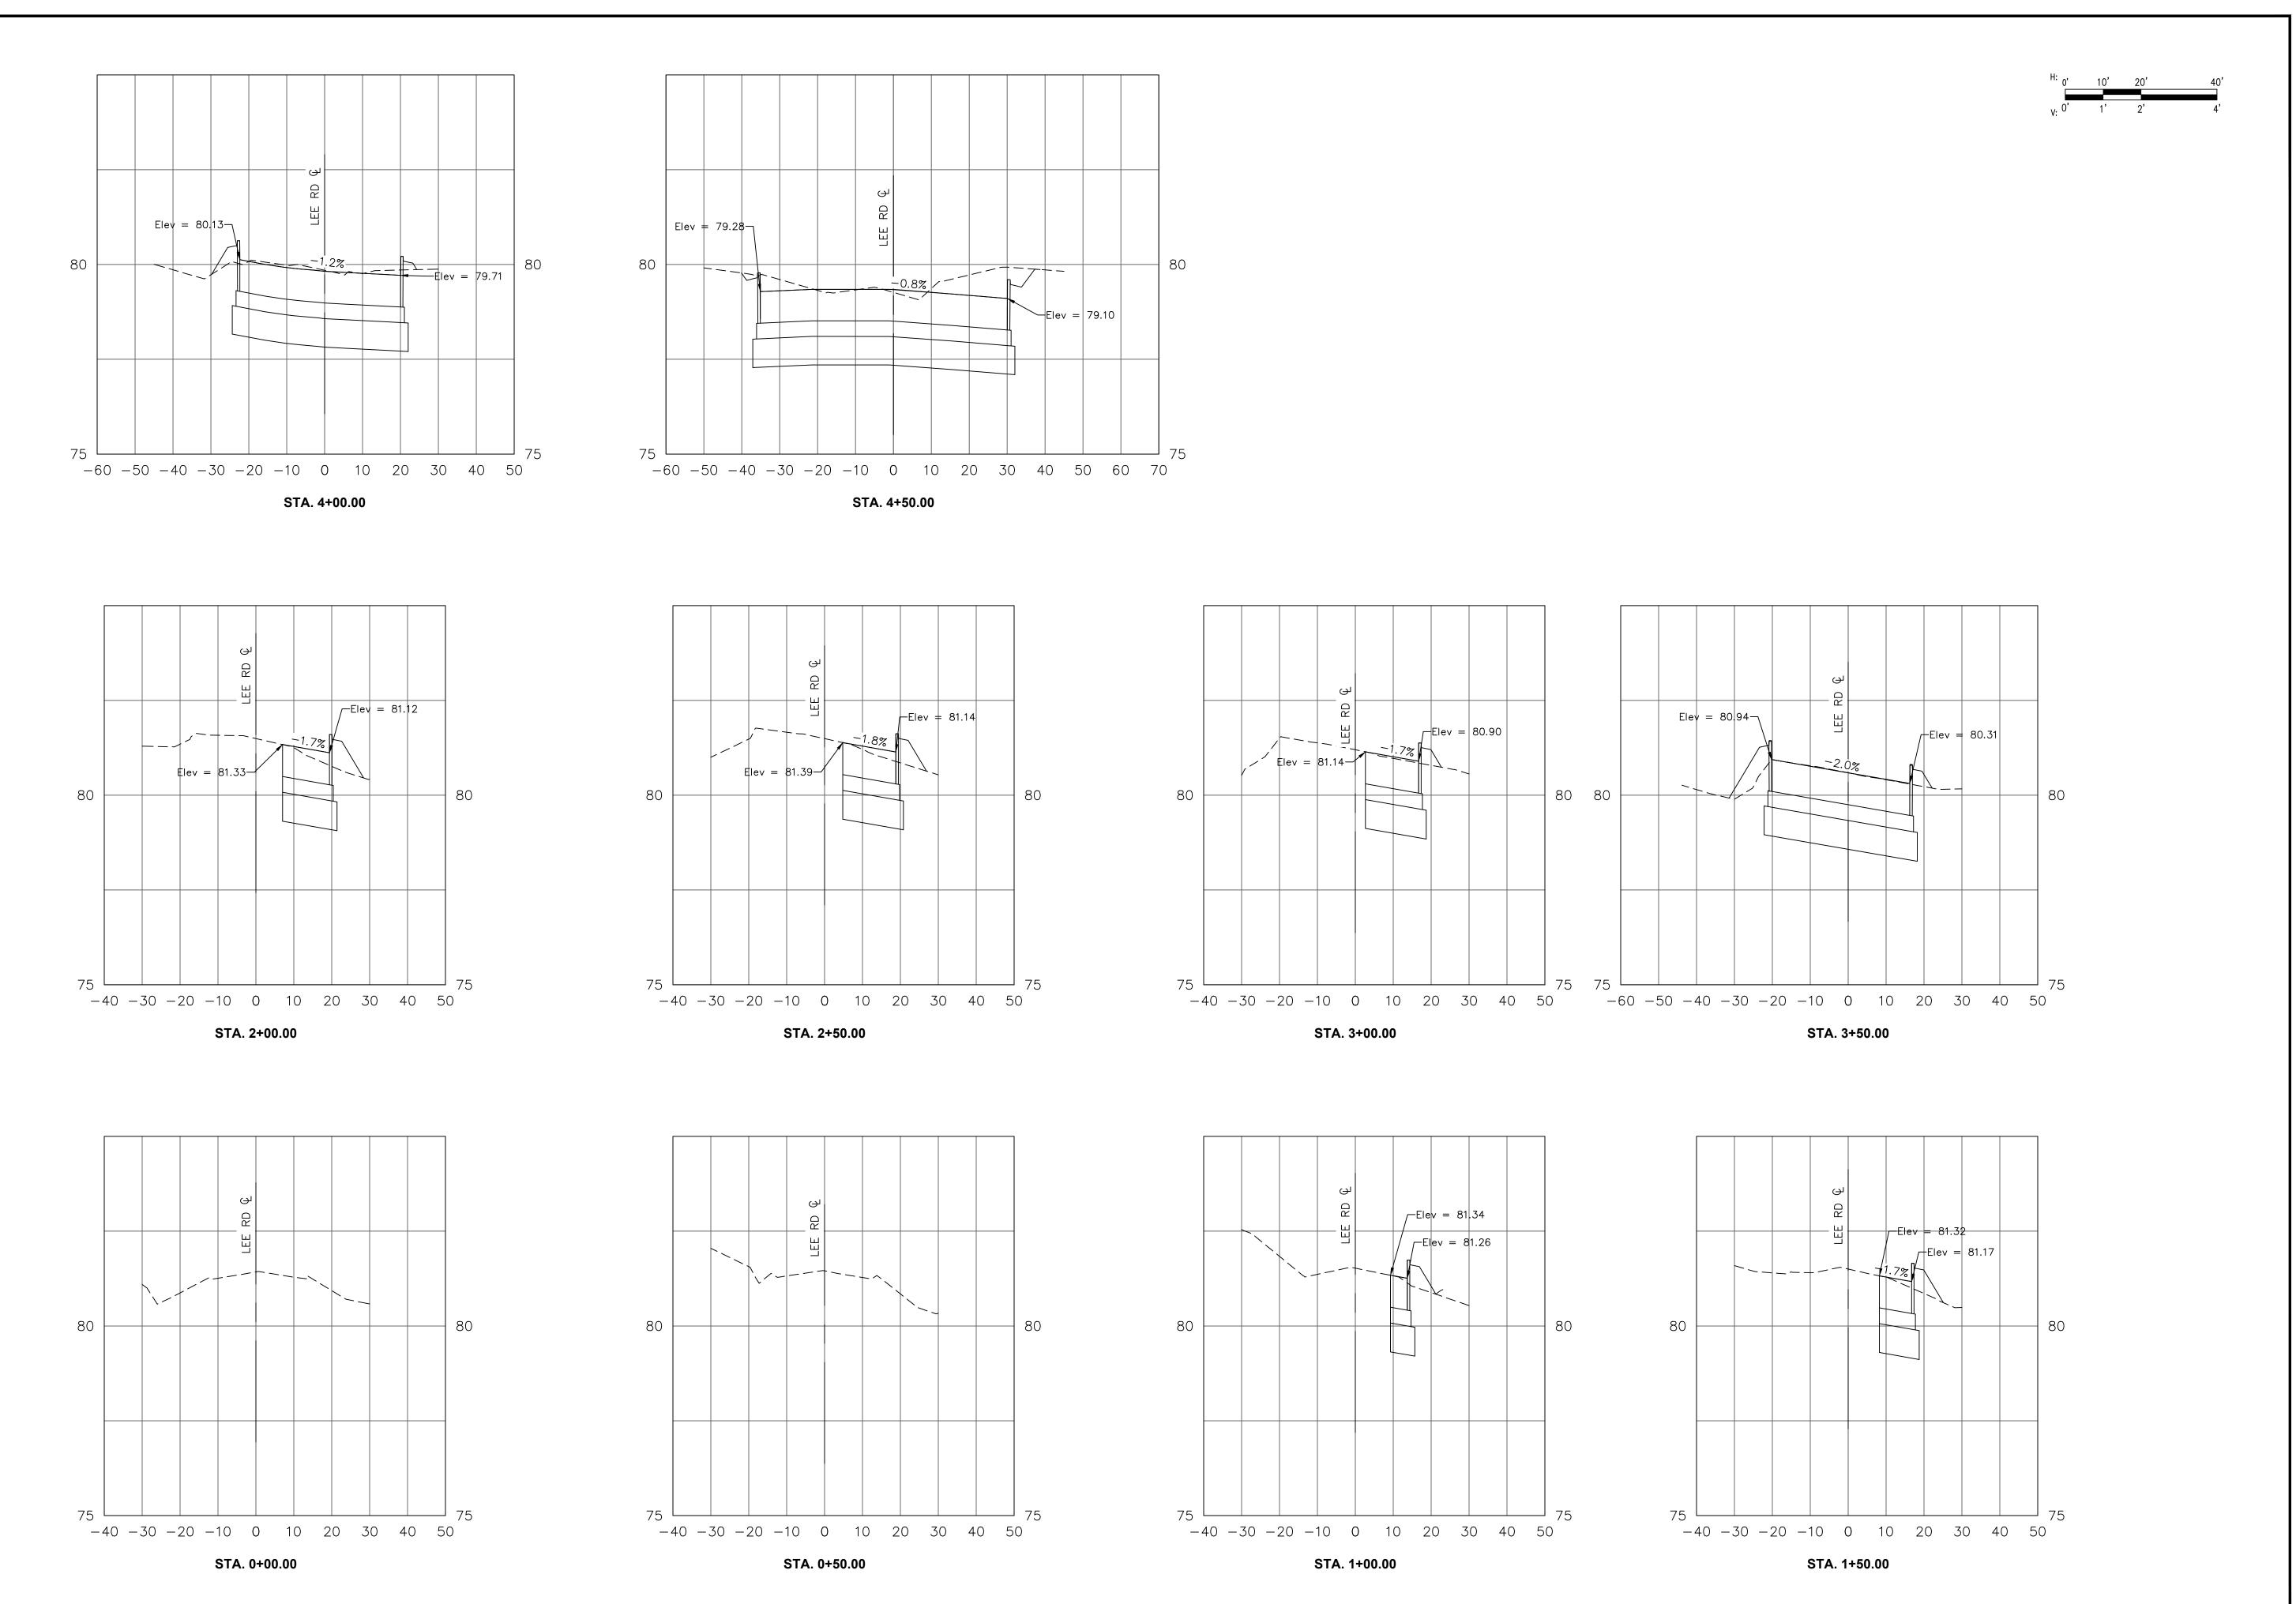
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PROJECT NO. 100072032 A.I.P. NO.

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HOUSTON AIRPORT SYSTEM
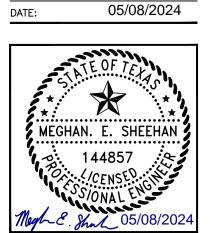
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HOUSTON, TX

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Houston Airports System

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PROJECT MGR: MES

DESIGNER: ALR

DRAWN BY: ALR

CHECK BY: PMW

SCALE:

DATE: 05/08/2024



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DIRECTOR
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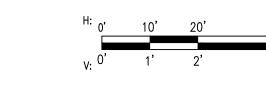
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AMERICA PE FIRM REG. #F-000474 REVISIONS

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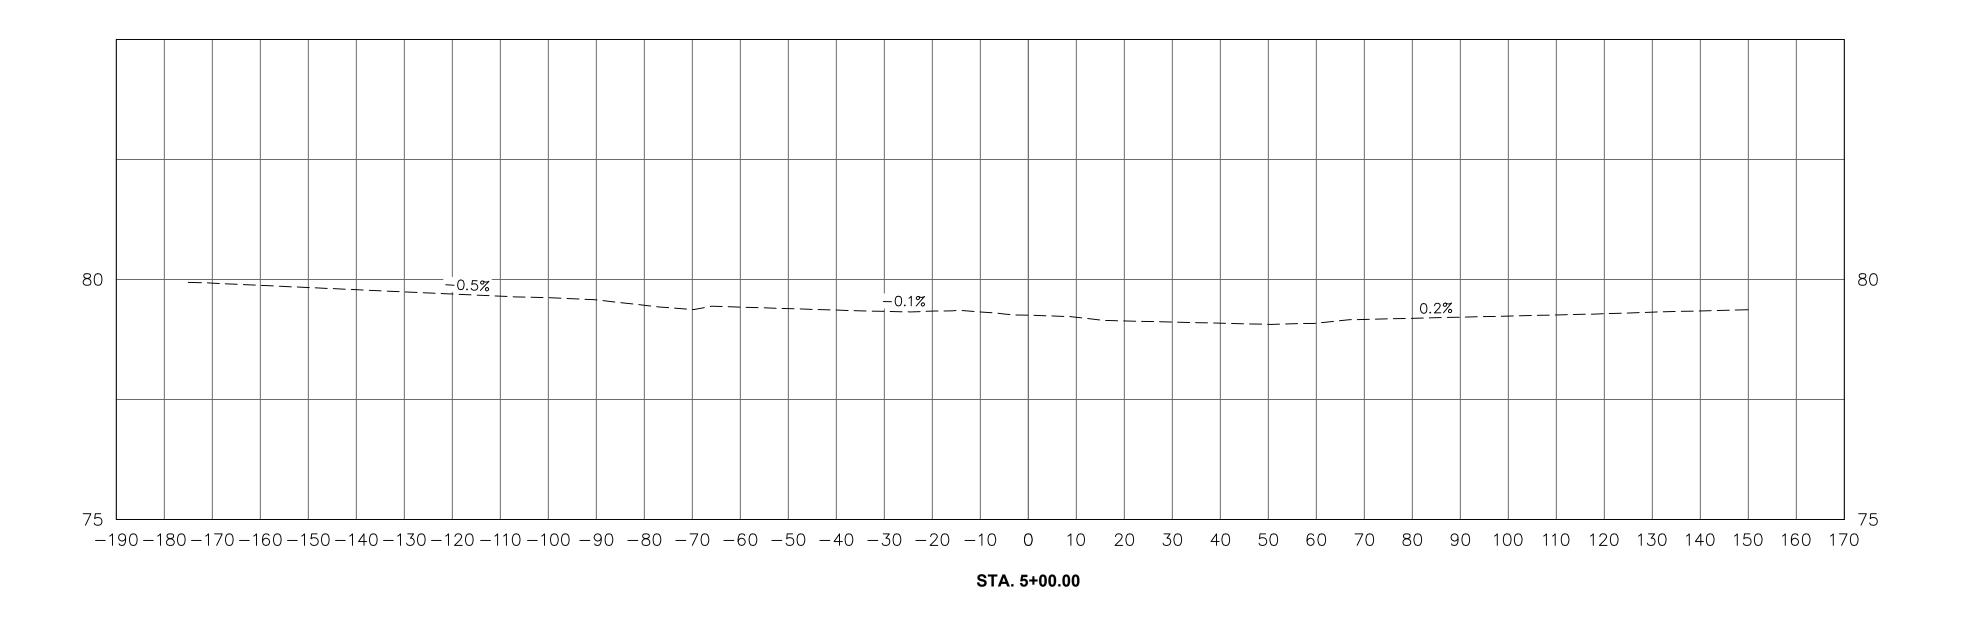
DIRECTOR HOUSTON AIRPORT SYSTEM


PROJECT NO. 100072032


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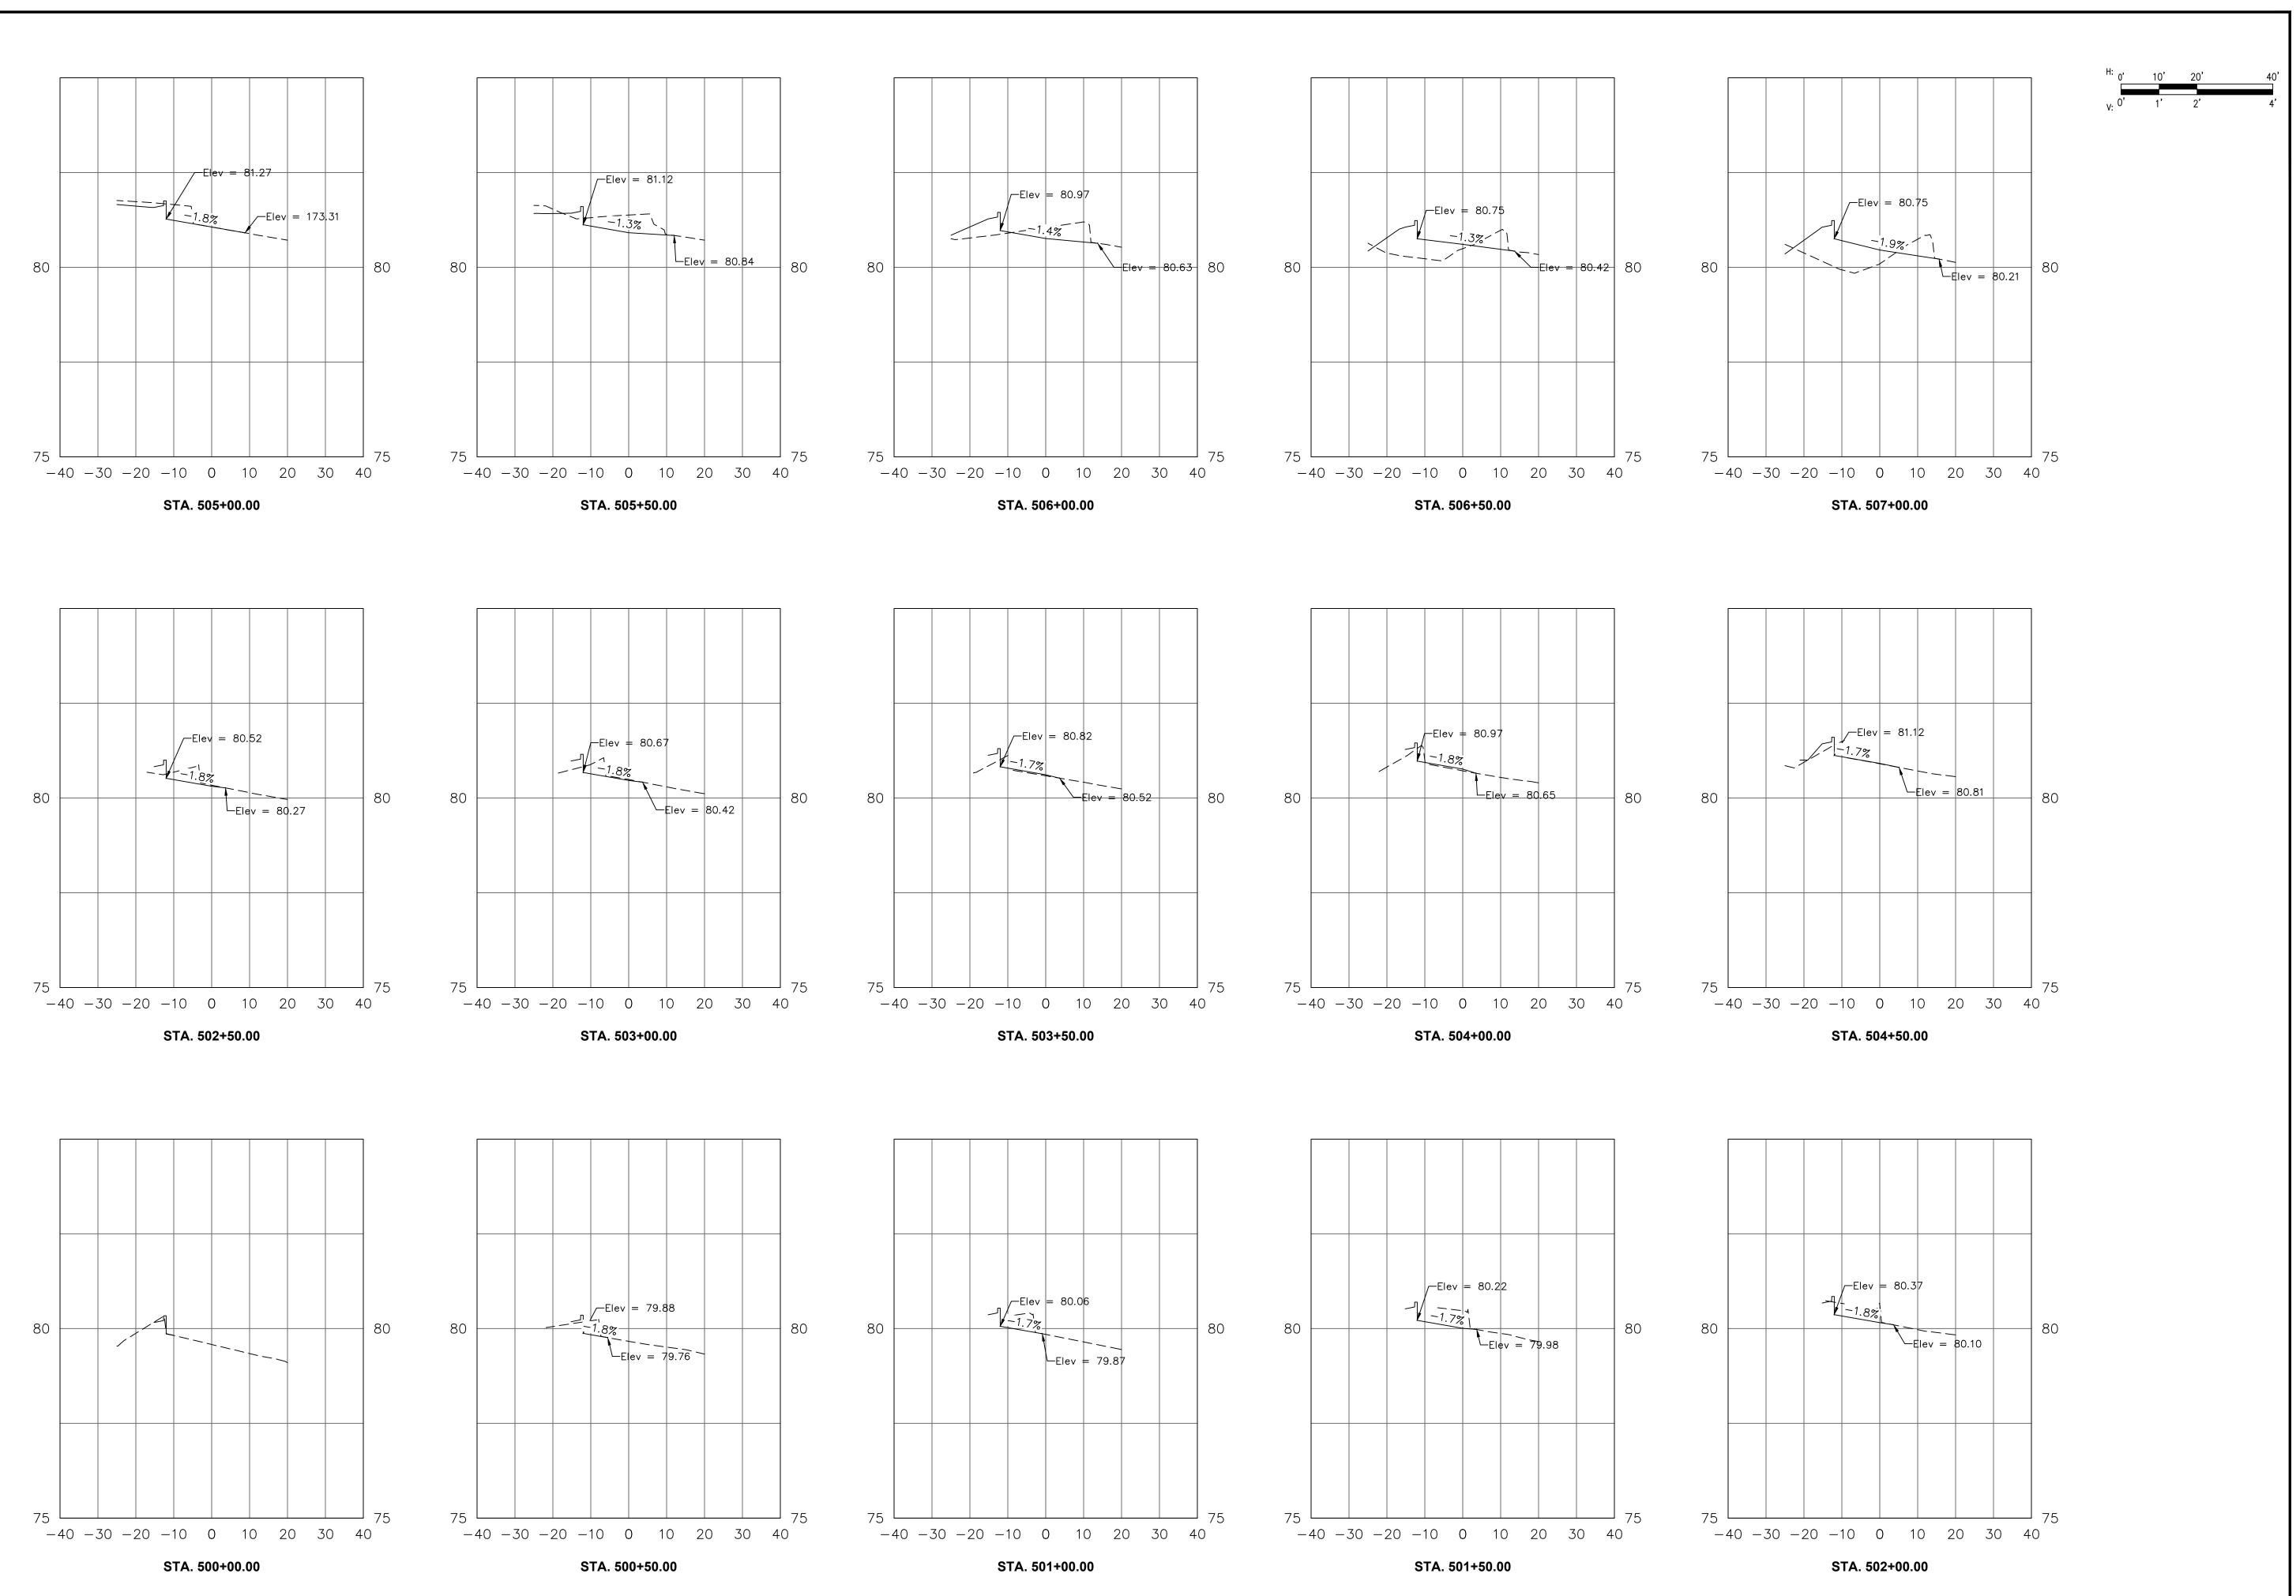
H.A.S. NO.

SHEET NO. **CD-606** 





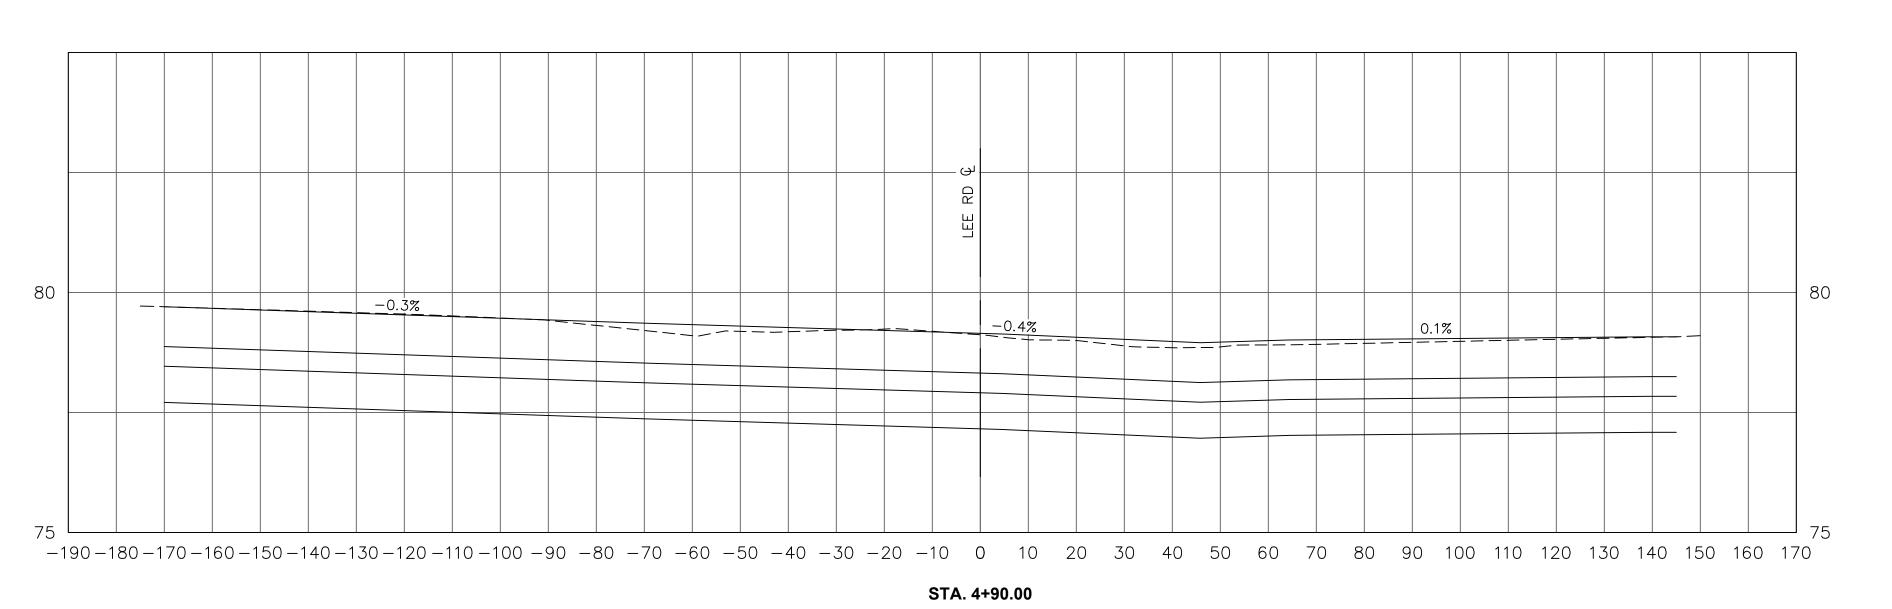

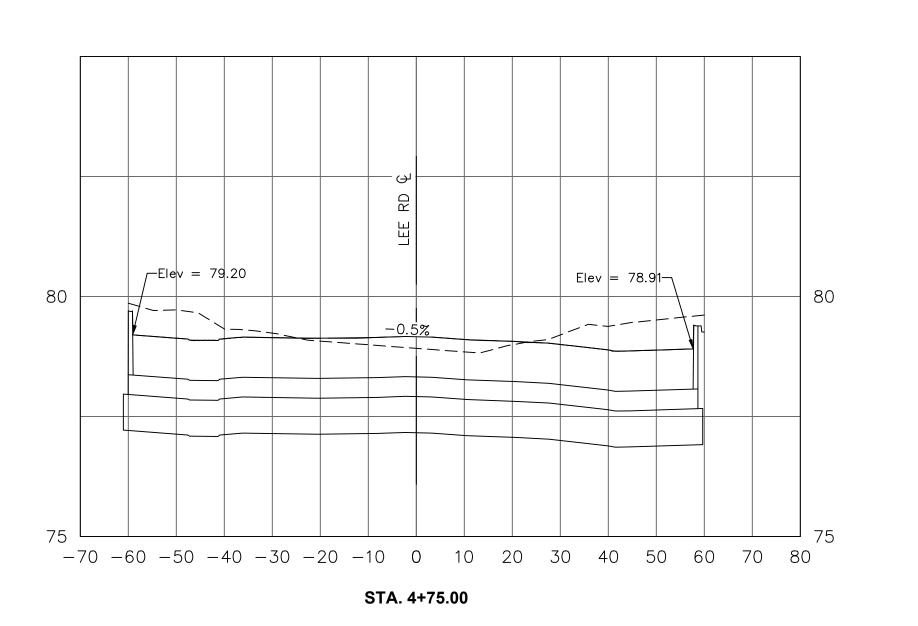



LOCAL OFFICE: 920 MEMORIAL CITY WAY. STE. 400 HOUSTON, TX 77024 TEL: (713) 576-8500 ATKINS NORTH AMERICA PE FIRM REG. #F-000474

REVISIONS NO. DESCRIPTION DATE BY

CITY OF HOUSTON HOUSTON AIRPORTS SYSTEM

MES PROJECT MGR: DESIGNER: ALR DRAWN BY: CHECK BY: PMW 05/08/2024




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DIRECTOR HOUSTON AIRPORT SYSTEM PROJECT NO.

100072032 A.I.P. NO.

H.A.S. NO. SHEET NO.



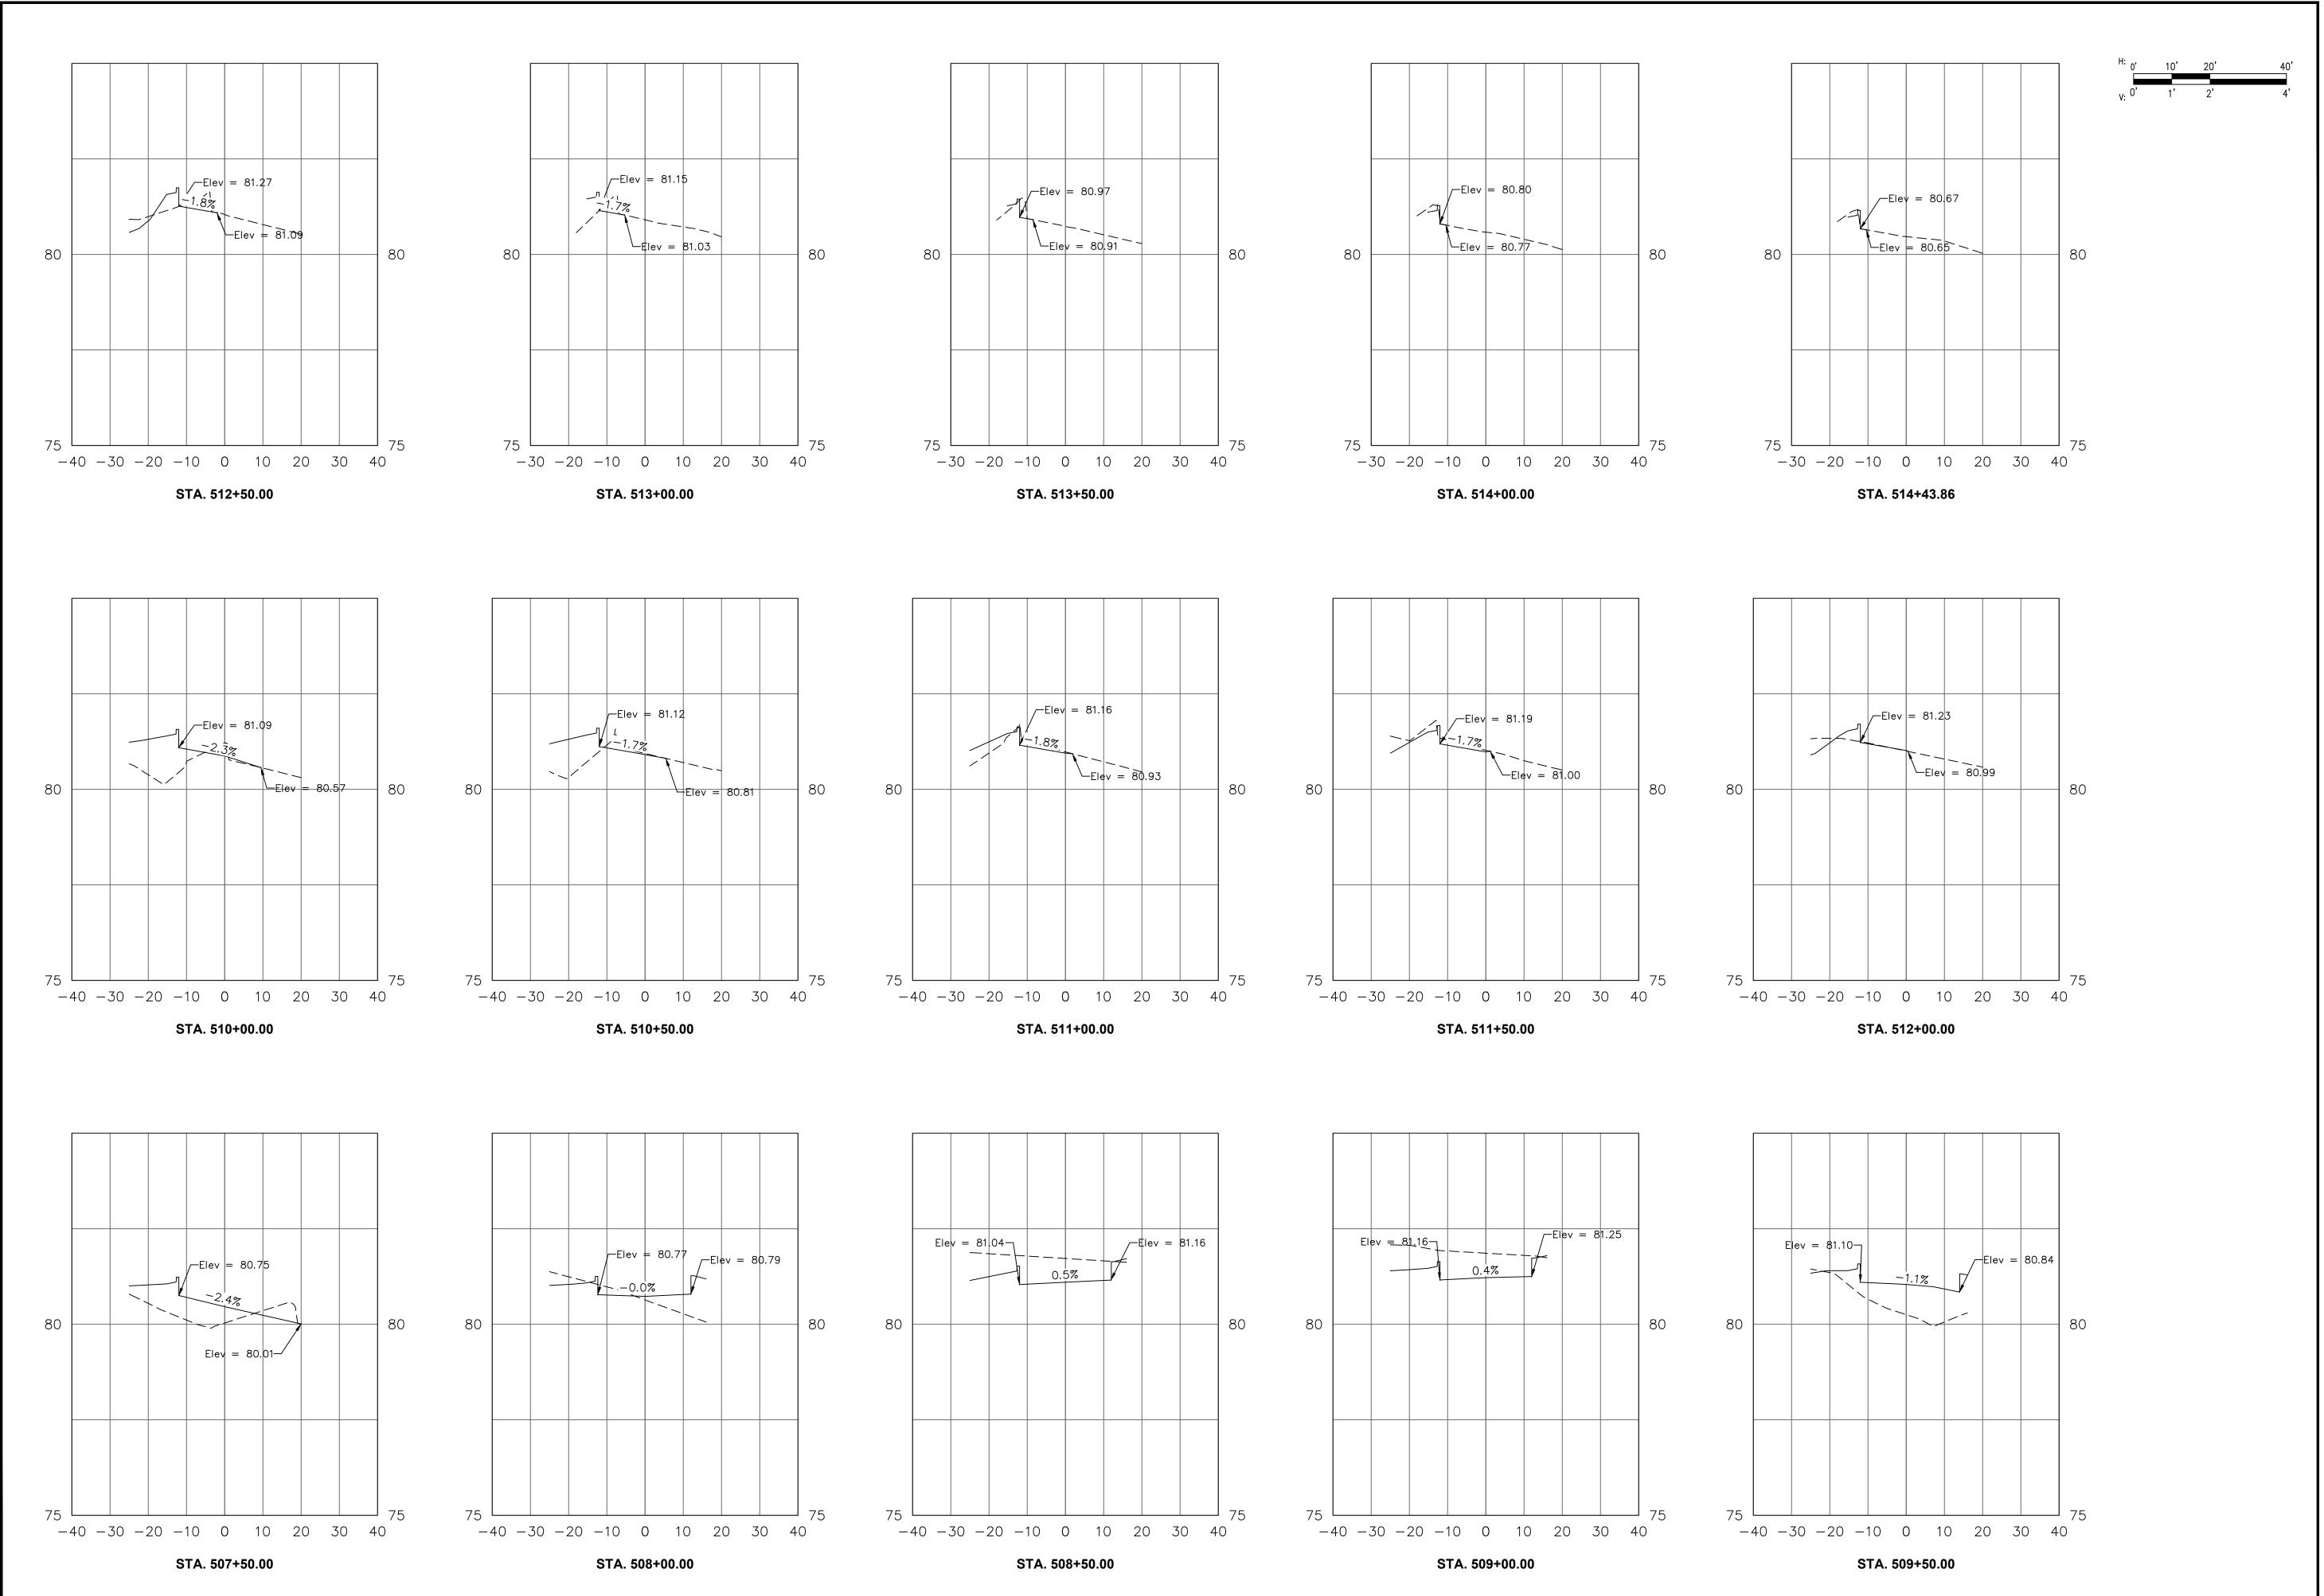

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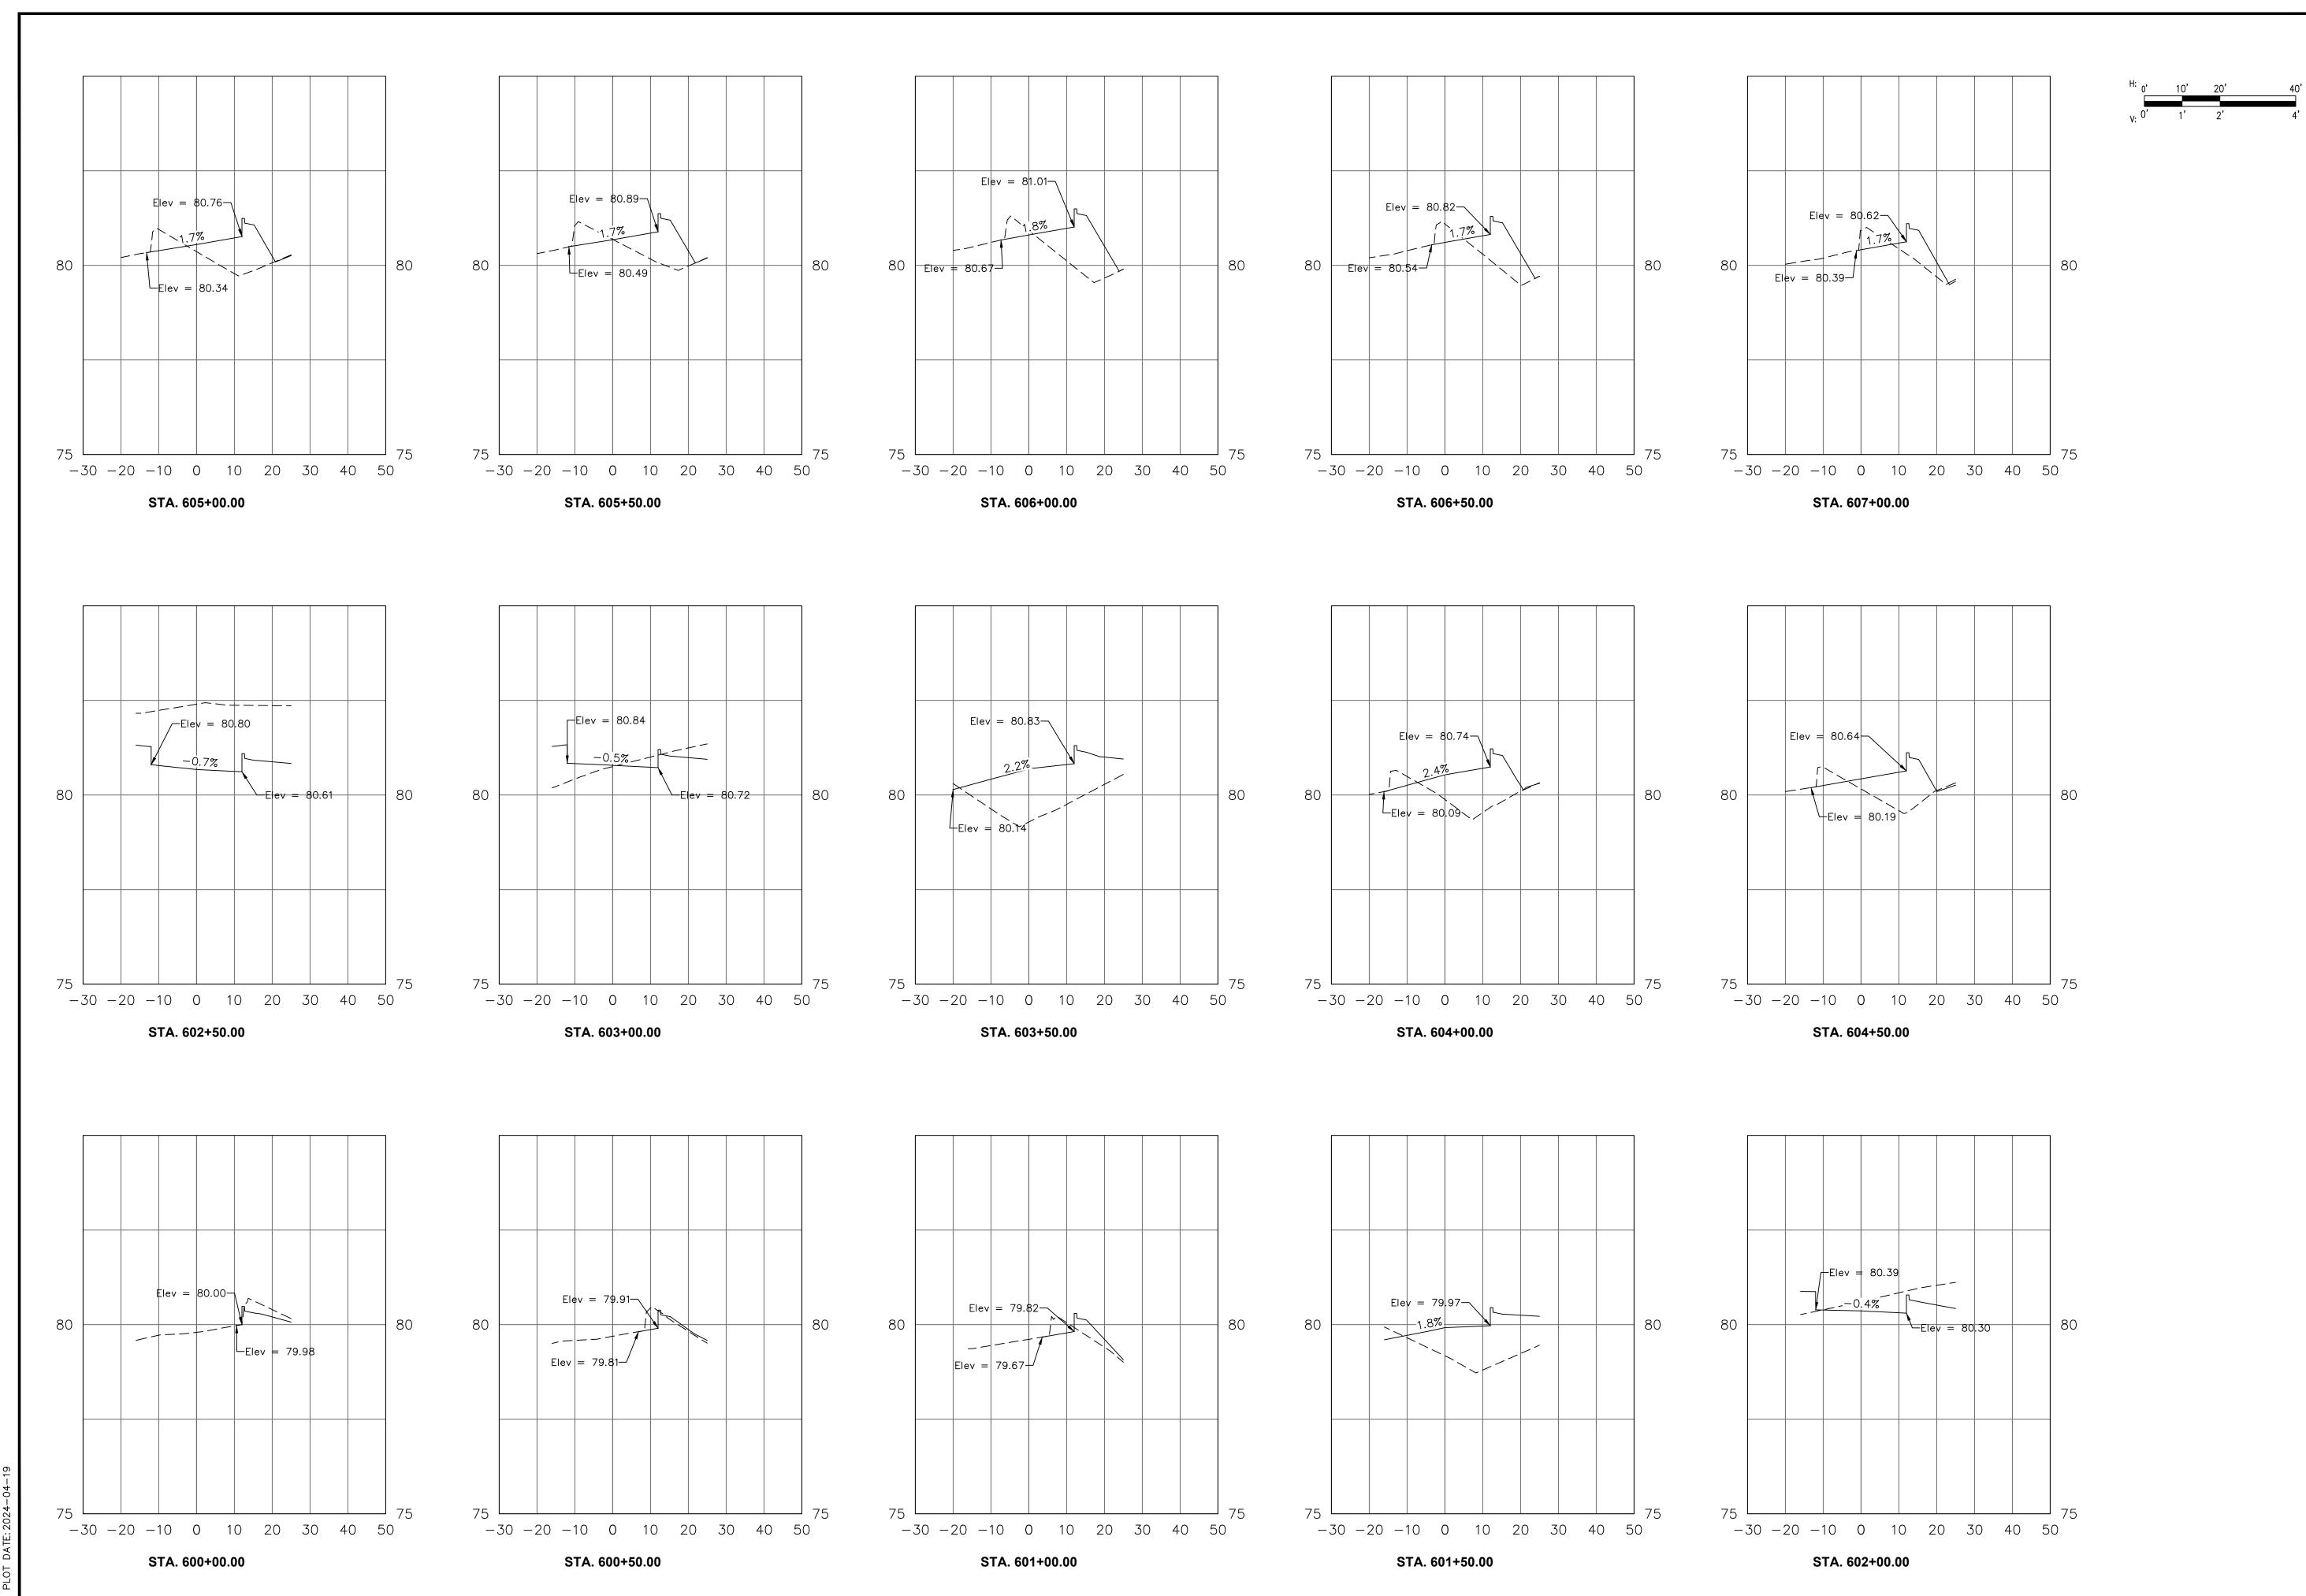
DIRECTOR HOUSTON AIRPORT SYSTEM

PROJECT NO.

100072032 A.I.P. NO.

H.A.S. NO.

SHEET NO.






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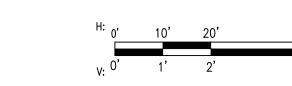


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PROJECT NO.

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SHEET NO. **CD-609** 

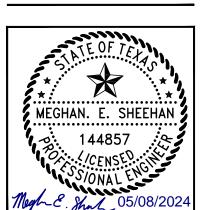






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REVISIONS NO. DESCRIPTION DATE BY

PROJECT MGR: DESIGNER: DRAWN BY: CHECK BY: 05/08/2024

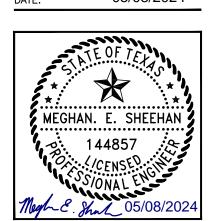


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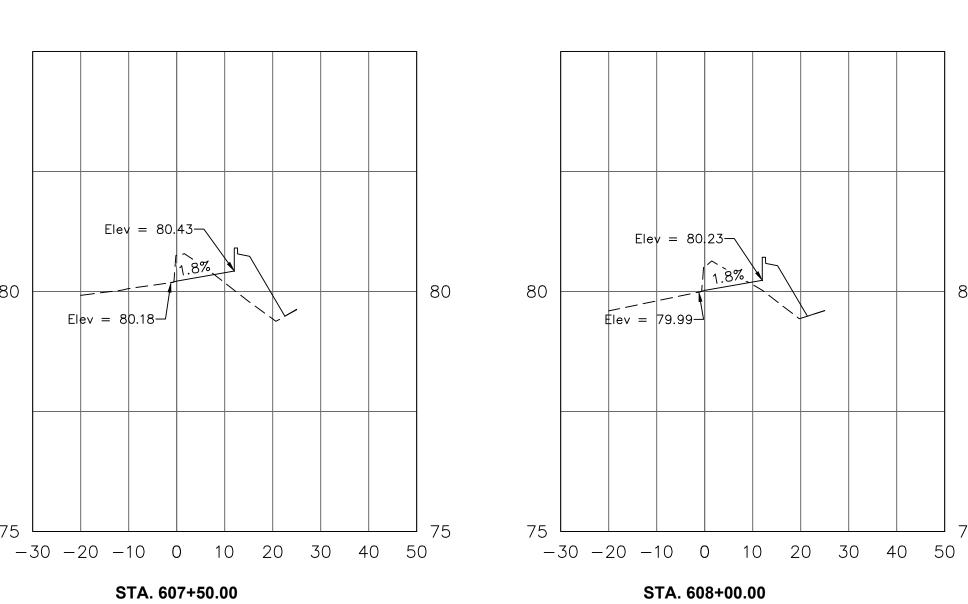
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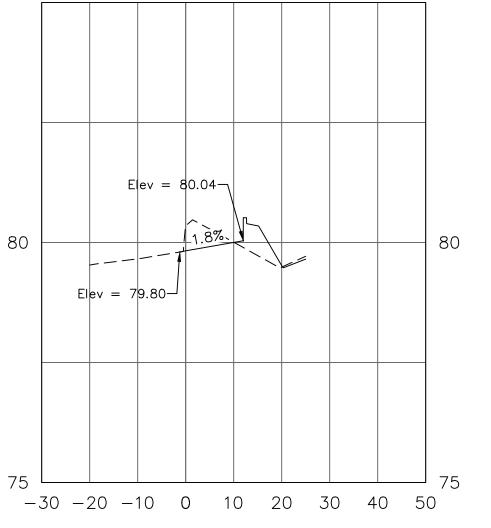
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CD-610




STA. 607+50.00



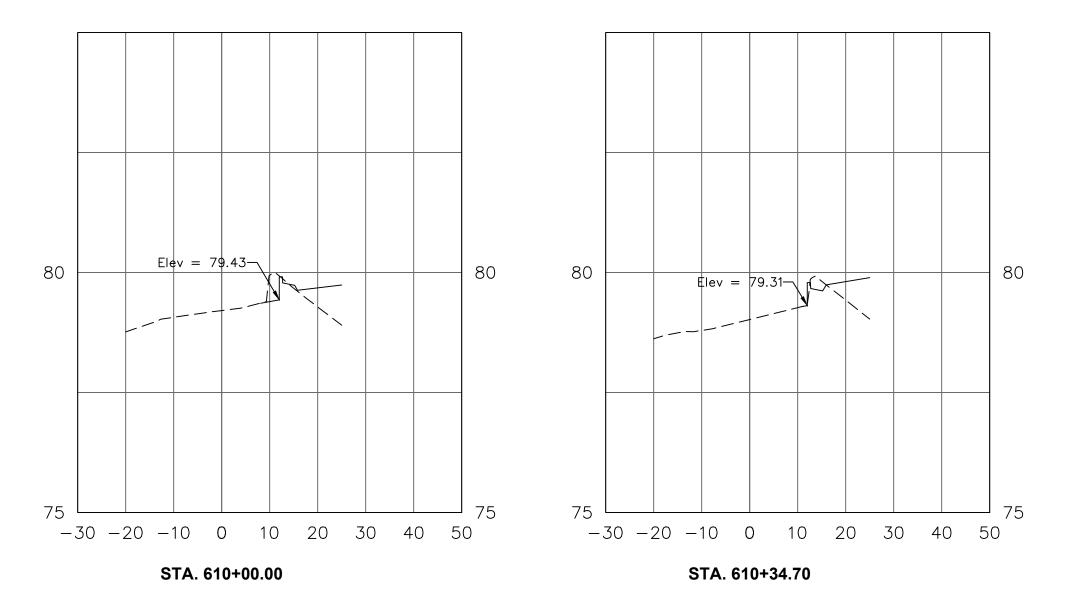

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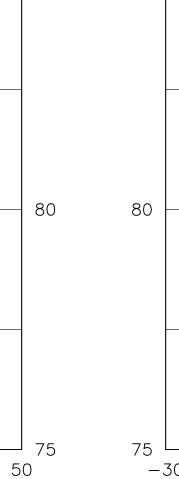
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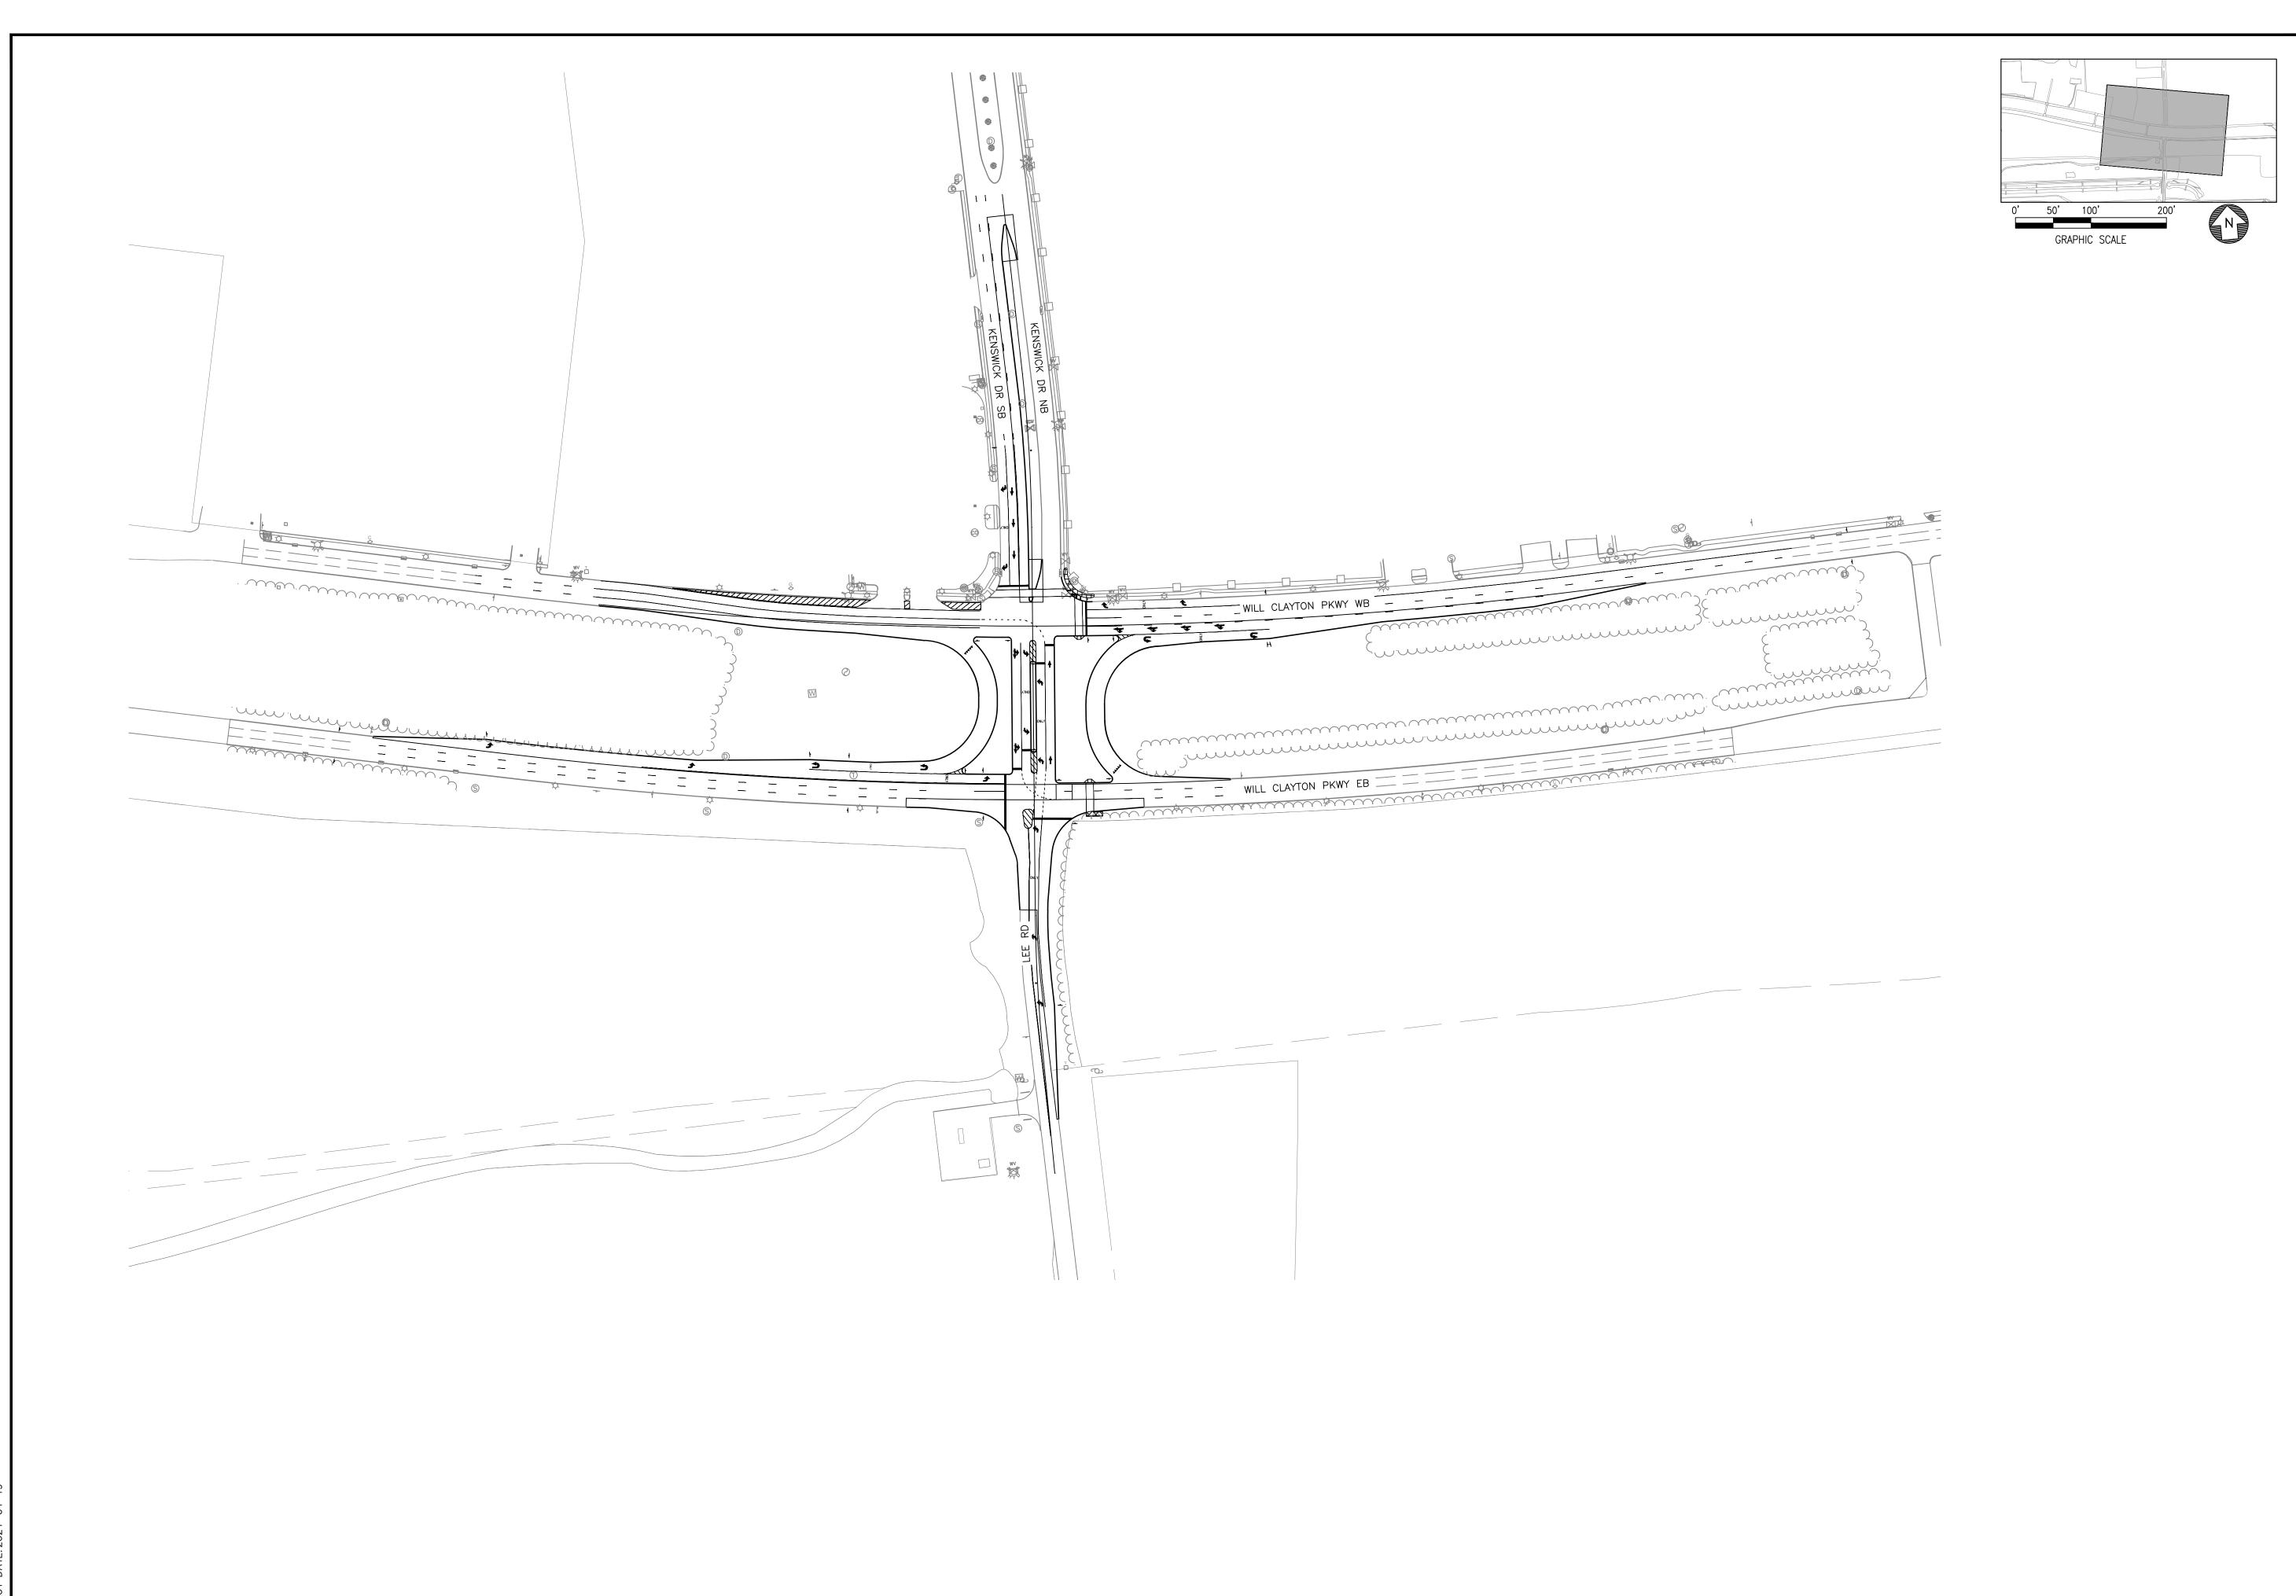
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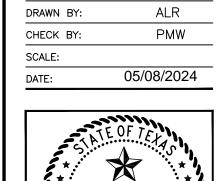


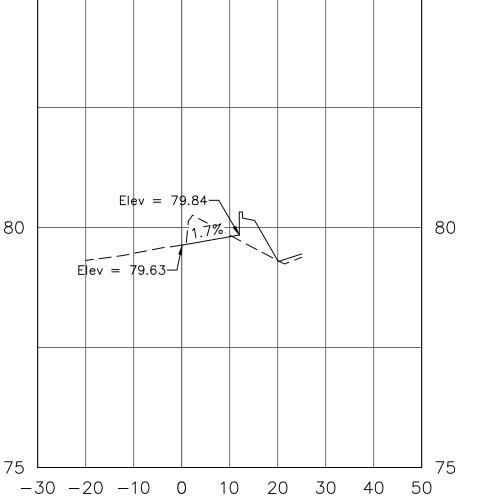

LOCAL OFFICE:
920 MEMORIAL CITY WAY.
STE. 400
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TEL: (713) 576-8500 ATKINS NORTH AMERICA PE FIRM REG. #F-000474

REVISIONS NO. DESCRIPTION DATE BY

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PROJECT MGR:


DESIGNER:

APPROVED BY:

PROJECT NO. 100072032 A.I.P. NO.

C.I.P. NO.

H.A.S. NO. SHEET NO.

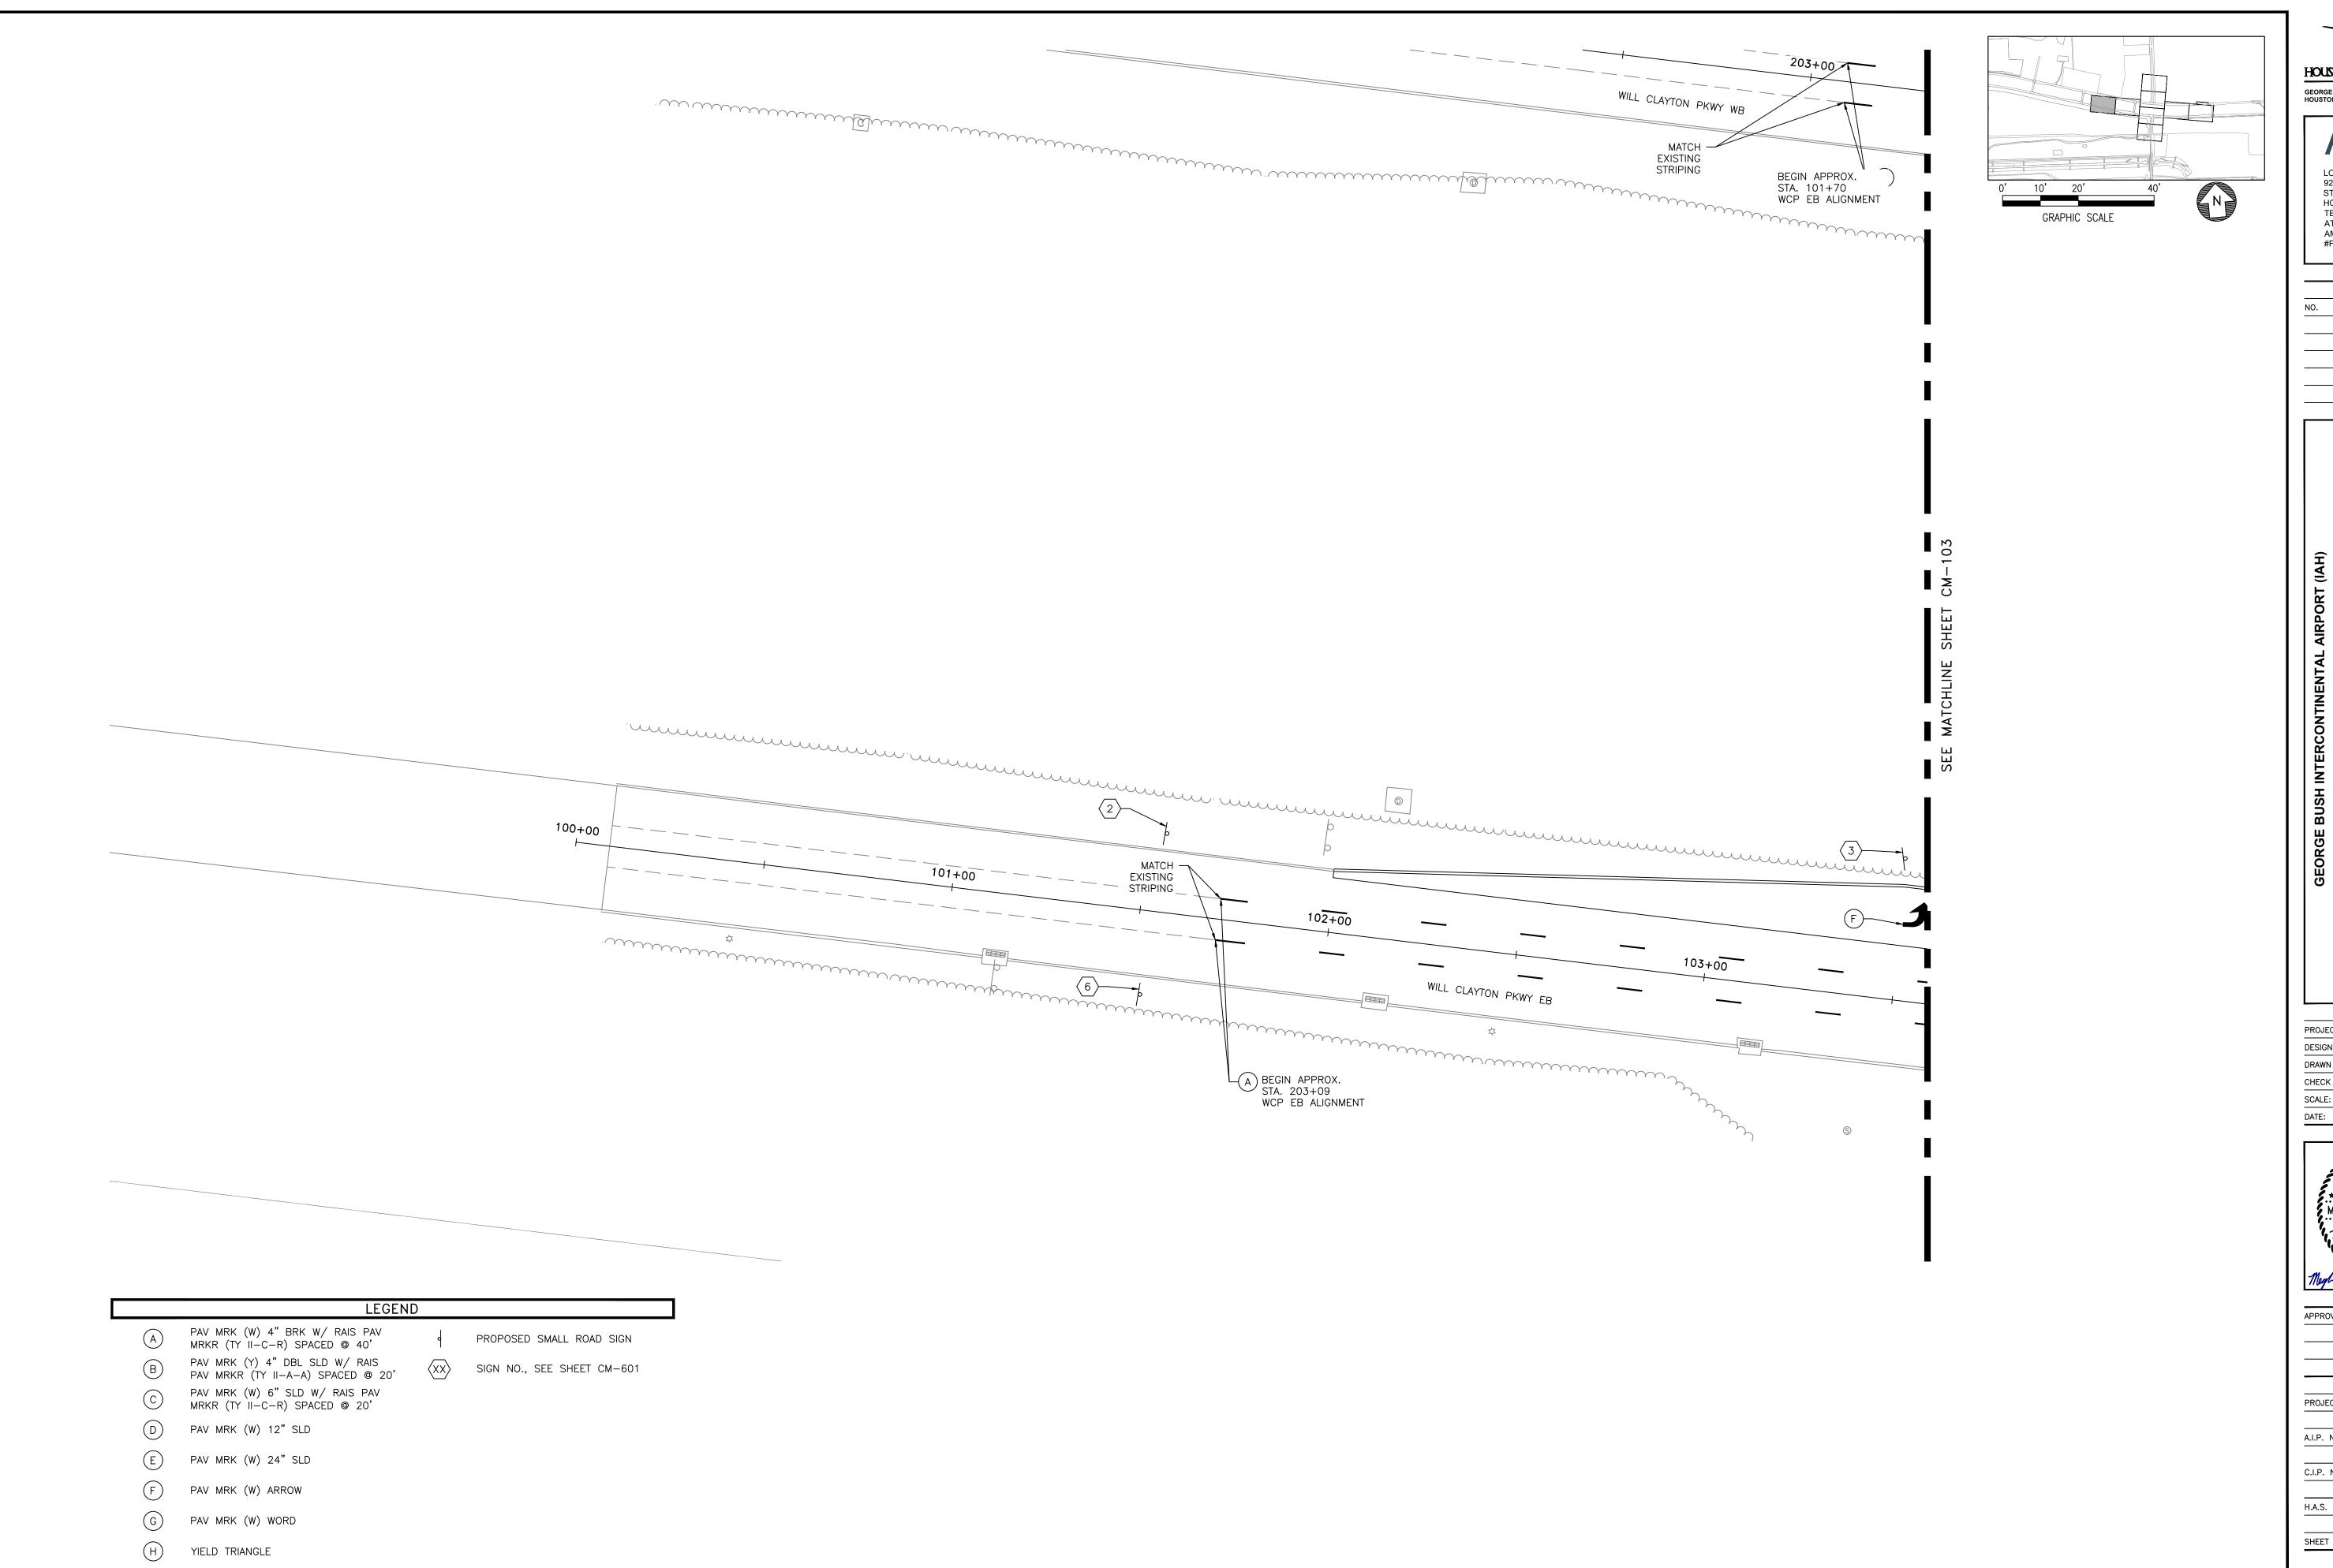

PAV MRK (W) 6" GAP




**ATKINS** 

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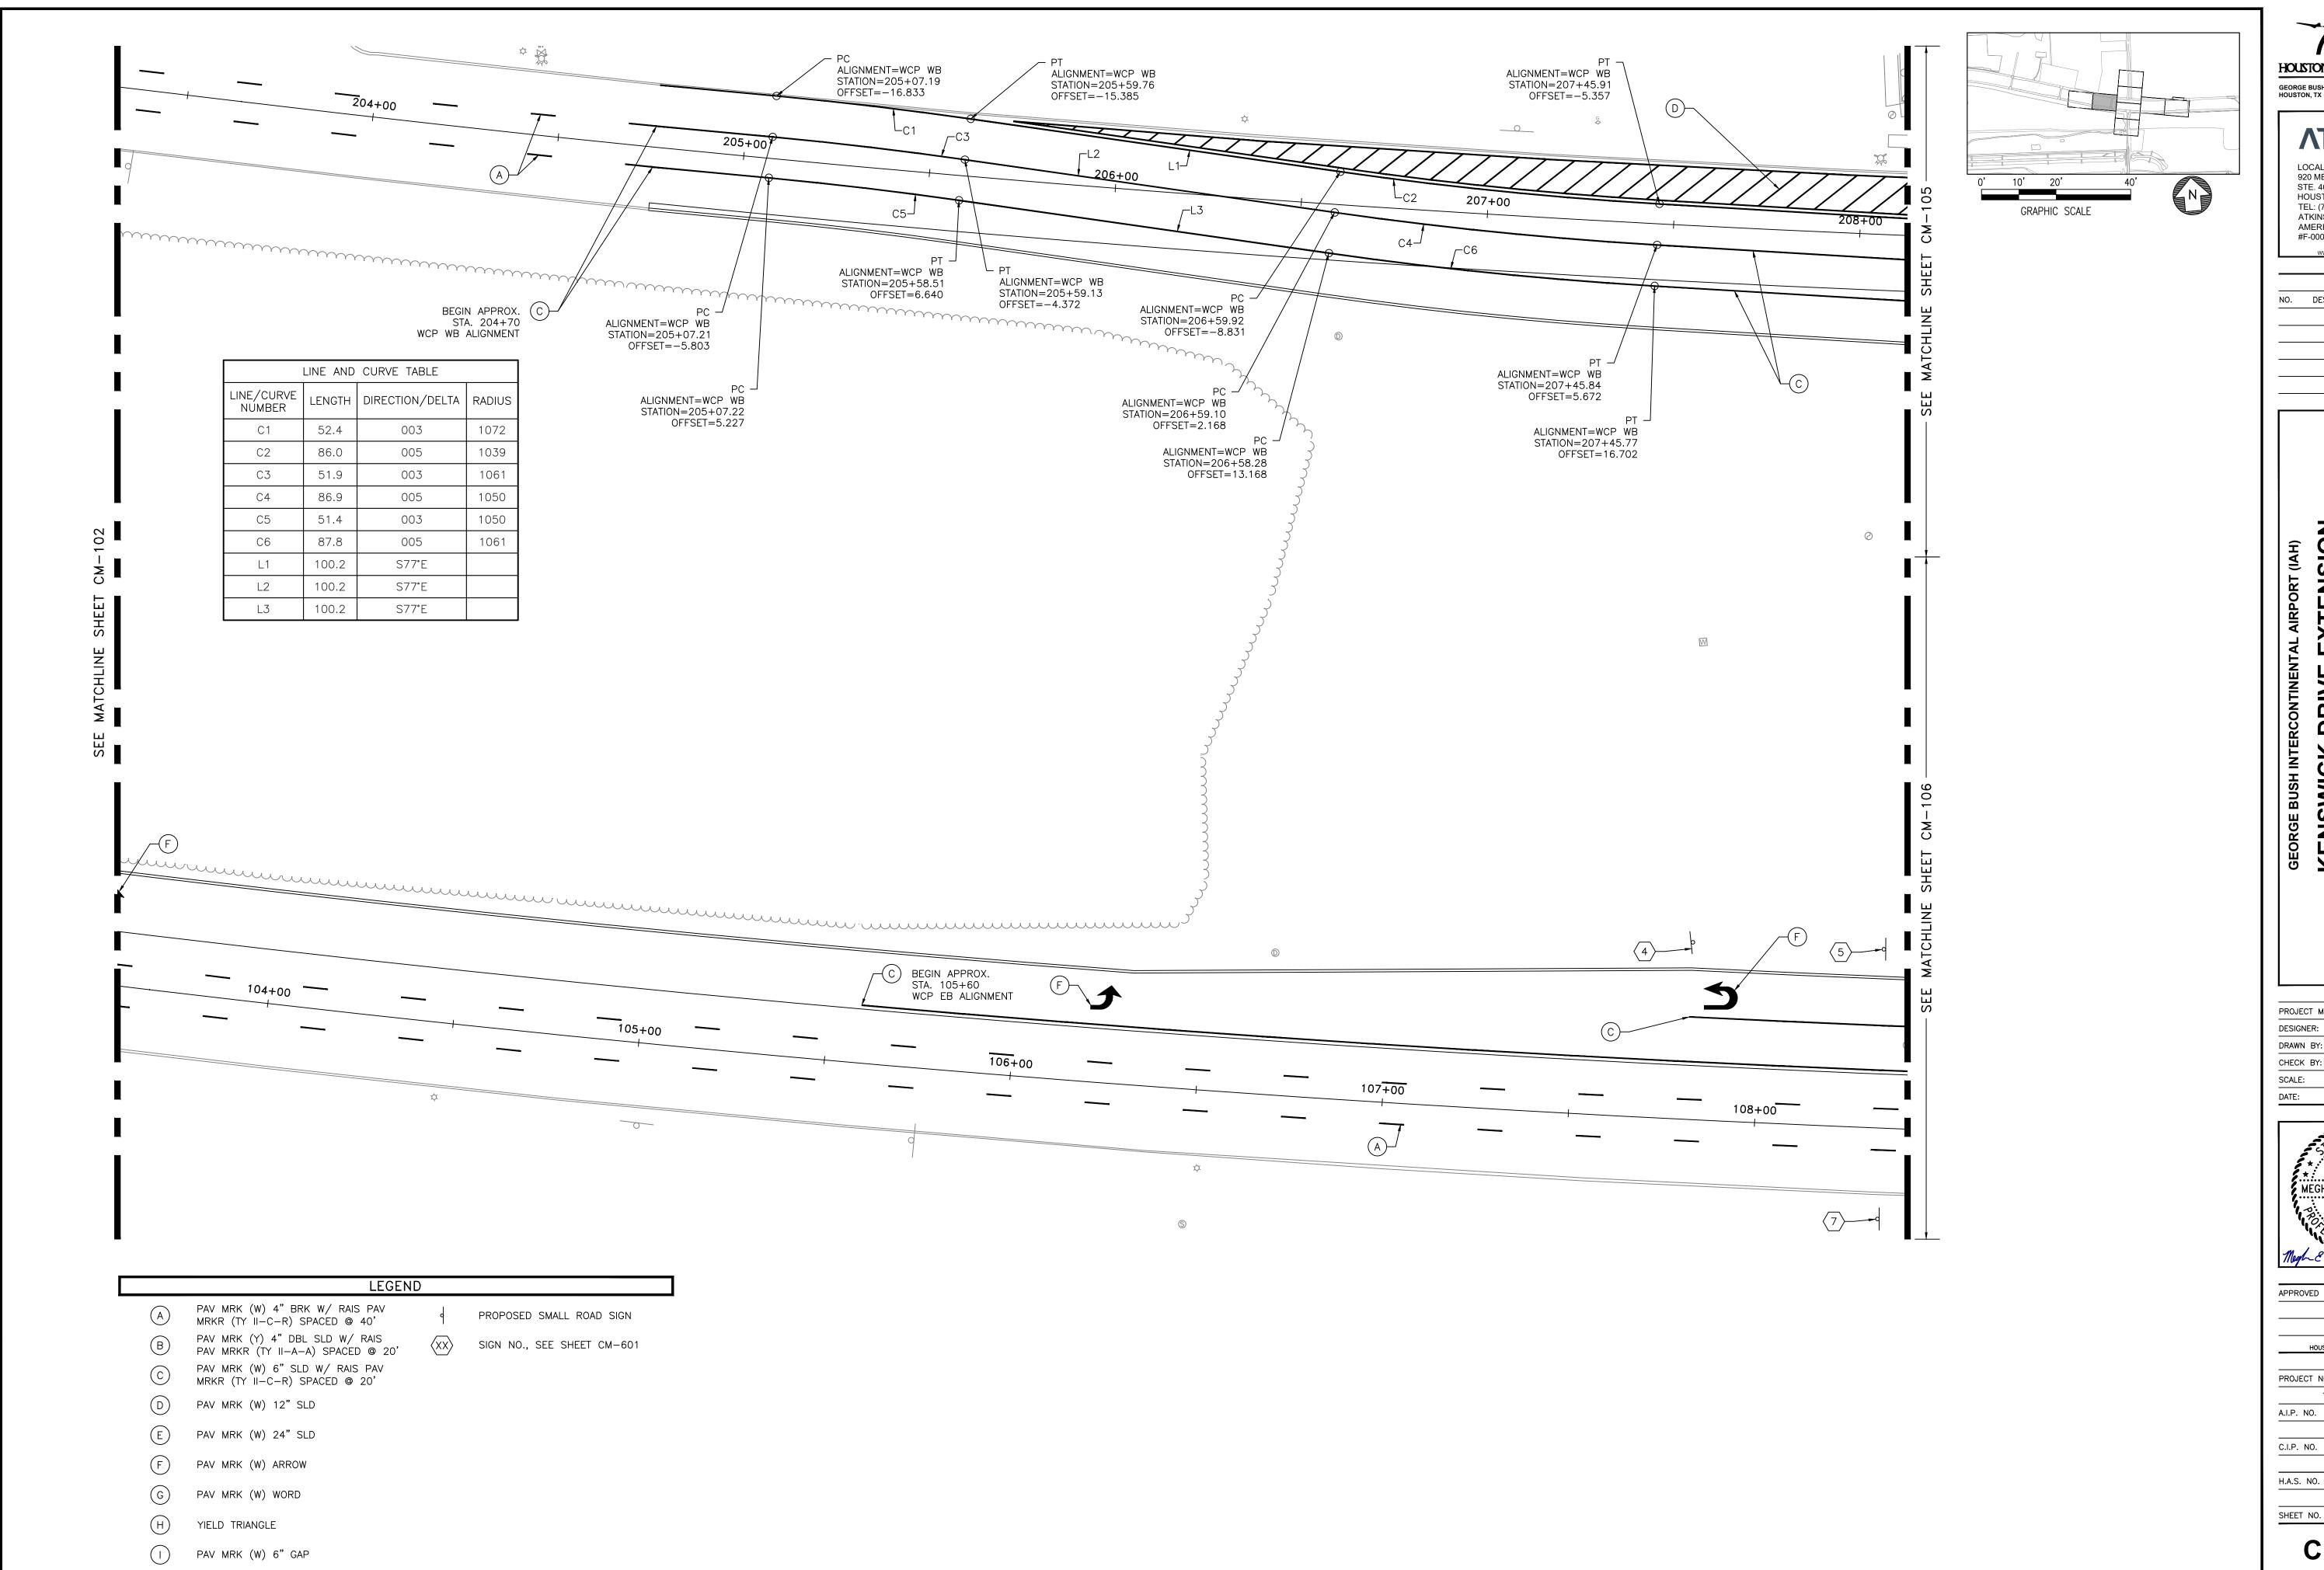
DIRECTOR HOUSTON AIRPORT SYSTEM

PROJECT NO.

100072032 A.I.P. NO.

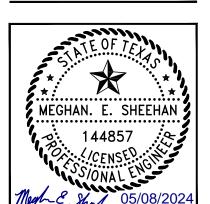C.I.P. NO.

H.A.S. NO. 935 SHEET NO.



HOUSTON AIRPORT SYSTEM GEORGE BUSH INTERCONTINENTAL AIRPORT /

> **ATKINS** LOCAL OFFICE:

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DIRECTOR HOUSTON AIRPORT SYSTEM

PROJECT NO.

100072032

935 SHEET NO.


HOUSTON AIRPORT SYSTEM GEORGE BUSH INTERCONTINENTAL AIRPORT / HOUSTON, TX

**ATKINS** 

LOCAL OFFICE:
920 MEMORIAL CITY WAY.
STE. 400
HOUSTON, TX 77024
TEL: (713) 576-8500
ATKINS NORTH
AMERICA PE FIRM REG.
#F-000474

REVISIONS NO. DESCRIPTION DATE BY

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A.I.P. NO. C.I.P. NO.

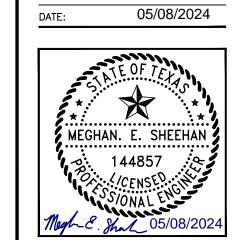H.A.S. NO.

SHEET NO.

935

CM-104

PAV MRK (W) 4" BRK W/ RAIS PAV MRKR (TY II-C-R) SPACED @ 40'

PROPOSED SMALL ROAD SIGN

SIGN NO., SEE SHEET CM-601

PAV MRK (Y) 4" DBL SLD W/ RAIS PAV MRKR (TY II—A—A) SPACED @ 20'

PAV MRK (W) 6" SLD W/ RAIS PAV MRKR (TY II-C-R) SPACED @ 20'


PAV MRK (W) 12" SLD

PAV MRK (W) 24" SLD PAV MRK (W) ARROW

PAV MRK (W) WORD

PAV MRK (W) 6" GAP

YIELD TRIANGLE

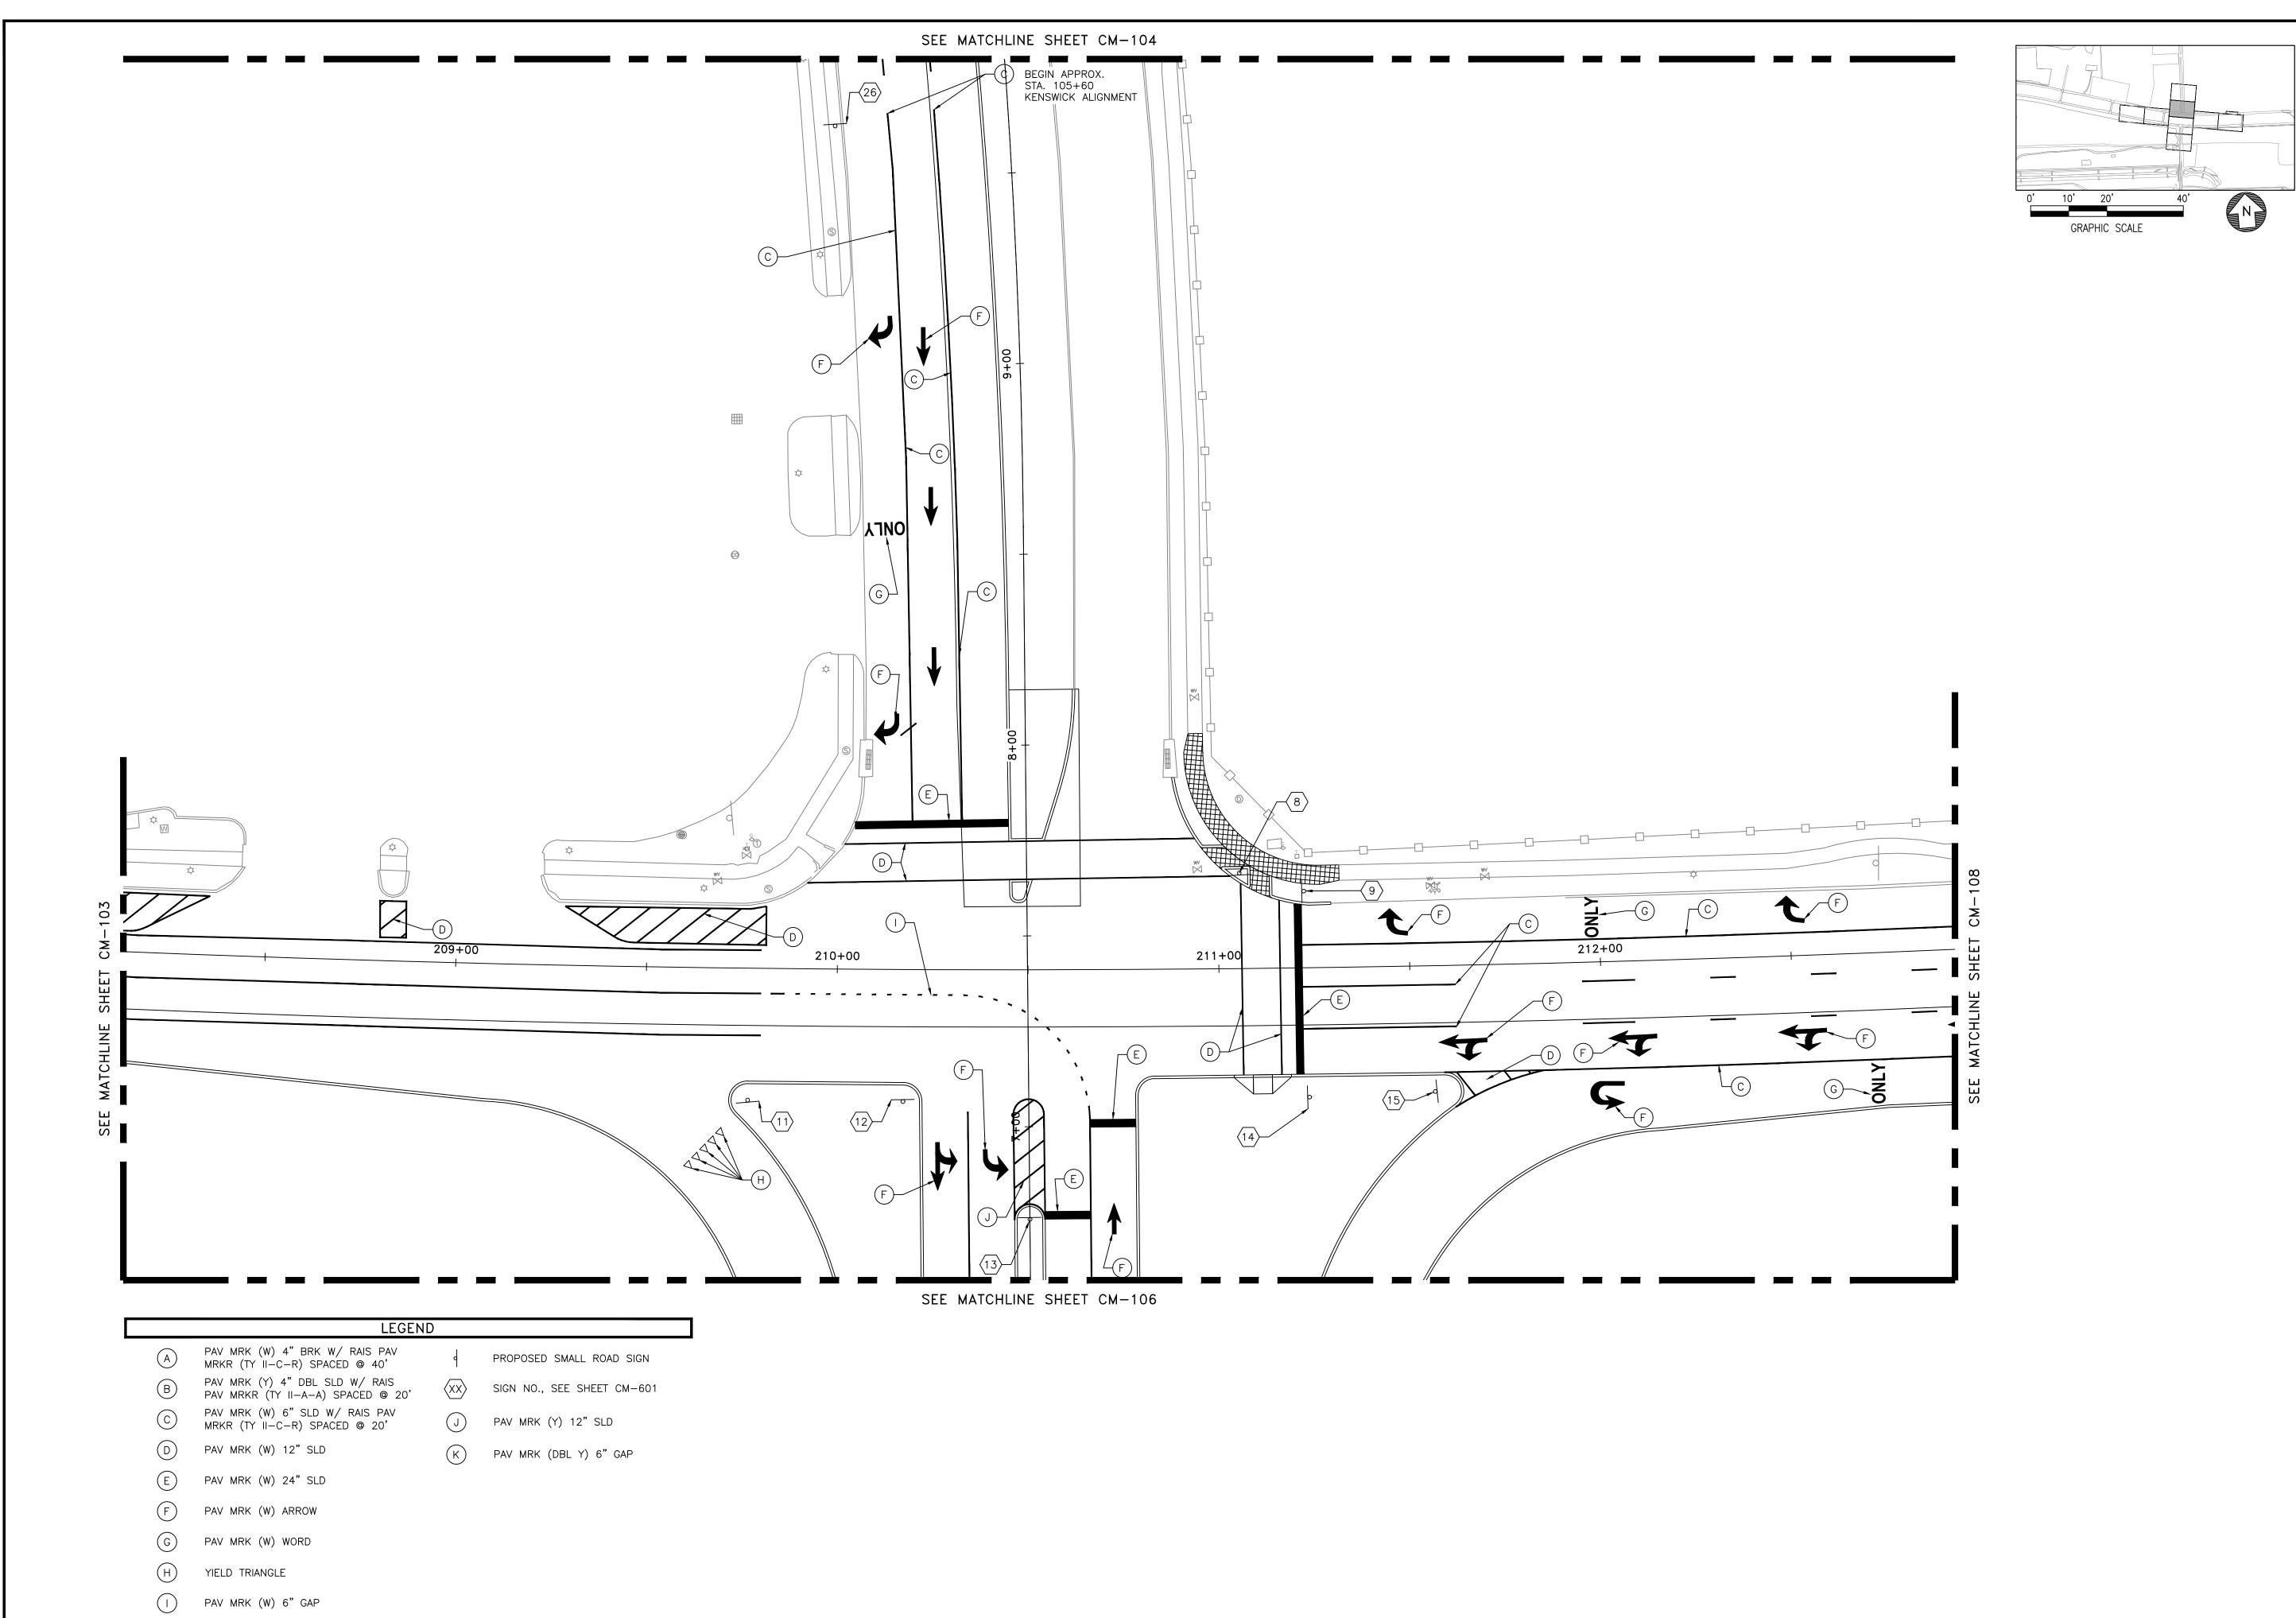

HOUSTON AIRPORT SYSTEM

GEORGE BUSH INTERCONTINENTAL AIRPORT /
HOUSTON, TX

**ATKINS** 

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STE. 400
HOUSTON, TX 77024
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AMERICA PE FIRM REG.
#F-000474

REVISIONS

NO. DESCRIPTION DATE BY

CITY OF HOUSTON
HOUSTON AIRPORTS SYSTEM

Recommended

Busiston Airports System
DATE

Director or Designated Representation

Required Documents submitted for
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EXTENSION
RINGS PLAN

SIGNAGE AND MARKIN

PROJECT MGR: MES

DESIGNER: ALR

DRAWN BY: ALR

CHECK BY: PMW

SCALE:

DATE: 05/08/2024



APPROVED BY:

DIRECTOR HOUSTON AIRPORT SYSTEM

PROJECT NO.

100072032 A.I.P. NO.

C.I.P. NO.

H.A.S. NO.
935
SHEET NO.

GEORGE BUSH INTERCONTINENTAL AIRPORT / HOUSTON, TX

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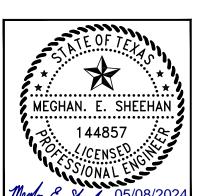
HOUSTON AIRPORT SYSTEM GEORGE BUSH INTERCONTINENTAL AIRPORT / HOUSTON, TX

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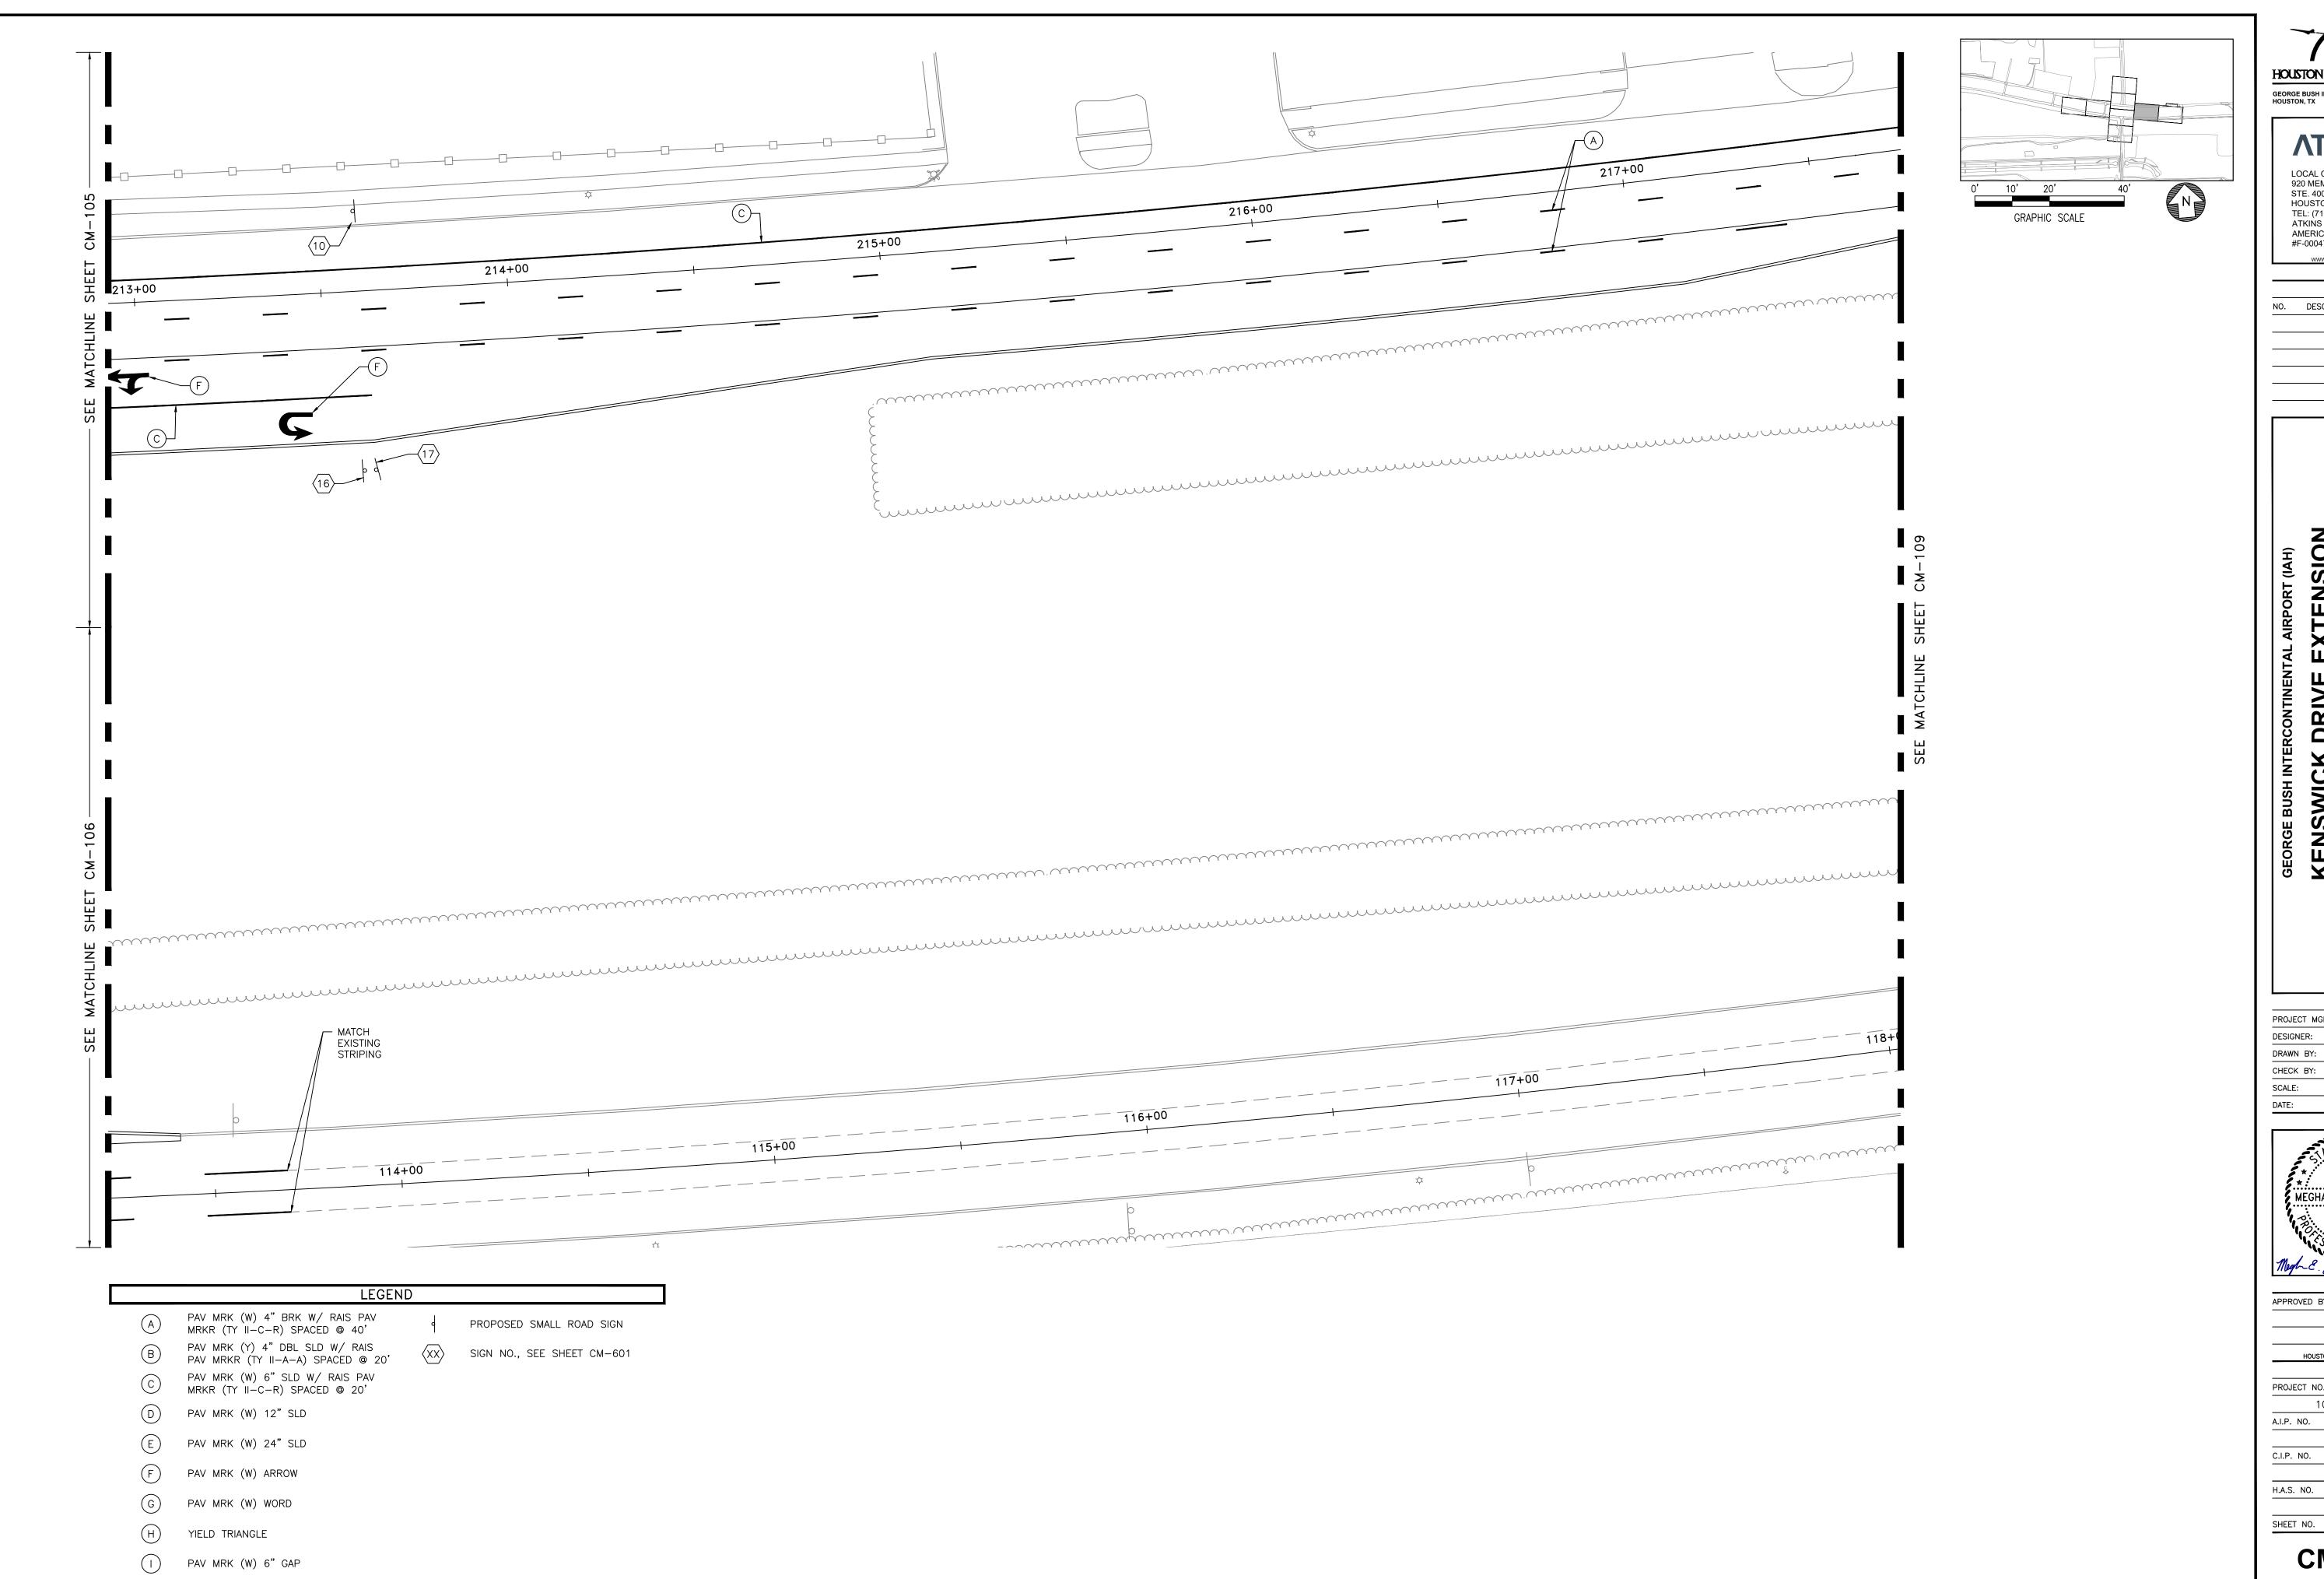
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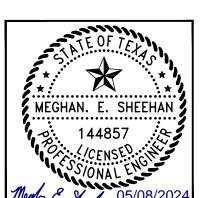
GEORGE BUSH INTERCONTINENTAL AIRPORT / HOUSTON, TX

LOCAL OFFICE: 920 MEMORIAL CITY WAY.

STE. 400 HOUSTON, TX 77024 TEL: (713) 576-8500 ATKINS NORTH AMERICA PE FIRM REG. #F-000474

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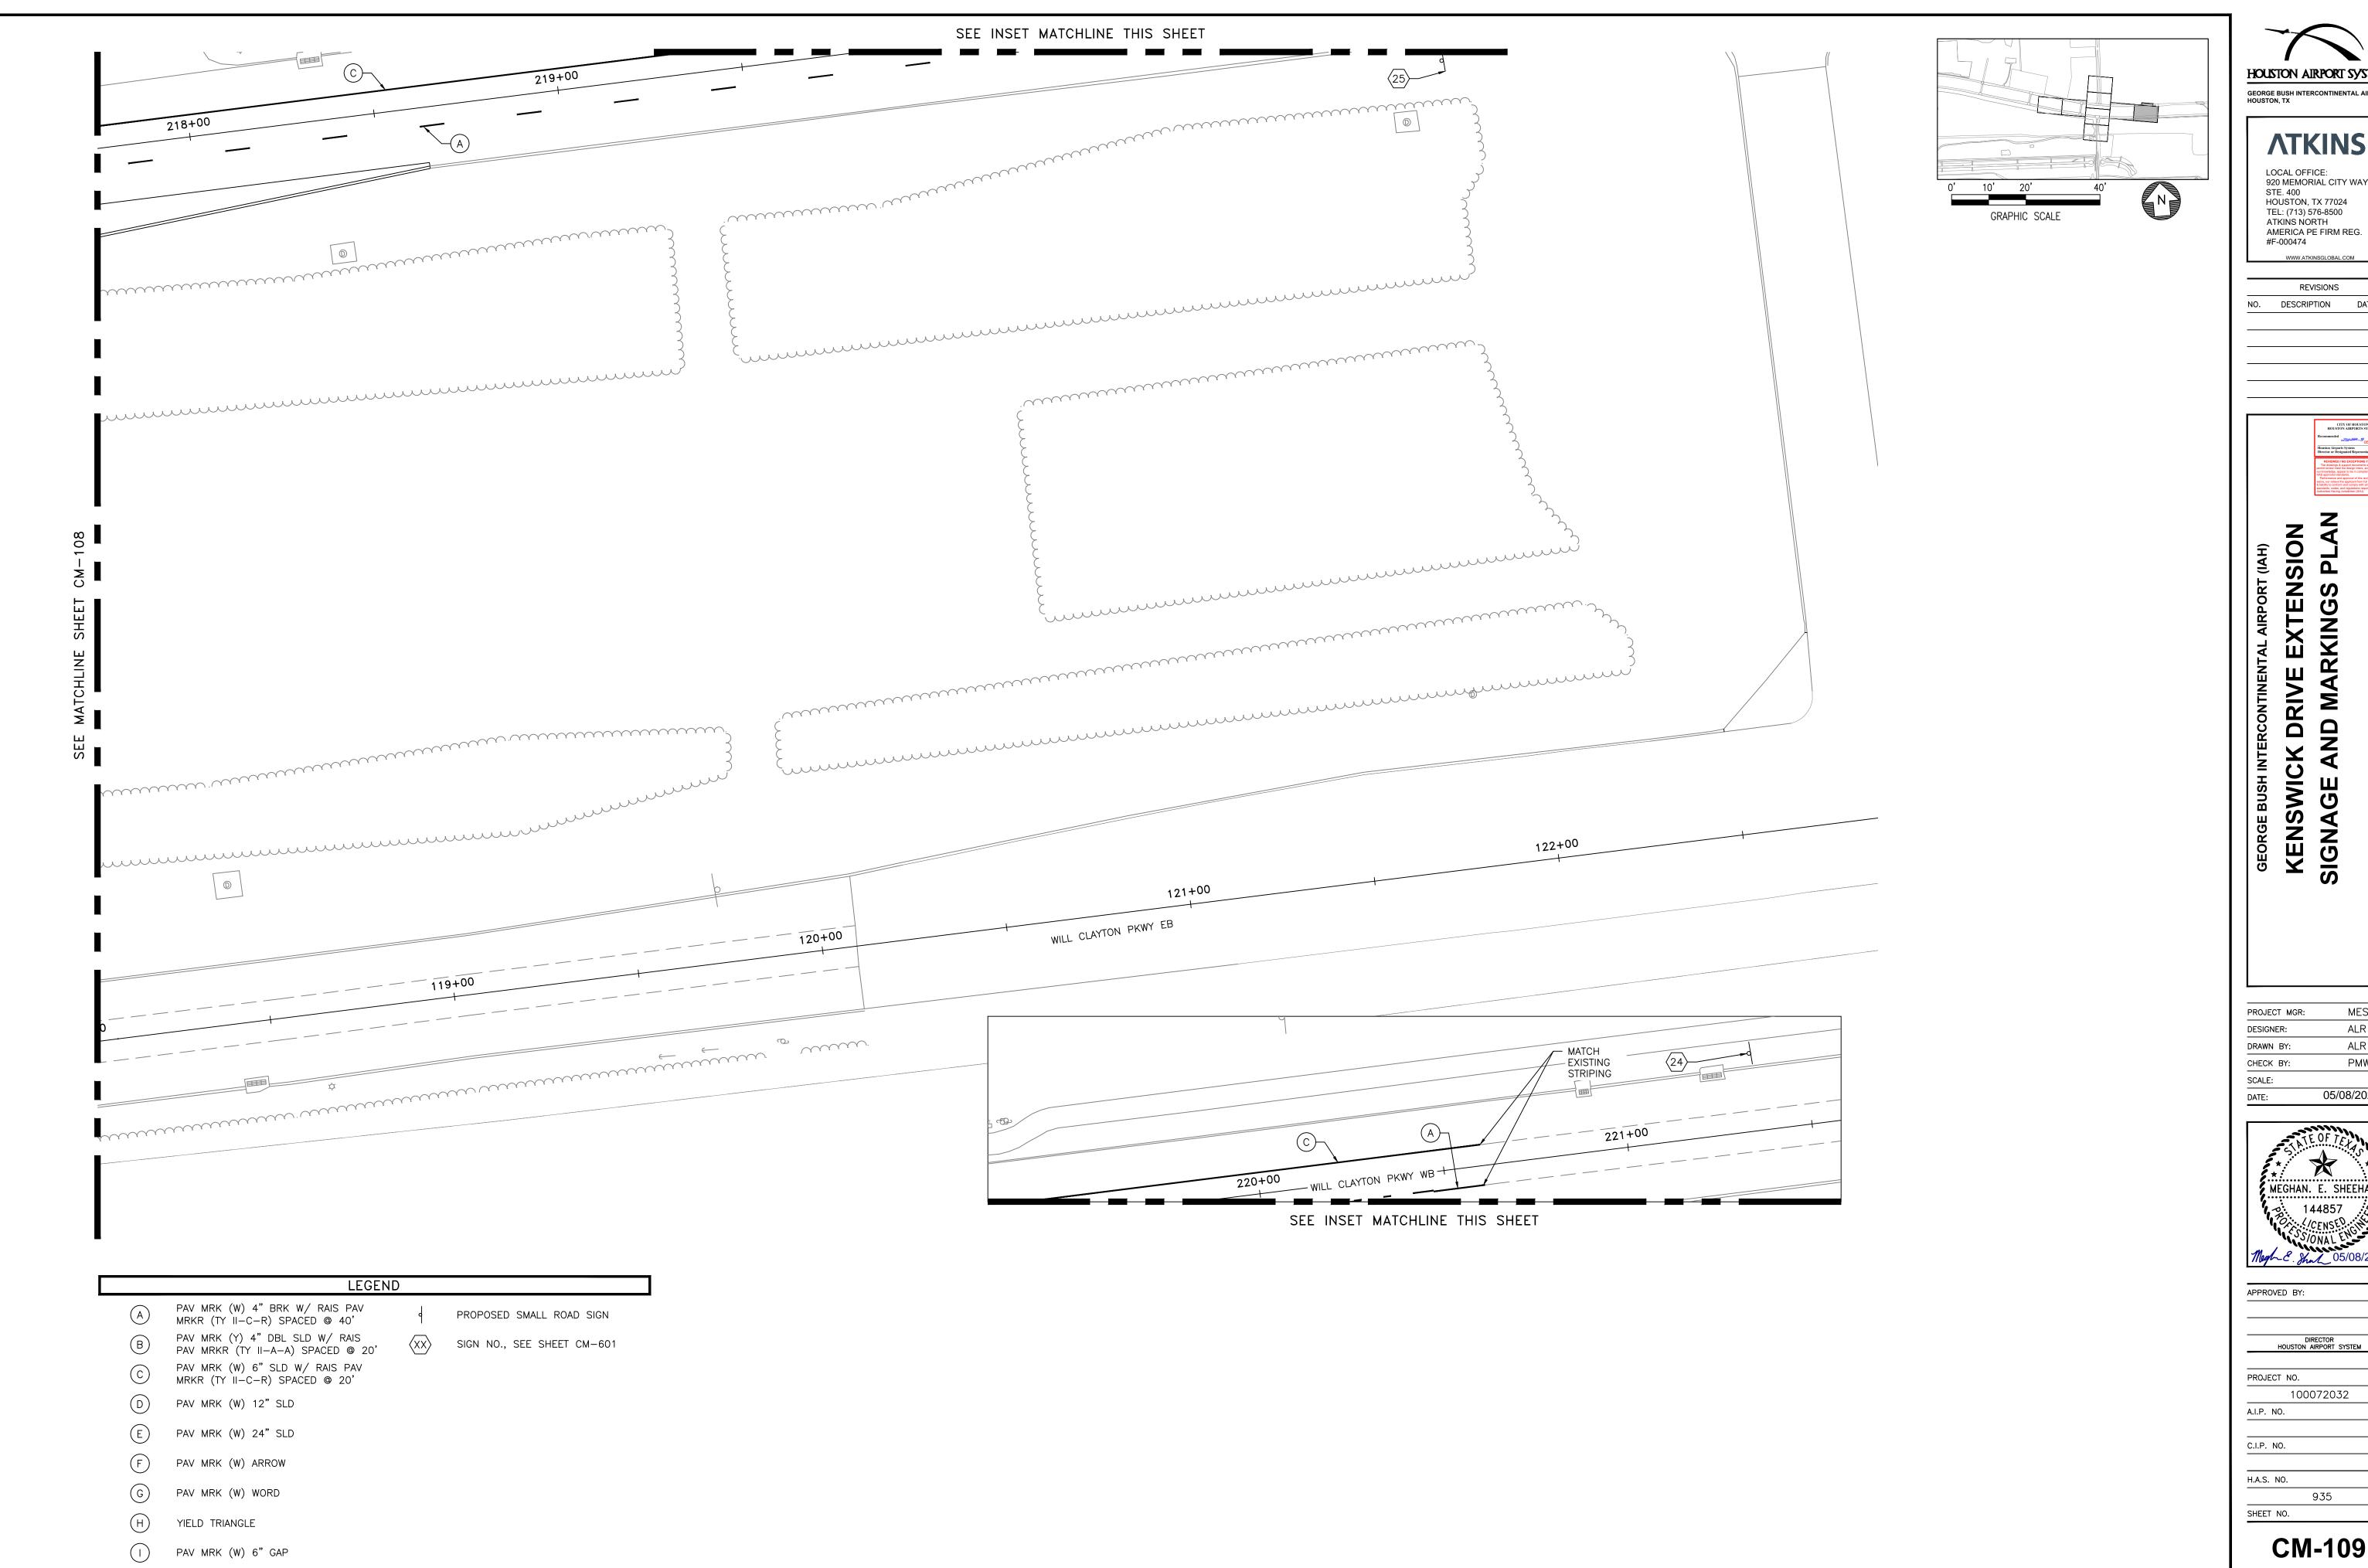


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935

- 1. PRIOR TO START OF CONSTRUCTION, ALL EXISTING PAVEMENT MARKINGS WITHIN THE AREA OF CONSTRUCTION SHALL BE INVENTORIED AND DOCUMENTED JOINTLY BY THE CITY INSPECTOR AND THE CONTRACTOR. THIS DOCUMENT WILL BE JOINTLY SIGNED BY BOTH PARTIES REFLECTING ALL EXISTING PAVEMENT MARKINGS AND LANE CONFIGURATIONS WILL BE DUPLICATED AGAIN. THIS REVIEW CAN BE DONE IN CONJUNCTION WITH SIGN INVENTORY. THE
- CONSTRUCTION PAVEMENT MARKINGS THROUGHOUT THE PROJECT AND AT THE PROJECT'S COMPLETION. 2. ALL PAVEMENT MARKINGS SHALL CONFORM TO CITY OF HOUSTON STANDARDS AND SPECIFICATIONS AND GENERAL GUIDELINES OF THE TEXAS MANUAL ON
- UNIFORM TRAFFIC CONTROL DEVICES (TMUTCD).

  3. THE PERMANENT PAVEMENT MARKINGS MAY BE MODIFIED AS DIRECTED BY

CONTRACTOR IS HELD ACCOUNTABLE FOR EXISTING AND TEMPORARY

- 4. THE DESIGN SPEED FOR THE ROAD IS: ____. THE POSTED SPEED LIMIT
- 5. ALL LANE DIMENSIONS ARE FROM CENTER OF LANE LINE, CENTER OF DOUBLE LANE LINE, FACE OF CURB, OR EDGE OF PAVEMENT UNLESS OTHERWISE NOTED.
  6. THE PAVEMENT MARKING DRAWINGS ARE SCHEMATIC ONLY. THE CONTRACTOR SHALL FOLLOW ALL DIMENSIONS, DETAILS, AND STANDARDS WHEN INSTALLING PAVEMENT MARKINGS AND SYMBOLS.
- 7. THE FINAL LONGITUDINAL STRIPINGS SHALL BE 60 MIL (0.060") THICK HOT-SPRAYED THERMOPLASTIC PLACED OVER THE TEMPORARY STRIPING WITHIN 14 TO 30 CALENDAR DAYS AFTER COMPLETION OF THE FINAL PAVEMENT SURFACE, OR AS DIRECTED BY THE CITY TRAFFIC ENGINEER. ALL OTHER PAVEMENT MARKINGS SHALL BE APPLIED AT THE SAME TIME. TEMPORARY STRIPING SHALL
- BE WATER BASED PAINT.

  8. ALL FINAL TRANSVERSE MARKINGS SHALL BE 90 MIL (0.090") HOT-SPRAYED THERMOPLASTIC. ALL PAVEMENT ARROWS AND LEGENDS SHALL ALSO BE 90 MIL (0.090") HOT-SPRAYED THERMOPLASTIC. PREFORMED THERMOPLASTIC
- APPLICATIONS MAY BE USED IF ONLY APPROVED BY THE CITY TRAFFIC ENGINEER 9. THE CONTRACTOR SHALL BE RESPONSIBLE FOR THE LAYOUT AND INSTALLATION OF PAVEMENT MARKINGS OF FINAL SURFACE COURSE FOLLOWING CONTROL POINTS THAT HAVE BEEN SET NO MORE THAN 50 FEET APART ALONG THE LINES TO BE IMPLEMENTED. IN TANGENT SECTIONS OF A ROAD WHERE THE PAVEMENT MARKING PATTERN DOES NOT CHANGE, CONTROL POINTS CAN BE SET AT 200 FEET SPACING. THE LAYOUT AND INSPECTION OF ALL PAVEMENT MARKINGS SHALL BE APPROVED BY CITY OF HOUSTON REPRESENTATIVE PRIOR TO THE APPLICATION OF MATERIALS.
- 10.IT IS THE CONTRACTOR'S RESPONSIBILITY TO ENSURE THAT THE FINAL SURFACE COURSE IS PLACED SO THAT THE STRIPING IS OFFSET NO MORE THAN ONE FOOT CLEAR OF THE CONSTRUCTION JOINT, UNLESS OTHERWISE DIRECTED BY THE CITY
- TRAFFIC ENGINEER. 11.ALL RAISED PAVEMENT MARKERS (RPMS) SHALL BE INSTALLED SO THAT THE REFLECTIVE FACE OF EACH MARKER IS FACING THE DIRECTION OF TRAFFIC AND IS PERPENDICULAR TO THE DIRECTION OF TRAFFIC FLOW. TYPE C PAVEMENT MARKERS SHALL BE INSTALLED SO THAT THE CLEAR FACE OF EACH MARKER IS
- FACING THE APPROACHING TRAFFIC FLOW AND PERPENDICULAR TO THE DIRECTION OF TRAFFIC FLOW. 12.ALL REMOVAL OF EXISTING PAVEMENT MARKINGS SHALL BE ACCOMPLISHED IN ACCORDANCE TO CITY OF HOUSTON STANDARD SPECIFICATION 02762. APPLYING OVER EXISTING PAVEMENT MARKINGS DOES NOT CONSTITUTE AS APPROVED
- 13.THE ENGINEER OF RECORD SHALL BE REQUIRED TO PRODUCE AS-BUILT OF PAVEMENT MARKING PLANS WITHIN 30 DAYS AFTER COMPLETION OF PAVEMENT
- 14.BLUE RPMS MAY BE PLACED ADJACENT TO FIRE HYDRANTS WITH THE APPROVAL OF THE CITY TRAFFIC ENGINEER.
- 15.FOR ALL CONSTRUCTION, ALL PAVEMENT MARKINGS AND SIGNING SHALL BE INSTALLED AND SHALL BE PAID BY THE PROJECT OWNER/DEVELOPER. 16:FINAL INSPECTION AND ACCEPTANCE OF PAVEMENT MARKINGS SHALL BE PERFORMED BY TRANSPORTATION & DRAINAGE OPERATION REPRESENTATIVE

(713-803-3054).


Description	and Application of Pa	vement Markin	g Lines

Line Series	Color	Description	Width Inches	Typical Applications
WB	White	Broken (10' stripe w/ 30' gap)	4"	Lane lines between travel lanes in the same direction where changing of lanes is permitted.
			4"	- Edge lines to delineate the right edge of the roadway.
			6"	Left edge of bicycle lane and lane lines between travel lanes in the same direction where changing of lanes is discouraged.
ws	White	Solid	12"	- Perpendicular crosswalk lines.
	***************************************		24"	Stop bars at intersections (signalized and unsignalized).
			24	- Hatching at high visibility crosswalks.
			12", 24"	Diagonal hatching used in gores between same direction of travel lanes.
WG	White	Guide (2' stripe w/6' gap)	6"	Guide lines through intersections.     Taper lines for turn lanes.     Guide lines for bicycle lanes.
20	Yellow	Solid	4"	Edge lines to delineate the left edge of a divided roadway, a one-way road, or ramp.
YS	i ellow	Sulu	12", 24"	Diagonal hatching used in gores between opposing direction of travel lanes.
YDS	Yellow	Double Solid	4" - (4") - 4" (gap)	Centerline that separates opposing travel lanes and delineation of median islands.
YDB	Yellow	Double Broken	4" - (4") - 4" (gap)	Defines the edges of center reversible lanes that are used as TWLTLs during intermittent periods.
YB	Yellow	Broken (10' stripe w/ 30' gap)	4"	Separates travel lanes in opposite directions where passing is permitted in both directions of travel.
YB (BIKE)	Yellow	Broken (3' stripe w/ 9' gap)	4"	Separates bicycle travel lanes in opposite directions where passing is permitted in both directions of travel.
YSB	Yellow	Solid & Broken Broken (10' stripe w/ 30' gap)	4" - (4") - 4" (gap)	Separates travel lanes in opposite directions where passing is permitted in one direction and prohibited in the opposite direction.      Used for edge of two-way left-turn lanes (TWLTL).
BICYCLE GREEN	Green	Solid Colored Pavement	Varies	- Ped/Bike crossing - Vehicle / Bike/ Conflict Area
YIELD LINE	White	Triangle	16" x 24"	- Mid-Block crossing.

RRPM Types	Color	COH Spec. Sec. 02764 Equivalent	Description
С	Clear	Type I-C	<ul> <li>Approach face that reflects white light, and the other side does not reflect.</li> </ul>
R	Clear & Red	Type II-C-R	Approach face that reflects white light, and the other side reflects red light.
Α	Amber & Amber	Type II-A-A	- Approach face and the other side both reflect amber light.

RPM spacing RPM type ----RPM spacing CITY OF HOUSTON HOUSTON PUBLIC WORKS GENERAL NOTES AND LECENDS

AND LE	GENUS
	(NOT TO SCALE)
CITY ENGINEER CITY ENGINEER	DIRECTOR OF HOUSTON PUBLIC WORKS
EFF DATE: JUL-01-2018	DWG NO: 01510-01

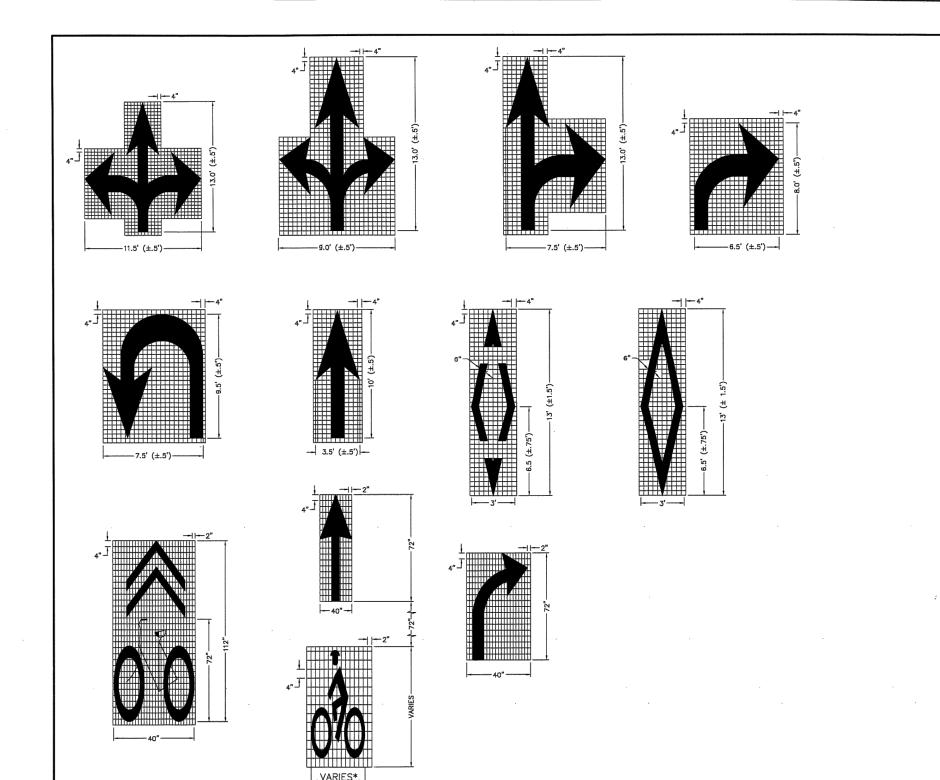



 MINIMUM 8 FOOT WHITE MARKINGS SHALL BE USED, UNLESS OTHERWISE NOTED. IF MESSAGE CONSISTS OF MORE THAN ONE WORD, IT SHOULD BE PLACED WITH FIRST WORD NEAREST THE DRIVER.

- 2. THESE DETAILS ARE STANDARD SIZE FOR NORMAL INSTALLATION; SIZES MAY BE REDUCED APPROXIMATELY ONE—THIRD DEPENDING ON CONDITIONS. SPECIAL PERMISSION NEEDED BY CITY TRAFFIC ENGINEER FOR REDUCTION BELOW ONE-THIRD OF STANDARD SIZES.
- 3. THE LONGITUDINAL SPACE BETWEEN MARKINGS SHOULD BE 30 FEET, OR AS INDICATED ON THE PLANS. 4. MARKINGS CONSIDERED APPROPRIATE FOR USE WHEN
- A. REGULATORY RIGHT (LEFT) TURN ONLY, SYMBOL ARROWS.
- B. WARNING STOP AHEAD SIGNAL AHEAD
- SCHOOL
  SCHOOL X-ING
  PED X-ING
  R X R (SEE SHEET 01510-08 DETAILS) OTHER WORDS OR SYMBOLS MAY BE NECESSARY UNDER CERTAIN CONDITIONS. SPECIAL PERMISSION NEEDED BY CITY TRAFFIC ENGINEER FOR SPECIAL CONDITIONS.
- 5. UNCONTROLLED USE OF PAVEMENT MARKINGS CAN RESULT IN DRIVER CONFUSION. WORD AND SYMBOL MARKINGS SHOULD BE NO MORE THAN THREE LINES. 6. THE WORD "STOP" SHALL NOT BE USED ON THE PAVEMENT
- UNLESS ACCOMPANIED BY A STOP LINE AND STOP SIGN. THE WORD "STOP" SHALL NOT BE PLACED ON THE PAVEMENT IN ADVANCE TO A STOP LINE, UNLESS EVERY VEHICLE IS REQUIRED TO STOP AT ALL TIMES (ALL-WAY STOP). 7. PAVEMENT MARKINGS SHOULD GENERALLY BE NO MORE THAN
- ONE LANE IN WIDTH, WITH SCHOOL MESSAGES BEING THE EXCEPTION. FOR DETAILS OF SCHOOL AND SCHOOL CROSSING PAVEMENT MARKINGS, REFER TO PART VII OF THE "TEXAS MANUAL ON UNIFORM TRAFFIC CONTROL DEVICES".
- SPACING BETWEEN STANDARD SIZE LETTERS SHOULD BE
   INCHES (MIN). THE WIDTH OF NON-STANDARD SIZE LETTERS MAY VARY DEPENDING ON THE WIDTH OF THE TRAVEL LANES.
- APPROVAL BY CITY TRAFFIC ENGINEER. SPECIAL PERMISSION
  NEEDED FOR NON-STANDARD SIZE "LETTER" AND/OR "ARROWS". 9. LANE-USE ARROW MARKINGS MAY BE USED TO CONVEY EITHER GUIDANCE OR MANDATORY MESSAGES. SINGLE TURN ARROWS
- USED TO CONVEY A MANDATORY MOVEMENT MUST BE ACCOMPANIED STANDARD SIGNS AND THE PAVEMENT MARKING WORD "ONLY". 10. PAVEMENT MARKINGS ARE TO BE LOCATED AS SPECIFIED

IN THE DESIGN PLANS.	
	HOUSTON JBLIC WORKS
STANDARD MARKING —	
CHY TRAFFIC ENGINEER  CITY ENGINEER  CITY ENGINEER	DIRECTOR OF HOUSTON PUBLIC WORKS

EFF DATE: JUL-01-2018 DWG NO: 01510-04

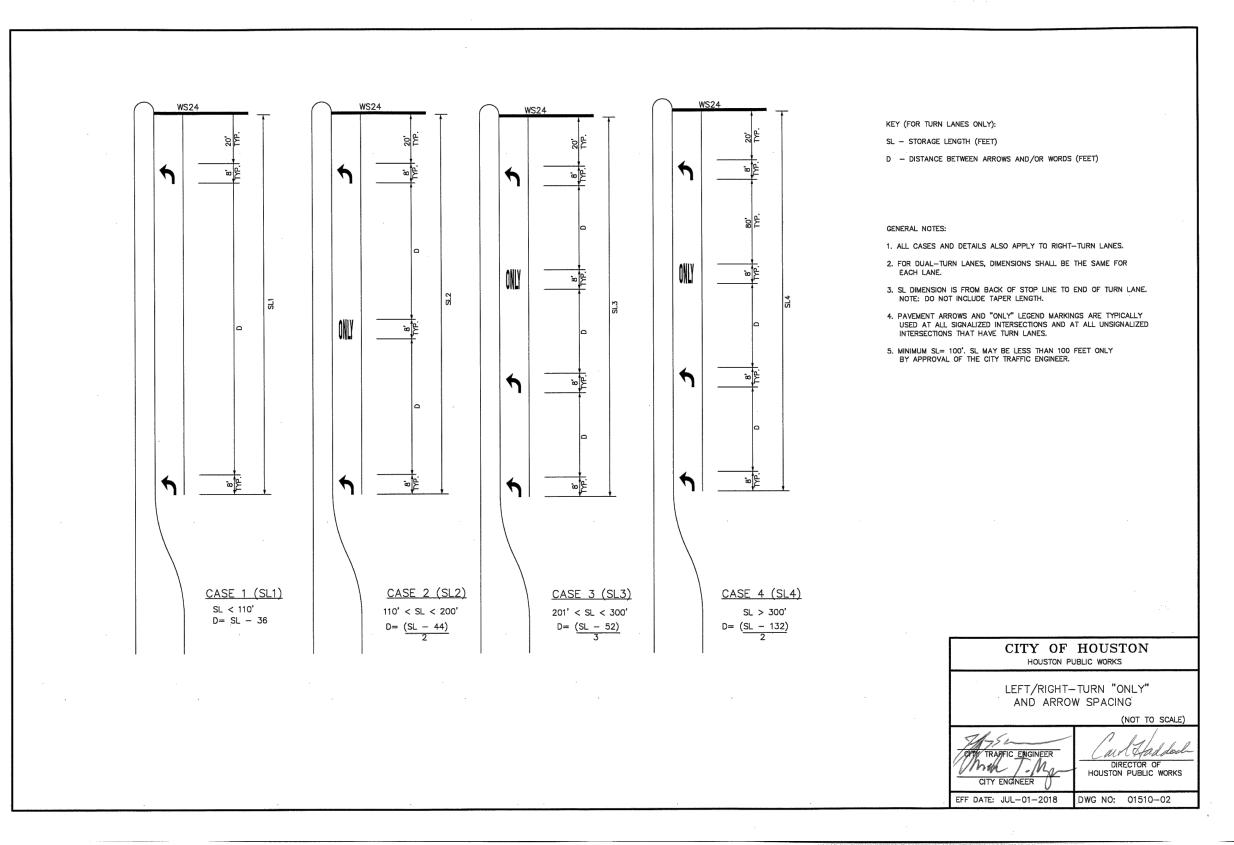

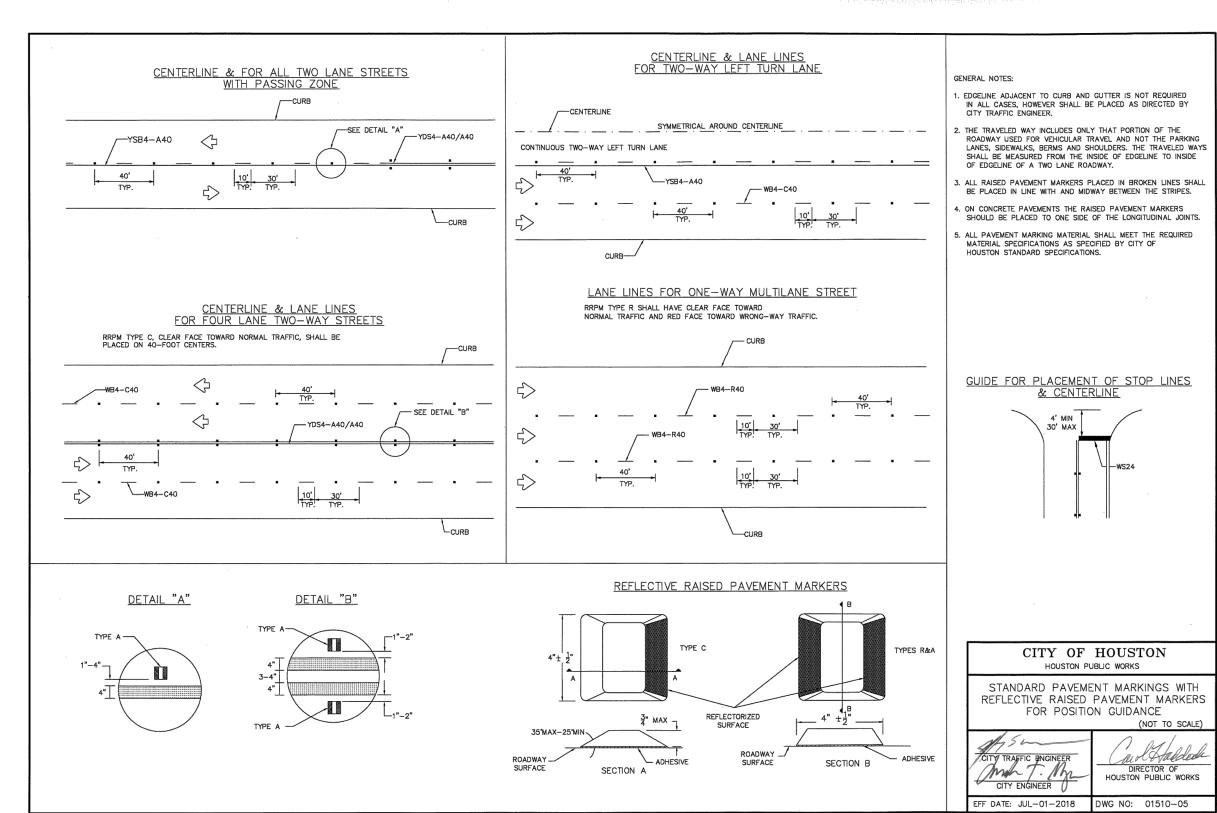




**ATKINS** 

LOCAL OFFICE:

200 WESTLAKE PARK BLVD., STE, 1100 HOUSTON, TX 77079 TEL: (713) 576-8500 ATKINS NORTH AMERICA PE FIRM REG. #F-000474

REVISIONS NO. DESCRIPTION DATE BY

MES PROJECT MGR: ALR DESIGNER: ALR DRAWN BY: CHECK BY: PMWSCALE: 05/08/2024 DATE:

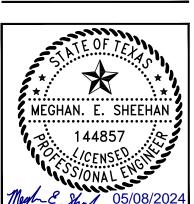

APPROVED BY:

DIRECTOR HOUSTON AIRPORT SYSTEM


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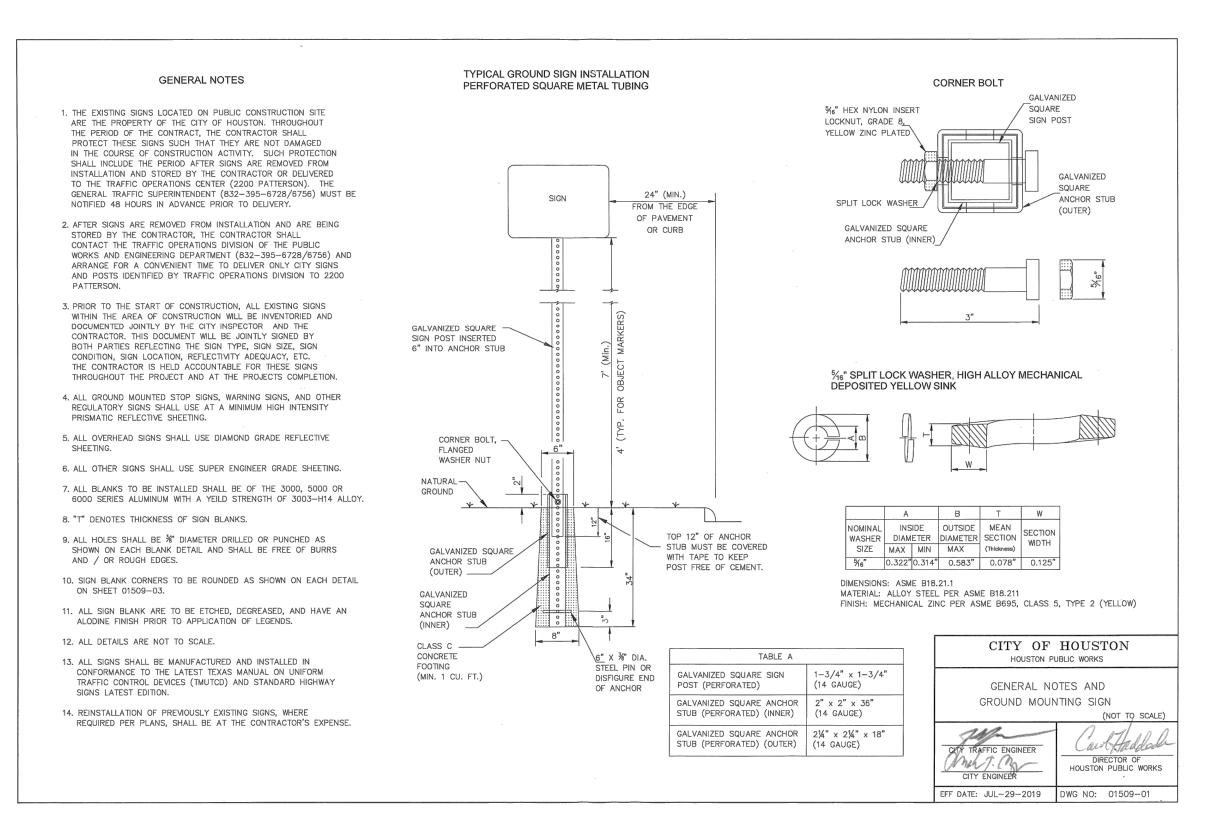
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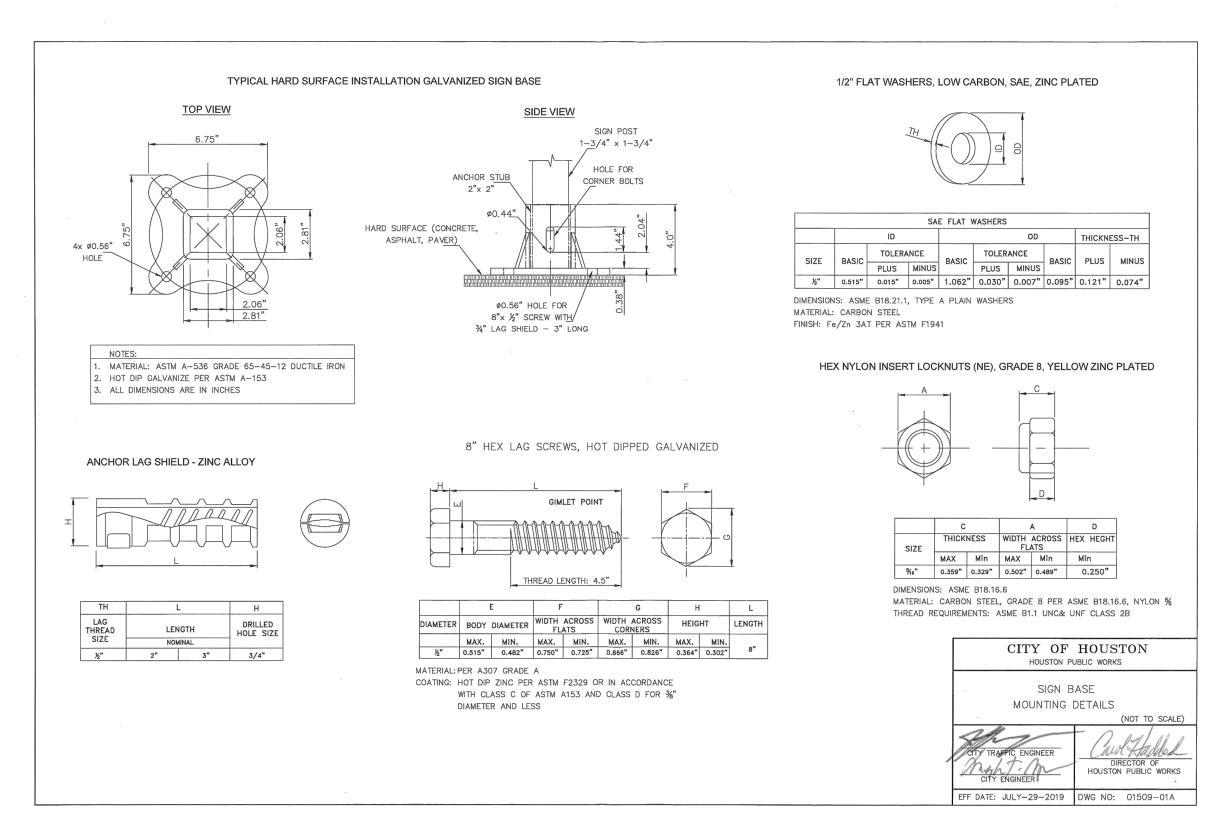
C.I.P. NO. H.A.S. NO.

SHEET NO. CM-501

935





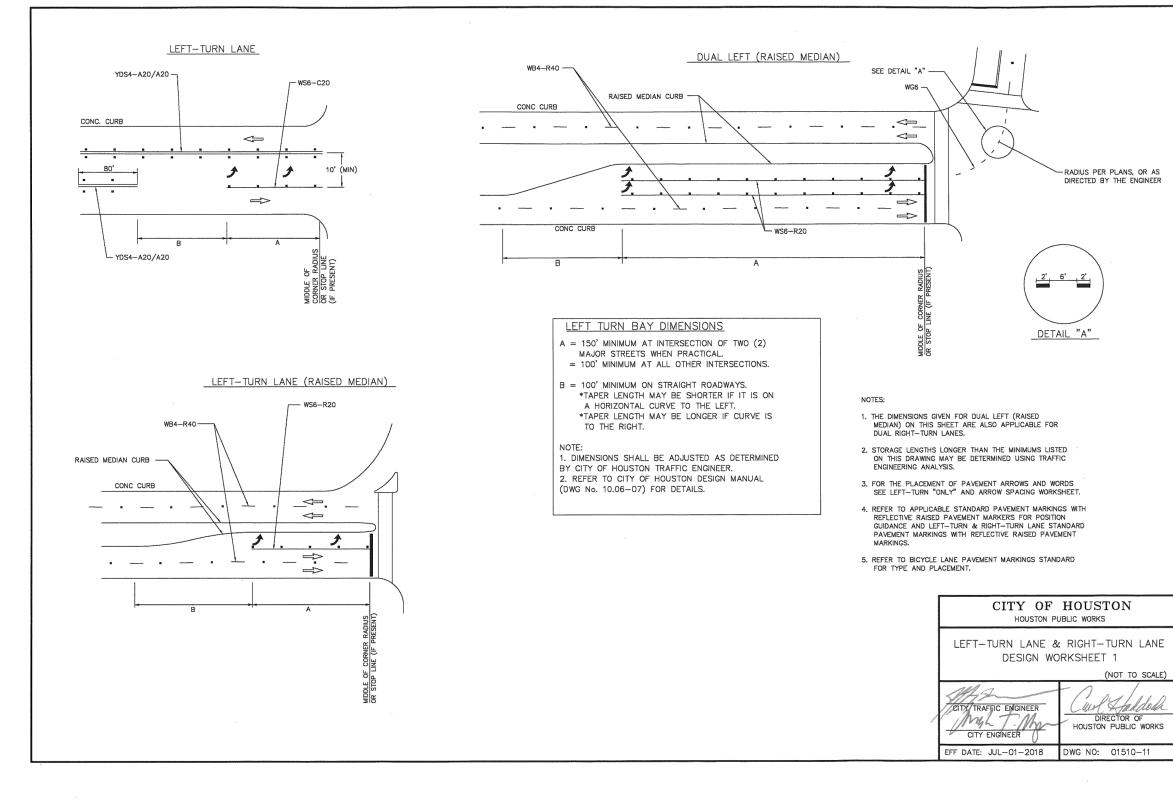



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#F-000474

REVISIONS

NO. DESCRIPTION DATE BY

HOLSTON HOLSTON
HOLSTON AIRPORTS SYSTEM
Recommended

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EXTENSION INGS DETAIL

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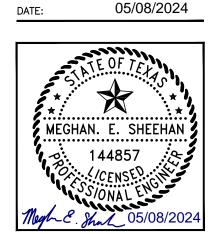
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DRAWN BY: ALR

CHECK BY: PMW

SCALE:



APPROVED BY:

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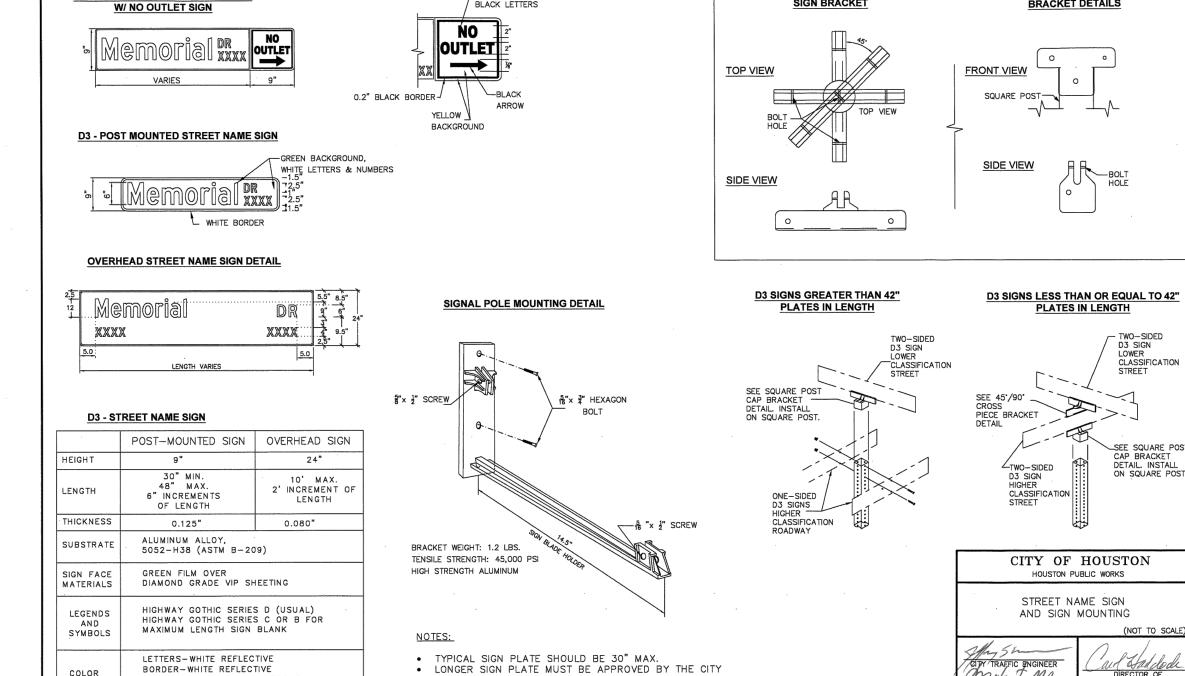
DIRECTOR HOUSTON AIRPORT SYSTEM
PROJECT NO.

100072032 A.I.P. NO.

C.I.P. NO.

SHEET NO.

H.A.S. NO. 935



BLACK LETTERS

POST MOUNTED STREET NAME SIGN

COLOR

BACKGROUND-GREEN REFLECTIVE

45°/90° CROSS PIECE

SIGN BRACKET


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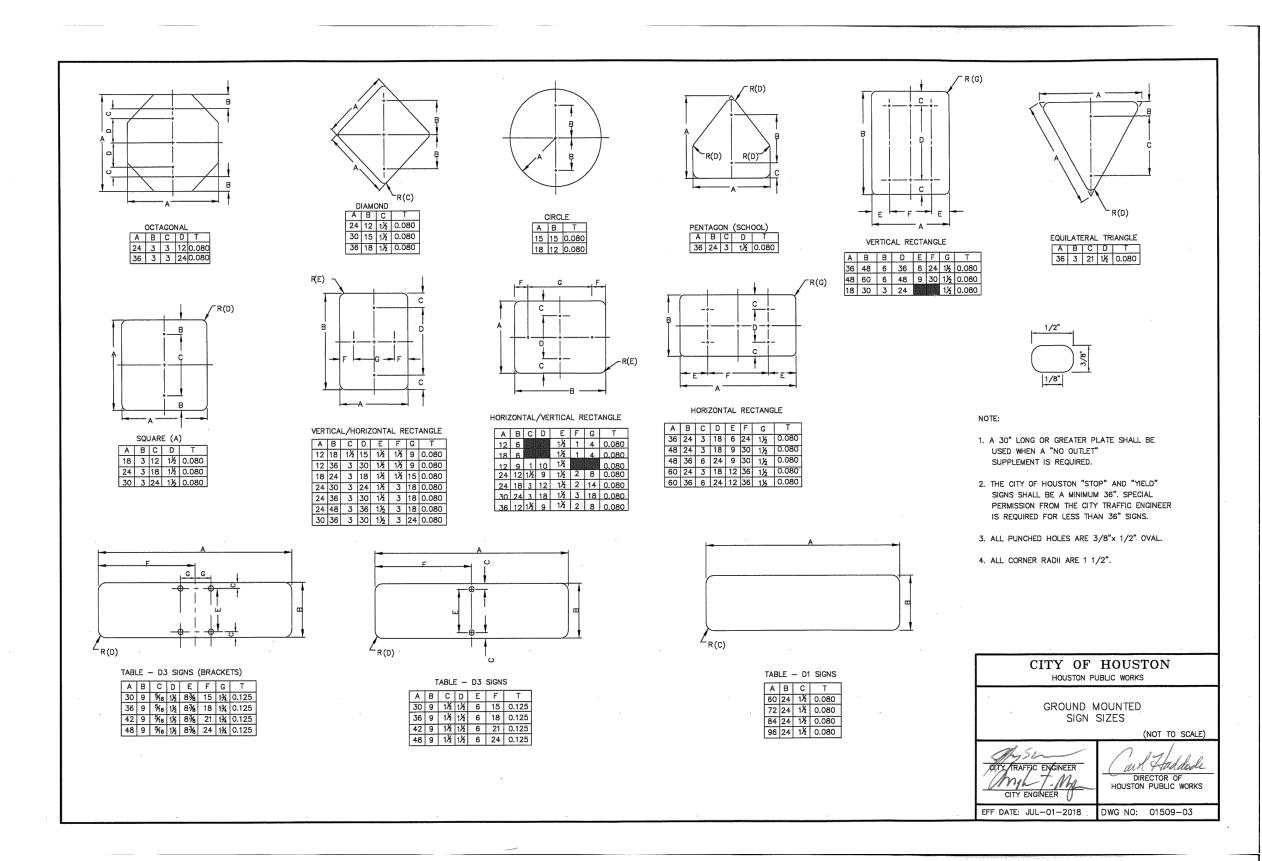
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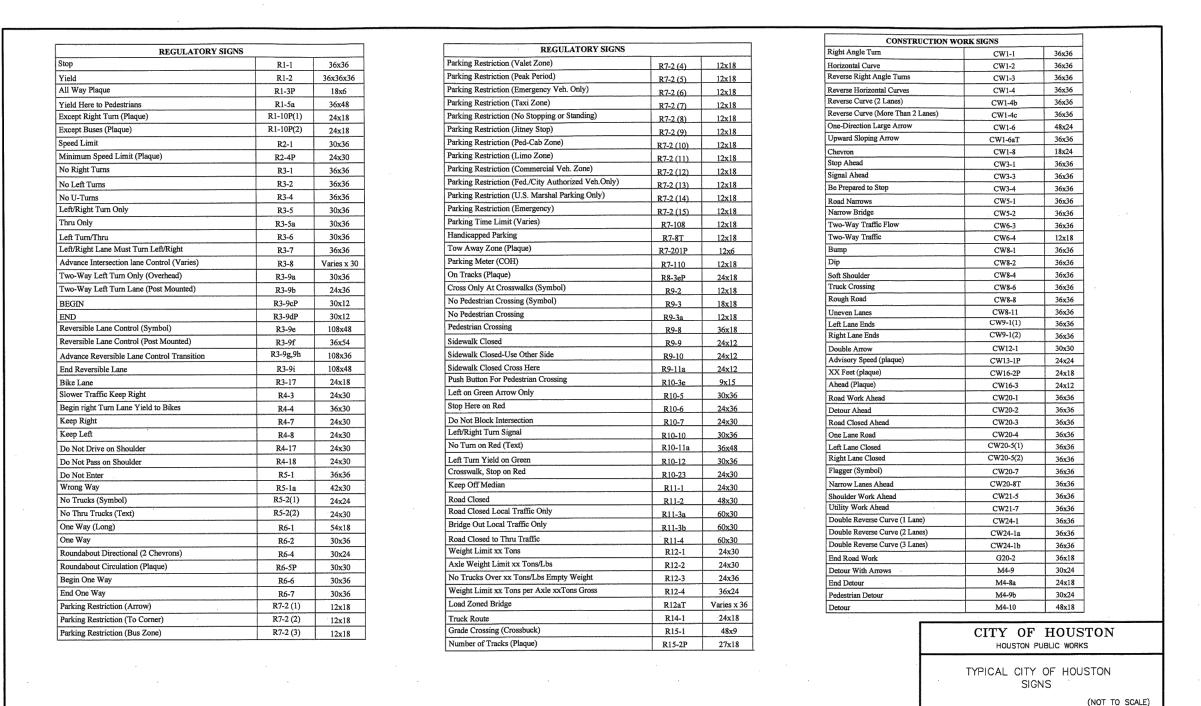
CITY TRAFFIC ENGINEER

CITY ENGINEER

HOUSTON PUBLIC WORKS





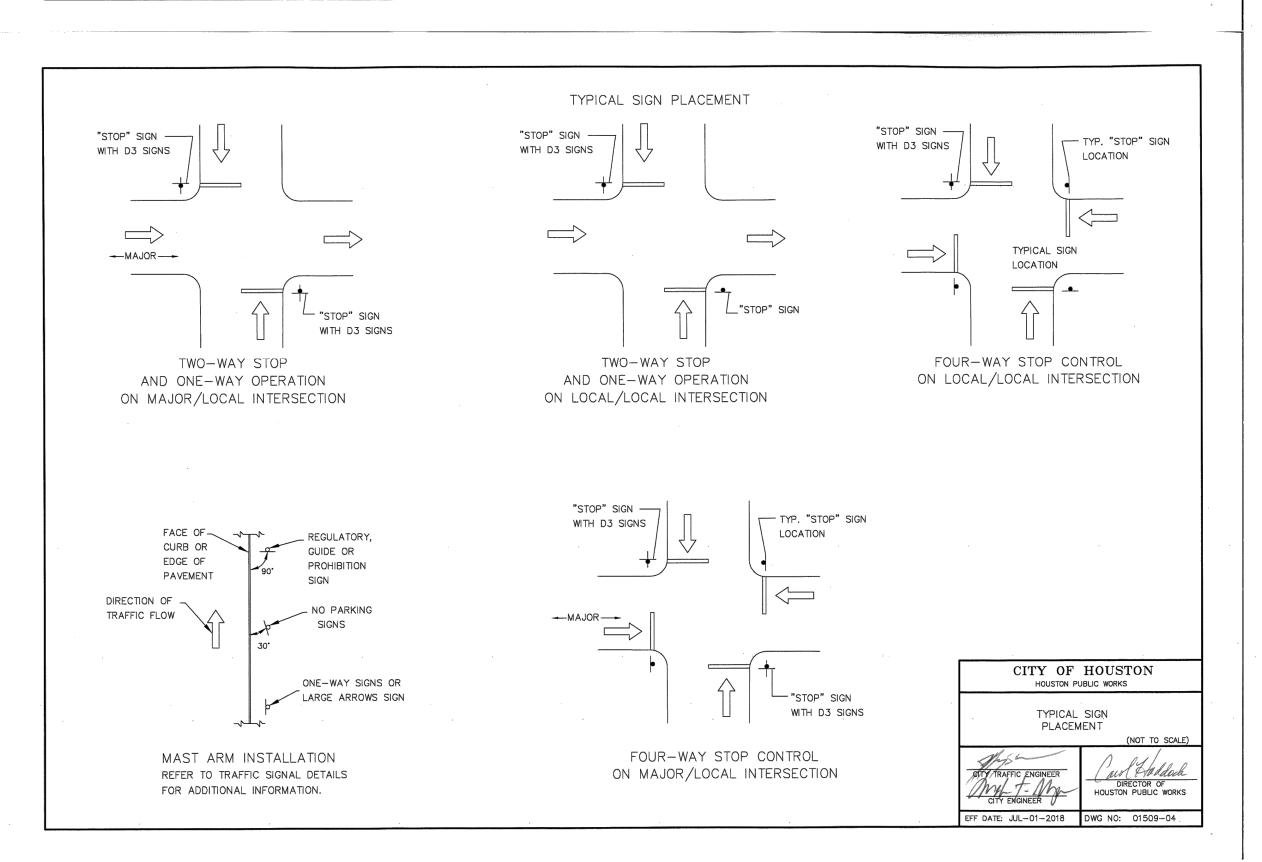

CITY TRAFFIC ENGINEER

CITY ENGINEER

EFF DATE: JUL-01-2018 DWG NO: 01509-05

DIRECTOR OF HOUSTON PUBLIC WORKS



**ATKINS** 

LOCAL OFFICE: 920 MEMORIAL CITY WAY. STE, 400 HOUSTON, TX 77024 TEL: (713) 576-8500 ATKINS NORTH AMERICA PE FIRM REG.

#F-000474

REVISIONS NO. DESCRIPTION DATE BY

MES PROJECT MGR: ALR DESIGNER:

ALR

PMW

SCALE: 05/08/2024 DATE: MEGHAN. E. SHEEHAN 144857

Magh & Shul 05/08/2024

APPROVED BY:

DRAWN BY:

CHECK BY:

HOUSTON AIRPORT SYSTEM

PROJECT NO. 100072032

A.I.P. NO.

C.I.P. NO. H.A.S. NO.

935 SHEET NO.

WARNING SIGNS		
Right Angle Turn Curve	W1-1	30x30
Right Angle Turn With Speed Limit	W1-1a	36x36
Horizontal Curve	W1-2	30x30
Horizontal Curve With Speed Limit	W1-2a	36x36
Reverse Right Angle Turn	W1-3	30x30
Reverese Horizontal Curve	W1-4	30x30
Winding Road	W1-5	30x30
One Direction Large Arrow	W1-6	48x24
Two Direction Large Arrow	W1-7	48x24
Chevron Alignment	W1-8	18x24
Hairpin Curve	W1-11	30x30
Truck Rollover	W1-13	36x36
Cross Road	W2-1	30x30
Side Street T-Intersection (Symbol)	W2-2	30x30
T-Intersection (Symbol)	W2-4	30x30
Y-Intersection (Symbol)	W2-5	30x30
Roundabout (Symbol)	W2-6	30x30
Stop Ahead	W3-1	30x30
Signal Ahead	W3-3	30x30
Reduced Speed Limit Ahead	W3-5	36x36
Merge	W4-1	36x36
Lane Ends	W4-2	36x36
Added Lane	W4-3	36x36
Cross Traffic Does Not Stop (Plaque)	W4-4P	24x12
Road Narrows	W5-1	36x36
Narrow Bridge	W5-2	36x36
Divided Highway	W6-1	36x36
Divided Highway Ends	W6-2	36x36
Two Way Traffic (Symbol)	W6-3	36x36
Bump	W8-1	30x30
Dip	W8-2	30x30
Pavement Ends	W8-3	36x36
Soft Shoulder	W8-4	36x36
Truck Crossing	W8-6	36x36
Loose Gravel	W8-7	36x36
Rough Road	W8-8	36x36
Uneven Lanes	W8-11	36x36
Watch for ICE on Bridge	W8-13T	36x36
Shoulder Drop-Off (Symbol)	W8-17	30x30
Shoulder Drop-Off (Plaque)	W8-17P	24x18

WARNING SIG	INS	
Flood Gauge	W8-19	12x72
No Shoulder	W8-23	36x36
Shoulder Ends	W8-25	36x30
Left Lane Ends	W9-1(1)	36x36
Right Lane Ends	W9-1(2)	36x36
Lane Ends Merge Left	W9-2(1)	36x3
Lane Ends Merge Right	W9-2(2)	36x3
Grade Crossing Advance Warning	W10-1	30Di
No Train Horn	W10-9	36x3
No Train Horn (Plaque)	W10-9P	30x2
Bicycle	W11-1	30x3
Pedestrian	W11-2	36x3
Emergency Vehicle	W11-8	30x3
Handicapped	W11-9	30x3
Truck	W11-10	30x3
Emergency Signal Ahead (Plaque)	W11-12P	36x3
Bicycle/Pedestrian	W11-15	30x3
Trail Crossing (Plaque)	W11-15P	24x1
Double Arrow	W12-1	30x3
Low Clearance With Arrows	W12-2	36x3
Low Clearance	W12-2a	78x2
Loaded Zoned Bridge	W12-5T	36x3
Advisory Speed (Plaque)	W13-1P	18x1
No Outlet	W14-2	24x2
No Outlet With Arrow	W14-2a	36x
Share the Road (Plaque)	W16-1P	18x2
xx Feet (Plaque)	W16-2P	24x1
Next xx Feet (Plaque)	W16-4P	30x2
Supplemental Left Arrow (Plaque)	W16-5P(1)	24x1
Supplemental Right Arrow (Plaque)	W16-5P(2)	24x1
Diagonal Arrow (Plaque)	W16-7P	24x1
Ahead (Plaque)	W16-9P	24x1
When Flashing (Plaque)	W16-13P	24x1
Roundabout (Plaque)	W16-17	24x1
Speed Hump	W17-1	30x3
Type 3 Object Marker (Left)	OM3-L	12x3
Type 3 Object Marker (Right)	OM3-R	12x3
Type 3 Object Marker (Center)	ОМ3-С	12x3
Type 4 Object Marker	OM4-1	18x1

BICYCLE SIGNS		
Stop	R1 -1	18x18
Street Name	D3- 1	varies x 6
Yield	R1-2	18x18x18
To Request Green Wait on Symbol	R10- 22	12x18
Yield to Pedestrian	R9- 6	18x18
No Parking Bike Lane	R7 - 9	12x18
Bike Route	D11-1	24x18
Bike Route to Downtown	D11-1c	24x18
Bike Sign Auxiliary Signs	M4-1, - M4-14	12x6
Bicycle Route Route Arrow Signs	M5-1,2; M6-1,2,3,4,5,6,7	12x9
Walk Your Bike (custom sign)	R9 - 8 CoH	12x18
Yield To Ped /Bike (custom sign)	R1 - 5 PB	36x36
Turning Vehicles Yield to Ped/Bike (custom sign)	R10 - 15 PB	36x36

OOL SIGNS	
S1-1 (FYG)	36x36
\$4-1P	24x10
S4-3P (FYG)	24x8
S4-4P	24x10
S4-5a (FYG)	36x36
S5-1 (FYG)	24x48
S5-2	24x30
S5-2aTP	24x10
S7-1T	24x18
SW16-5P (FYG)	24x12
SW16-6P (FYG)	24x12
SW16-7P (FYG)	24x12
S16-9P (FYG)	24x12
	\$1-1 (FYG) \$4-1P \$4-3P (FYG) \$4-4P \$4-5a (FYG) \$5-1 (FYG) \$5-2 \$5-2aTP \$7-1T \$W16-5P (FYG) \$W16-6P (FYG) \$W16-7P (FYG)

CITY OF HOUSTON
HOUSTON PUBLIC WORKS

TYPICAL CITY OF HOUSTON
SIGNS

(NOT TO SCALE)

OTHER TO STAND PUBLIC WORKS

EFF DATE: JUL-01-2018 DWG NO: 01509-06



**ATKINS** 

LOCAL OFFICE:
920 MEMORIAL CITY WAY.
STE. 400
HOUSTON, TX 77024
TEL: (713) 576-8500
ATKINS NORTH
AMERICA PE FIRM REG.
#F-000474

REVISIONS

NO. DESCRIPTION DATE BY

CITY OF HOLSTON
HOLSTON SYSTEM
Recommended

SCOGP2024
Houston Airport's System
DATE
Director or Designated Representative
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TENSION 3S DETAILS

NAGE AND MARKING

PROJECT MGR: MES


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DRAWN BY: ALR

CHECK BY: PMW

SCALE:

DATE: 05/08/2024

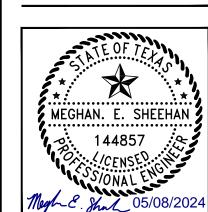

APPROVED BY:

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DIRECTOR HOUSTON AIRPORT SYSTEM

PROJECT NO.

100072032

A.I.P. NO.

C.I.P. NO.

H.A.S. NO.

SHEET NO.



920 MEMORIAL CITY WAY. STE. 400 HOUSTON, TX 77024 TEL: (713) 576-8500 ATKINS NORTH AMERICA PE FIRM REG. #F-000474

REVISIONS NO. DESCRIPTION DATE BY

MES PROJECT MGR: ALR DESIGNER: ALR DRAWN BY: CHECK BY: PMWSCALE: 05/08/2024



APPROVED BY:

DATE:


DIRECTOR HOUSTON AIRPORT SYSTEM


PROJECT NO.

100072032 A.I.P. NO.

C.I.P. NO. H.A.S. NO.

935 SHEET NO.

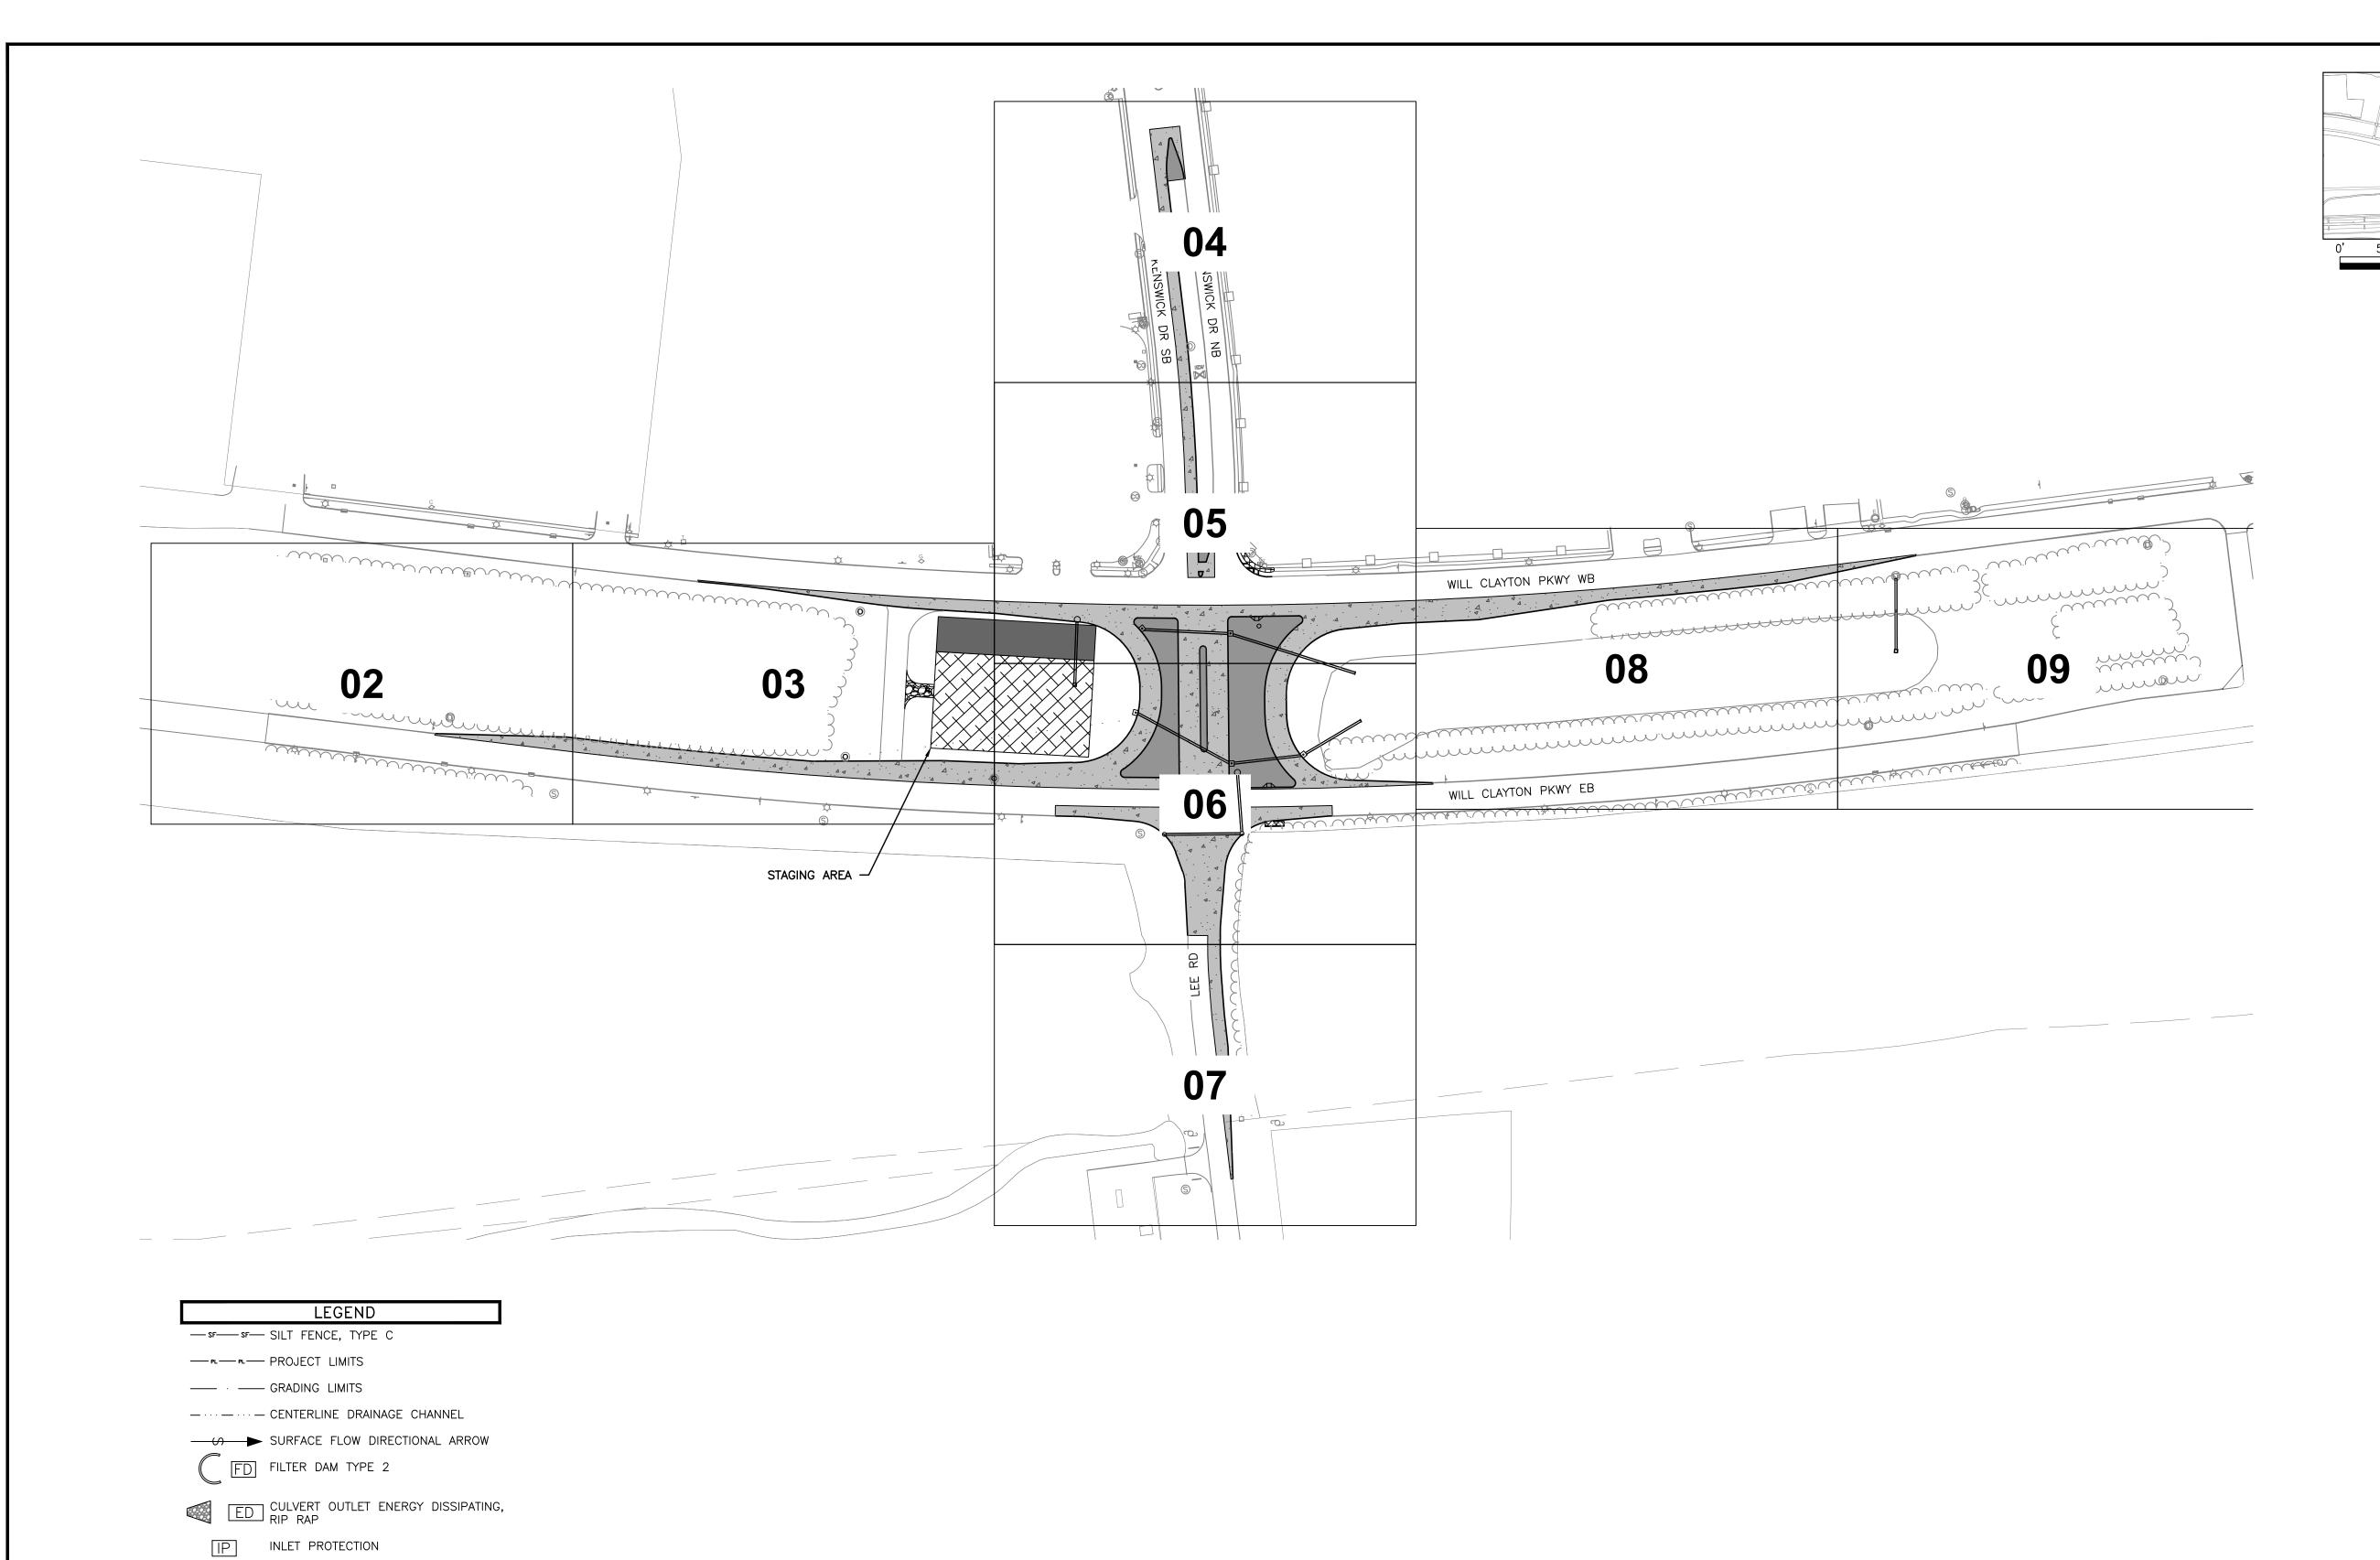


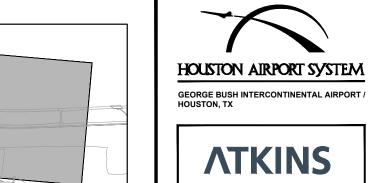

LOCAL OFFICE: 200 WESTLAKE PARK BLVD., STE. 1100 HOUSTON, TX 77079 TEL: (713) 576-8500 ATKINS NORTH AMERICA PE FIRM REG. #F-000474

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PROJECT MGR:	MES
DESIGNER:	ALR
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SCALE:	
DATE:	05/08/2024

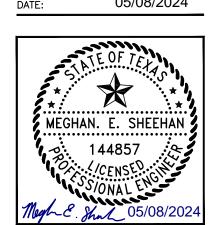

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DIRECTOR HOUSTON AIRPORT SYSTEM

PROJECT NO.

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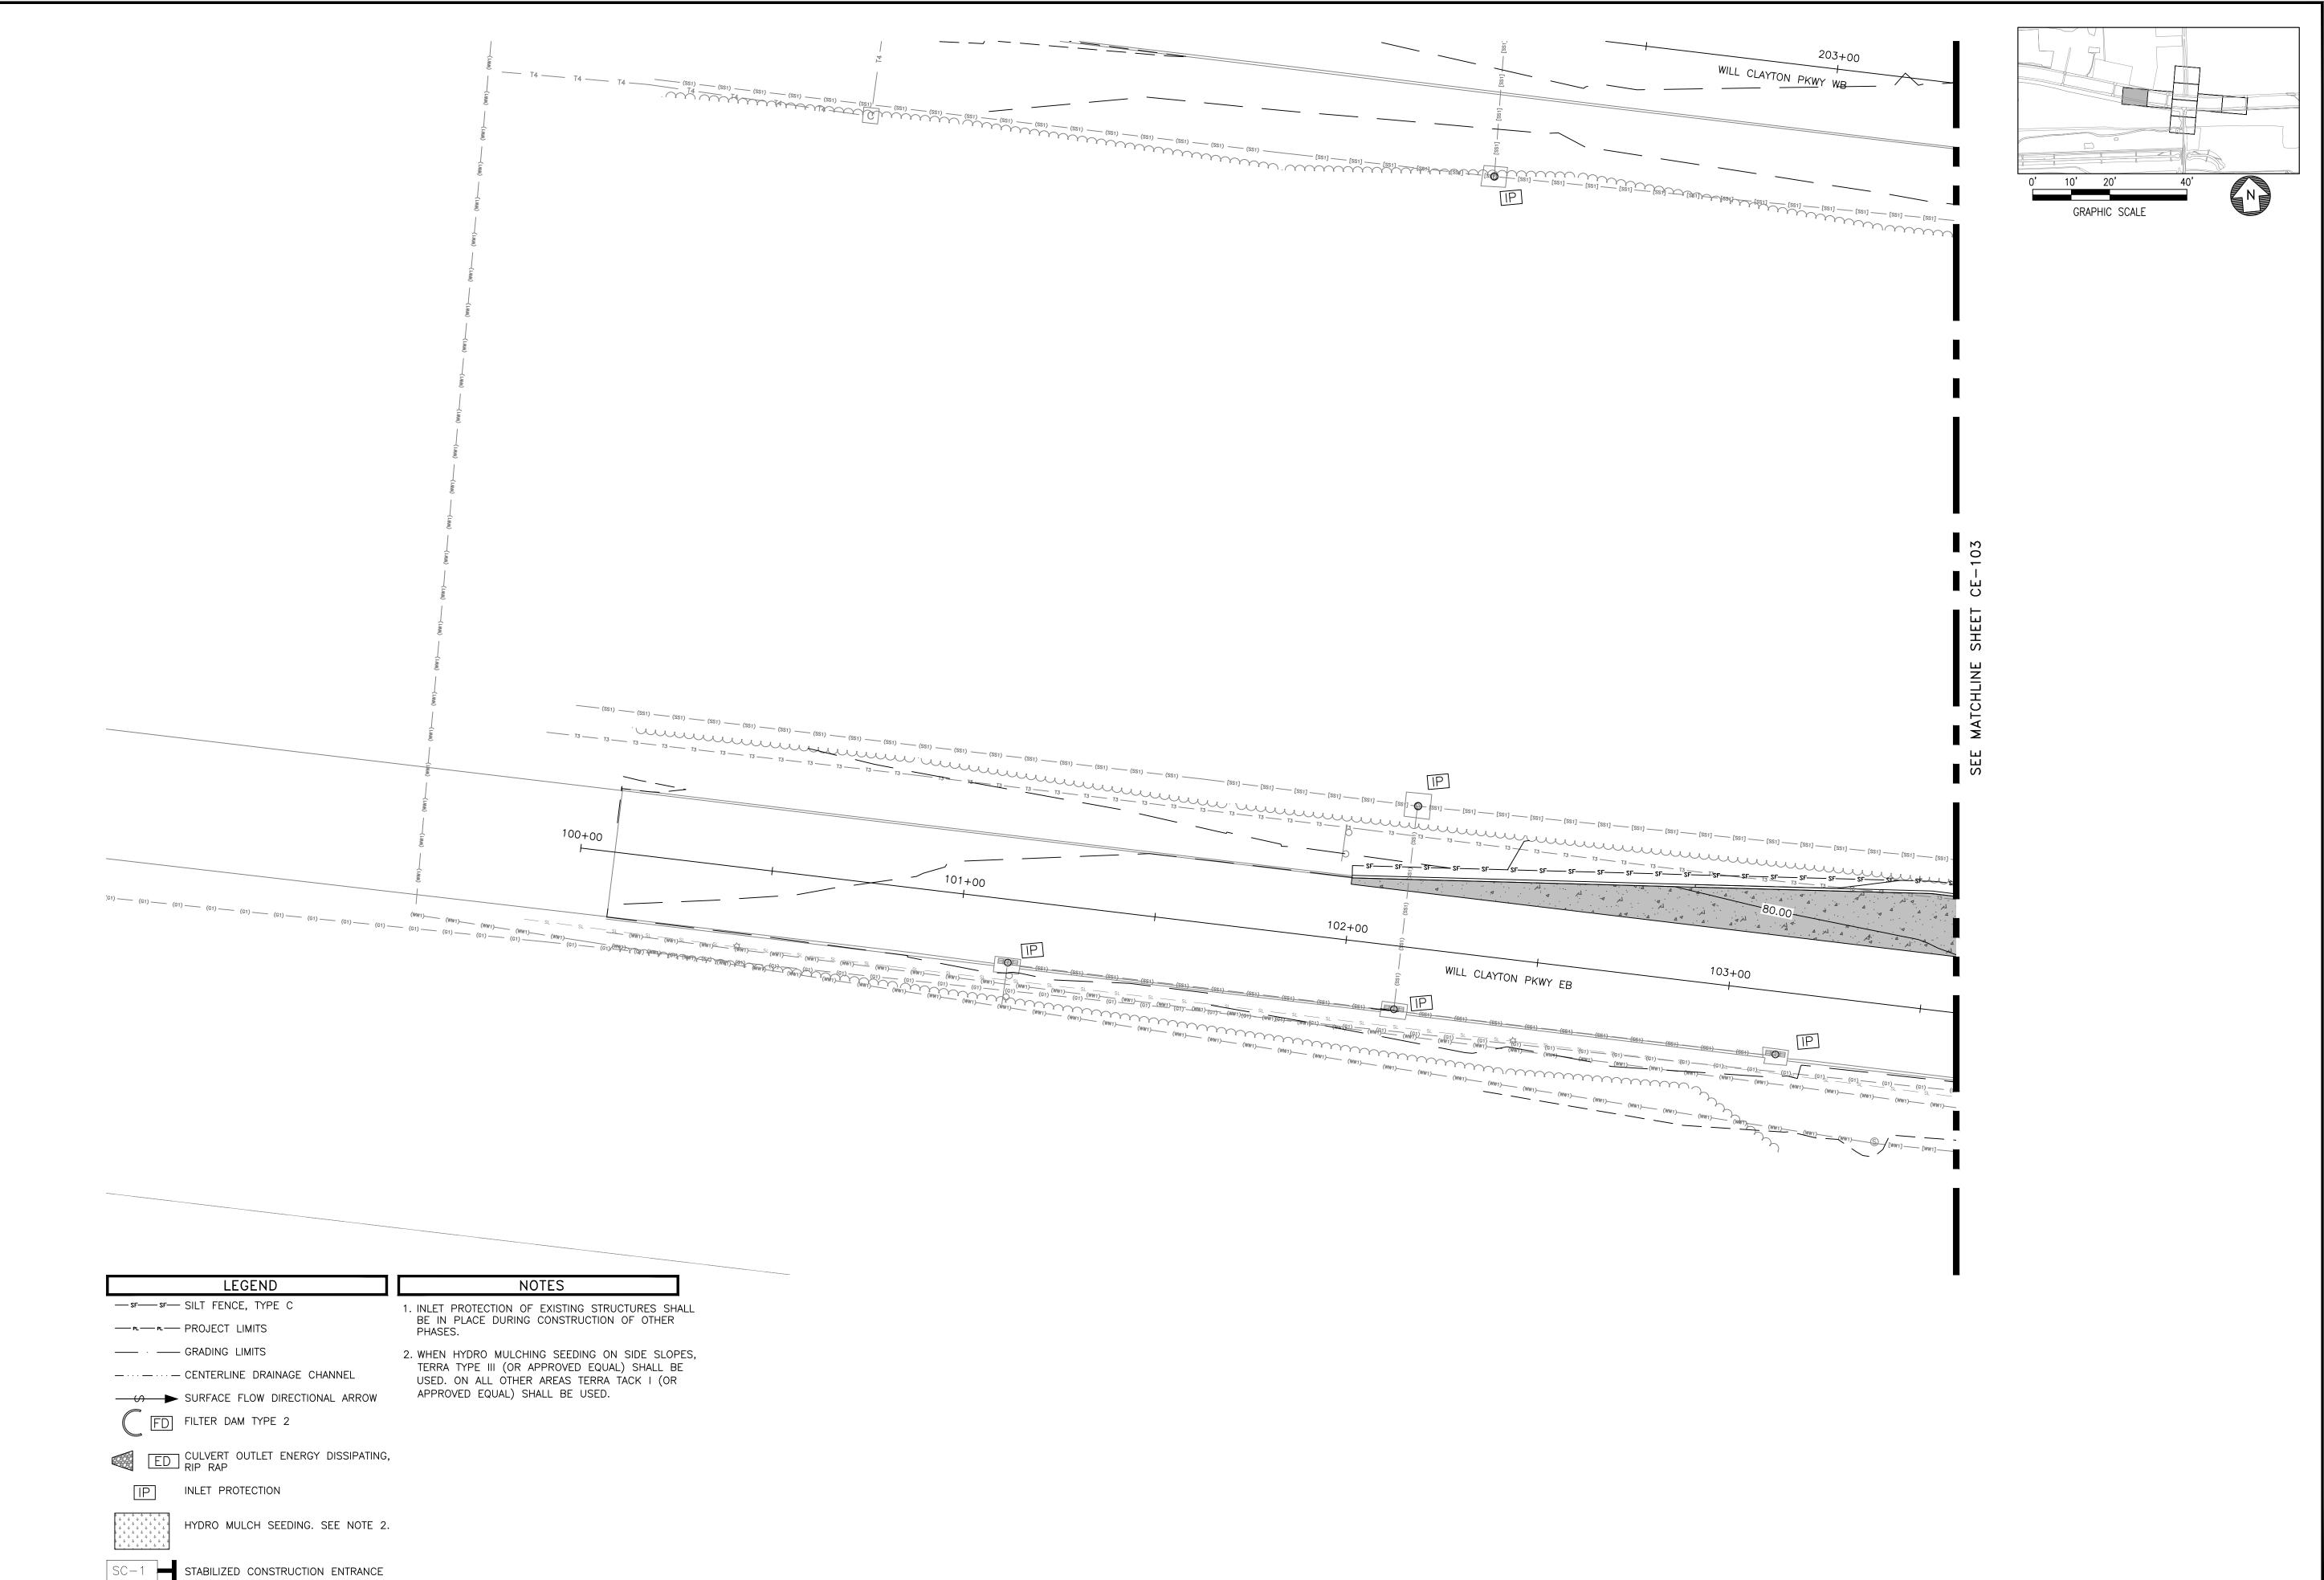
C.I.P. NO.

SHEET NO.

CE-101

HYDRO MULCH SEEDING. SEE NOTE 2.

STABILIZED CONSTRUCTION ENTRANCE



HOUSTON AIRPORT SYSTEM

GEORGE BUSH INTERCONTINENTAL AIRPORT /
HOUSTON, TX

**ATKINS** 

LOCAL OFFICE:
200 WESTLAKE PARK BLVD.,
STE. 1100
HOUSTON, TX 77079
TEL: (713) 576-8500
ATKINS NORTH
AMERICA PE FIRM REG.
#F-000474

REVISIONS

NO. DESCRIPTION DATE BY

CONTROL PROPERTY OF THE PROPER

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PROJECT MGR: MES

DESIGNER: ALR


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CHECK BY: PMW

SCALE:

DATE: 05/08/2024

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APPROVED BY:

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PROJECT NO.

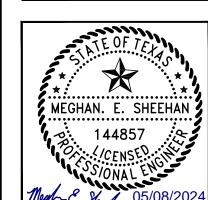100072032 A.I.P. No.

C.I.P. NO.

H.A.S. NO.

935

SHEET NO.

CE-102



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MES PROJECT MGR: ALR ALR PMW05/08/2024

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DIRECTOR HOUSTON AIRPORT SYSTEM

PROJECT NO. 100072032

**CE-103** 




**ATKINS** 

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PROJECT NO.

100072032 A.I.P. NO.

C.I.P. NO.

H.A.S. NO. SHEET NO.

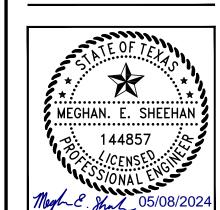CE-104

→ SURFACE FLOW DIRECTIONAL ARROW

FD FILTER DAM TYPE 2



ED CULVERT OUTLET ENERGY DISSIPATING,



IP INLET PROTECTION



HYDRO MULCH SEEDING. SEE NOTE 2.

APPROVED EQUAL) SHALL BE USED.

STABILIZED CONSTRUCTION ENTRANCE

HOUSTON AIRPORT SYSTEM GEORGE BUSH INTERCONTINENTAL AIRPORT / HOUSTON, TX

**ATKINS** 

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REVISIONS NO. DESCRIPTION DATE BY

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PROJECT NO. 100072032

HOUSTON AIRPORT SYSTEM GEORGE BUSH INTERCONTINENTAL AIRPORT /


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DIRECTOR HOUSTON AIRPORT SYSTEM

PROJECT NO. 100072032

935

HOUSTON AIRPORT SYSTEM GEORGE BUSH INTERCONTINENTAL AIRPORT / HOUSTON, TX


**ATKINS** 
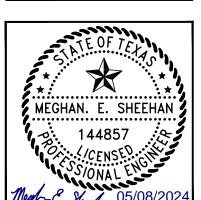
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REVISIONS NO. DESCRIPTION DATE BY

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PROJECT MGR: MES DESIGNER: ALR ALR DRAWN BY: CHECK BY: PMW SCALE: 05/08/2024



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DIRECTOR HOUSTON AIRPORT SYSTEM

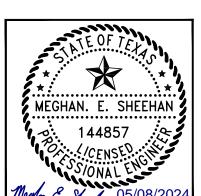100072032 A.I.P. NO.

C.I.P. NO.

H.A.S. NO.

GEORGE BUSH INTERCONTINENTAL AIRPORT HOUSTON, TX

LOCAL OFFICE: 200 WESTLAKE PARK BLVD., STE. 1100 HOUSTON, TX 77079 TEL: (713) 576-8500 ATKINS NORTH


AMERICA PE FIRM REG. #F-000474

REVISIONS NO. DESCRIPTION DATE BY

MES PROJECT MGR: ALR ALR PMW

05/08/2024

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DIRECTOR HOUSTON AIRPORT SYSTEM

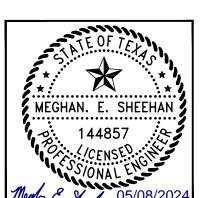PROJECT NO. 100072032

935 SHEET NO.

GEORGE BUSH INTERCONTINENTAL AIRPORT HOUSTON, TX

LOCAL OFFICE: 200 WESTLAKE PARK BLVD., STE. 1100 HOUSTON, TX 77079 TEL: (713) 576-8500 ATKINS NORTH AMERICA PE FIRM REG. #F-000474

REVISIONS

NO. DESCRIPTION DATE BY

PROJECT MGR: MES ALR ALR DRAWN BY: CHECK BY: PMW 05/08/2024

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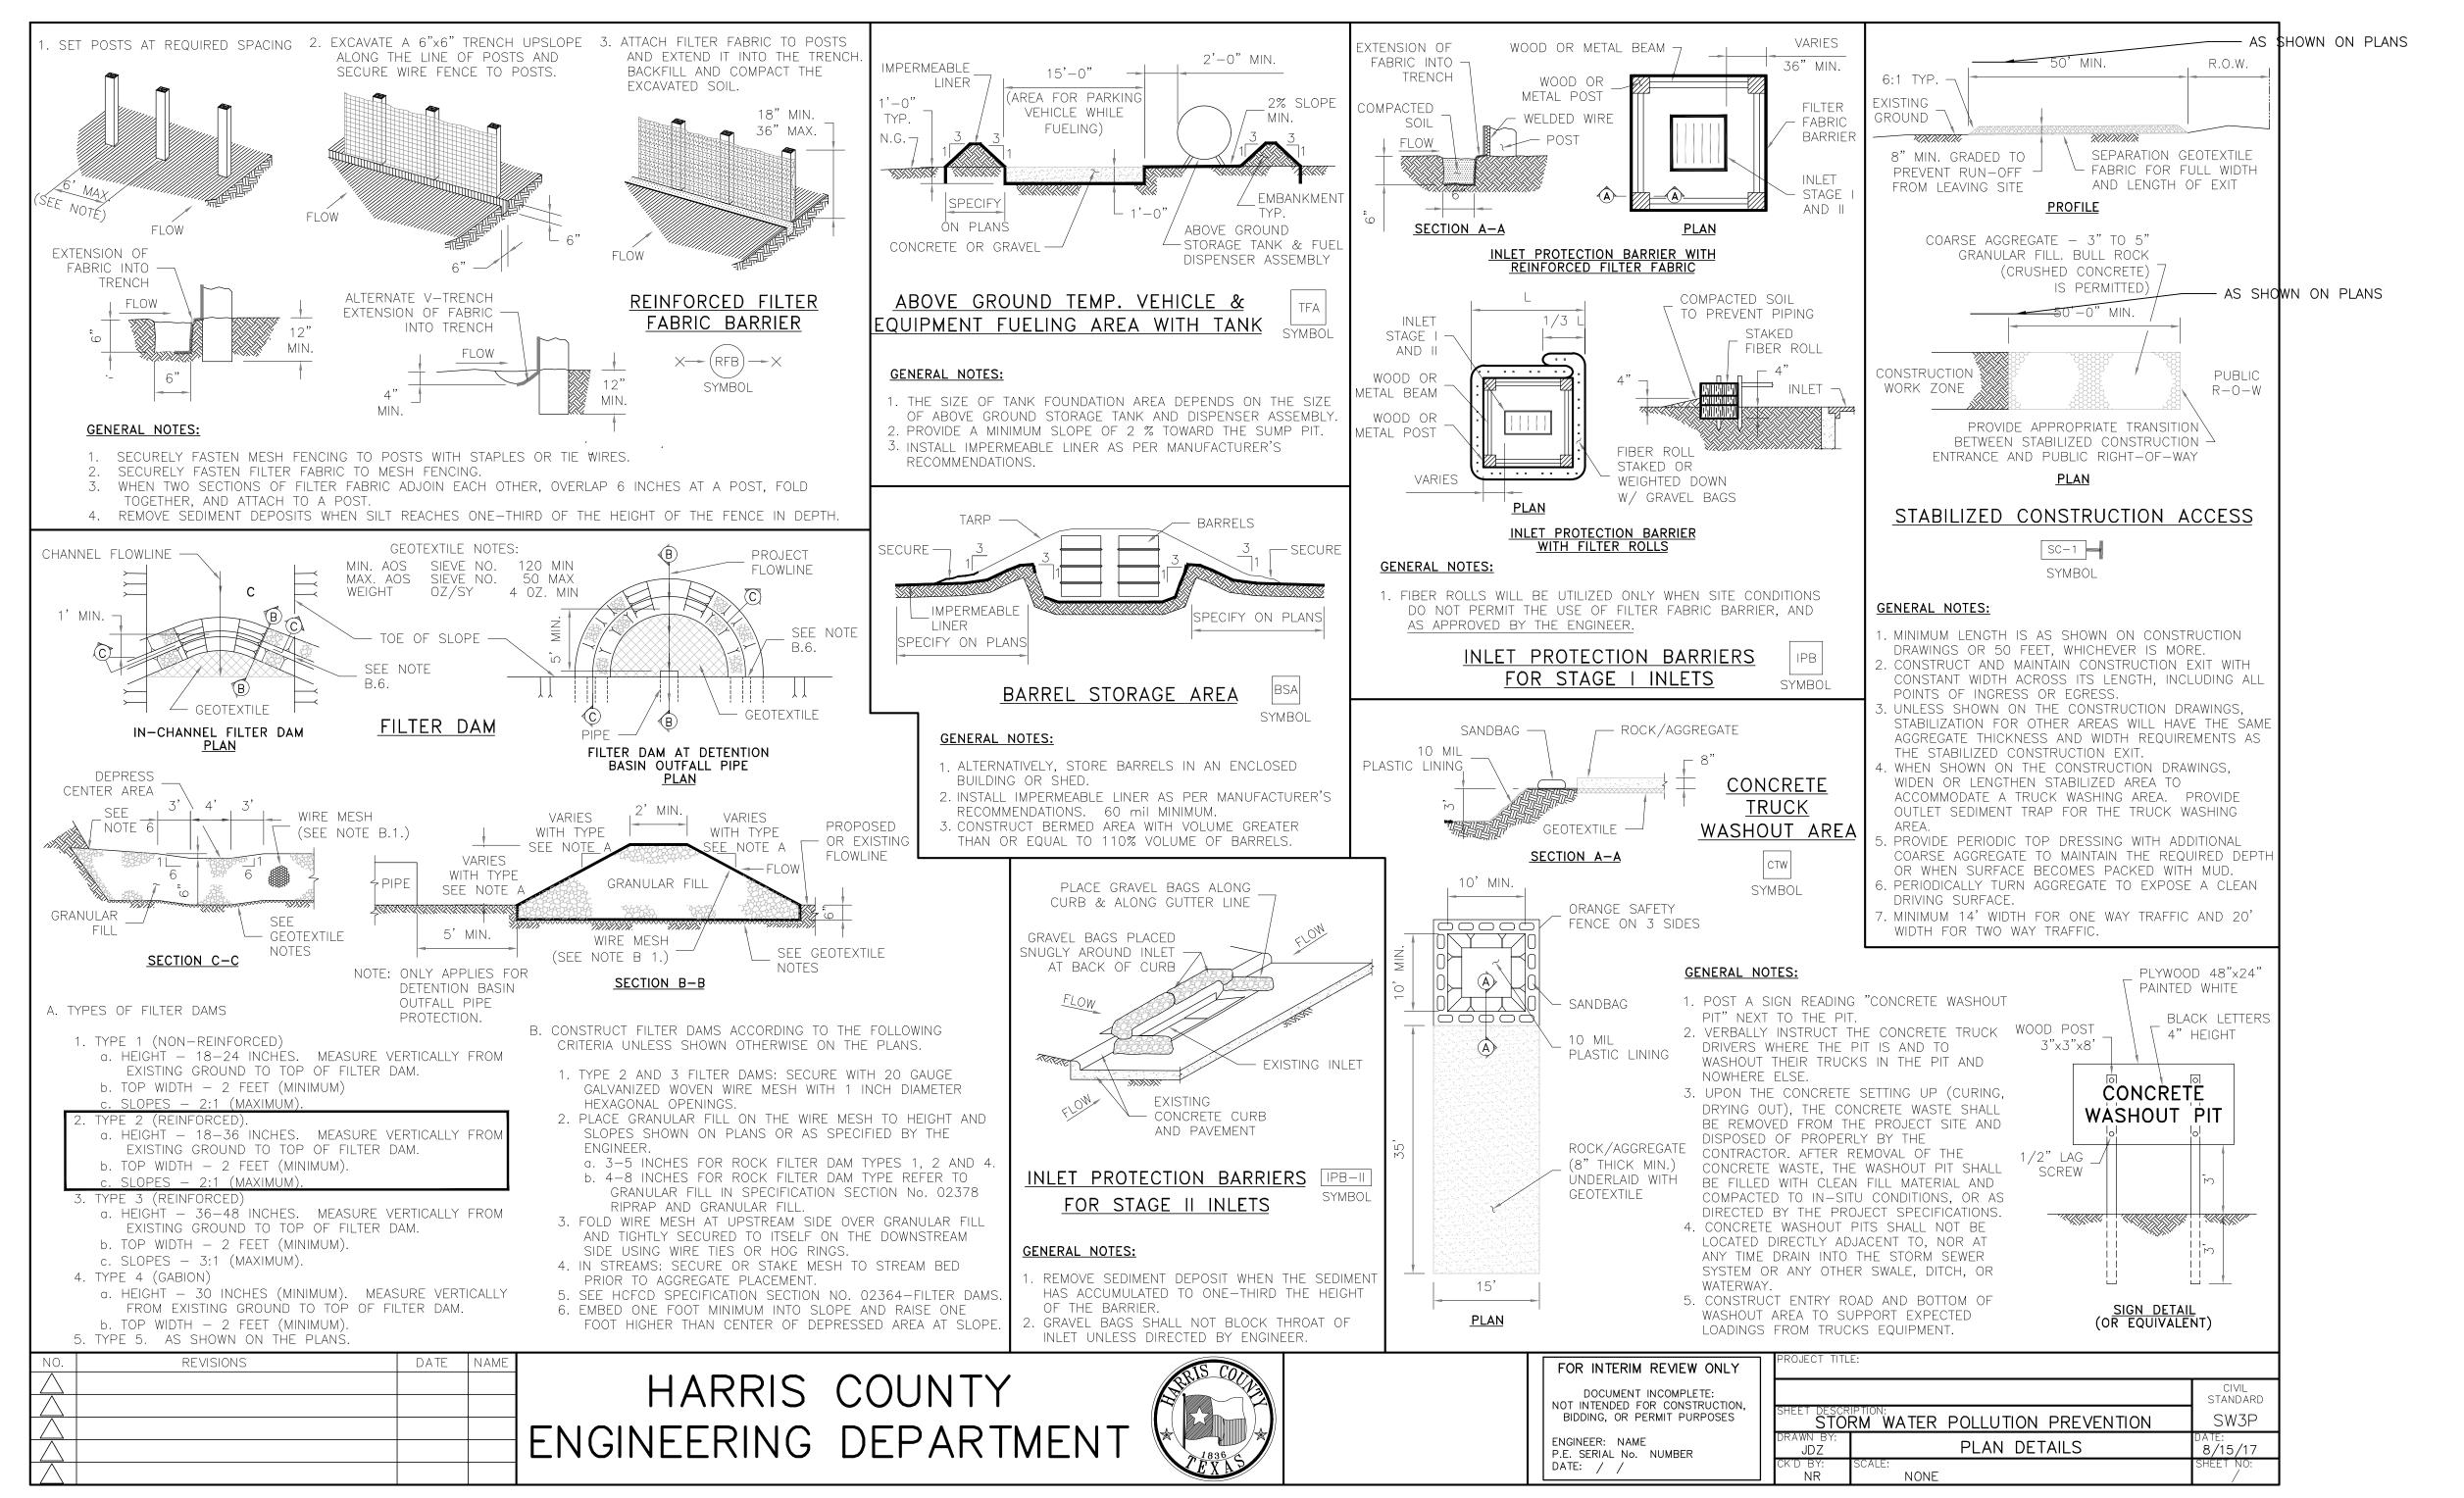
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DIRECTOR HOUSTON AIRPORT SYSTEM

PROJECT NO. 100072032 A.I.P. NO.

C.I.P. NO.

H.A.S. NO. 935



# SWPPP GENERAL NOTES

- 1. SEDIMENT WILL BE RETAINED ON SITE TO THE MAXIMUM EXTENT PRACTICABLE.
- 2. IF DAMAGED OR RENDERED INEFFECTIVE, THE EROSION AND SEDIMENT CONTROLS WILL BE REPAIRED OR REPLACED IMMEDIATELY.
- 3. WHEN PUMPING (DEWATERING) STANDING STORM WATER FROM THE SITE, THE OPERATOR SHALL USE APPROPRIATE BEST MANAGEMENT PRACTICES (BMPS) FROM THE STORM WATER MANAGEMENT HANDBOOK FOR CONSTRUCTION ACTIVITIES. UNTREATED/DIRECT DISCHARGE INTO A STORM SEWER WILL NOT BE ALLOWED.
- 4. IF THE INTERIM PERIOD BETWEEN CONSTRUCTION OF UTILITIES AND STREET CONSTRUCTION WILL BE MORE THAN 21 DAYS, THE STREETS RIGHTS-OF-WAY WILL BE MULCHED OR OTHERWISE STABILIZED WITHIN 14 DAYS.
- 5. AFTER PAVING COMPLETION, NEWLY GRADED AREAS AND ALL EXPOSED SOILS WILL BE COMPLETELY STABILIZED.
- 6. CONCRETE TRUCKS WILL NOT BE ALLOWED TO WASH OUT OR DISCHARGE SURPLUS CONCRETE OR DRUM WASH WATER ON THE SITE, UNLESS THEY ARE USING A PROPERLY DESIGNED AND DESIGNATED CONCRETE WASHOUT AREA.
- 7. EROSION AND SEDIMENT CONTROL MEASURES THAT HAVE BEEN IMPROPERLY INSTALLED OR HAVE BEEN DISABLED, RUN-OVER, REMOVED, OR OTHERWISE RENDERED INEFFECTIVE MUST BE REPLACED OR CORRECTED IMMEDIATELY.
- 8. MAINTENANCE AND REPAIRS WILL BE CONDUCTED WITHIN 24 HOURS OF INSPECTION REPORT.
- 9. ALL LITTER, TRASH AND FLOATABLE DEBRIS WILL BE CONTAINED IN DUMPSTER CONTAINER WITH CLOSING LIDS. MATERIAL DISPOSABLE SHALL BE HANDLED AT CONTRACTORS EXPENSE.



**ATKINS** 

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REVISIONS NO. DESCRIPTION DATE B'

PROJECT MGR: MES DESIGNER: ALR ALR DRAWN BY: PMWCHECK BY: SCALE: 05/08/2024



APPROVED BY:

DATE:


HOUSTON AIRPORT SYSTEM

PROJECT NO. 100072032

A.I.P. NO.

C.I.P. NO.

H.A.S. NO. 935 SHEET NO.

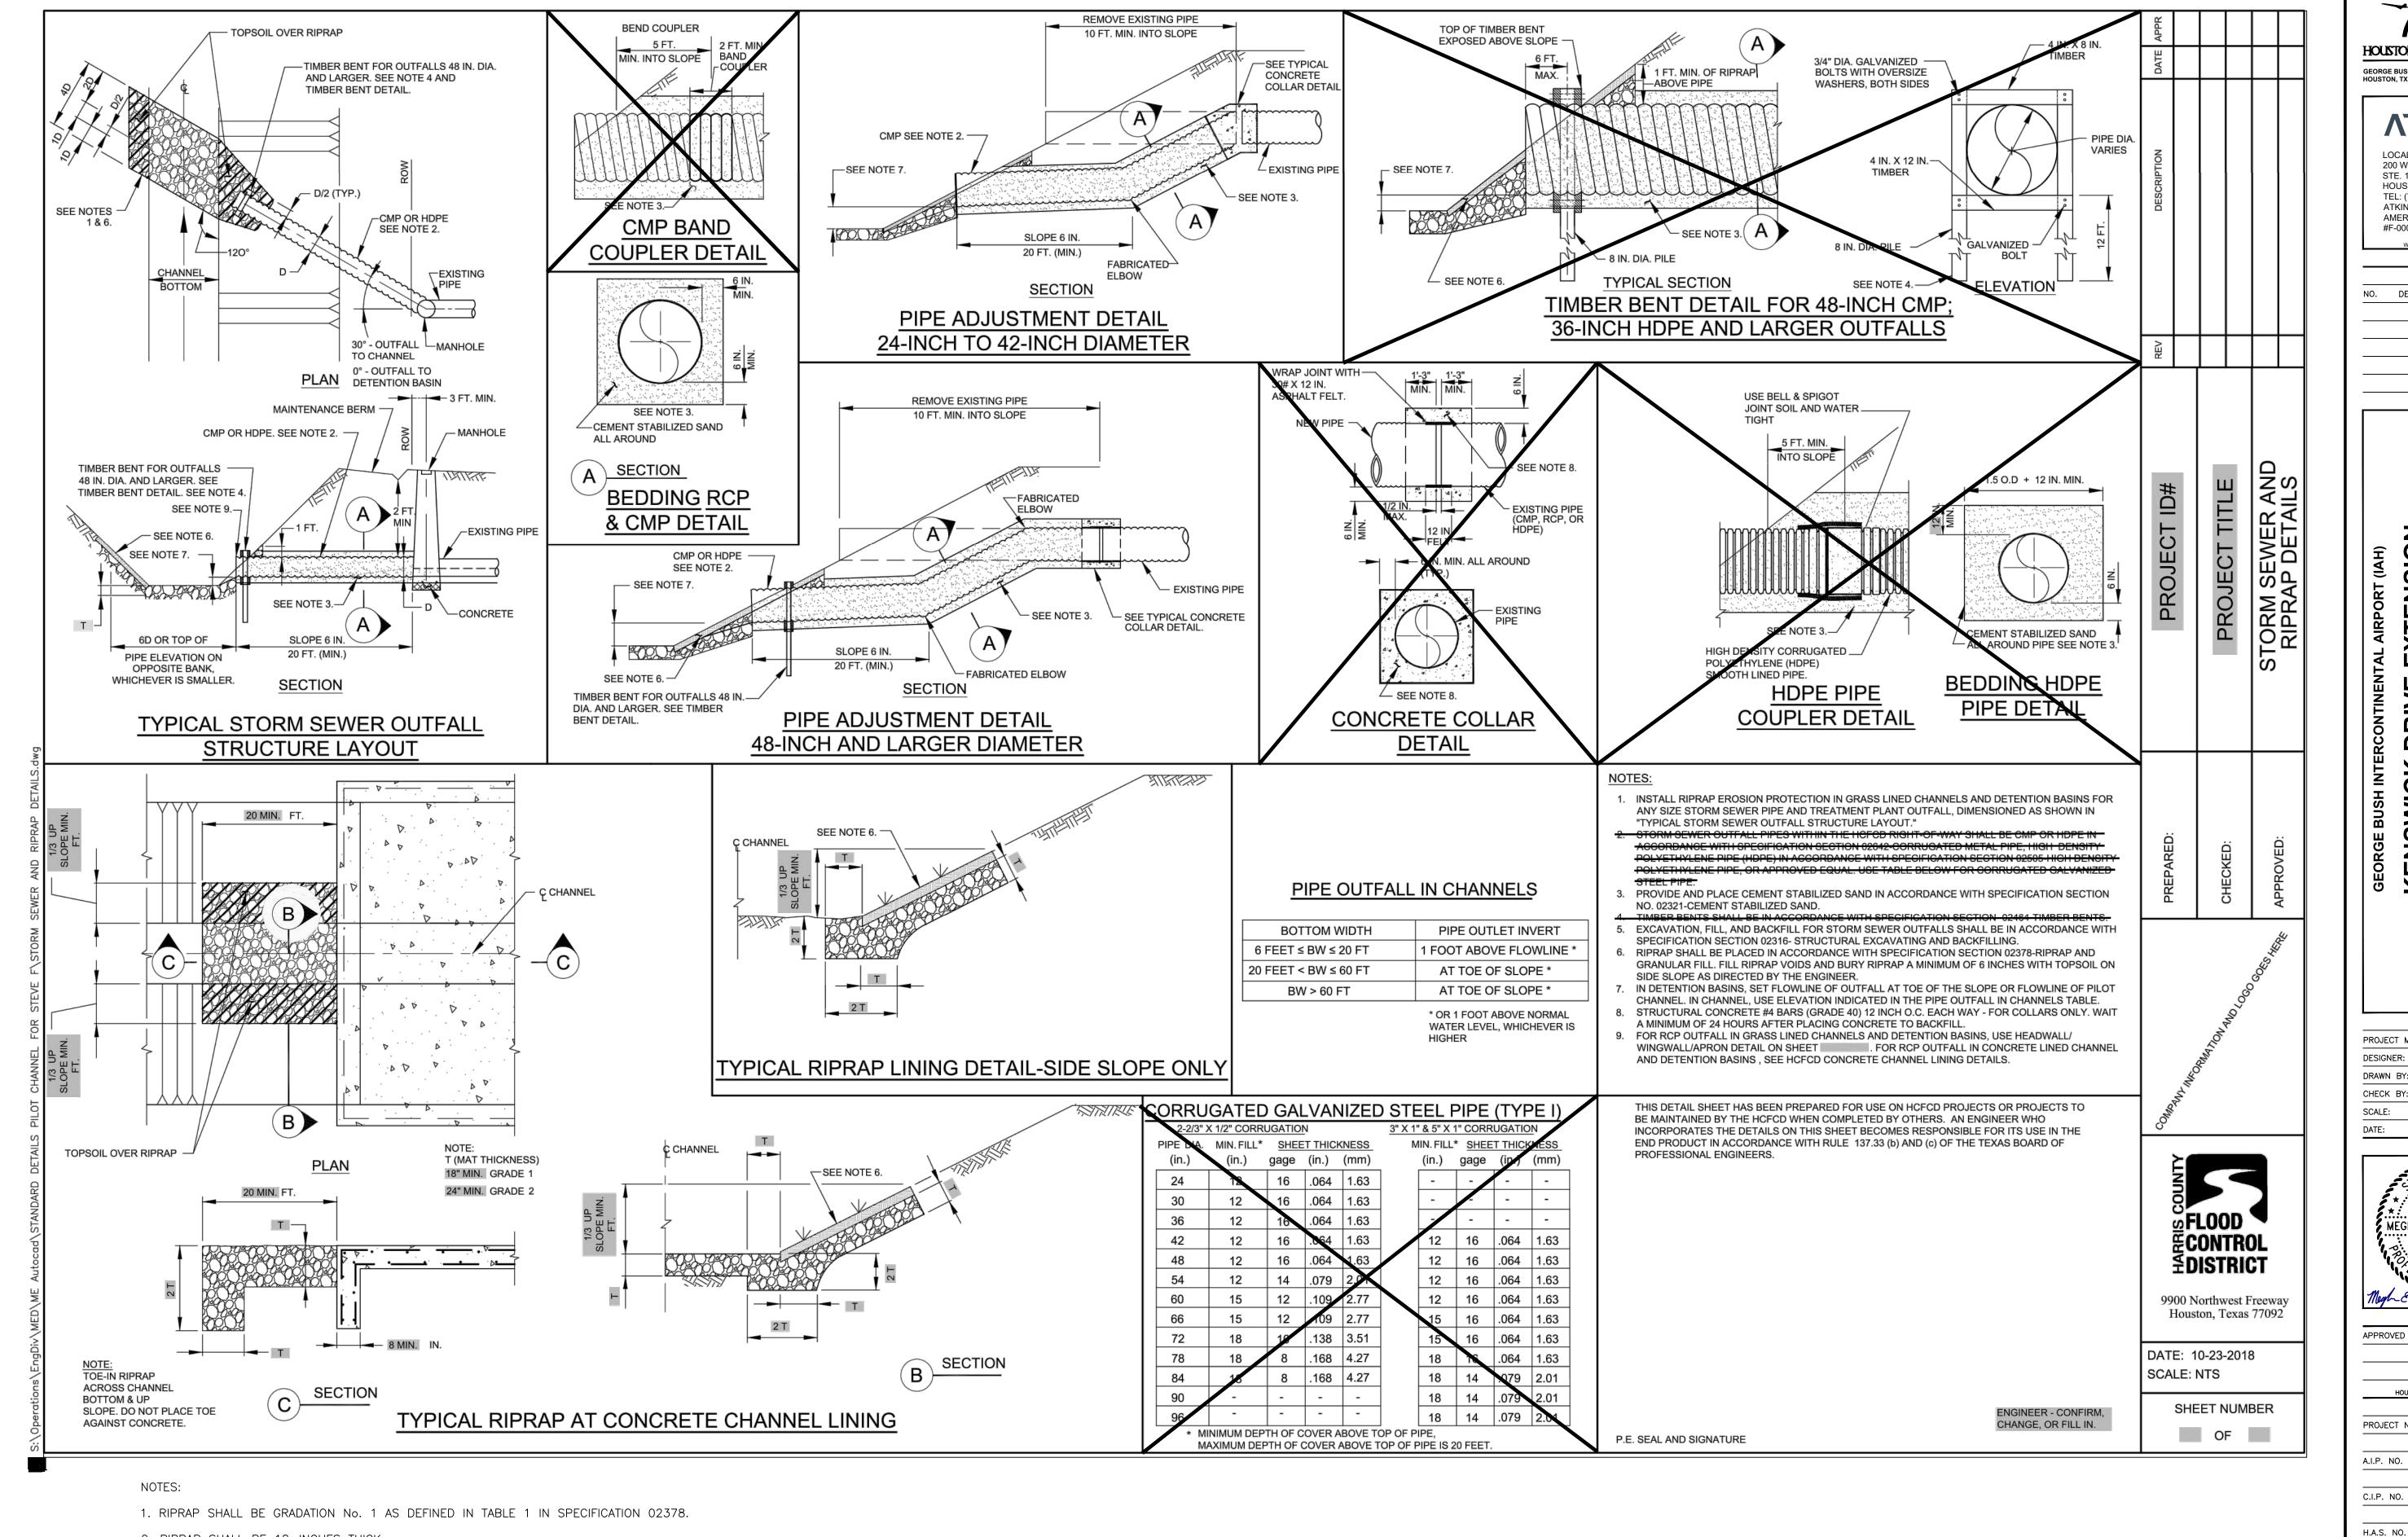

2. RIPRAP SHALL BE 18-INCHES THICK.

GEORGE BUSH INTERCONTINENTAL AIRPORT


**ATKINS** LOCAL OFFICE: 200 WESTLAKE PARK BLVD.,

STE. 1100

HOUSTON, TX 77079 TEL: (713) 576-8500 ATKINS NORTH AMERICA PE FIRM REG. #F-000474

REVISIONS NO. DESCRIPTION DATE BY

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DIRECTOR HOUSTON AIRPORT SYSTEM

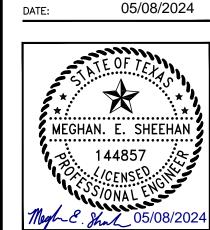PROJECT NO.

100072032 A.I.P. NO.

C.I.P. NO.

935 SHEET NO.

### TRAFFIC SIGNAL GENERAL NOTES:

- 1. ALL EQUIPMENT / MATERIALS AND CONSTRUCTION SHALL MEET OR EXCEED THE REQUIREMENTS CONTAINED IN THE CURRENT CITY OF HOUSTON STANDARD SPECIFICATIONS AND STANDARD DRAWINGS, THE PROJECT SPECIFIC SPECIFICATIONS AND THE PLANS.
- 2. ALL ELECTRICAL WORK SHALL BE IN CONFORMANCE WITH THE PROVISIONS AND REQUIREMENTS OF THE CITY ELECTRICAL CODE.
- 3. ALL SIGNS SHALL BE MANUFACTURED IN ACCORDANCE WITH THE TEXAS MANUAL ON UNIFORM TRAFFIC CONTROL DEVICES.
- 4. THE CONTRACTOR. SHALL ARRANGE THE INSTALLATION OF SIGNALS, POLES AND CONDUIT SO AS TO PERMIT THE CONTINUOUS MOVEMENT OF TRAFFIC IN ALL DIRECTIONS AT ALL TIMES. THE CONTRACTOR SHALL NOT CLOSE MORE THAN ONE LANE OF A ROADWAY AT ONE TIME WITHOUT PRIOR APPROVAL OF THE CITY.
- 5. THE CONTRACTOR SHALL CLEAN UP AND REMOVE FROM THE WORK AREA ALL LOOSE MATERIAL RESULTING FROM CONTRACT OPERATIONS EACH DAY PRIOR TO WORK BEING SUSPENDED FOR THAT DAY.
- 6. THE CONTRACTOR SHALL CONTACT THE ENGINEER AND/OR THE APPROVED CITY OF HOUSTON REPRESENTATIVE TO ARRANGE FOR METER AND ELECTRICAL SERVICE CONNECTION FROM THE POWER COMPANY.
- 7. ALL PEDESTRIAN PUSH BUTTON ASSEMBLIES SHALL MEET ADA REQUIREMENTS. THE SIGNS THAT SHALL BE USED ARE IDENTIFIED IN THE TMUTCD AS R10-3E.
- 8. OVERHEAD STREET NAME SIGNS SHALL BE INSTALLED SUCH THAT THE BOTTOM OF THE SIGN IS NO LESS THAN 11 FEET ABOVE THE ROADWAY PAVEMENT OR NO LESS THAN 16 FEET ABOVE THE FINISHED GRADE BEYOND THE SHOULDER.
- 9. THE LOCATION OF EACH NEW POLE FOUNDATION, PULL BOX, CONTROLLER CABINET FOUNDATION, UPS CABINET FOUNDATION AND ELECTRIC SERVICE PEDESTAL FOUNDATION SHALL BE MARKED IN THE FIELD AS SHOWN ON THE PLANS. THE EXACT LOCATION SHALL BE APPROVED BY THE ENGINEER AND/OR THE APPROVED CITY OF HOUSTON REPRESENTATIVE PRIOR TO BEGINNING INSTALLATION OF THE FOUNDATION.
- 10. THE TOP OF THE POLE FOUNDATION SHALL BE LEVEL WITH THE FINISHED GRADE. IF THE SLOPE OR SHOULDER DROPS OFF FROM FINISHED GRADE, THE CONTRACTOR SHALL GRADE AROUND POLE FOUNDATION. THE TOP OF THE FOUNDATION SHALL EXIEND NO MORE THAN 4 INCHES ABOVE SURROUNDING GRADE.
- 11. ALL CONCRETE USED FOR TRAFFIC SIGNAL POLE AND CABINET FOUNDATIONS SHALL BE CLASS "A" (REFER TO THE CITY OF HOUSTON SPECIFICATION FOR CONCRETE).
- 12. MAST ARM POLES SHALL NOT BE INSTALLED ON THE FOUNDATIONS LESS THAN SEVEN DAYS AFTER THE PLACEMENT OF THE CONCRETE FOR THE FOUNDATION.
- 13. ANCHOR BOLTS FOR SIGNAL POLES SHALL BE SET SO THAT TWO ARE IN COMPRESSION AND TWO ARE IN TENSION. PRIOR TO THE INSTALLATION OF THE NUT, THE THREADS OF THE ANCHOR BOLT SHALL BE COATED WITH PIPE JOINT COMPOUND.
- 14. ALL UNDERGROUND CONSTRUCTION (CONDUIT, FOUNDATIONS AND PULL BOXES) FOR THE INTERSECTION SHALL BE COMPLETED PRIOR TO THE INSTALLATION OF POLES, SIGNALS AND CABINETS. THE CONTRACTOR SHALL NOT PROCEED TO ABOVE GROUND WORK UNTIL THE ENGINEER AND/OR APPROVED CITY OF HOUSTON REPRESENTATIVE HAD CONFIRMED THAT THE MATERIALS FOR A COMPLETE INSTALLATION ARE AVAILABLE.
- 15. UNDERGROUND CONDUIT FOR SIGNAL CABLE SHALL BE SCHEDULE 80 ELECTRICAL PVC CONDUIT OF THE DIAMETER SHOWN ON THE PLANS, UNLESS OTHERWISE NOTED. ALL COUPLINGS AND CONNECTIONS SHALL BE TIGHT AND WATERPROOF.
- 16. ALL ABOVE GROUND CONDUIT FOR SIGNAL CABLE AND INTERCONNECT MEDIA SHALL BE HOT DIPPED GALVANIZED STEEL RIGID METAL CONDUIT OF THE DIAMETERS SHOWN ON THE PLANS, UNLESS OTHERWISE NOTED. ALL COUPLINGS AND CONNECTIONS SHALL BE TIGHT AND WATERPROOF.

- 17. ONLY NEW CONDUIT AND CABLE SHALL BE INSTALLED.
- 18. CONDUIT INSTALLED UNDER EXISTING PAVED DRIVEWAYS, ROADWAYS OR SIDEWALKS, WHICH ARE NOT SCHEDULED TO BE RECONSTRUCTED AS PART OF THIS PROJECT, SHALL BE INSTALLED BY MEANS OF BORING. THE CONTRACTOR SHALL NOT CUT OPEN ANY STREET OR DRIVEWAY FOR CONDUIT INSTALLATION WITHOUT THE PRIOR APPROVAL OF THE ENGINEER AND/OR THE APPROVED CITY OF HOUSTON REPRESENTATIVE.
- 19. CONDUIT NOT PLACED UNDER PAVED DRIVEWAYS, ROADWAY PAVEMENT OR SIDEWALK MAY BE PLACED BY. CUTTING A TRENCH, INSTALLING THE CONDUIT AND BACKFILLING. ANY TRENCHING FOR CONDUIT WIDER THAN THEE (3) INCHES SHALL BE RESODDED.
- 20. PULL BOXES SHALL NOT BE INSTALLED WITHIN CONCRETE CURB ACCESS RAMPS. IN ADDITION, ANY PULL BOXES INSTALLED BEHIND CURBS SHALL BE INSTALLED BETWEEN THE CURB AND THE PROPOSED / FUTURE SIDEWALK OR BEYOND THE PROPOSED / FUTURE SIDEWALK. AN EXCEPTION TO THIS NOTE WOULD BE PULL BOXES INSTALLED IN A MEDIAN. ANY PULL BOXES INSTALLED ALONG AN UNCURBED ROADWAY SHALL BE INSTALLED ADJACENT TO, BUT NOT WITHIN, THE SHOULDER.
- 21. A 5/8 IN. X 10 FT. GROUND ROD SHALL BE INSTALLED IN THE PULL BOX LOCATED ON EACH CORNER. TWO GROUND ROD CLAMPS SHALL BE FURNISHED FOR GROUNDING THE GROUND WIRE.
- 22. ALL CONDUITS SHALL BE CLEANED BY COMPRESSED AIR AND A PROPERLY SIZED CONDUIT PISTON OR MANDREL SHALL BE PULLED THROUGH THE CONDUIT PRIOR TO CABLE INSTALLATION.
- 23. WHEN PULLING TRAFFIG SIGNAL SYSTEM CABLES THROUGH CONDUIT, THE CABLES SHALL BE LUBRICATED WITH A LUBRICANT NORMALLY USED FOR THIS PURPOSE. ANY ABRASION TO ANY CONDUCTOR INSULATION WHICH OCCURS WHILE PULLING CABLE FOR THE TRAFFIC SIGNAL SYSTEM WILL BE CAUSE FOR THE IMMEDIATE REJECTION OF THE CABLE. IF THIS OCCURS, THE CONTRACTOR SHALL REMOVE AND REPLACE THE ENTIRE CABLE RUN AT THEIR EXPENSE.
- 24. A MINIMUM OF THREE (3) FEET OF EACH WIRE AND CABLE MEASURED FROM THE TOP OF THE PULL BOX SHALL BE LEFT IN EACH PULL BOX AND AT EACH POLE BASE.
- 25. ALL CABLES SHALL BE STRIPPED, FORMED AND TERMINATED IN A NEAT AND UNIFORM MANNER WHETHER IN THE SIGNAL HEAD OR CONTROLLER CABINET. ALL CABLE SHALL BE BROUGHT INTO THE TERMINAL HOUSING OF SIGNALS AND/OR CONTROLLER CABINETS AND A SUFFICIENT LENGTH OF CABLE SHALL BE LEFT SO THAT ALL TERMINAL CONNECTIONS MAY BE MADE WITHOUT THE NECESSITY OF SPLICING THE CABLE.
- 26. THE HIGH VOLTAGE CABLES SHOULD BE SEPARATED FROM THE LOW VOLTAGE CABLES AS MUCH AS POSSIBLE.
- 27. NO LOOP DETECTOR SHALL BE CUT IN A PARALLEL EXPANSION JOINT. LOOPS CUT ACROSS EXPANSION JOINTS SHALL HAVE A SLACK IN THE CABLE FOR EXPANSION.
- 28. ALL VEHICLE ROADWAY DETECTION LOOP CABLES SHALL BE #14 AWG IMSA 51-5-1985 CABIF. LEAD-IN CABLES SHALL BE #14 AWG IMSA 50-2-1984 CABLE. NO SPLICES SHALL BE ALLOWED IN THE ROADWAY DETECTION LOOP CABLE EXCEPT AT THE PULL BOXADJACENT TO LOOP. THE DETECTOR LEAD-IN CABLE SHALL NOT BE SPLICED.
- 29. DETECTION LOOP SAW CUTS SHALL BE FLUSHED WITH WATER UNDER PRESSURE AND THEN DRIED WITH AIR UNDER PRESSURE.
- 30. THERE SHALL BE NO SPLICING IN CONDUCTORS EXCEPT FOR THE NECESSARY SPLICE BETWEEN ROADWAY LOOP WIRE AND DETECTOR LEAD-IN CABLE IN THE PULL BOX ADJACENT TO THE DETECTOR. THESE SPLICES SHALL BE WATERPROOF AND SHALL 8E IN COMPLIANCE WITH THE CITY OF HOUSTON STANDARD DRAWINGS FOR TRAFFIC SIGNAL CONSTRUCTION. THESE SPLICES SHALL BE MADE BY THE CONTRACTOR. DO NOT GROUND THE CABLE SHIELD AT THE PULL BOX.

- 31. TWO #10 AWG-XHHW CONDUCTORS SHALL BE INSTALLED FROM EACH LUMINAIRE TO THE CONTROLLER CABINET, LEAVING THREE FEET OF SLACK FOR EACH CONDUCTOR (MEASURED FROM THE TOP OF THE PULL BOX) IN EACH PULL BOX. ROUTE FOUR CONDUCTORS TO THE LUMINAIRE WITH THE PHOTOELECTRIC CELL. AN IN-LINE FUSE SHALL BE INSTALLED FOR EACH LUMINAIRE IN THE ASSOCIATED PULL BOX.
- 32. THE EMERGENCY VEHICLE PREEMPTION SENSOR CABLE SHALL BE OPTICOM DETECTOR CABLE MODEL NO. 138. THE CABLE SHALL NOT BE SPLICED.
- 33. ALL VEHICLE AND PEDESTRIAN INDICATIONS SHALL
- 34. THE CONTRACTOR SHALL BAG ALL NEWLY INSTALLED VEHICULAR AND/OR PEDESTRIAN TRAFFIC SIGNAL HEADS WITH BURLAP OR OTHER APPROVED MATERIAL UNTIL THE FINAL INSPECTION AND ACCEPTANCE BY THE CITY TRAFFIC ENGINEER AND/OR APPROVED CITY OF HOUSTON REPRESENTATIVE. THE BURLAP OR OTHER APPROVED MATERIAL/DEVICE SHALL COMPLETELY COVER THE TRAFFIC SIGNAL HEAD AND SHALL OBSCURE THE VIEW OF THE TRAFFIC SIGNAL INDICATIONS SO THAT THEY CANNOT BE SEEN UNTIL THE TRAFFIC SIGNAL IS PLACED IN OPERATION. DURING CONSTRUCTION, THE TRAFFIC SIGNAL WILL BE DE-ENERGIZED WHILE NOT IN USE FOR TESTING.
- 35. THE TRAFFIC SIGNAL OPERATION AT EXISTING SIGNALIZED INTERSECTIONS SHALL BE MAINTAINED THROUGHOUT THE DURATION OF THE PROJECT.
- 36.ALL STRIPING AND PAVEMENT MARKINGS ARE TO BE DONE UNDER THIS CONTRACT AND SHALL BE IN PLACE PRIOR TO THE ACTIVATION OF THE TRAFFIC SIGNAL. THE CONTRACTOR SHALL VERIFY THE LOCATION OF ALL STOP LINES PRIOR TO THE INSTALLATION OF LOOP
- 37. ALL CONSTRUCTION SIGNING AND CONSTRUCTION TRAFFIC CONTROL DEVICES SHALL BE IN CONFORMANCE WITH THE TEXAS MANUAL ON UNIFORM TRAFFIC CONTROL DEVICES.
- 38. CONTRACTOR SHALL VERIFY ALL ROW & WALKWAY EASEMENT LIMITS PRIOR TO THE INSTALLATION OF ANY SIGNAL EQUIPMENT.



**ATKINS** LOCAL OFFICE:


920 MEMORIAL CITY WAY, STE. 400 HOUSTON, TX 77024 TEL: (713) 576-8500 ATKINS NORTH AMERICA PE FIRM REG. #F-000474

REVISIONS NO. DESCRIPTION DATE BY

RAFFIC SIGNAL ENERAL NOTES

MES PROJECT MGR: KJV DESIGNER: ΚJV DRAWN BY: MES CHECK BY: SCALE:

05/08/2024

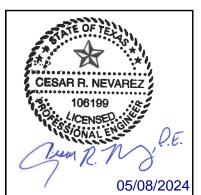

DIRECTOR HOUSTON AIRPORT SYSTEM

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,	APPROVED BY:	

PROJECT NO. 100072032


A.I.P. NO.

C.I.P. NO. H.A.S. NO.

SHEET NO. 116 OF 125

CS-001

935

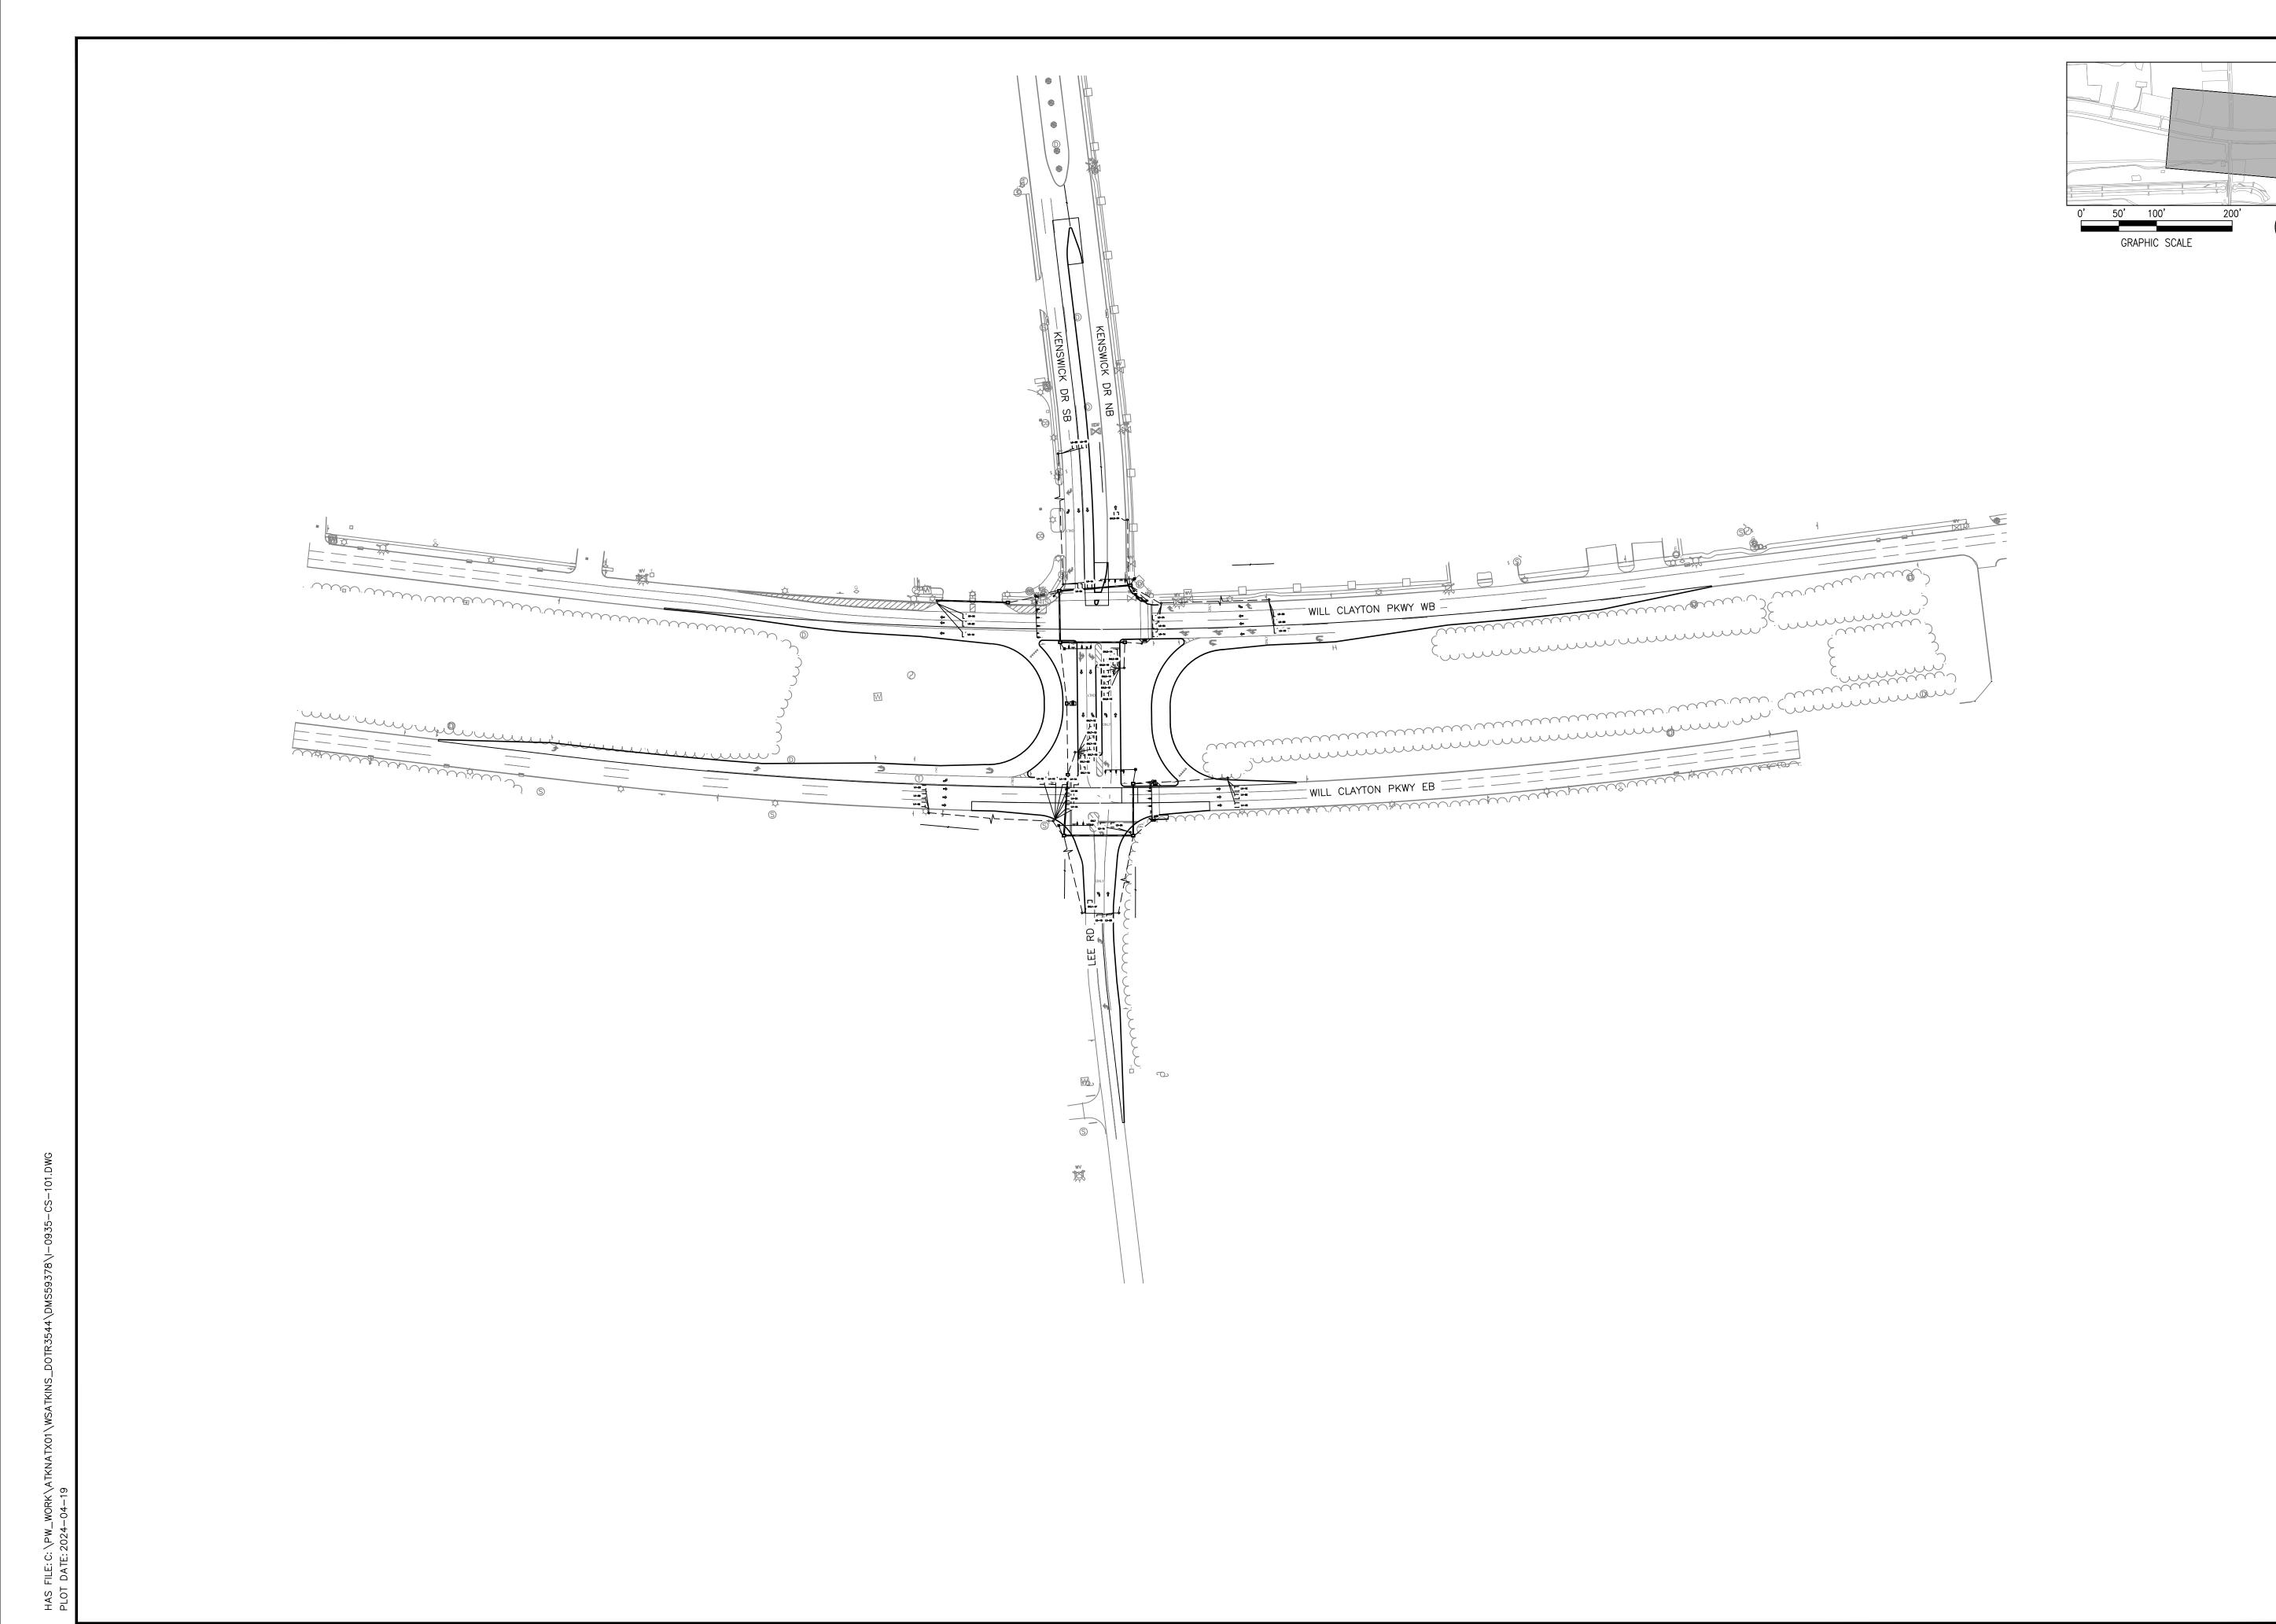




**ATKINS** LOCAL OFFICE:
920 MEMORIAL CITY WAY.
STE. 400
HOUSTON, TX 77024
TEL: (713) 576-8500
ATKINS NORTH

AMERICA PE FIRM REG.

#F-000474

REVISIONS NO. DESCRIPTION DATE BY

MES PROJECT MGR: ALR DESIGNER: ALR DRAWN BY: PMW CHECK BY: SCALE: 05/08/2024

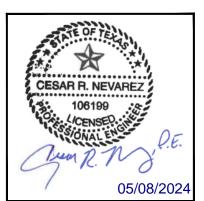

APPROVED BY:

PROJECT NO. 100072032 A.I.P. NO.

H.A.S. NO.

SHEET NO. **CS-101** 


GEORGE BUSH INTERCONTINENTAL AIRPORT

**ATKINS** LOCAL OFFICE: 920 MEMORIAL CITY WAY. STE. 400

HOUSTON, TX 77024 TEL: (713) 576-8500 ATKINS NORTH AMERICA PE FIRM REG. #F-000474

REVISIONS NO. DESCRIPTION DATE BY

MES PROJECT MGR: ALR DESIGNER: ALR DRAWN BY: CHECK BY: PMWSCALE:

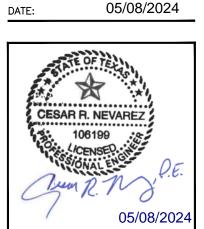

APPROVED BY:

DIRECTOR HOUSTON AIRPORT SYSTEM PROJECT NO.

100072032 A.I.P. NO. C.I.P. NO.

H.A.S. NO. 935

**CS-102** 

SHEET NO.

LIMITED TO, FIBER CABLE, COPPER, ETHERNET

MINIMUM OF ONE WEEK IN ADVANCE. PLEASE

SWITCHES, BLUETOOTH, ETC. INTERRUPTION

APPROVAL FROM THE CITY OF HOUSTON

OPERATIONS DIVISION/ITS SECTION AT A

DIVISION/ITS SECTION FOR QUESTIONS AT

OF ITS OPERATIONS SHALL REQUIRE

CONTACT THE TRAFFIC OPERATION

713.881.3172.

STREET NAME SIGN "Lee

PULL BOX — TYPE B PULL BOX - TYPE C

W/EXTENSION

METERED POWER PEDESTAL POLE MOUNTED METER  $\Diamond$ FIBER OPTIC CONDUIT -FO-MAST ARM SIGN  $\Rightarrow$ DIRECTIONAL ARROWS PULL BOX — TYPE B  $\boxtimes$ CURB RAMP DETECTABLE WARNING SURFACE

OVL2 PRESENCE LOOP 6'x6'

OVL2 PRESENCE LOOP 6'x6'

OVL2 DOWNSTREAM LOOP 6'x6'

2E LEADING EDGE

2B LEADING EDGE

2C LEADING EDGE

6+41.7

6+78.5

8+90.3


13.0 RT.

25.1 RT.

28.7 RT.

Road/Kenswick Drive" WITH BLOCK NUMBERS 18000 AND 18200 R3-7R (30"x30") SIGN "RIGHT LANE MUST TURN RIGHT" S10 R3-5L (30"x36") SIGN "LEFT TURN

PEDESTRIAN SIGNAL HEAD PEDESTRIAN PUSH BUTTON PULL BOX — TYPE A

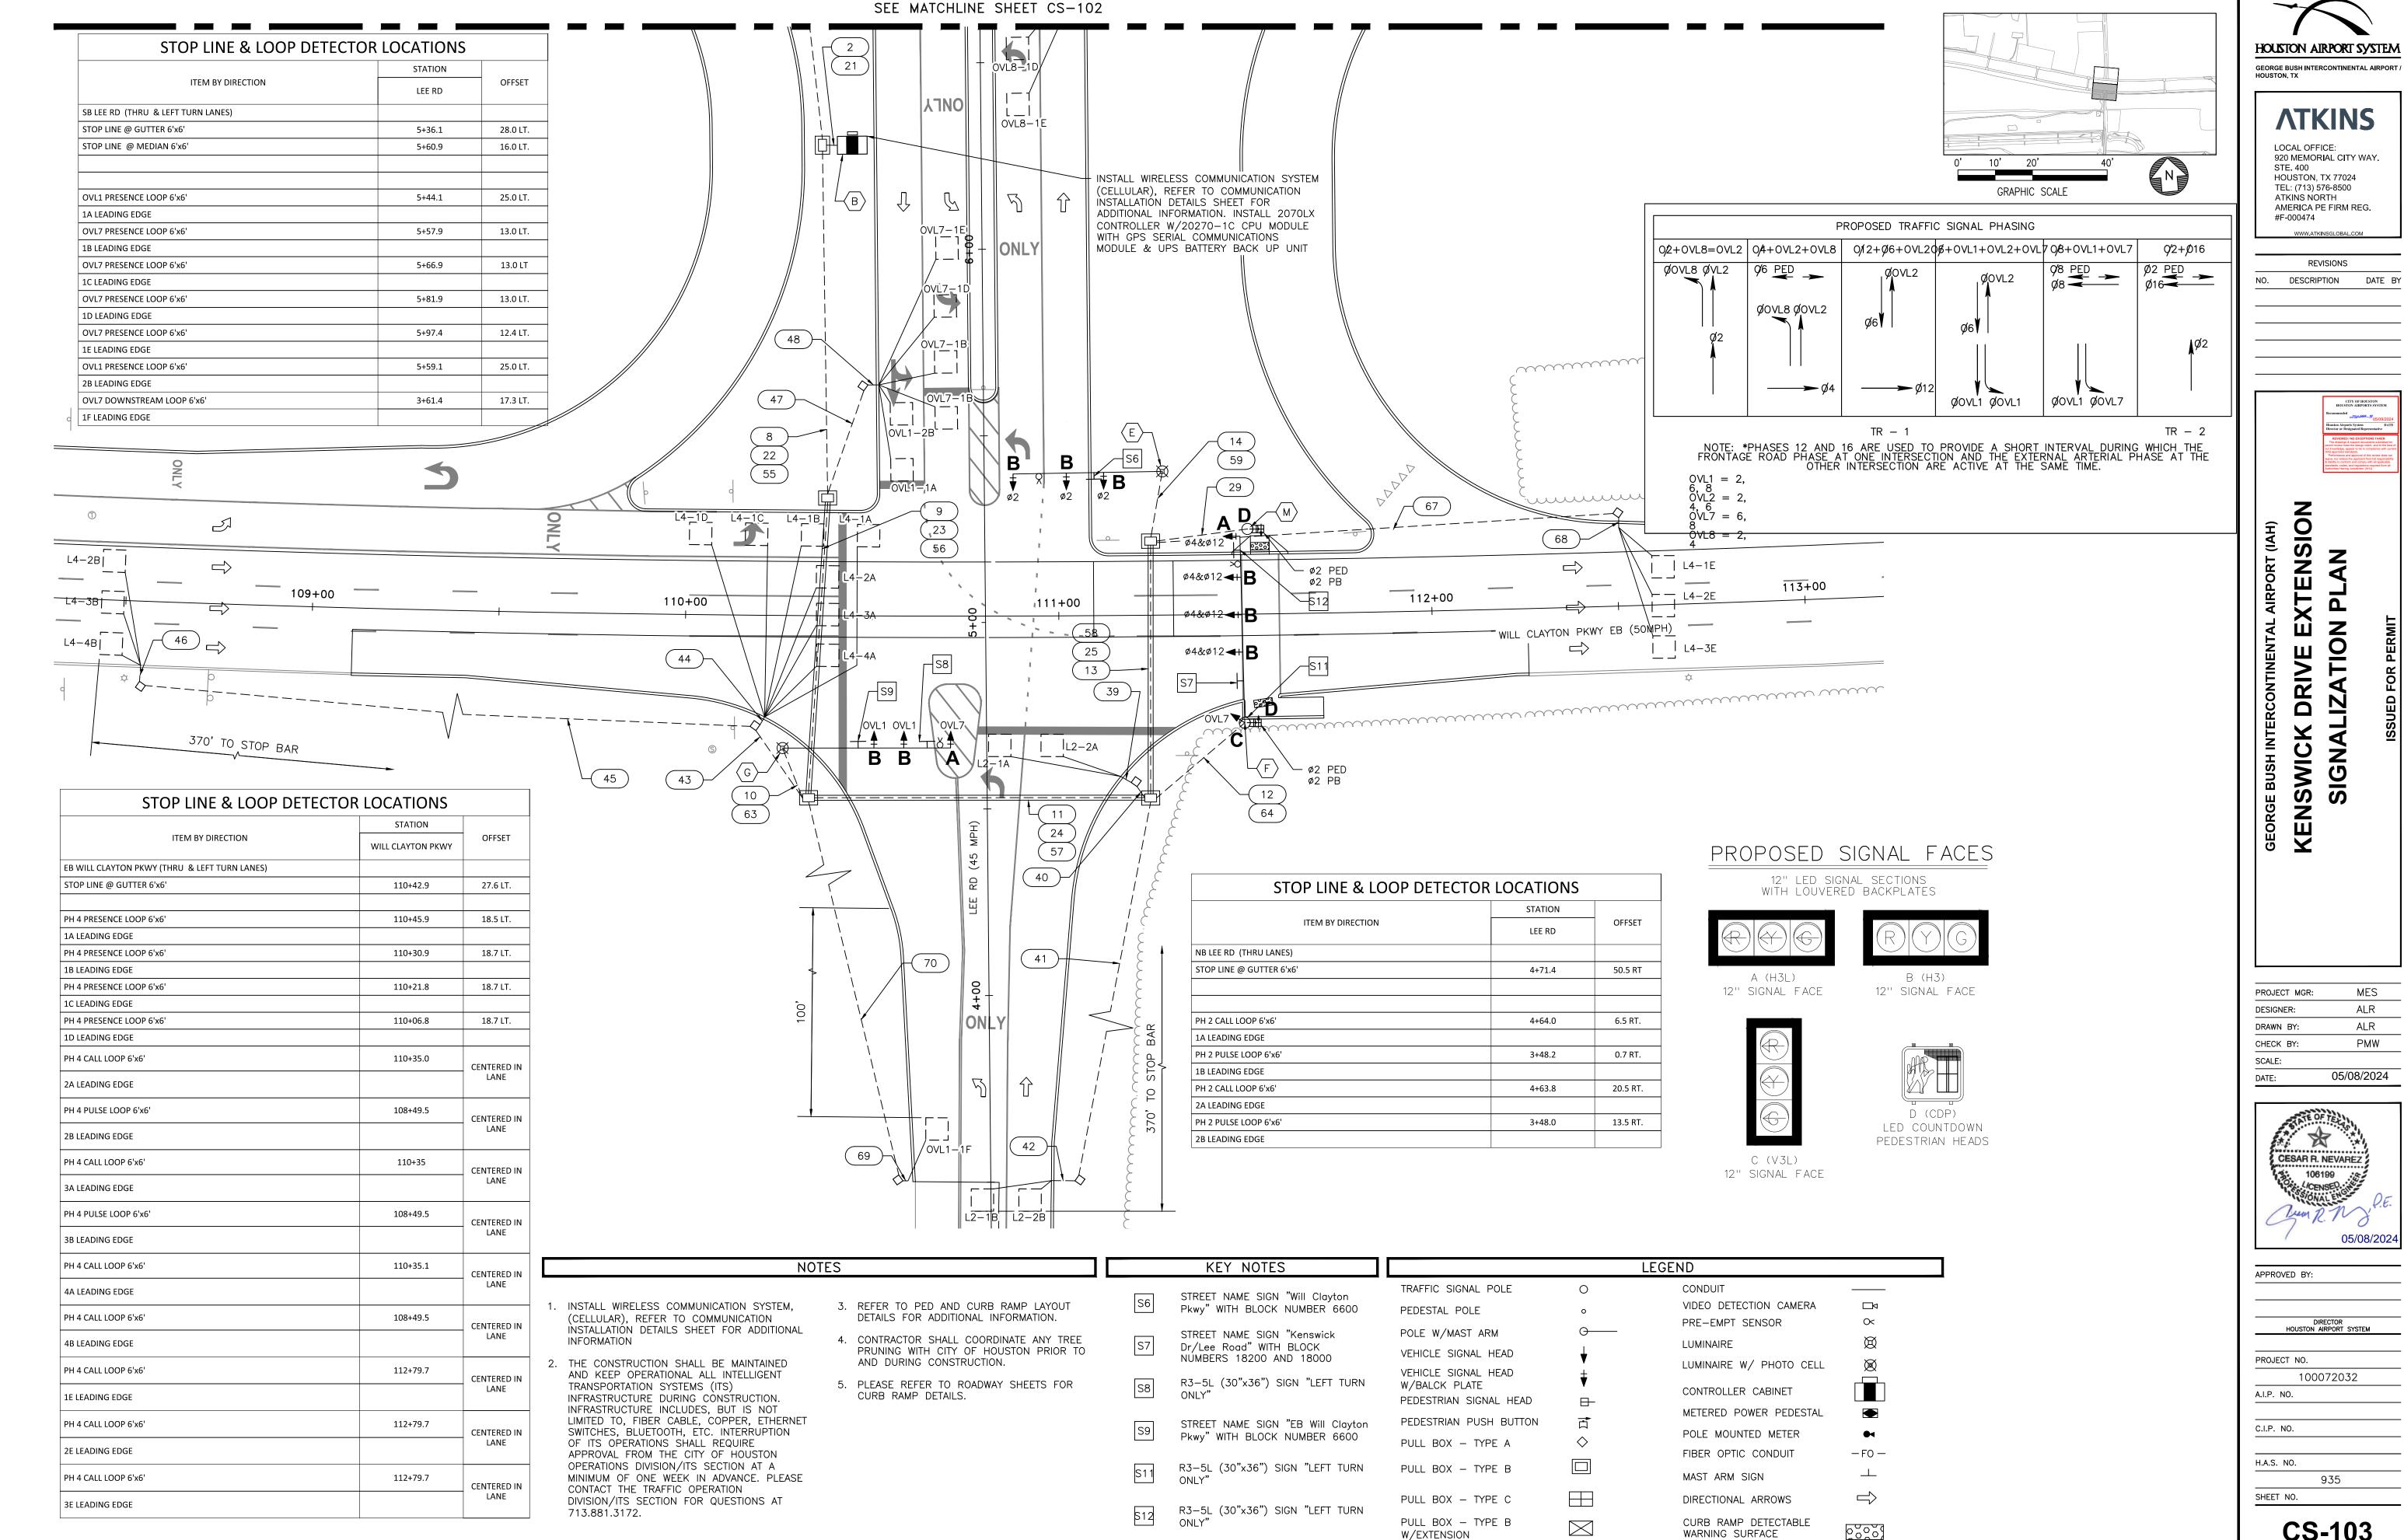

**CS-103** 

935

MES


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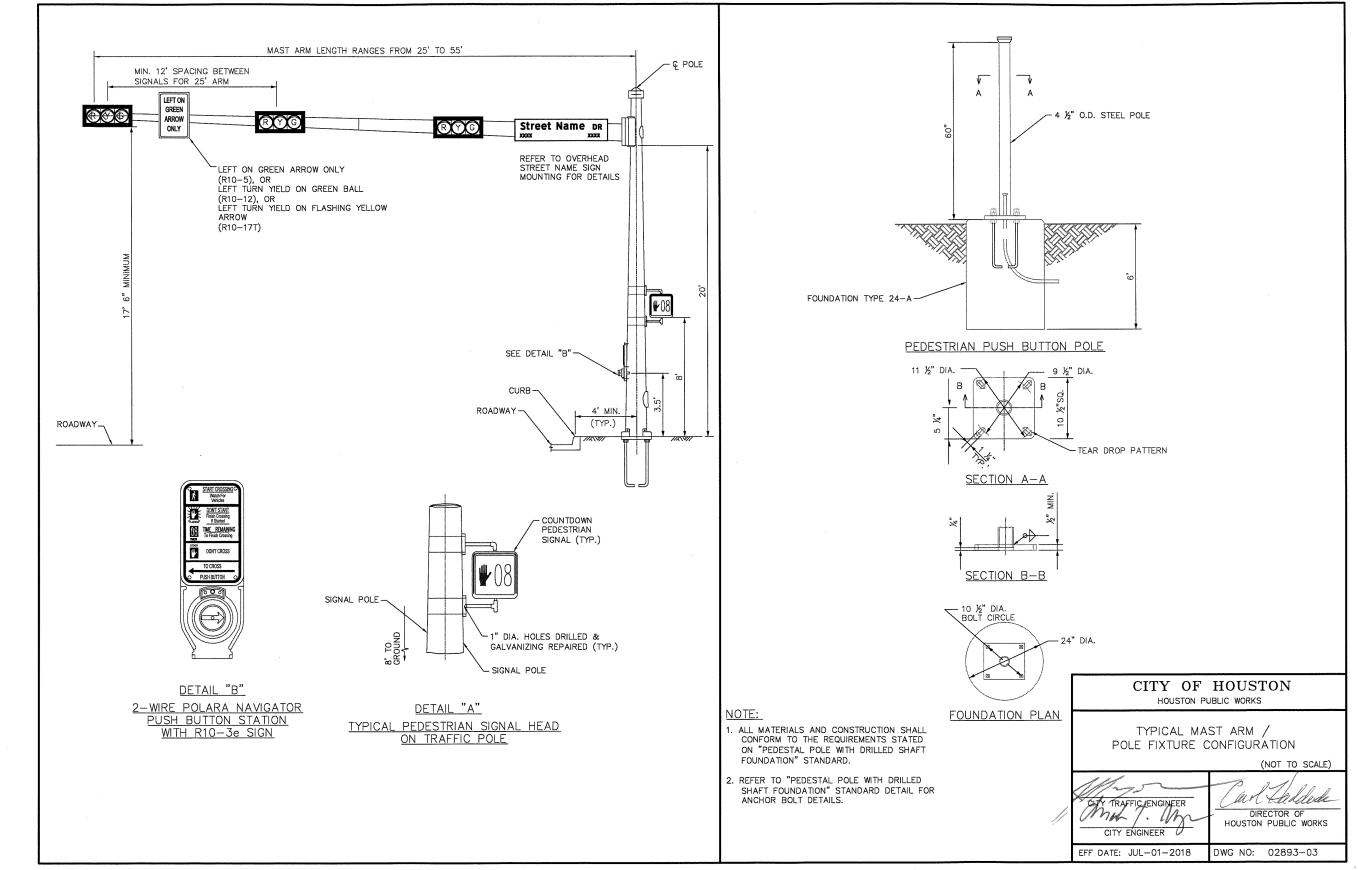
ALR


PMW


05/08/2024


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HOUSTON AIRPORT SYSTEM GEORGE BUSH INTERCONTINENTAL AIRPORT


**ATKINS** LOCAL OFFICE: 920 MEMORIAL CITY WAY, STE. 400 HOUSTON, TX 77024

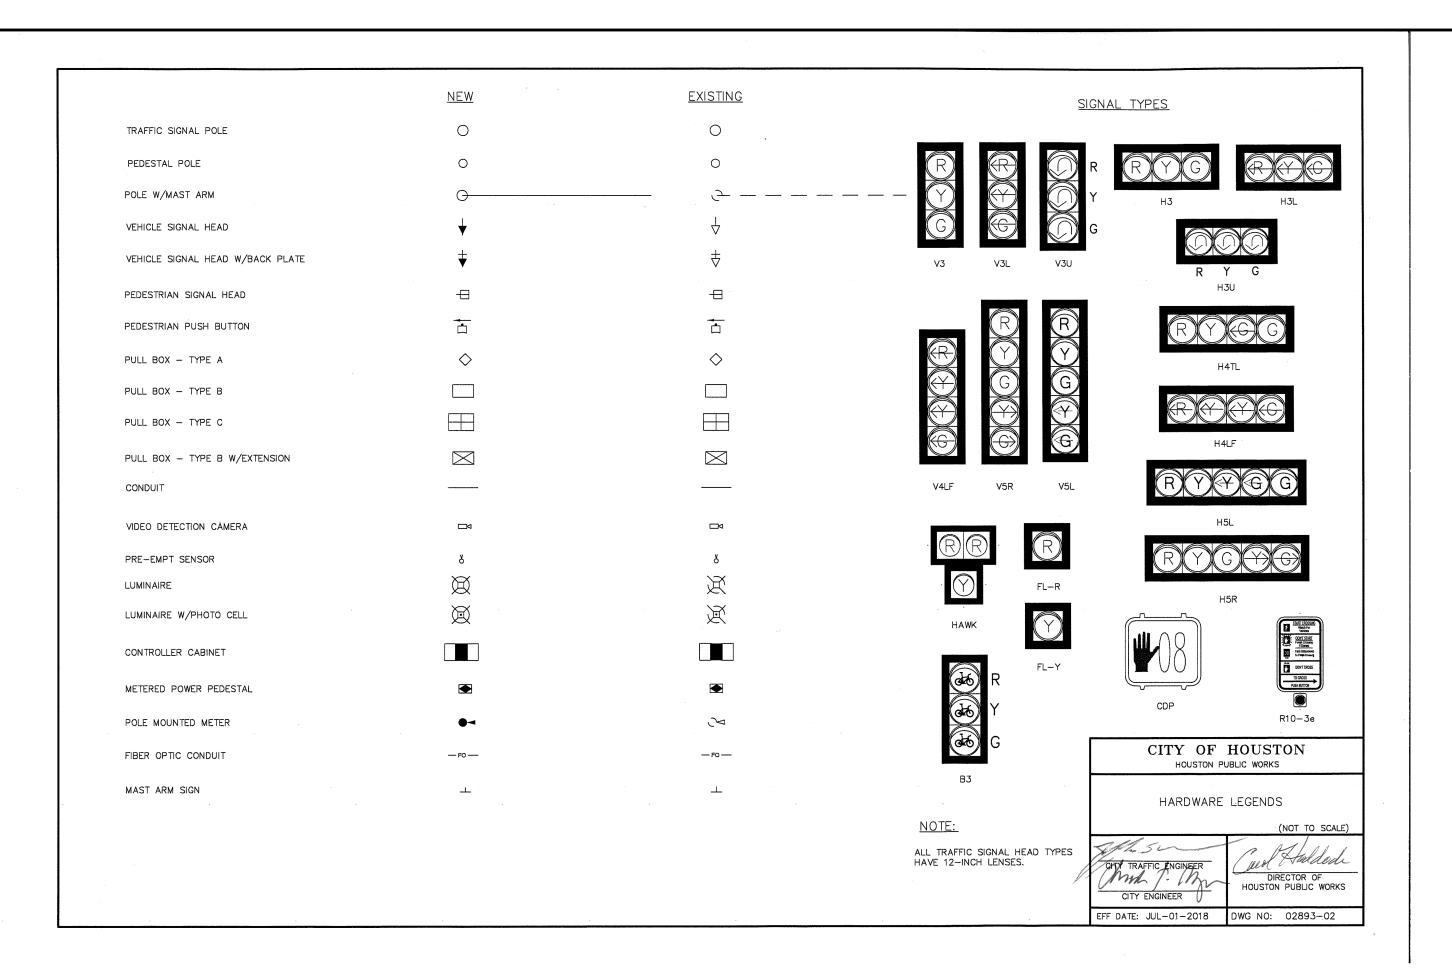TEL: (713) 576-8500 ATKINS NORTH AMERICA PE FIRM REG. #F-000474

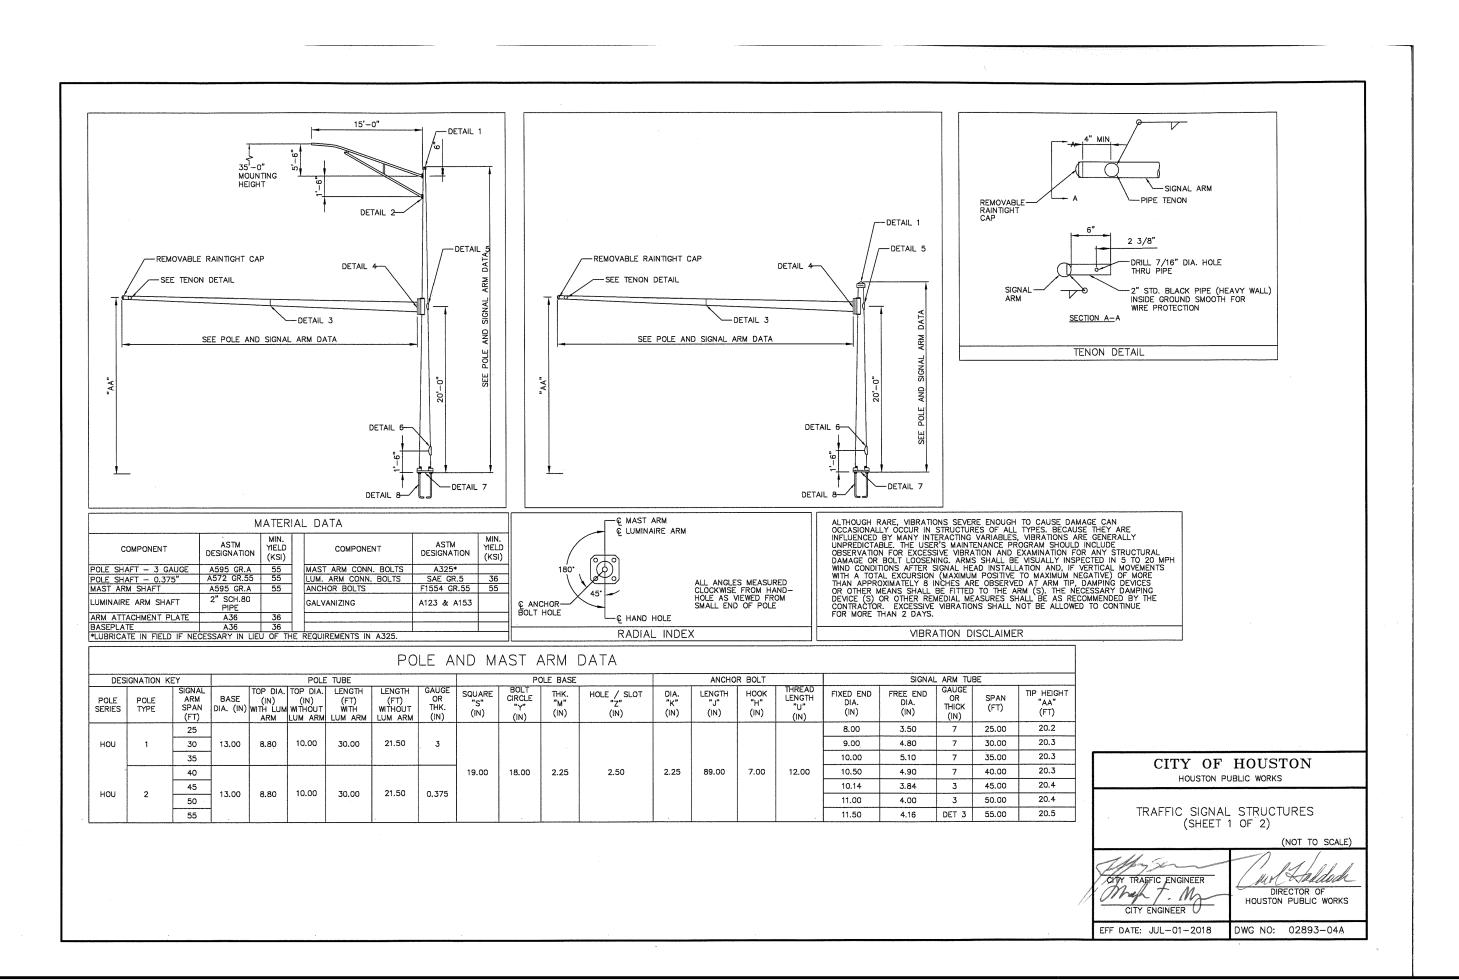REVISIONS NO. DESCRIPTION DATE BY

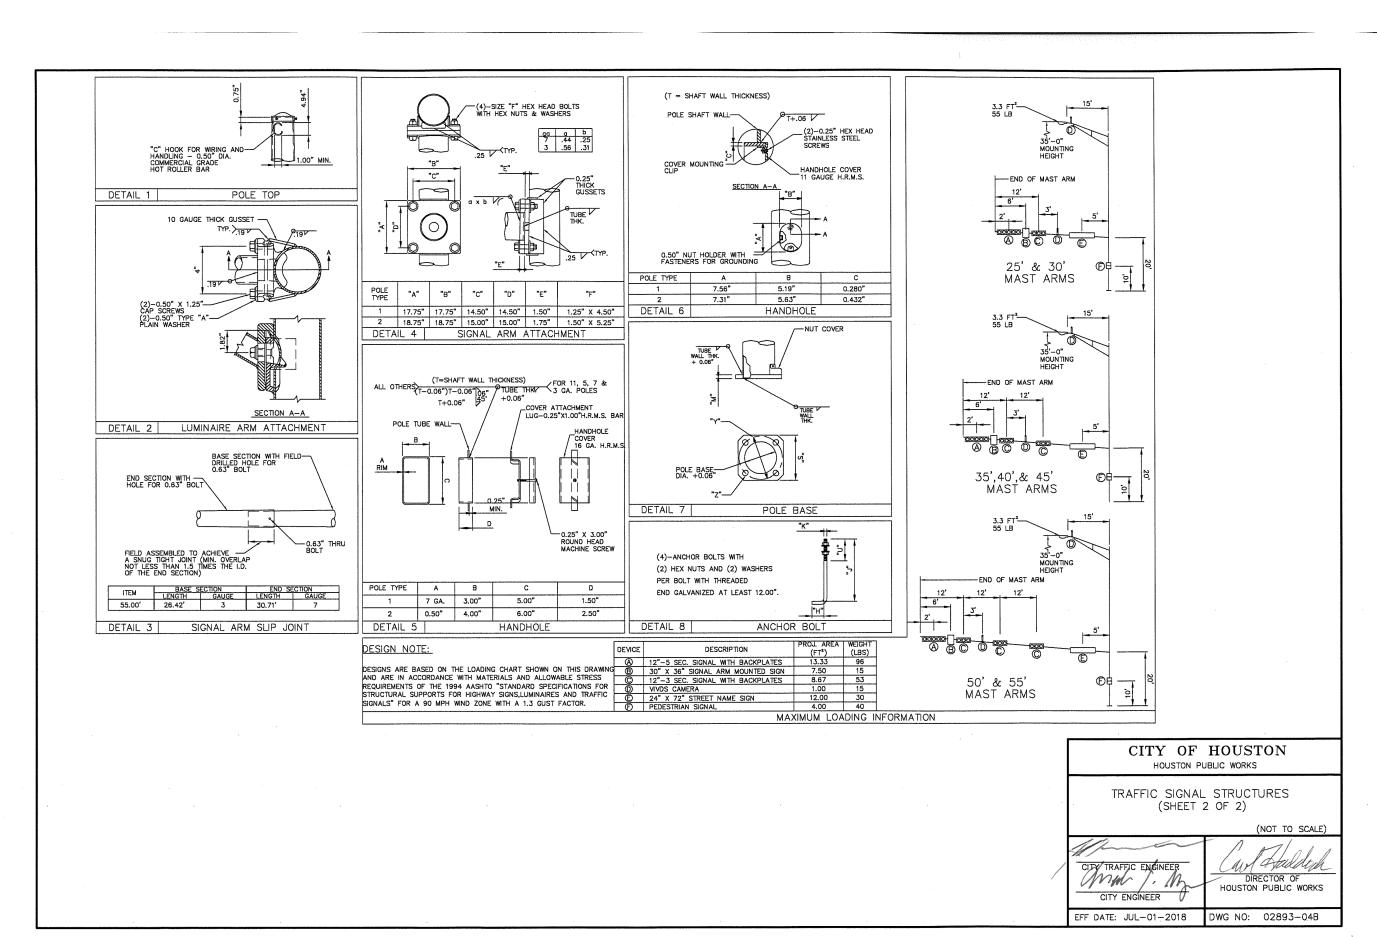PROJECT MGR: MES DESIGNER: ΚJV ΚJV DRAWN BY: MES CHECK BY: SCALE:

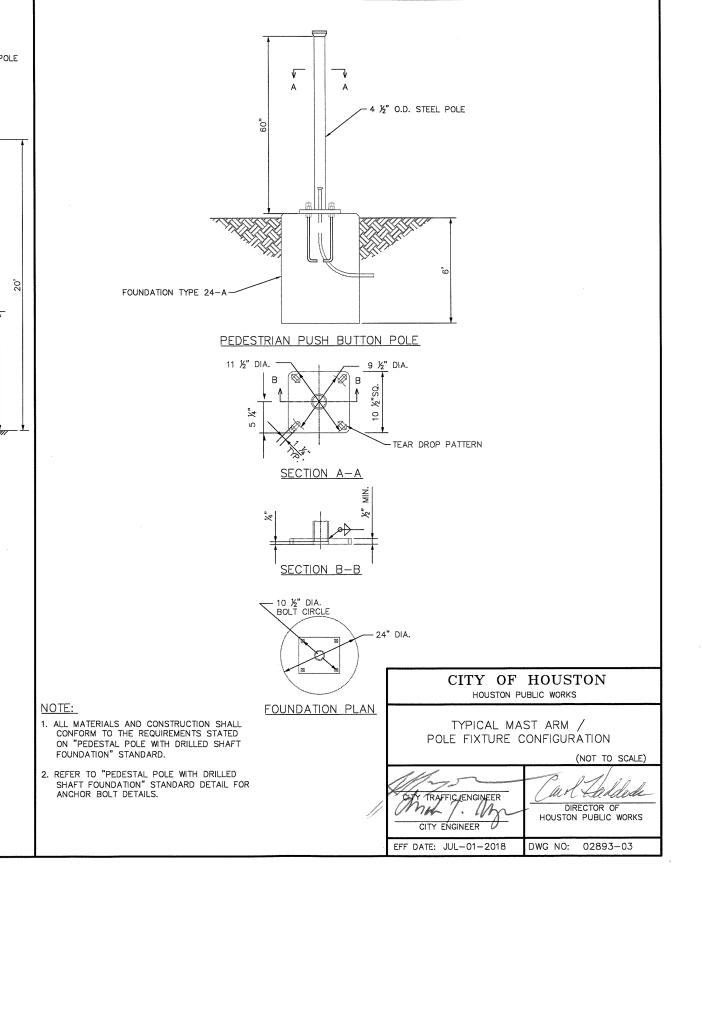05/08/2024

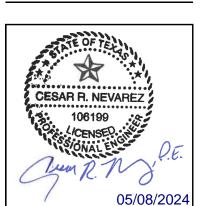

APPROVED BY:


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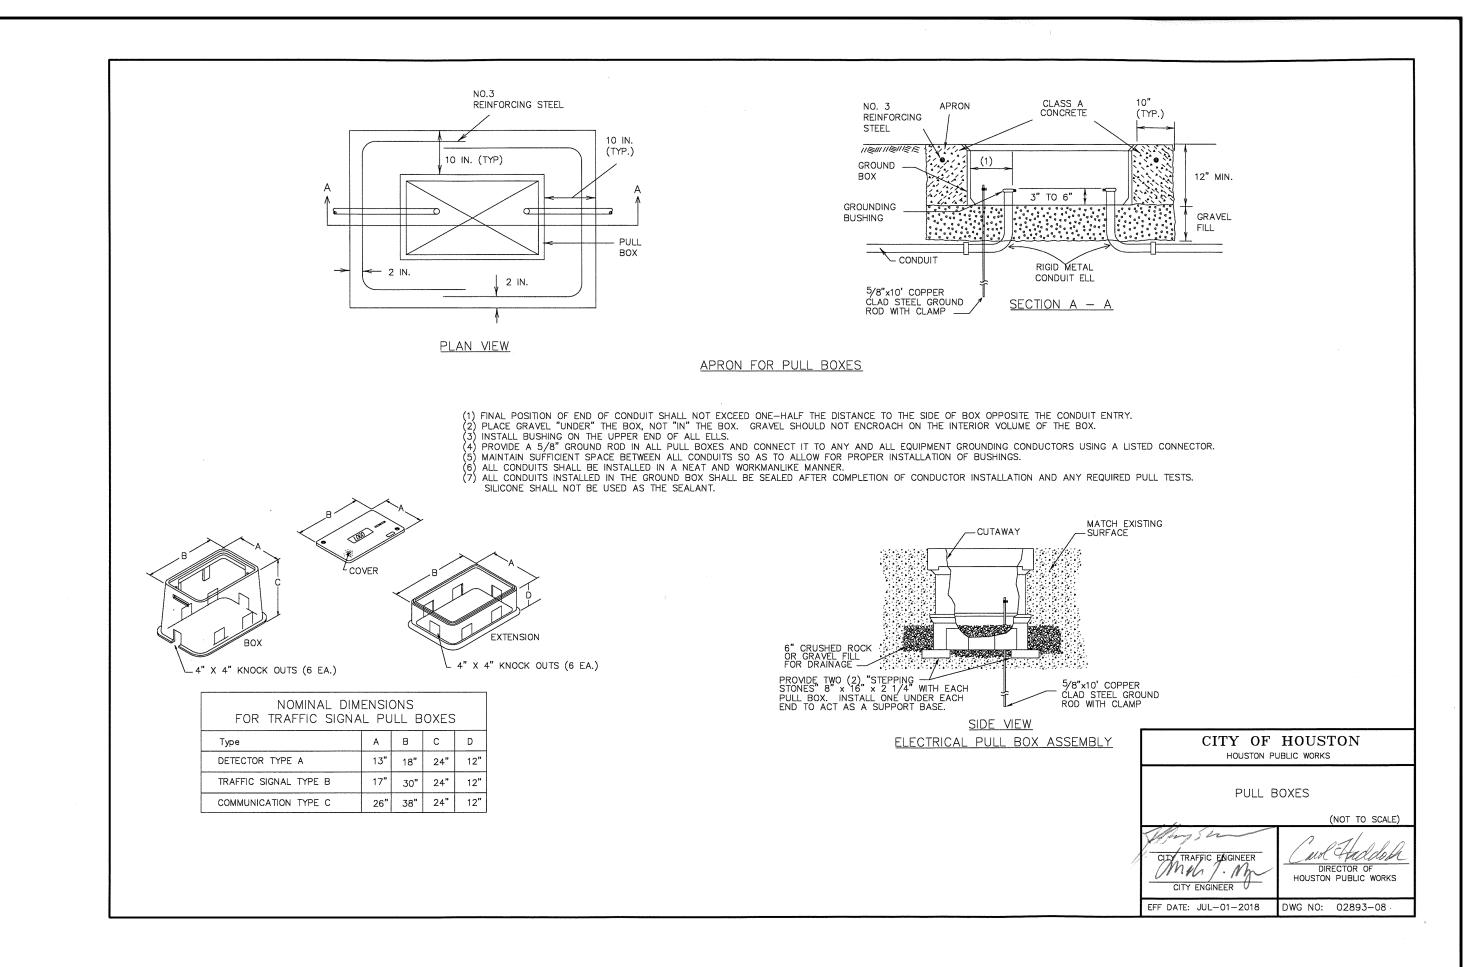
100072032 A.I.P. NO.


H.A.S. NO.


C.I.P. NO.

935 SHEET NO. 120 OF 125



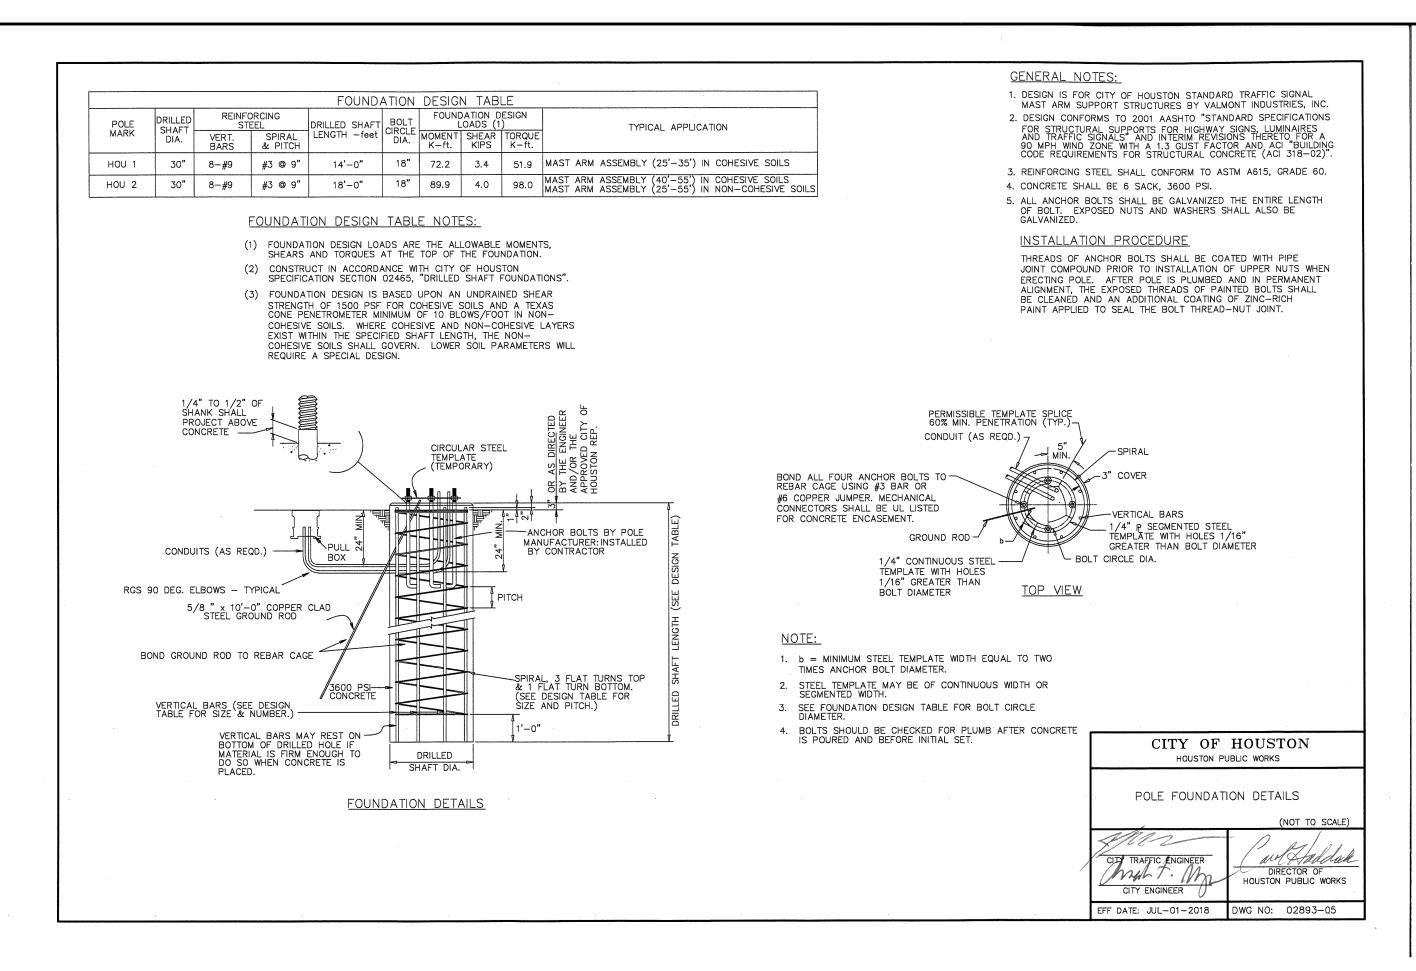

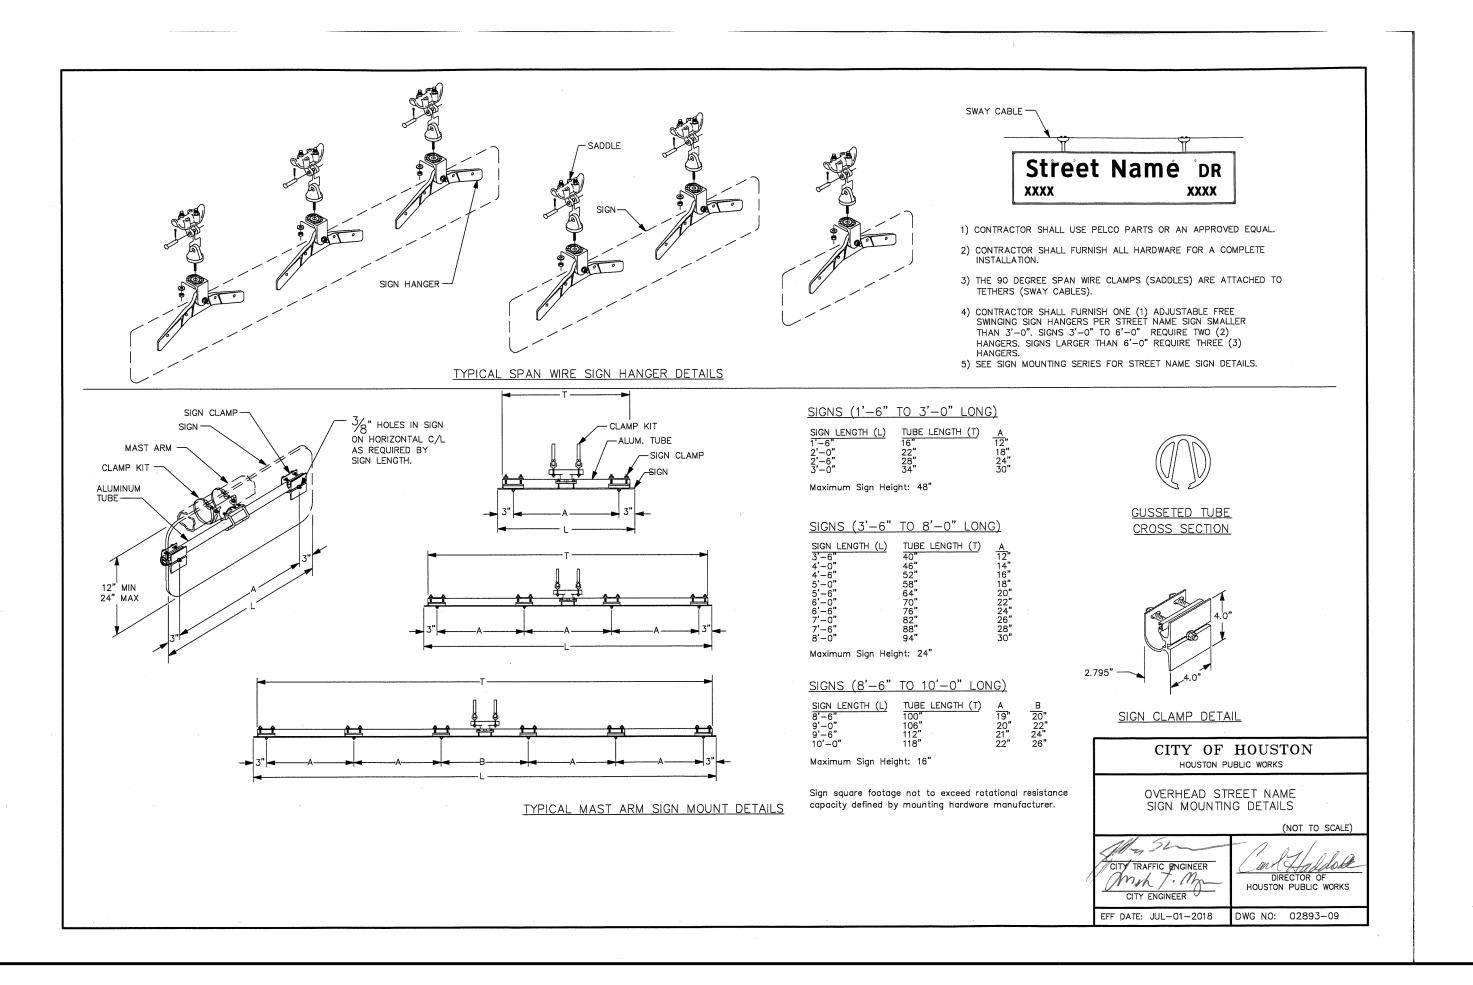

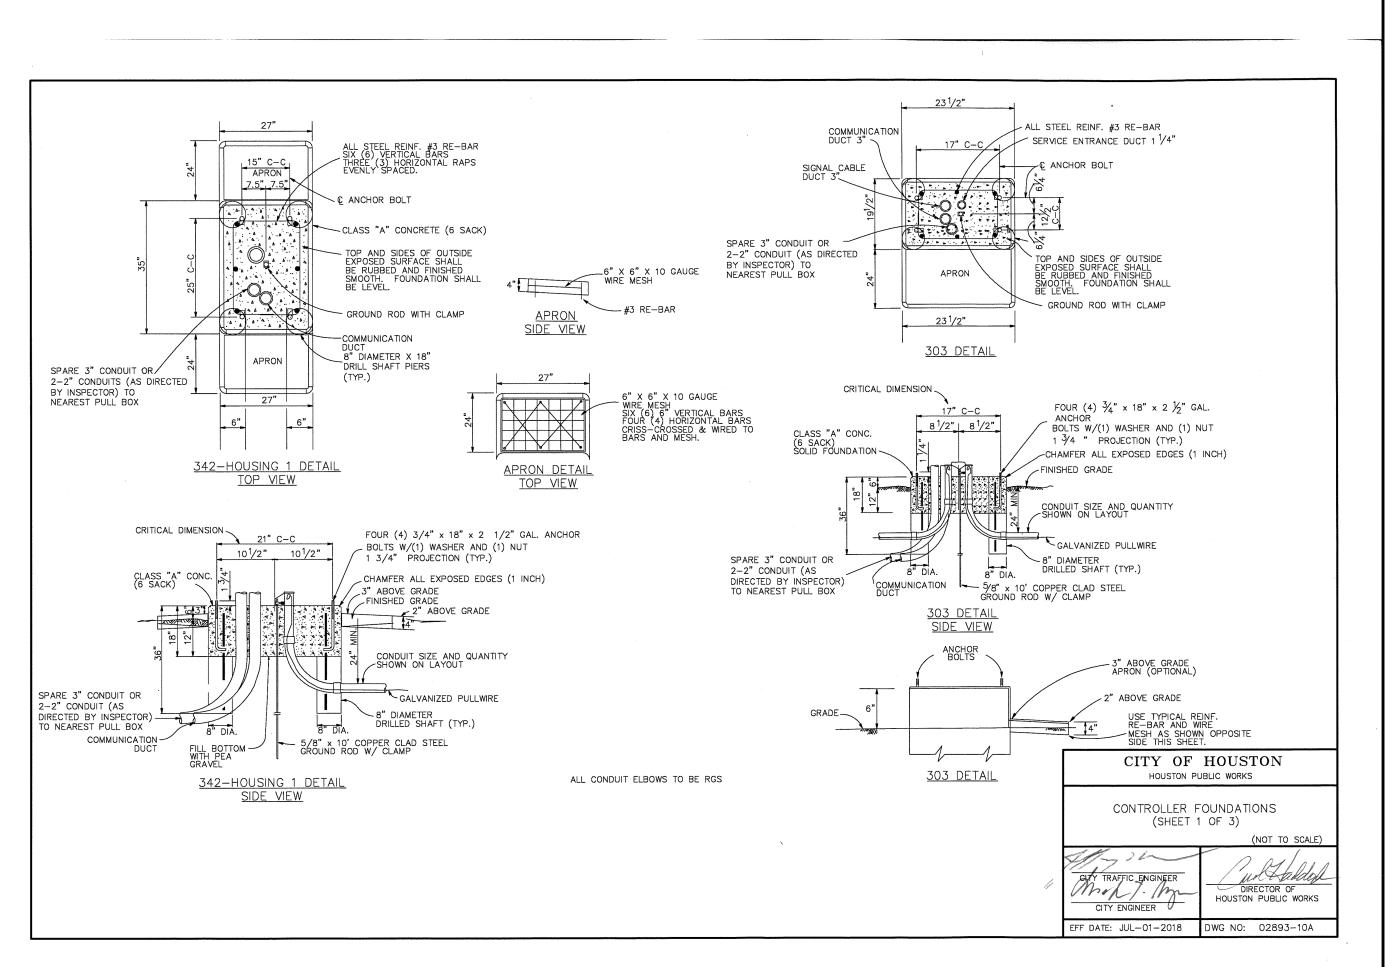



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REVISIONS NO. DESCRIPTION DATE BY

MES PROJECT MGR: DESIGNER: KJV ΚJV DRAWN BY: MES CHECK BY: SCALE: 05/08/2024 DATE:



APPROVED BY:


PROJECT NO.


100072032


A.I.P. NO. C.I.P. NO.

H.A.S. NO.

935 SHEET NO. 121 OF 125

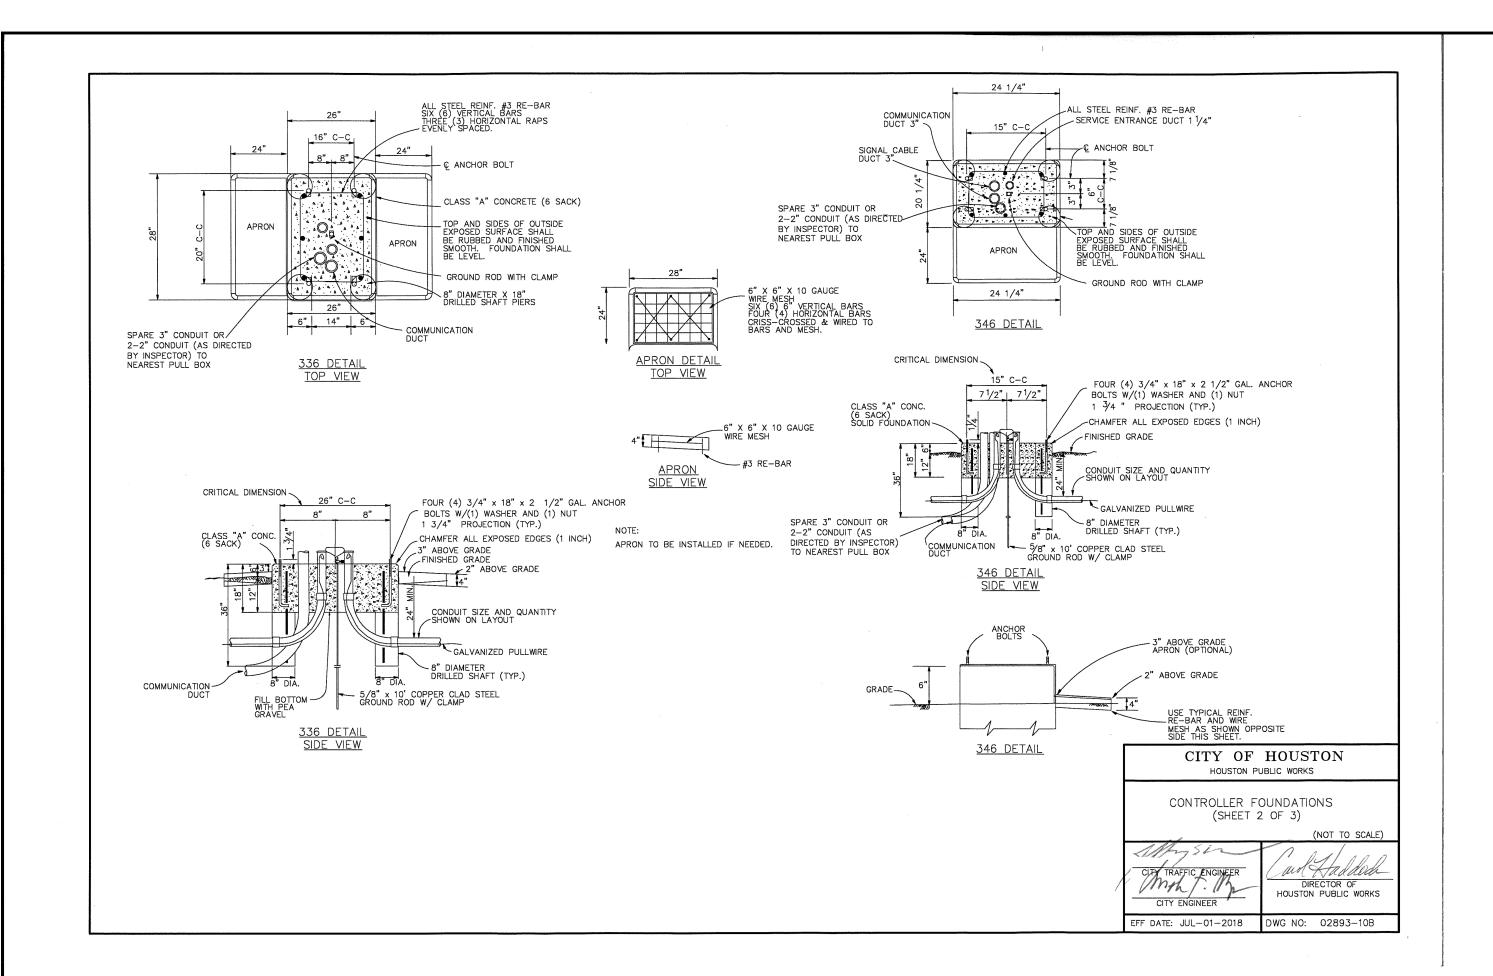

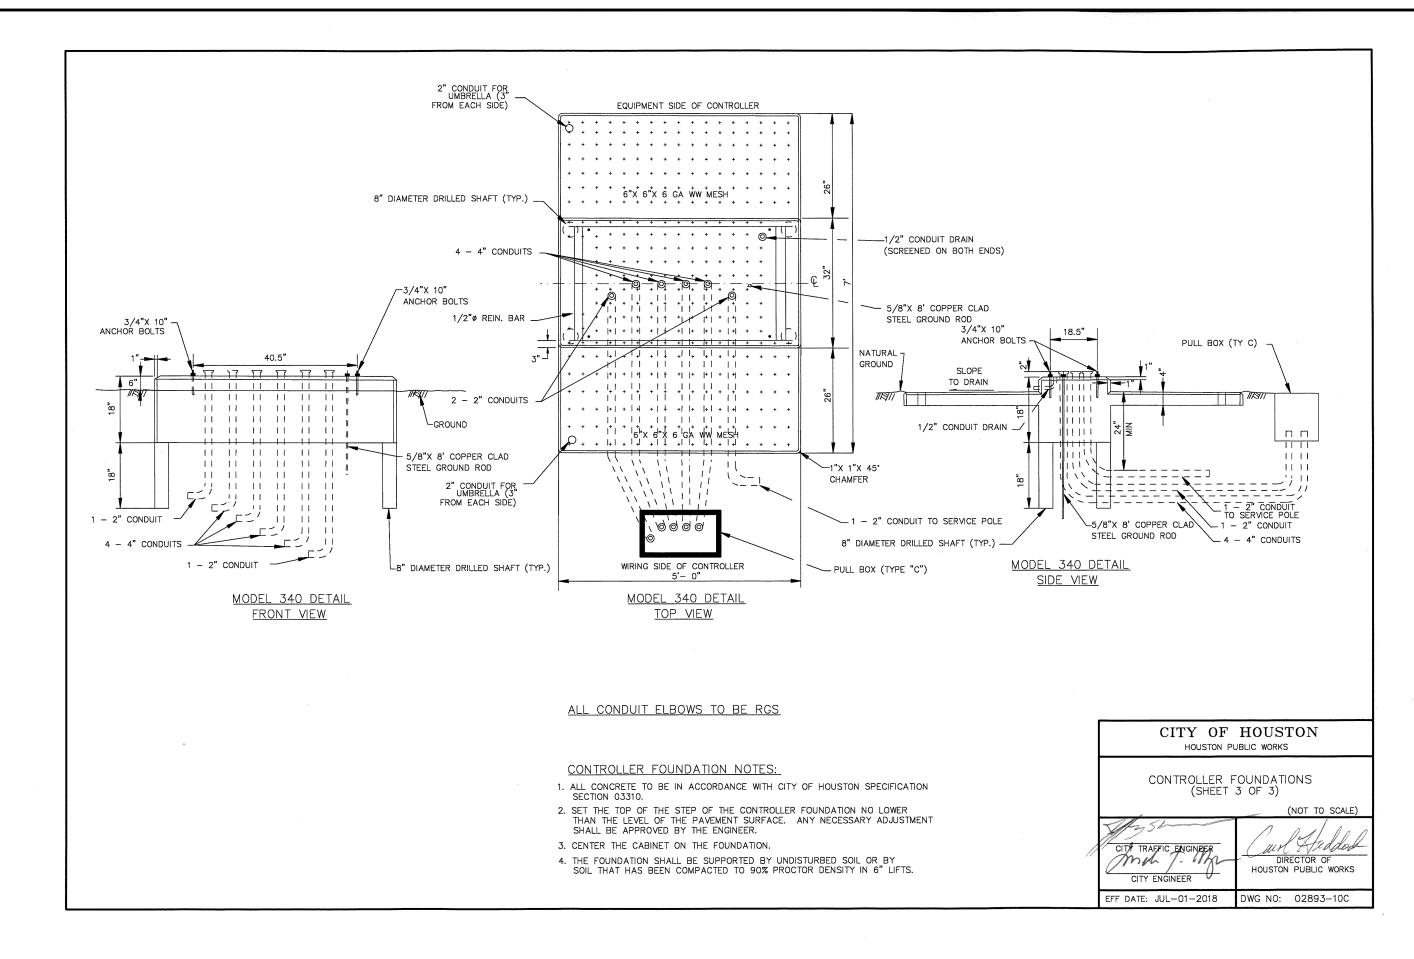

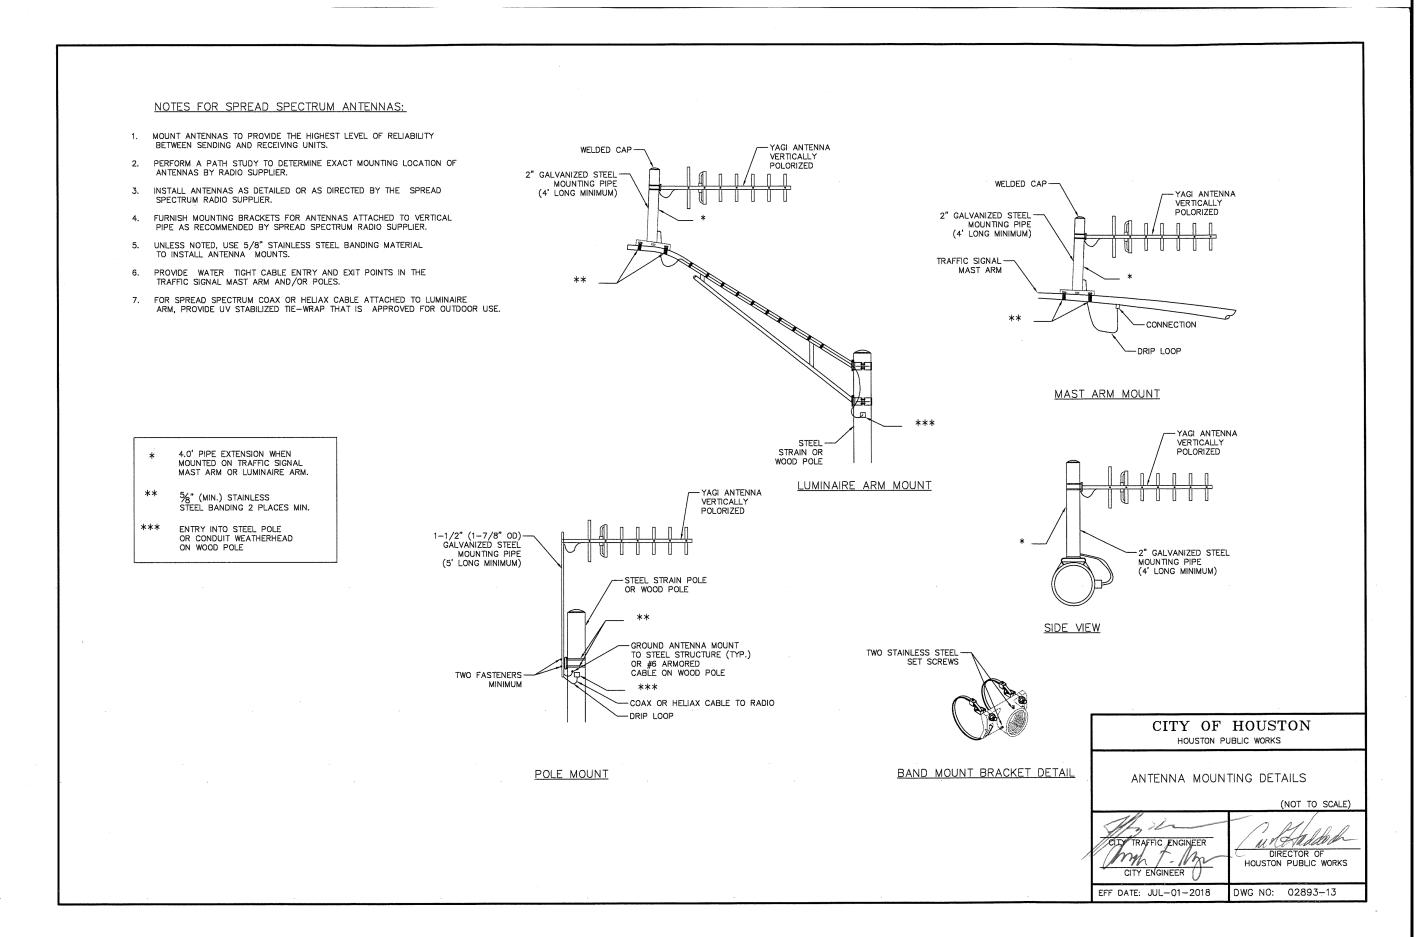



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PROJECT MGR: MES DESIGNER: KJV ΚJV DRAWN BY: MES CHECK BY: SCALE: 05/08/2024



APPROVED BY:

PROJECT NO.

100072032 AJI.P. NO.

C.I.P. NO. H.A.S. NO.

935 SHEET NO. 122 OF 125

### **GENERAL NOTES:**

- 12. ALL CONDUIT AND CONDUCTORS ATTACHED TO THE PEDESTAL 1. THE PEDESTAL SERVICE SHALL BE UL TYPE 3R, AND SHALL SERVICE AND WITHIN 12 INCHES OF THE PEDESTAL SERVICE BE CONSTRUCTED OF A MINIMUM OF 12 GAUGE STAINLESS WILL NOT BE PAID FOR DIRECTLY, BUT SHALL BE SUBSIDIARY STEEL OR ALUMINUM AS REQUIRED. STAINLESS STEEL SHALL TO THE PEDESTAL SERVICE. ALL SERVICE CONDUIT AND NOT BE PAINTED. FOR ALUMINUM, THE FINISH SHALL BE AN CONDUCTORS FROM THE UTILITY COMPANY TRANSFORMER ELECTROSTATIC APPLIED POLY-URETHANE BAKED ON POWDER. TO A POINT 12 INCHES FROM THE THE PEDESTAL SERVICE LIGHT GREEN IN COLOR, OR COLOR AS SHOWN ELSEWHERE SHALL BE PAID FOR SEPARATELY. SERVICE CONDUIT SHALL BE AND AS APPROVED BY THE ENGINEER. THE FRONT OF THE THE SIZE AND TYPE AS SHOWN IN THE ELECTRICAL SERVICE INTERIOR DEAD FRONT TRIM SHALL BE PERMANENTLY LABELED, "DANGER HIGH VOLTAGE" WITH OSHA STYLE LABEL. THE
- 13. DIMENSIONS MAY VARY TO ACCOMODATE REQUIRED EQUIPMENT, EXTERIOR OF THE PEDESTAL SERVICE DOOR SHALL BE UTILITY COMPANY REQUIREMENTS, OR MANUFACTURER'S PERMANENTLY LABELED WITH A PLACARD AS TO ITS USE STANDARD EQUIPMENT DIMENSIONS. THE CONTRACTOR SHALL (I.E. ROADWAY LIGHTING, TRAFFIC SIGNALS, ETC.). PLACARD SUBMIT TO THE ENGINEER FOR APPROVAL, SIX (6) COPIES OF SHALL BE NEAT AND PROFESSIONAL IN APPEARANCE. LETTERING BROCHURES AND/OR DRAWINGS OF THE PEDESTAL SERVICE SHALL BE 1" MINIMUM HEIGHT. TO BE SUPPLIED, INCLUDING ACTUAL DIMENSIONS, AND A PAINT 2. UTILITY ACCESS DOOR SHALL HAVE STAINLESS STEEL PIANO COLOR SAMPLE.
- AND STAINLESS STEEL LATCH WITH PROVISIONS FOR PADLOCKING. SERVICES. PHOTOCELL SHALL BE INSTALLED AS SHOWN HERE. 4 METER ACCESS SHALL BE HINGED AND CAPABLE OF PADLOCKING 5. THE PEDESTAL DOOR SHALL HAVE A MECHANICALLY ATTACHED 5. ALL MOUNTING HARDWARE AND INSTALLATION DETAILS OF DATA POCKET ON THE INSIDE. POCKET SHALL BE EITHER METAL SERVICES SHALL BE IN ACCORDANCE WITH UTILITY COMPANY OR THEMOPLASTIC AND SHALL MEASURE AT LEAST 12 INCHES SPECIFICATIONS. THE CONTRACTOR IS RESPONSIBLE FOR BY 12 INCHES. THE CONTRACTOR SHALL PREPARE AND SUBMIT CONTACTING THE LOCAL UTILITY COMPANY AND OBTAINING A SCHEMATIC DRAWING UNIQUE TO AN INDIVIDUAL SERVICE. THE THEIR APPROVAL OF PEDESTAL DETAILS PRIOR TO MAKING APPROVED DRAWING SHALL BE LAMINATED AND PLACED IN THE SUBMITTAL TO THE CITY AND PRIOR TO CONSTRUCTING THE DOCUMENT POCKET OF THE SERVICE AT THE TIME OF SHIPMENT ELECTRICAL PEDESTAL SERVICE. ANY CHANGES REQUIRED TO THE JOB SITE. ALL APPLICABLE WIRING DIAGRAMS AND PLAN BY THE UTILITY COMPANY SHALL BE NOTED ON THE SUBMITTALS. SHEET LAYOUTS FOR ALL EQUIPMENT AND BRANCH BREAKER 6. METER SOCKET SHALL BE A MINIMUM OF 100 AMP RATING AND CIRCUITS SUPPLIED BY THAT SERVICE SHALL ALSO BE LAMINATED SHALL COMPLY WITH THE LOCAL UTILITY REQUIREMENTS.
- AND PLACED IN THE DOCUMENT POCKET PRIOR TO SHIPPING. 16. GROUND ROD CLAMP TO BE ULLISTED FOR DIRECT BURIAL. ALL SHOWN ON ED(5). SHIELD TO CONTROL STRAY LIGHT IS ALLOWABLE. NON-CONDUCTIVE COATING TO BE REMOVED FROM GROUND ROD THE CONTRACTOR SHALL BE RESPONSIBLE FOR PROPER OPERATION WIRE TO BE #6 AWG SOLID COPPER. METAL CONDUIT ELLS TO HAVE OF THE PHOTO-ELECTRIC CONTROL. THE CONTRACTOR SHALL GROUNDING BUSHING AND BONDING JUMPERS CORRECTLY MOVE AND/OR ADJUST OR SHIELD THE PHOTOCELL FROM STRAY OR INSTALLED.

14. A SEPARATE ENCLOSURE AS SHOWN ON TXDOT STANDARD

ED(4) OR ED(5) FOR PHOTOCELL SHALL NOT BE USED FOR PEDESTAL

PLANS, THE PHOTOCELL SHALL TURN ON THE ILLUMINATION SYSTEM SIGNAL CABLE NOT TO BE MEGGED AFTER CONNECTION, AS ELECTRONICS WILL BE DAMAGED. 19. TOP OF CONCRETE FOUNDATION TO BE FINISHED IN A NEAT AND WORKMAN LIKE MANNER. IF LEVELING WASHERS ARE USED, NO MORE THAN 1/2 IN. HEIGHT SHALL BE USED AT ANY ONE CORNER. MAXIMUM HANDLE SHALL PROTRUDE THROUGH HINGED DEADFRONT TRIM AND DIP OR RISE IN FOUNDATION IS NOT TO EXCEED 1/8 IN PER FOOT. WHEN PROPERLY INSTALLED, TOP OF SERVICE ENCLOSURE SHALL CONCRETE FOR PEDESTAL SERVICE FOUNDATION SHALL BE CLASS A READ LEVEL FRONT TO BACK AND SIDE TO SIDE WITHIN  $\frac{1}{2}$  IN.

ROCKING OR MOVEMENT OF THE SERVICE ENCLOSURE SHALL BE

PREPARED BY THE CONTRACTOR AT NO COST TO THE STATE. 20. LIQUID TIGHT FLEXIBLE METAL CONDUIT SHALL NOT BE ALLOWED

CITY	OF	HOU	STON	1
Н	OUSTON F	PUBLIC WO	RKS	
ELECTR PEDES				
			(NOT	TO SCALE

		(NOT TO SCALE
9	CITY TRAFFIC ENGINEER  CITY ENGINEER	DIRECTOR OF HOUSTON PUBLIC WORKS
	EFF DATE: JUL-01-2018	DWG NO: 02893-14

All existing and propose Intelligent Transportation Systems (ITS) infrastructure must be field verified and included on all design plans. ITS Infrastructure includes, but not limited to, fiber optic cable, copper cable, Ethernet switches, Bluetooth equipment, CCTV cameras, Dynamic Message Sign, midblock counter, etc. Any interruption of ITS operations requires City of Houston Transportation and Drainage Operations/ITS section approval at a minimum of one (1) week in advance. Contact City's ITS Section for questions regarding ITS infrastructure, communication equipment and interruption approval request at 713-881-3000.

unit, if applicable. All ITS infrastructure shall be designed and installed as outlined in the Communication details. Contact City's ITS section for compatibility questions with City of Houston communication infrastructure.

For a proposed/new signalized intersection, new ITS communication infrastructure and Communication Details must be included in the design plans. All ITS communication devices shall be furnished and installed by the contractor with the exceptions of Bluetooth reader, Router and Air-card (Cellular card). The proposed ITS equipment must meet the latest City of Houston specifications and design details. Please contact the City's ITS section for equipment specific questions and/or Communication Details at 713.881.3000.

(1) - Managed Field Hardened Ethernet switch shall be compatible with existing COH ITS infrastructure. Contractor shall be responsible for all compatibility testing and providing results to COH ITS Section. Proposed equipment different from the current standard. Contact COH ITS Section (713.881.3000) for more information. (2) - Bluetooth reader, Router and Air-card shall be provided by COH ITS Section.

Fiber Optic Cable Installation - Material List

Description

2 Single Fiber Distribution Unit with SC connector

6 Managed Field Hardened Ehternet Switch (1)

1 Fiber Optic Cable

4 Fiber cable jumper

7 Meraki Router (2)


8 Battery Backup Unit


9 Bluetooth reader (2) and antenna

5 Ethernet cable

3 Shelf mounting on DIN rail

# Fiber Optic Cable Installation Detail

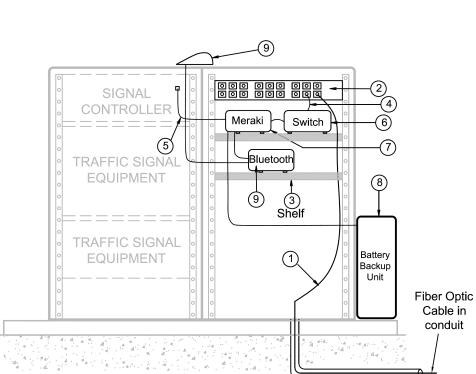

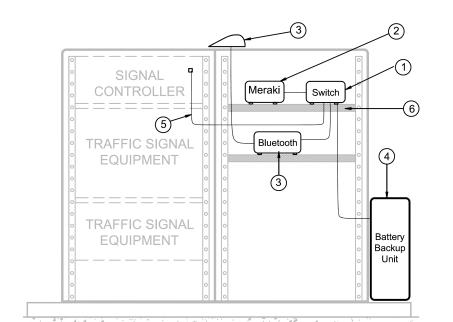

Cellular Installation Detail

1 F

Cellular Modem Installation - Material List

Description

1 Managed Field Hardened Ehternet Switch (1)


2 Meraki Router (2)


4 Battery Backup Unit

6 Shelf mounting on DIN rail

5 Ethernet cable

3 Bluetooth reader (2) and antenna

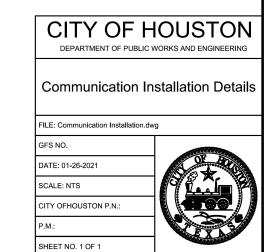

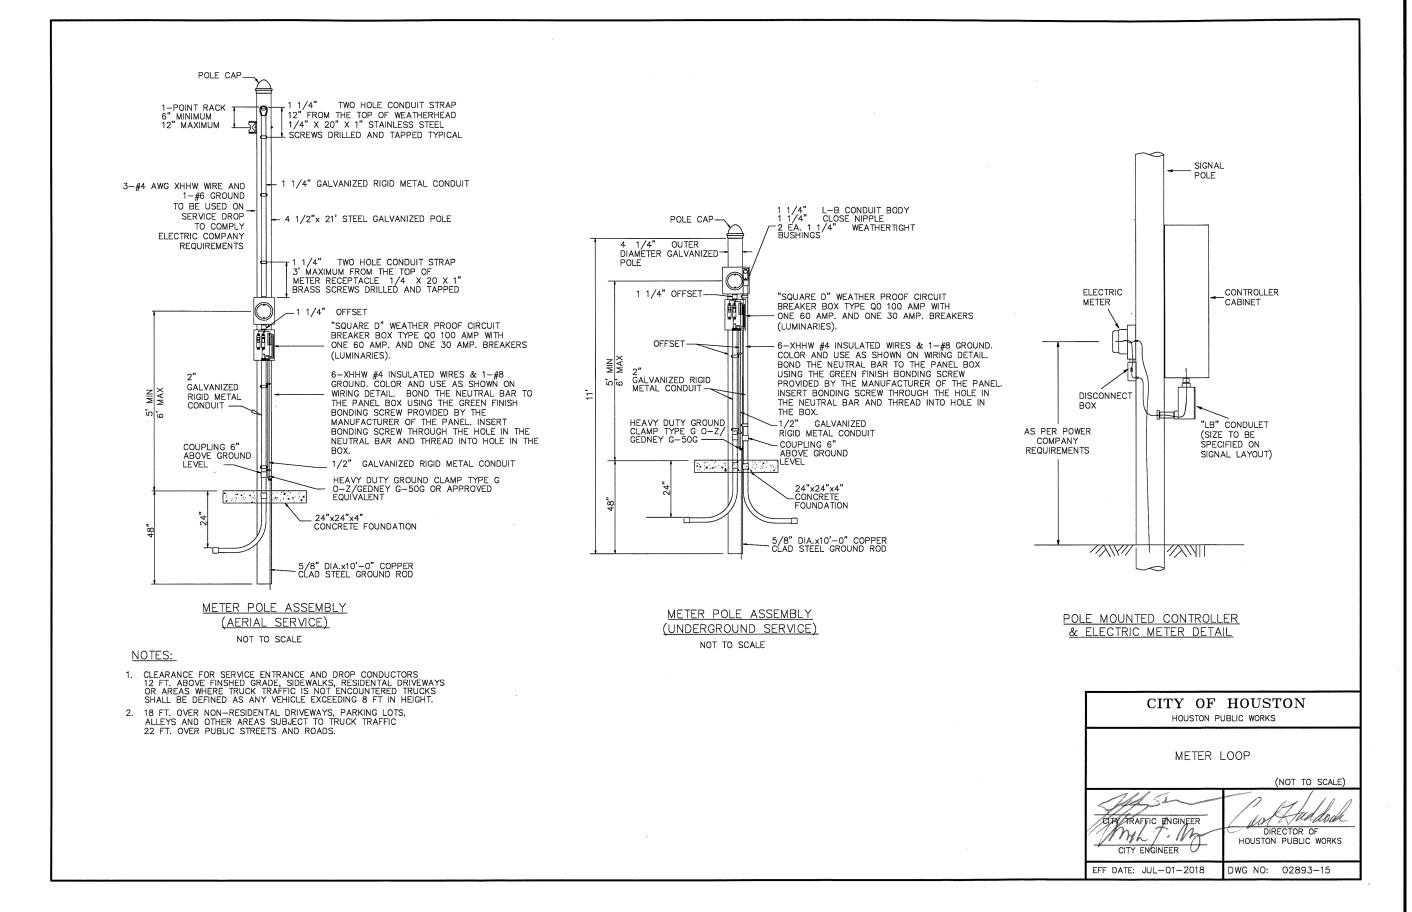



GEORGE BUSH INTERCONTINENTAL AIRPORT **ATKINS** 

LOCAL OFFICE: 920 MEMORIAL CITY WAY, STE. 400 HOUSTON, TX 77024 TEL: (713) 576-8500 ATKINS NORTH AMERICA PE FIRM REG. #F-000474 WWW.ATKINSGLOBAL.COM

REVISIONS NO. DESCRIPTION DATE BY

PROJECT MGR:	MES
DESIGNER:	KJV
DRAWN BY:	KJV
CHECK BY:	MES
SCALE:	
DATE:	05/08/2024



APPROVED BY:

PROJECT NO. 100072032

A.I.P. NO. C.I.P. NO.

H.A.S. NO.

SHEET NO. 123 OF 125

For a modified or reconstructed signalized intersection, all existing ITS infrastructure must be shown on design plan and kept operational during construction. If there is no existing ITS communication devices, new devices shall be installed and included in the design. If there is existing ITS communication devices, all devices shall be relocated to proposed cabinet with the exceptions of switches and fiber distribution

PROPOSED TRAFFIC SIGNAL POLE SCHEDULE (KENSWICK DR)  POLE SIGNALS PED PR									
POLE IUMBER	POLE NUMBER	POLE TYPE	MAST ARM	MOUNTING	FACE	PED PB TYPE/SIGN	REMARKS	LOCATION	STANDARDS
POLE C	15' 12' 11' 17'	TYPE -2	55'	4 - ASTRO-BRAC 1 - SIDE OF POLE	4 - H3 1 - V3L	-	PRE-EMPT SENSOR, SIGNS: S4 = STREET NAME S5 = R3-7R (30 X 30) S10 = R3-5L (30 X 36)	AT APPROXIMATE POLE C-STA 7+71.2, 82.6' LT SB KENSWICK DR CONST CL	02893-02 02893-03 02893-04A 02893-04B 02893-05 02893-09 02893-12
POLE D	15' 12' 18'	TYPE -2	45' W/ LUM (106-WATT SYSTEM MAX LED COBRA HEAD LUMNAIRE)	3 - ASTRO-BRAC	2 - H3 1 - H3L	-	PRE-EMPT SENSOR, LUMINAIRE, SIGNS: S1 = R3-5L (30 X 36) S2 = STREET NAME	AT APPROXIMATE POLE D-STA 7+92.7, 48.8' RT NB KENSWICK DR CONST CL	02893-02 02893-03 02893-04A 02893-04B 02893-05 02893-09 02893-12
POLE E	11' 10' 19'	TYPE -2	40' W/LUM (106-WATT SYSTEM MAX LED COBRA HEAD LUMNAIRE)	3 - ASTRO-BRAC	3 - H3	-	PRE-EMPT SENSOR, LUMINAIRE, SIGNS: S6 = STREET NAME	AT APPROXIMATE POLE E-STA 5+40.0, 47.7' RT NB KENSWICK DR CONST CL	02893-02 02893-03 02893-04A 02893-04B 02893-05 02893-12
POLE F	* * * * * * * * * * * * * * * * * * *	TYPE -2	50'	4 - ASTRO-BRAC 2 - SIDE OF POLE	3 - H3 1 - H3L 1 - V3L 1 - CDP	POLARA NAVIGATOR R10-3e ( L )	PRE-EMPT SENSOR, LUMINAIRE, SIGNS:  S7 = STREET NAME  S11 = R3-5L (30 X 36)  S12 = R3-5L (30 X 36)	AT APPROXIMATE POLE F-STA 4+72.5, 69.2' RT NB KENSWICK DR CONST CL	02893-02 02893-03 02893-04A 02893-04B 02893-05 02893-09 02893-12
POLE G	21' 12' 12' .	TYPE -2	45' W/LUM (106-WATT SYSTEM MAX LED COBRA HEAD LUMNAIRE)	3 - ASTRO-BRAC 1 - SIDE OF POLE		-	PRE-EMPT SENSOR, LUMINAIRE, SIGNS: S8 = R3-5L (30 X 36) S9 = STREET NAME	AT APPROXIMATE POLE G-STA 4+66.8, 54.7'LT SB KENSWICK DR CONST CL	02893-02 02893-03 02893-04A 02893-04B 02893-05 02893-09 02893-12
POLE H	11' 12' 12' .	TYPE -1	35' W/ LUM (106-WATT SYSTEM MAX LED COBRA HEAD LUMNAIRE)	3 - ASTRO-BRAC	3 - НЗ	-	PRE-EMPT SENSOR, LUMINAIRE, SIGNS: S3 = STREET NAME	AT APPROXIMATE POLE H-STA 7+00.9, 45.0'LT SB KENSWICK DR CONST CL	02893-02 02893-03 02893-04A 02893-04B 02893-05 02893-09 02893-12
POLE I		PED POLE 15'	-	1 - SIDE OF POLE	1 - CDP	POLARA NAVIGATOR R10-3e ( L )	PEDESTRIAN POLE	AT APPROXIMATE POLE 1- STA 7+76.2, 47.7' RT NB KENSWICK DR CONST CL	02893-02 02893-03 02893-06 02893-07
POLE J		PED POLE 15'	-	1 - SIDE OF POLE	1 - CDP	POLARA NAVIGATOR R10-3e (R)	PEDESTRIAN POLE	AT APPROXIMATE POLE J - STA 7+70.6, 58.3' LT SB KENSWICK DR CONST CL	02893-02 02893-03 02893-06 02893-07
OLE K	E O I	PED POLE 15'	-	1 - SIDE OF POLE	1 - CDP	POLARA NAVIGATOR R10-3e ( L )	PEDESTRIAN POLE	AT APPROXIMATE POLE K - STA 7+63.5, 65.4'RT NB KENSWICK DR CONST CL	02893-02 02893-03 02893-06 02893-07
OLE L		PED POLE 15'	-	1 - SIDE OF POLE	1 - CDP	POLARA NAVIGATOR R10-3e (R)	PEDESTRIAN POLE	AT APPROXIMATE POLE L - STA 7+06.8, 57.4'RT NB KENSWICK DR CONST CL	02893-02 02893-03 02893-06 02893-07
POLE M		PED POLE 15'	-	1 - SIDE OF POLE		POLARA NAVIGATOR R10-3e (R)	PEDESTRIAN POLE	AT APPROXIMATE POLE M - STA 5+24.4, 70.4'RT NB KENSWICK DR CONST CL	02893-02 02893-03 02893-06 02893-07
	CABINET	TYPE	CONTR	TRAFFIC OLLER	SIGNAL (	CONTROLLER	REMARKS	LOCATION	STANDARDS
A	•	METERED PEDESTAL SERVICE UL TYPE 3R	METERED PEDES	STAL SERVICE IMP AND ONE REAKERS	-	PROVIDE METER S (CONTRACTOR SHALL	SOCKET WINDOW 4" H X 6" W	PENDING	02893-14
В		TYPE 340	2070LX CONTROLLER Module With GPS SER Module & UPS BATTI	RIAL COMMUNICATIONS	-	UNITERRUPTIBLE STANDARD SPECI	FICATION 16730 & 16731 POWER SUPPLY FICATION 16732 & 16785 FICATION 16733 & 16738	AT APPROXIMATE STA 6+28.2, 34.5'LT KENSWICK DR CONST CL	02893-10C



LOCAL OFFICE:
920 MEMORIAL CITY WAY,
STE. 400
HOUSTON, TX 77024
TEL: (713) 576-8500
ATKINS NORTH
AMERICA PE FIRM REG.
#F-000474

REVISIONS

NO. DESCRIPTION DATE BY

CITY OF HOUSTON
HOUSTON AIRPORTS SYSTEM
Recommended
AARPAN 05/09/2024
Houston Airports System DATE
Director or besignated Representative

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The disease, a Support document southfield for
point review need from long intent, and to the barriers
14/48 approved standards. If the intent of the control of the contr

TRAFFIC SIGNAL PROPOSED POLE SCHEDULE

PROJECT MGR: MES


DESIGNER: KJV

DRAWN BY: KJV

CHECK BY: MES

SCALE:

DATE: 05/08/2024

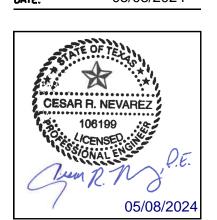

APPROVED BY:

PROJECT NO.

100072032


A.I.P. NO.

C.I.P. NO.

H.A.S. NO.

935

SHEET NO. 124 OF 125

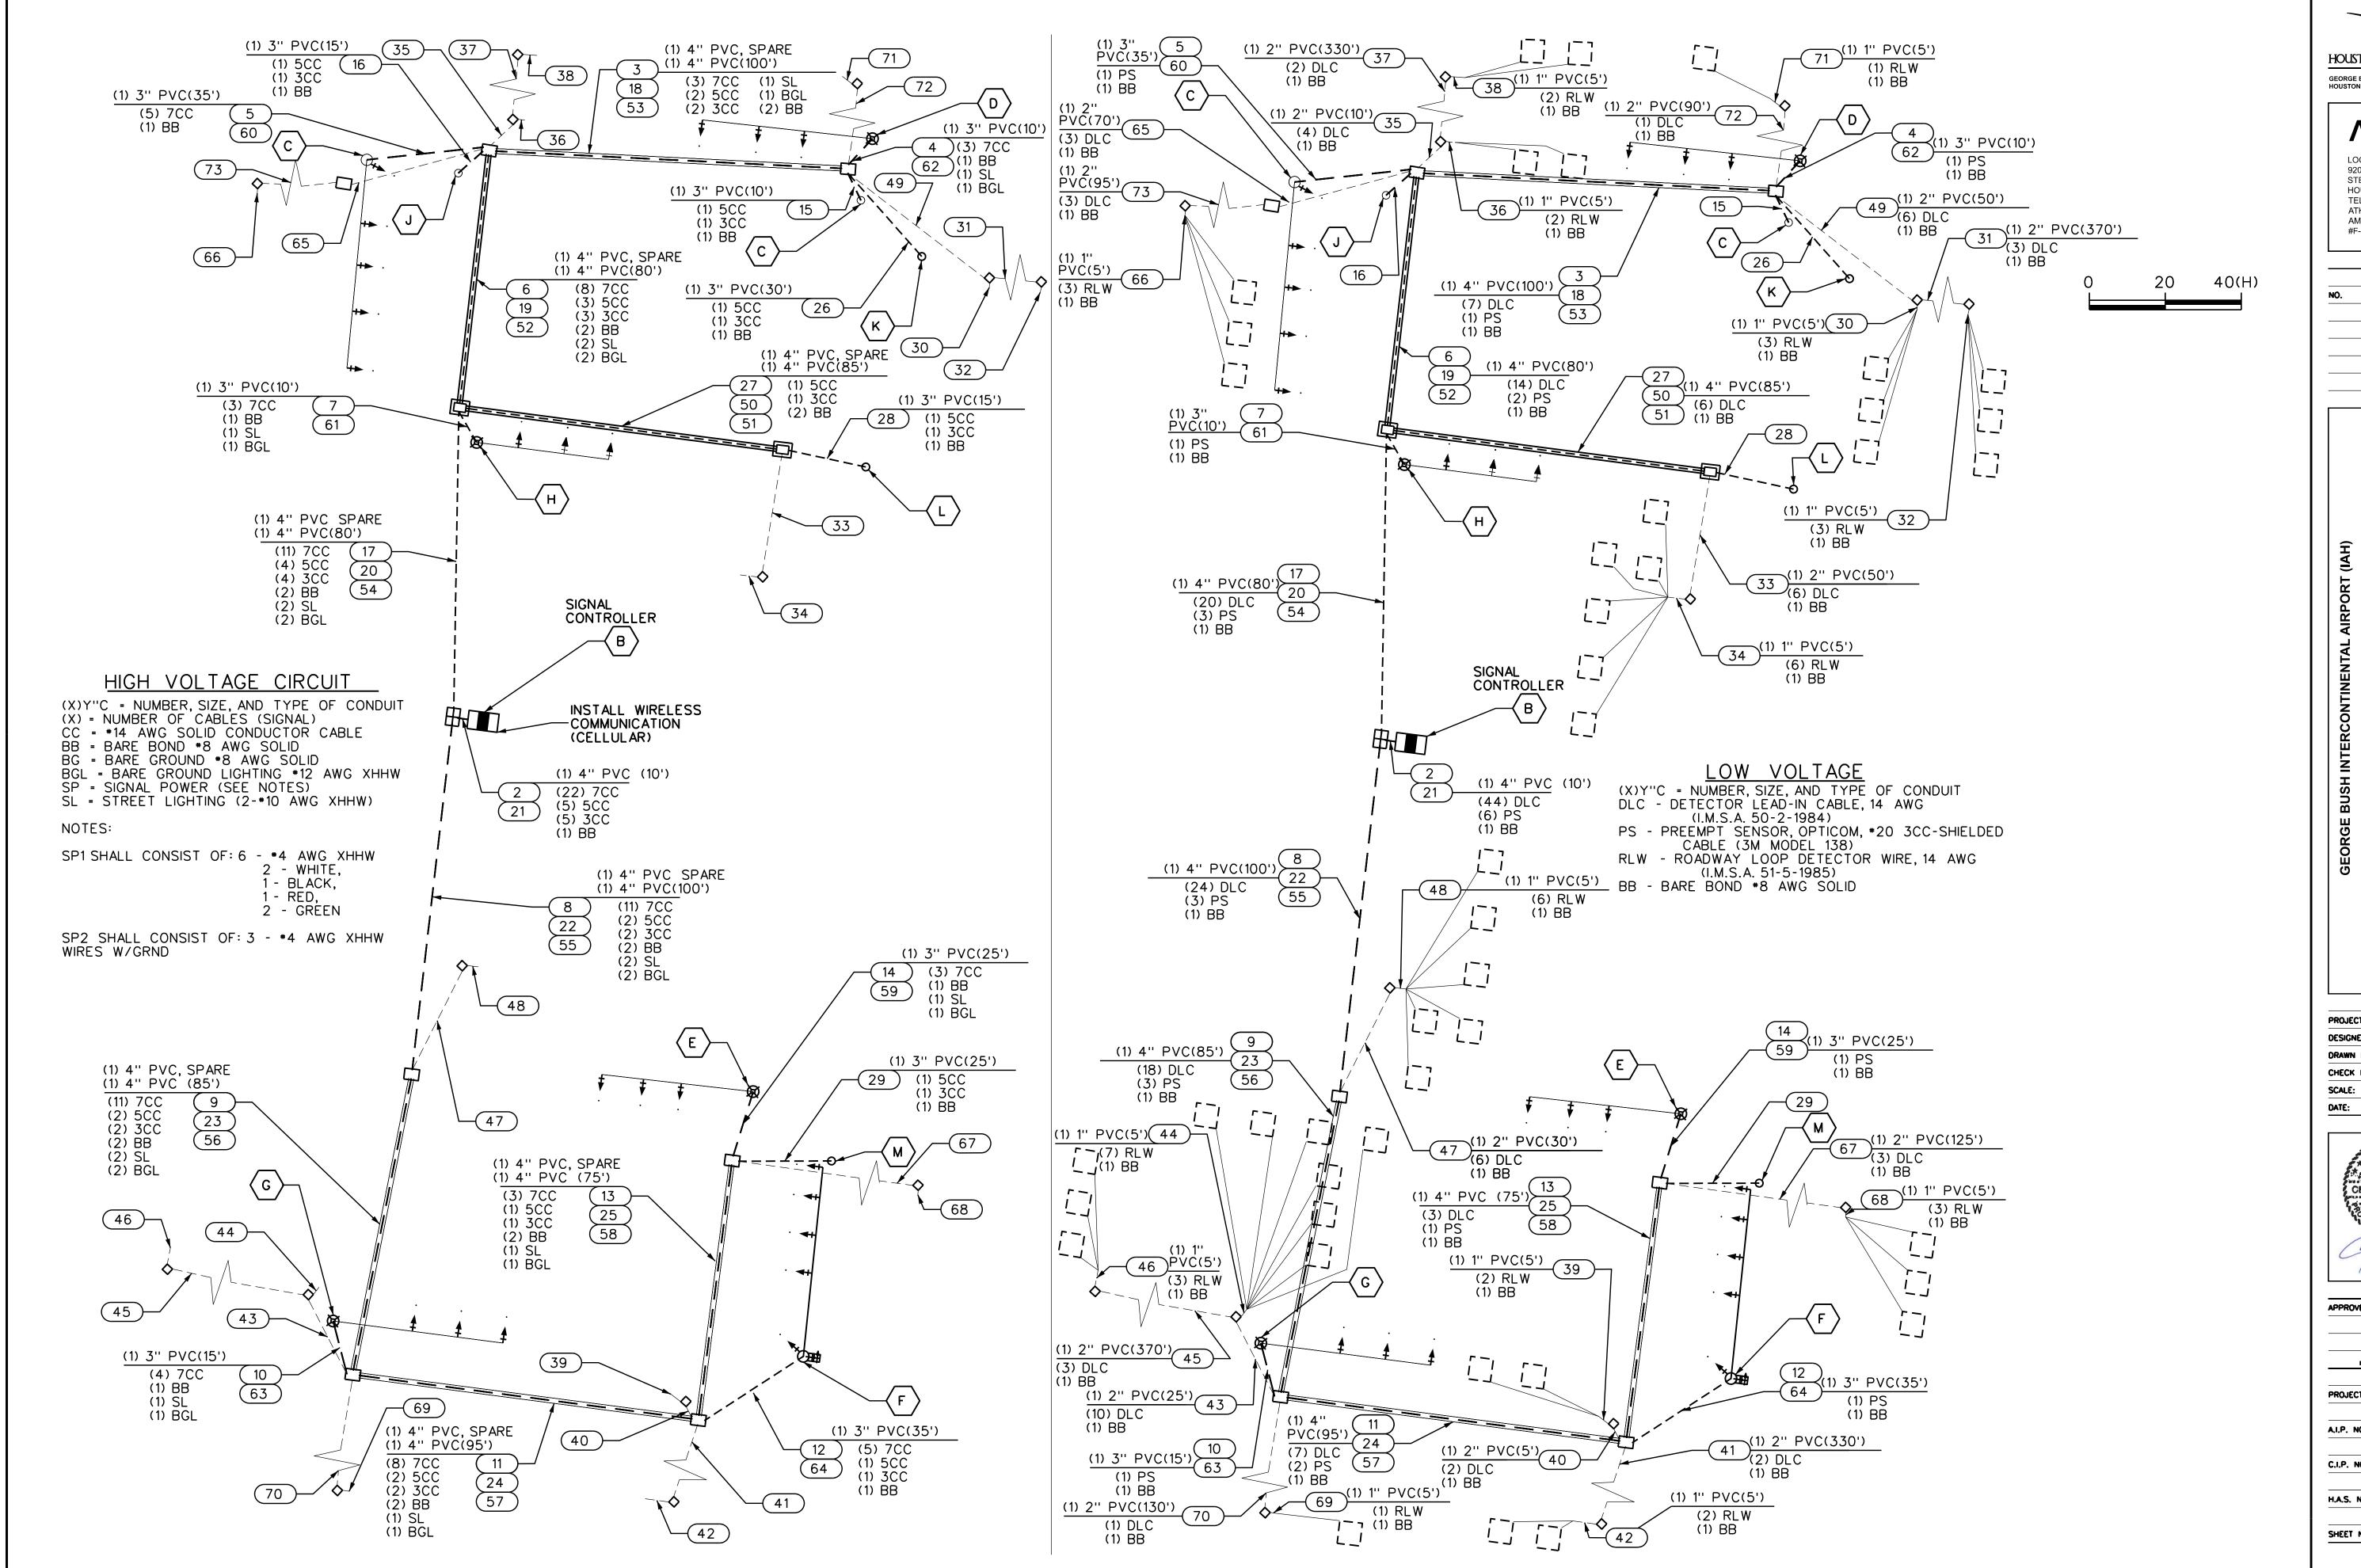



920 MEMORIAL CITY WAY, STE. 400 HOUSTON, TX 77024 TEL: (713) 576-8500 ATKINS NORTH AMERICA PE FIRM REG. #F-000474

REVISIONS NO. DESCRIPTION DATE BY

TRAFFIC SIGNAL WIRING DIAGRAM

PROJECT MGR: MES DESIGNER: ΚJV ΚJV DRAWN BY: MES CHECK BY:

05/08/2024



APPROVED BY:

PROJECT NO. 100072032

A.I.P. NO. C.I.P. NO.

H.A.S. NO. 935 SHEET NO. 125 OF 125