
WESTLINK - KEMPS CREEK

CIVIL WORKS PACKAGE -

INFRASTRUCTURE WORKS - STAGE 1 STATE SIGNIFICANT DEVELOPMENT APPLICATION RTS-SSD-9138102

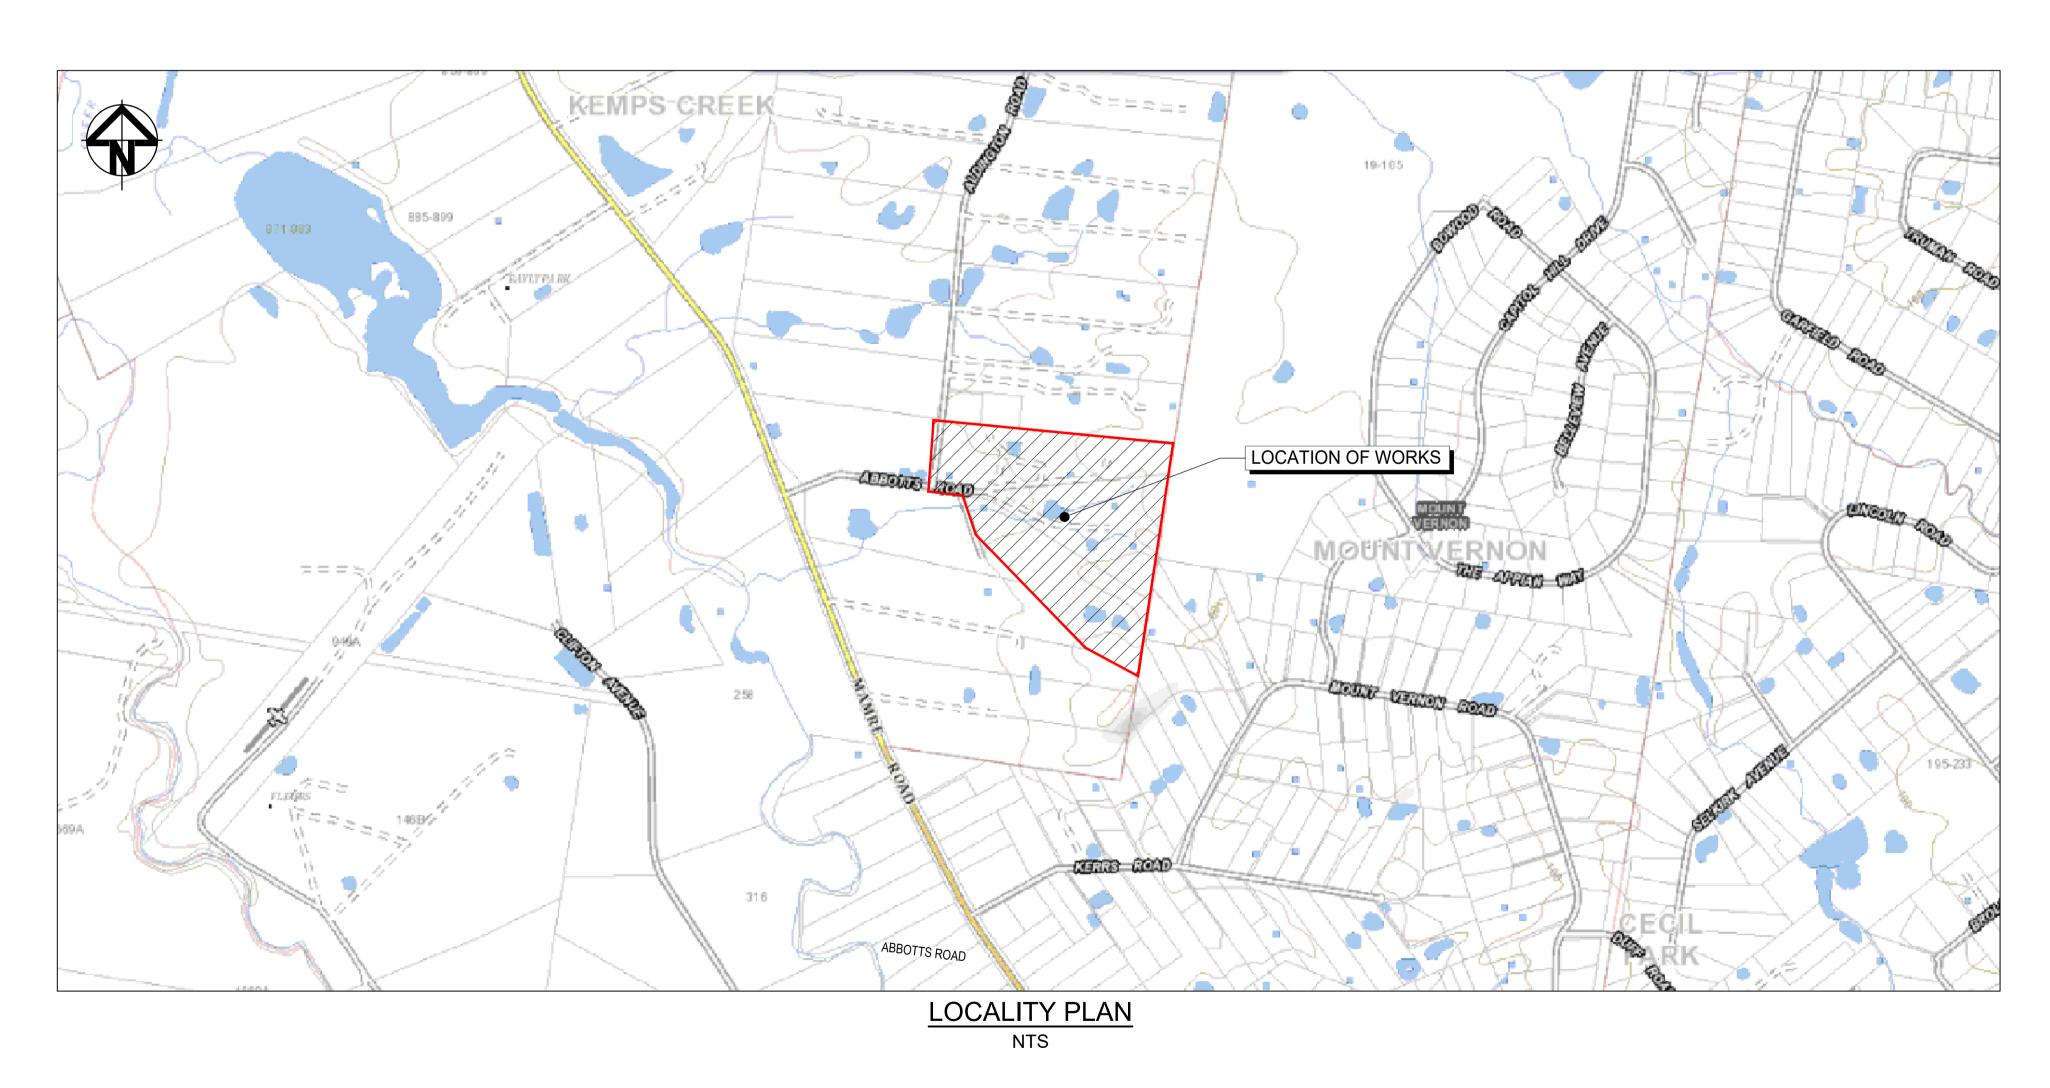

Client

Bar Scales RE-ISSUED FOR MOD 1 APPROVAL 14-03-24 RE-ISSUED FOR MOD 1 APPROVAL **ISSUED FOR MOD 1 APPROVAL** 01-11-23 24-07-23 ISSUED FOR AGENCY APPROVAL ISSUED FOR CLIENT REVIEW 23-06-23 Date Description



Scales	N.T.S.	Drawn	LM	Projec
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Grid	MGA2020	Checked	AT	
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PROPOSED INDUSTRIAL DEVELOPMENT WESTLINK KEMPS CREEK

COVER SHEET AND

Civil Engineers and Project Managers North Sydney NSW 2060 Tel: 02 9439 1777 Fax: 02 9923 1055 www.atl.net.au

FOR APPROVAL NOT TO BE USED FOR CONSTRUCTION Project - Drawing No.

20-748-C11000

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Description

5 RE-ISSUED FOR MOD 1 APPROVAL

RE-ISSUED FOR MOD 1 APPROVAL

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ISSUED FOR CLIENT REVIEW

ISSUED FOR AGENCY APPROVAL

Bar Scales

14-03-24

01-11-23

24-07-23

23-06-23

Date

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Designed

N.T.S.

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DRAWING LIST

WESTLINK

KEMPS CREEK

Project PROPOSED INDUSTRIAL DEVELOPMENT

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NOTE:

1. THESE DRAWINGS ARE TO BE READ IN CONJUNCTION WITH

STAGE 1 BULK EARTHWORKS PACKAGE DRAWINGS AND STAGE 1 EROSION AND SEDIMENTATION PACKAGE DRAWINGS.

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TRUCTION

20-748-C11001

Civil Engineers and Project Managers

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FOR APPROVAL NOT TO BE USED FOR CONSTR
Project - Drawing No.

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DRAWING TITLE

STORMWATER DRAINAGE DETAILS SHEET 1

STORMWATER DRAINAGE DETAILS SHEET 2

STORMWATER DRAINAGE DETAILS SHEET 3

STORMWATER DRAINAGE OVERALL CATCHMENT PLAN (POST-DEVELOPED)

DRAWING LIST

Client

DRAWING No.

20-748-C11081

20-748-C11091

20-748-C11092

20-748-C11093

STORMWATER DRAINAGE DETAILS

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STORMWATER DRAINAGE MANAGEMENT PLAN	<u> </u>
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20-748-C11080	STORMWATER DRAINAGE OVERALL CATCHMENT PLAN (PRE-DEVELOPED)
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SITEWORKS NOTES

- 1. ORIGIN OF LEVELS:- REFER SURVEY NOTES
- 2. CONTRACTOR MUST VERIFY ALL DIMENSIONS AND EXISTING LEVELS ON SITE PRIOR TO COMMENCEMENT OF WORK. ANY DISCREPANCIES TO BE REPORTED TO AT & L.
- 3. MAKE SMOOTH CONNECTION WITH EXISTING WORKS.
- 4. ALL TRENCH BACKFILL MATERIAL SHALL BE COMPACTED TO THE SAME DENSITY AS THE ADJACENT MATERIAL.
- 5. ALL SERVICE TRENCHES UNDER VEHICULAR PAVEMENTS SHALL BE BACKFILLED WITH SAND TO 300mm ABOVE PIPE, WHERE PIPE IS UNDER PAVEMENTS BACKFILL REMAINDER OF TRENCH TO UNDERSIDE OF PAVEMENT WITH SAND OR APPROVED GRANULAR MATERIAL COMAPACTED IN 150mm LAYERS TO MINIMUM 98% MODIFIED MAXIMUM DRY DENSITY IN ACCORDANCE WITH AS 1289 5.2.1. (OR A DENSITY INDEX OF NOT LESS THAN 75)
- 6. PROVIDE 10mm WIDE EXPANSION JOINTS BETWEEN BUILDINGS AND ALL CONCRETE OR UNIT PAVEMENTS.
- 7. ASPHALTIC CONCRETE SHALL CONFORM TO R.M.S SPECIFICATION R116.
- 8. ALL BASECOURSE MATERIAL SHALL BE IGNEOUS ROCK QUARRIED MATERIAL TO COMPLY WITH R.M.S FORM 3051 (UNBOUND), R.M.S FORM 3052 (BOUND) COMPACTED TO MINIMUM 98% MODIFIED DENSITY IN ACCORDANCE WITH AS 1289 5.2.1 FREQUENCY OF COMPACTION TESTING SHALL NOT BE LESS THAN 1
- TEST PER 50m OF BASECOURSE MATERIAL PLACED.
- 9. ALL SUB-BASE COURSE MATERIAL SHALL BE IGNEOUS ROCK QUARRIED MATERIAL TO COMPLY WITH R.M.S FORM 3051, 3051.1 AND COMPACTED TO MINIMUM 95% MODIFIED DENSITY IN ACCORDANCE WITH A.S 1289 5.2. FREQUENCY OF COMPACTION TESTING SHALL NOT BE LESS THAN 1 TEST PER 50m OF SUB-BASE COURSE MATERIAL PLACED.
- 10. AS AN ALTERNATIVE TO THE USE OF IGNEOUS ROCK AS A SUB-BASE MATERIAL IN (9) A CERTIFIED RECYCLED CONCRETE MATERIAL COMPLYING WITH R.M.S FORM 3051 AND 3051.1 WILL BE CONSIDERED SUBJECT TO MATERIAL SAMPLES AND APPROPRIATE CERTIFICATIONS BEING PROVIDED TO THE SATISFACTION OF AT & L.
- 11. SHOULD THE CONTRACTOR WISH TO USE A RECYCLED PRODUCT THE CONTRACTOR IS TO SEEK ACCEPTANCE OF THE PRODUCT FROM AT&L. THE PRICE DIFFERENCE BETWEEN AN IGNEOUS PRODUCT AND A RECYCLED PRODUCT SHALL BE CLEARLY INDICATED.
- 12. WHERE NOTED ON THE DRAWINGS THAT WORKS ARE TO BE CARRIED BY OTHERS, (eg. ADJUSTMENT OF SERVICES), THE CONTRACTOR SHALL BE RESPONSIBLE FOR THE CO-ORDINATION OF THESE WORKS.
- 13. ALL WORKS TO BE CONSTRUCTED IN ACCORDANCE WITH PENRITH CITY COUNCIL'S ENGINEERING CONSTRUCTION SPECIFICATION FOR CIVIL WORKS.

SURVEY NOTES

THE EXISTING SITE CONDITIONS SHOWN ON THE FOLLOWING DRAWINGS HAVE BEEN INVESTIGATED BY LANDPARTNERS, BEING REGISTERED SURVEYORS. THE INFORMATION IS SHOWN TO PROVIDE A BASIS FOR DESIGN. AT & L DOES NOT GUARANTEE THE ACCURACY OR COMPLETENESS OF THE SURVEY BASE OR ITS SUITABILITY AS A BASIS FOR CONSTRUCTION DRAWINGS.

SHOULD DISCREPANCIES BE ENCOUNTERED DURING CONSTRUCTION BETWEEN THE SURVEY DATA AND ACTUAL FIELD DATA, CONTACT AT & L.

THE FOLLOWING NOTES HAVE BEEN TAKEN DIRECTLY FROM THE ORIGINAL SURVEY DOCUMENTS.

- 1. THE BOUNDARIES HAVE APPOROXIMATELY BEEN SURVEYED IN ACCORDANCE WITH CLAUSE 9 OF THE SURVEYING & SPATIAL INFORMATION
- 2. ALL AREAS AND DIMENSIONS HAVE BEEN COMPILED FROM PLANS MADE AVAILABLE BY NSW LAND REGISTRY SERVICES AND ARE SUBJECT TO FINAL
- B. ORIGIN OF COORDINATES HAS BEEN DERIVED USING GPS (GNSS) SURVEY FROM SSM33562
- 4. ORIGIN OF LEVELS ON A.H.D. IS TAKEN FROM PM178274 USING GPS (GNSS) SURVEY METHODS.
- CONTOUR INTERVAL 0.5 m
- 6. CONTOURS ARE INDICATIVE ONLY. ONLY SPOT LEVELS SHOULD BE USED FOR CALCULATIONS OF QUANTITIES WITH CAUTION
- NO INVESTIGATION OF UNDERGROUND SERVICES HAS BEEN MADE. SERVICES HAVE BEEN PLOTTED FROM RELEVANT AUTHORITIES INFORMATION AND HAVE NOT BEEN SURVEYED. ALL RELEVANT AUTHORITIES SHOULD BE NOTIFIED PRIOR TO ANY EXCAVATION ON OR
- NEAR THE SITE 8. 8/.4/7 DENOTES TREE SPREAD OF 8m, TRUNK DIAMETER OF 0.4m & APPROX
- HEIGHT OF 7m 9. SHOWS APPROXIMATE POSITION OF ROAD LINEMARKING AND IS
- INDICATIVE ONLY 10. BEARINGS SHOWN ARE MGA (MAP GRID OF AUSTRALIA) ADD APPROX. 1°00' FOR TRUE NORTH

CONSTRUCTION SPECIFICATION

- THESE DRAWINGS SHOULD BE READ IN CONJUCTION WITH PENRITH CITY COUNCIL'S LATEST REVISION OF THE 'ENGINEERING CONSTRUCTION SPECIFICATION FOR CIVIL WORKS'
- WHERE THERE IS A CONFLICT THE FOLLOWING IS TO OCCUR 2.1. NOTIFY THE DESIGN ENGINGEER AND/OR SUPERINTENDENT 2.2. THE PENRITH CITY COUNCIL'S SPECIFICATION TAKES PRECEDENCE

CONCRETE NOTES

- 1. ALL WORKMANSHIP AND MATERIALS SHALL BE IN ACCORDANCE WITH AS 3600 CURRENT EDITION WITH AMENDMENTS, EXCEPT WHERE VARIED BY THE CONTRACT DOCUMENTS.
- 2. CONCRETE QUALITY ALL REQUIREMENTS OF THE CURRENT ACSE CONCRETE SPECIFICATION DOCUMENT 1 SHALL APPLY TO THE FORMWORK, REINFORCEMENT AND CONCRETE UNLESS NOTED OTHERWISE

ELEMENT	AS 3600 F'c MPa	SPECIFIED	NOMINAL
	AT 28 DAYS	SLUMP	AGG. SIZE
VEHICULAR BASE KERBS, PATHS, AND PITS	32 25	60 80	20 20

- CEMENT TYPE SHALL BE (ACSE SPECIFICATION) TYPE SL PROJECT CONTROL TESTING SHALL BE CARRIED OUT IN ACCORDANCE WITH AS 1379
- 3. NO ADMIXTURES SHALL BE USED IN CONCRETE UNLESS APPROVED IN WRITING BY AT & L.
- 4. CLEAR CONCRETE COVER TO ALL REINFORCEMENT FOR DURABILITY SHALL BE 40mm TOP AND 70mm FOR EXTERNAL EDGES UNLESS NOTED OTHERWISE.
- 5. ALL REINFORCEMENT SHALL BE FIRMLY SUPPORTED ON MILD STEEL PLASTIC TIPPED CHAIRS, PLASTIC CHAIRS OR CONCRETE CHAIRS AT NOT GREATER THAN 1m CENTRES BOTH WAYS, BARS SHALL BE TIED AT ALTERNATE INTERSECTIONS.
- 6. THE FINISHED CONCRETE SHALL BE A DENSE HOMOGENEOUS MASS. COMPLETELY FILLING THE FORMWORK, THOROUGHLY EMBEDDING THE REINFORCEMENT AND FREE OF STONE POCKETS. ALL CONCRETE INCLUDING SLABS ON GROUND AND FOOTINGS SHALL BE COMPACTED AND CURED IN ACCORDANCE WITH R.M.S SPECIFICATION R83.
- 7. REINFORCEMENT SYMBOLS:
- N DENOTES GRADE 450 N BARS TO AS 1302 GRADE N
- R DENOTES 230 R HOT ROLLED PLAIN BARS TO AS 1302 SL DENOTES HARD-DRAWN WIRE REINFORCING FABRIC TO AS 1304
- NUMBER OF BARS IN GROUP _ _ BAR GRADE AND TYPE

17 N 20 250

NOMINAL BAR SIZE IN mm — LSPACING IN mm

THE FIGURE FOLLOWING THE FABRIC SYMBOL SL IS THE REFERANCE NUMBER FOR FABRIC TO AS 1304.

8. FABRIC SHALL BE LAPPED IN ACCORDANCE WITH THE FOLLOWING

KERBING NOTES

Bar Scales

- 1. ALL CONCRETE TO HAVE A MINIMUM COMPRESSIVE STRENGTH OF 25MPa U.N.O IN REINFORCED CONCRETE NOTES.
- 2. ALL KERBS, GUTTERS, DISH DRAINS AND CROSSINGS TO BE CONSTRUCTED ON MIN. 100mm GRANULAR BASECOURSE COMPACTED TO MINIMUM 95% MODIFIED DRY DENSITY (AS 1289 5.2.1).
- 3. EXPANSION JOINTS (E.J) TO BE FORMED FROM 10mm COMPRESSIBLE CORK FILLER BOARD FOR THE FULL DEPTH OF THE SECTION AND CUT TO PROFILE. EXPANSION JOINTS TO BE LOCATED AT DRAINAGE PITS, ON TANGENT POINTS OF CURVES AND ELSEWHERE AT MAX 12m CENTRES EXCEPT FOR INTEGRAL KERBS WHERE THE EXPANSION JOINTS ARE TO MATCH THE JOINT LOCATIONS IN THE SLABS.
- 4. WEAKENED PLANE JOINTS TO BE MIN 3mm WIDE AND LOCATED AT 3m CENTRES EXCEPT FOR INTEGRAL KERBS WHERE THE WEAKENED PLANE JOINTS ARE TO MATCH THE JOINT LOCATIONS IN THE SLABS.
- 5. BROOMED FINISH TO ALL RAMPED AND VEHICULAR CROSSINGS. ALL OTHER KERBING OR DISH DRAINS TO BE STEEL FLOAT FINISHED.
- 6. IN THE REPLACEMENT OF KERB AND GUTTER:-EXISTING ROAD PAVEMENT IS TO BE SAWCUT 900mm U.N.O FROM THE LIP OF GUTTER. UPON COMPLETION OF THE NEW KERB AND GUTTER NEW BASECOURSE AND SURFACE TO BE LAID 900mm WIDE U.N.O.
- EXISTING ALLOTMENT DRAINAGE PIPES ARE TO BE BUILT INTO THE NEW KERB AND GUTTER WITH 100mm DIA HOLE.
- EXISTING KERB AND GUTTER IS TO BE COMPLETELY REMOVED WHERE NEW KERB AND GUTTER IS SHOWN.

STORMWATER DRAINAGE NOTES

- . STORMWATER DESIGN CRITERIA (A) AVERAGE RECURRENCE INTERVAL 1:100 YEARS MAJOR STORM (OVERLAND FLOW) 1:20 YEARS MINOR STORM (PIPED NETWORK)
 - (B) RAINFALL INTENSITIES: TIME OF CONCENTRATION:5 MINUTES 1:100 YEARS= 219 mm/hr 1:20 YEARS= 167 mm/hr
 - (C) RUNOFF COEFFICIENTS: **ROOF AREAS:** C 100 =1.0 EXTERNAL PAVEMENTS: C 100 =1.0
 - PIPES 300 DIA. AND LARGER TO BE REINFORCED CONCRETE CLASS '3' APPROVED SPIGOT AND SOCKET WITH RUBBER RING JOINTS. U.N.O. ALL ROAD CROSSINGS TO BE CLASS '4' U.N.O.
 - PIPES UP TO 300 DIA SHALL BE SEWER GRADE uPVC WITH SOLVENT WELDED JOINTS.
 - . EQUIVALENT STRENGTH VCP OR FRC PIPES MAY BE USED, SUBJECT TO THE APPROVAL OF PENRITH CITY COUNCIL.
 - . ALL STORMWATER DRAINAGE LINES UNDER PROPOSED BUILDING SLABS TO BE uPVC PRESSURE PIPE GRADE 6. ENSURE ALL VERTICALS AND DOWNPIPES ARE uPVC PRESSURE PIPE, GRADE 6 FOR A MIN OF 3.0m
- E. PIPES TO BE INSTALLED TO TYPE HS1 SUPPORT IN ACCORDANCE WITH AS 3725 (2007) IN ALL CASES BACKFILL TRENCH WITH SAND TO 300mm ABOVE PIPE. WHERE PIPE IS UNDER PAVEMENTS BACKFILL REMAINDER OF TRENCH TO UNDERSIDE OF PAVEMENT WITH SAND OR APPROVED GRANULAR MATERIAL COMPACTED IN 150mm LAYERS TO MINIMUM 98% STANDARD MAXIMUM DRY DENSITY IN ACCORDANCE WITH AS 1289 5.2.1. (OR A DENSITY INDEX OF NOT LESS THAN 75)
- . ALL INTERNAL WORKS WITHIN PROPERTY BOUNDARIES ARE TO COMPLY WITH THE REQUIREMENTS OF AS 3500 3.1 (1998) AND AS/NZS 3500 3.2
- PRECAST PITS MAY BE USED EXTERNAL TO THE BUILDING SUBJECT TO APPROVAL BY AT & L.
- ENLARGERS, CONNECTIONS AND JUNCTIONS TO BE PREFABRICATED FITTINGS WHERE PIPES ARE LESS THAN 300 DIA.
-). WHERE SUBSOIL DRAINS PASS UNDER FLOOR SLABS AND VEHICULAR PAVEMENTS, UNSLOTTED uPVC SEWER GRADE PIPE IS TO BE USED.
- 1. CARE IS TO BE TAKEN WITH LEVELS OF STORMWATER LINES. GRADES SHOWN ARE NOT TO BE REDUCED WITHOUT APPROVAL.
- 12. GRATES AND COVERS SHALL CONFORM TO AS 3996. 13. AT ALL TIMES DURING CONSTRUCTION OF STORMWATER PITS, ADEQUATE SAFETY PROCEDURES SHALL BE TAKEN TO ENSURE AGAINST THE POSSIBILITY OF PERSONNEL FALLING DOWN PITS.
- 4. ALL EXISTING STORMWATER DRAINAGE LINES AND PITS THAT ARE TO REMAIN ARE TO BE INSPECTED AND CLEANED. DURING THIS PROCESS ANY PART OF THE STORMWATER DRAINAGE SYSTEM THAT WARRANTS REPAIR SHALL BE REPORTED TO THE SUPERINTENDENT/ENGINEER FOR FURTHER DIRECTIONS.

EMBANKMENT CONSTRUCTION SEQUENCE

- 1. STRIP VEGETATION AND TOPSOIL FROM EMBANKMENT AREA AND STOCKPILE TOPSOIL FOR LATER USE, CUT BACK AREA TO FIRM GROUND.
- 2. CONSTRUCT EMBANKMENT IN PRESENCE OF QUALIFIED AND EXPERIENCED GEOTECHNICAL ENGINEER IF NOT ROCK. 3. IN THE CASE WHERE THE EMBANKMENT AREAS SLUSH, GROUTING AND

DENTAL CONCRETE MAY BE REQUIRED, AS DIRECTED BY A QUALIFIED AND

EXPERIENCED GEOTECHNICAL ENGINEER 4. COMPACT CLAY STABILIZED WITH GYPSUM (3% BY DRY MASS, MINIMUM) AS APPROVED BY A QUALIFIED AND EXPERIENCED GEOTECHNICAL ENGINEER INTO THE CUT-OFF TRENCH OF LAYERS NOT EXCEEDING 150mm LOOSE THICKNESS TO A DRY DENSITY EQUIVALENT TO 98% OF THAT

DETERMINED BY STANDARD COMPACTION (AS 1289.5.1.1) AND AT A

MOISTURE CONTENT OF -2% TO +2% OF OPTIMUM MOISTURE CONTENT.

. GYPSUM STABILIZED NATURAL SOILS EXPOSED IN EMBANKMENT AREA WITH MINIMUM 3% GYPSUM BY DRY MASS AND COMPACT AS FOR #4. ALL TO THE APPROVAL OF A QUALIFIED AND

EXPERIENCED GEOTECHNICAL ENGINEER.

- 6. CONSTRUCT BODY OF EMBANKMENT WITH CLAYEY MATERIAL WON FROM SITE. COMPACT THE CLAYEY MATERIAL APPROVED BY A QUALIFIED AND EXPERIENCED GEOTECHNICAL ENGINEER IN LAYERS NOT EXCEEDING 150mm THICKNESS TO A DRY DENSITY EQUIVALENT TO 98% OF THAT DETERMINED BY STANDARD COMPACTION (AS 1289.5.1.1) AND AT A MOISTURE CONTENT OF -2% TO +2% OF OPTIMUM MOISTURE CONTENT. MOST IMPORTANTLY, IF SHRINKAGE CRACKS OCCUR, AS DIRECTED BY A QUALIFIED AND EXPERIENCED GEOTECHNICAL ENGINEER.
- 7. OVERFILL THE EMBANKMENT AND TRIM OFF, SO THAT THE ENTIRE BODY OF THE EMBANKMENT IS COMPACTED.
- 8. TRIM THE EMBANKMENTS BATTERS TO THE OVERFILLED MATERIAL, STABILIZE THE UPSTREAM CLAY BATTERS WITH WELL MIXED GYPSUM (3% BY DRY MASS, MIN.) AND COMPACT TO MIN. 98% STD -2% TO +2% OMC.
- 9. PLACE ROCK RIP-RAP AS SHOWN.
- 10. RECOVER TOPSOIL FROM STOCKPILE AND SPREAD OVER EMBANKMENT AND CUT BATTERS (A THIN COVER OF TOPSOIL ONLY HAS BEEN NOMINATED). ONLY LIGHTLY TRACK-ROLL THE TOPSOIL AND THEN LANDSCAPE IN ACCORDANCE WITH THE LANDSCAPE AREA DRAWINGS.
- 1. WATER AND FERTILIZE LANDSCAPE AS REQUIRED BY CLIMACTIC CONDITIONS TO ENSURE THE LANDSCAPE IS SUCCESSFUL.
- 12. AT THE COMPLETION OF WORK WRITTEN CONFIRMATION & CERTIFICATION IS TO BE PROVIDED FROM A QUALIFIED & EXPERIENCED GEOTECHNICAL ENGINEER THAT THE EMBANKMENTS HAVE BEEN CONSTRUCTED IN ACCORDANCE WITH THESE DRAWINGS.

EROSION AND SEDIMENT CONTROL NOTES

GENERAL INSTRUCTIONS

- 1. THE SITE SUPERINTENDENT/ENGINEER WILL ENSURE THAT ALL SOIL AND WATER MANAGEMENT WORKS ARE LOCATED AS DOCUMENTED.
- 2. ALL WORK SHALL BE GENERALLY CARRIED OUT IN ACCORDANCE WITH a. LOCAL AUTHORITY REQUIREMENTS b FPA REQUIREMENTS
- c. NSW DEPARTMENT OF HOUSING MANUAL "MANAGING URBAN STORMWATER, SOILS AND CONSTRUCTION", 4th EDITION, MARCH
- 3. MAINTAIN THE EROSION CONTROL DEVICES TO THE SATISFACTION OF THE SUPERINTENDENT AND THE LOCAL AUTHORITY.
- 4. WHEN STORMWATER PITS ARE CONSTRUCTED. PREVENT SITE RUNOFF ENTERING UNLESS SEDIMENT FENCES ARE ERECTED AROUND PITS.
- 5. CONTRACTOR IS TO ENSURE ALL EROSION & SEDIMENT CONTROL DEVICES ARE MAINTAINED IN GOOD WORKING ORDER AND OPERATE EFFECTIVELY, REPAIRS AND OR MAINTENANCE SHALL BE UNDERTAKEN AS REQUIRED, PARTICULARLY FOLLOWING STORM EVENTS.

LAND DISTURBANCE

- 6. WHERE PRACTICAL, THE SOIL EROSION HAZARD ON THE SITE WILL BE KEPT AS LOW AS POSSIBLE. TO THIS END, WORKS SHOULD BE UNDERTAKEN IN THE FOLLOWING SEQUENCE:
- (A) INSTALL A WIND FENCE ALONG THE BOUNDARIES AS SHOWN ON PLAN. REFER DETAIL.
- (B) INSTALL A SEDIMENT FENCE ALONG THE BOUNDARIES AS SHOWN ON PLAN. REFER DETAIL.
- (C) CONSTRUCT STABILISED CONSTRUCTION ENTRANCE TO LOCATION AS DETERMINED BY SUPERINTENDENT/ENGINEER. REFER
- (D) INSTALL SEDIMENT BASIN AS SHOWN ON PLAN
- (E) INSTALL SEDIMENT TRAPS AS SHOWN ON PLAN.
- (F) UNDERTAKE SITE DEVELOPMENT WORKS IN ACCORDANCE WITH THE ENGINEERING PLANS. WHERE POSSIBLE, PHASE DEVELOPMENT SO THAT LAND DISTURBANCE IS CONFINED TO AREAS OF WORKABLE SIZE.

EROSION CONTROL

- 7. DURING WINDY WEATHER, LARGE, UNPROTECTED AREAS WILL BE KEPT MOIST (NOT WET) BY SPRINKLING WITH WATER TO KEEP DUST UNDER CONTROL.
- 8. FINAL SITE LANDSCAPING WILL BE UNDERTAKEN AS SOON AS POSSIBLE AND WITHIN 20 WORKING DAYS FROM COMPLETION OF CONSTRUCTION ACTIVITIES.

SEDIMENT CONTROL

- 9. STOCKPILES WILL NOT BE LOCATED WITHIN 2 METRES OF HAZARD AREAS, INCLUDING LIKELY AREAS OF CONCENTRATED OR HIGH VELOCITY FLOWS SUCH AS WATERWAYS. WHERE THEY ARE BETWEEN 2 AND 5 METRES FROM SUCH AREAS. SPECIAL SEDIMENT CONTROL MEASURES SHOULD BE TAKEN TO MINIMISE POSSIBLE POLLUTION TO DOWNSLOPE WATERS, E.G. THROUGH INSTALLATION OF SEDIMENT
- 10. ANY SAND USED IN THE CONCRETE CURING PROCESS (SPREAD OVER THE SURFACE) WILL BE REMOVED AS SOON AS POSSIBLE AND WITHIN
- 10 WORKING DAYS FROM PLACEMENT. 11. WATER WILL BE PREVENTED FROM ENTERING THE PERMANENT DRAINAGE SYSTEM UNLESS IT IS RELATIVELY SEDIMENT FREE. I.E. THE CATCHMENT AREA HAS BEEN PERMANENTLY LANDSCAPED AND/OR ANY LIKELY SEDIMENT HAS BEEN FILTERED THROUGH AN APPROVED STRUCTURE.
- 12. TEMPORARY SOIL AND WATER MANAGEMENT STRUCTURES WILL BE REMOVED ONLY AFTER THE LANDS THEY ARE PROTECTING ARE REHABILITATED.

OTHER MATTERS

Client

- 13. ACCEPTABLE RECEPTORS WILL BE PROVIDED FOR CONCRETE AND MORTAR SLURRIES, PAINTS, ACID WASHINGS, LIGHT-WEIGHT WASTE MATERIALS AND LITTER.
- 14. ANY EXISTING TREES WHICH FORM PART OF THE FINAL LANDSCAPING PLAN WILL BE PROTECTED FROM CONSTRUCTION ACTIVITIES BY:
- (A) PROTECTING THEM WITH BARRIER FENCING OR SIMILAR MATERIALS INSTALLED OUTSIDE THE DRIP LINE
- (B) ENSURING THAT NOTHING IS NAILED TO THEM
- (C) PROHIBITING PAVING, GRADING, SEDIMENT WASH OR PLACING OF STOCKPILES WITHIN THE DRIP LINE EXCEPT UNDER THE FOLLOWING CONDITIONS.
- (I) ENCROACHMENT ONLY OCCURS ON ONE SIDE AND NO CLOSER TO THE TRUNK THAN EITHER 1.5 METRES OR HALF THE DISTANCE BETWEEN THE OUTER EDGE OF THE DRIP LINE AND THE TRUNK, WHICH EVER IS THE GREATER
- (II) A DRAINAGE SYSTEM THAT ALLOWS AIR AND WATER TO CIRCULATE THROUGH THE ROOT ZONE (E.G. A GRAVEL BED) IS PLACED UNDER ALL FILL LAYERS OF MORE THAN 300 MILLIMETRES DEPTH
- (III) CARE IS TAKEN NOT TO CUT ROOTS UNNECESSARILY NOR TO COMPACT THE SOIL AROUND THEM.

EROSION AND SEDIMENT CONTROL NOTES CONTINUED

STAGING

SUITABLE EROSION AND SEDIMENT CONTROLS SHALL BE DESIGNED. PROVIDED AND MAINTAINED BY THE CONTRACTOR THROUGHOUT ALL STAGES OF WORKS, INCLUDING AT COMPLETION OF THE BULK EARTHWORKS WHERE SHOWN ON AT&L DRAWINGS OR WHERE DIRECTED BY THE SUPERINTENDENT OR PENRITH CITY COUNCIL'S

ENGINEERS. SEDIMENT AND EROSION CONTROLS ARE TO BE DESIGNED AND DOCUMENTED BY A SUITABLY QUALIFIED EXPERT ENGAGED BY THE CONTRACTOR AND APPROVED AS PART OF THE CONSTRUCTION ENVIRONMENTAL MANAGEMENT PLAN PRIOR TO THE COMMENCEMENT OF CONSTRUCTION. SUCH CONTROLS SHALL BE IN ACCORDANCE WITH THE RELEVANT REQUIREMENTS IN THE LATEST VERSION OF THE MANAGING URBAN STORMWATER: SOILS AND CONSTRUCTION GUIDELINE (LANDCOM).

DEWATERING

ANY DEWATERING WORKS TO BE AS PER THE DEWATERING PROCEDURE AS CONTAINED WITHIN THE CONSTRUCTION ENVIRONMENTAL MANAGEMENT PLAN (CEMP).

DECOMMISSIONING / DEMOLITION

DEMOLITION OF EXISTING DWELLING TO BE CONDUCTED IN ACCORDANCE WITH THE PROVISIONS OF AS2601-2001 - DEMOLITION OF STRUCTURES BY CONTRACTORS EXPERIENCED IN THIS CLASS OF WORK AND HOLDING REQUIRED CURRENT PERMITS AND LICENSES AS REQUIRED.

EXISTING INTERNALS FENCING, CATTLE YARDS, UTILITIES AND OTHER REDUNDANT STRUCTURES TO BE DEMOLISHED AND REMOVED TO AN APPROVED WASTE MANAGEMENT FACILITY.

DAM DECOMMISSIONING TO BE COMPLETED AS PER THE DAM DECOMMISSIONING PROCEDURE AS CONTAINED WITHIN THE CONSTRUCTION ENVIRONMENTAL MANAGEMENT PLAN (CEMP).

EXISTING UNDERGROUND SERVICES

THE LOCATIONS OF UNDERGROUND SERVICES SHOWN IN THIS SET OF DRAWINGS HAVE BEEN PLOTTED FROM SURVEY INFORMATION AND SERVICE AUTHORITY INFORMATION. THE SERVICE INFORMATION HAS BEEN PREPARED ONLY TO SHOW THE APPROXIMATE POSITIONS OF ANY KNOWN SERVICES AND MAY NOT BE AS CONSTRUCTED OR ACCURATE.

AT & L CAN NOT GUARANTEE THAT THE SERVICES INFORMATION SHOWN ON THESE DRAWINGS ACCURATELY INDICATES THE PRESENCE OR ABSENCE OF SERVICES OR THEIR LOCATION AND WILL ACCEPT NO LIABILITY FOR INACCURACIES IN THE SERVICES INFORMATION SHOWN FROM ANY CAUSE WHATSOEVER.

CONTRACTORS SHALL TAKE DUE CARE WHEN EXCAVATING ONSITE INCLUDING HAND EXCAVATION WHERE NECESSARY.

CONTRACTORS ARE TO CONTACT THE RELEVANT SERVICE AUTHORITY PRIOR

TO COMMENCEMENT OF EXCAVATION WORKS.

CONTRACTORS ARE TO UNDERTAKE A SERVICES SEARCH, PRIOR TO COMMENCEMENT OF WORKS ON SITE. SEARCH RESULTS ARE TO BE KEPT ON



CONTRACTOR SHALL CALL; DIAL BEFORE YOU DIG 1100 PRIOR TO COMMENCEMENT OF WORK

TO OBTAIN ALL CURRENT SERVICE

Level 7, 153 Walker Street

Issue

North Sydney NSW 2060 ABN 96 130 882 405

Tel: 02 9439 1777

Fax: 02 9923 1055 www.atl.net.au

AUTHORITY PLANS

Civil Engineers and Project Managers

5	RE-ISSUED FOR MOD 1 APPROVAL	13-05-24
4	RE-ISSUED FOR MOD 1 APPROVAL	14-03-24
3	ISSUED FOR MOD 1 APPROVAL	01-11-23
2	ISSUED FOR AGENCY APPROVAL	24-07-23
1	ISSUED FOR CLIENT REVIEW	23-06-23
Issue	Description	Date

100mm on Original

Scales LM N.T.S. Designed LM Checked MGA2020 AHD Datum

GDA2020

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WESTLINK **KEMPS CREEK**


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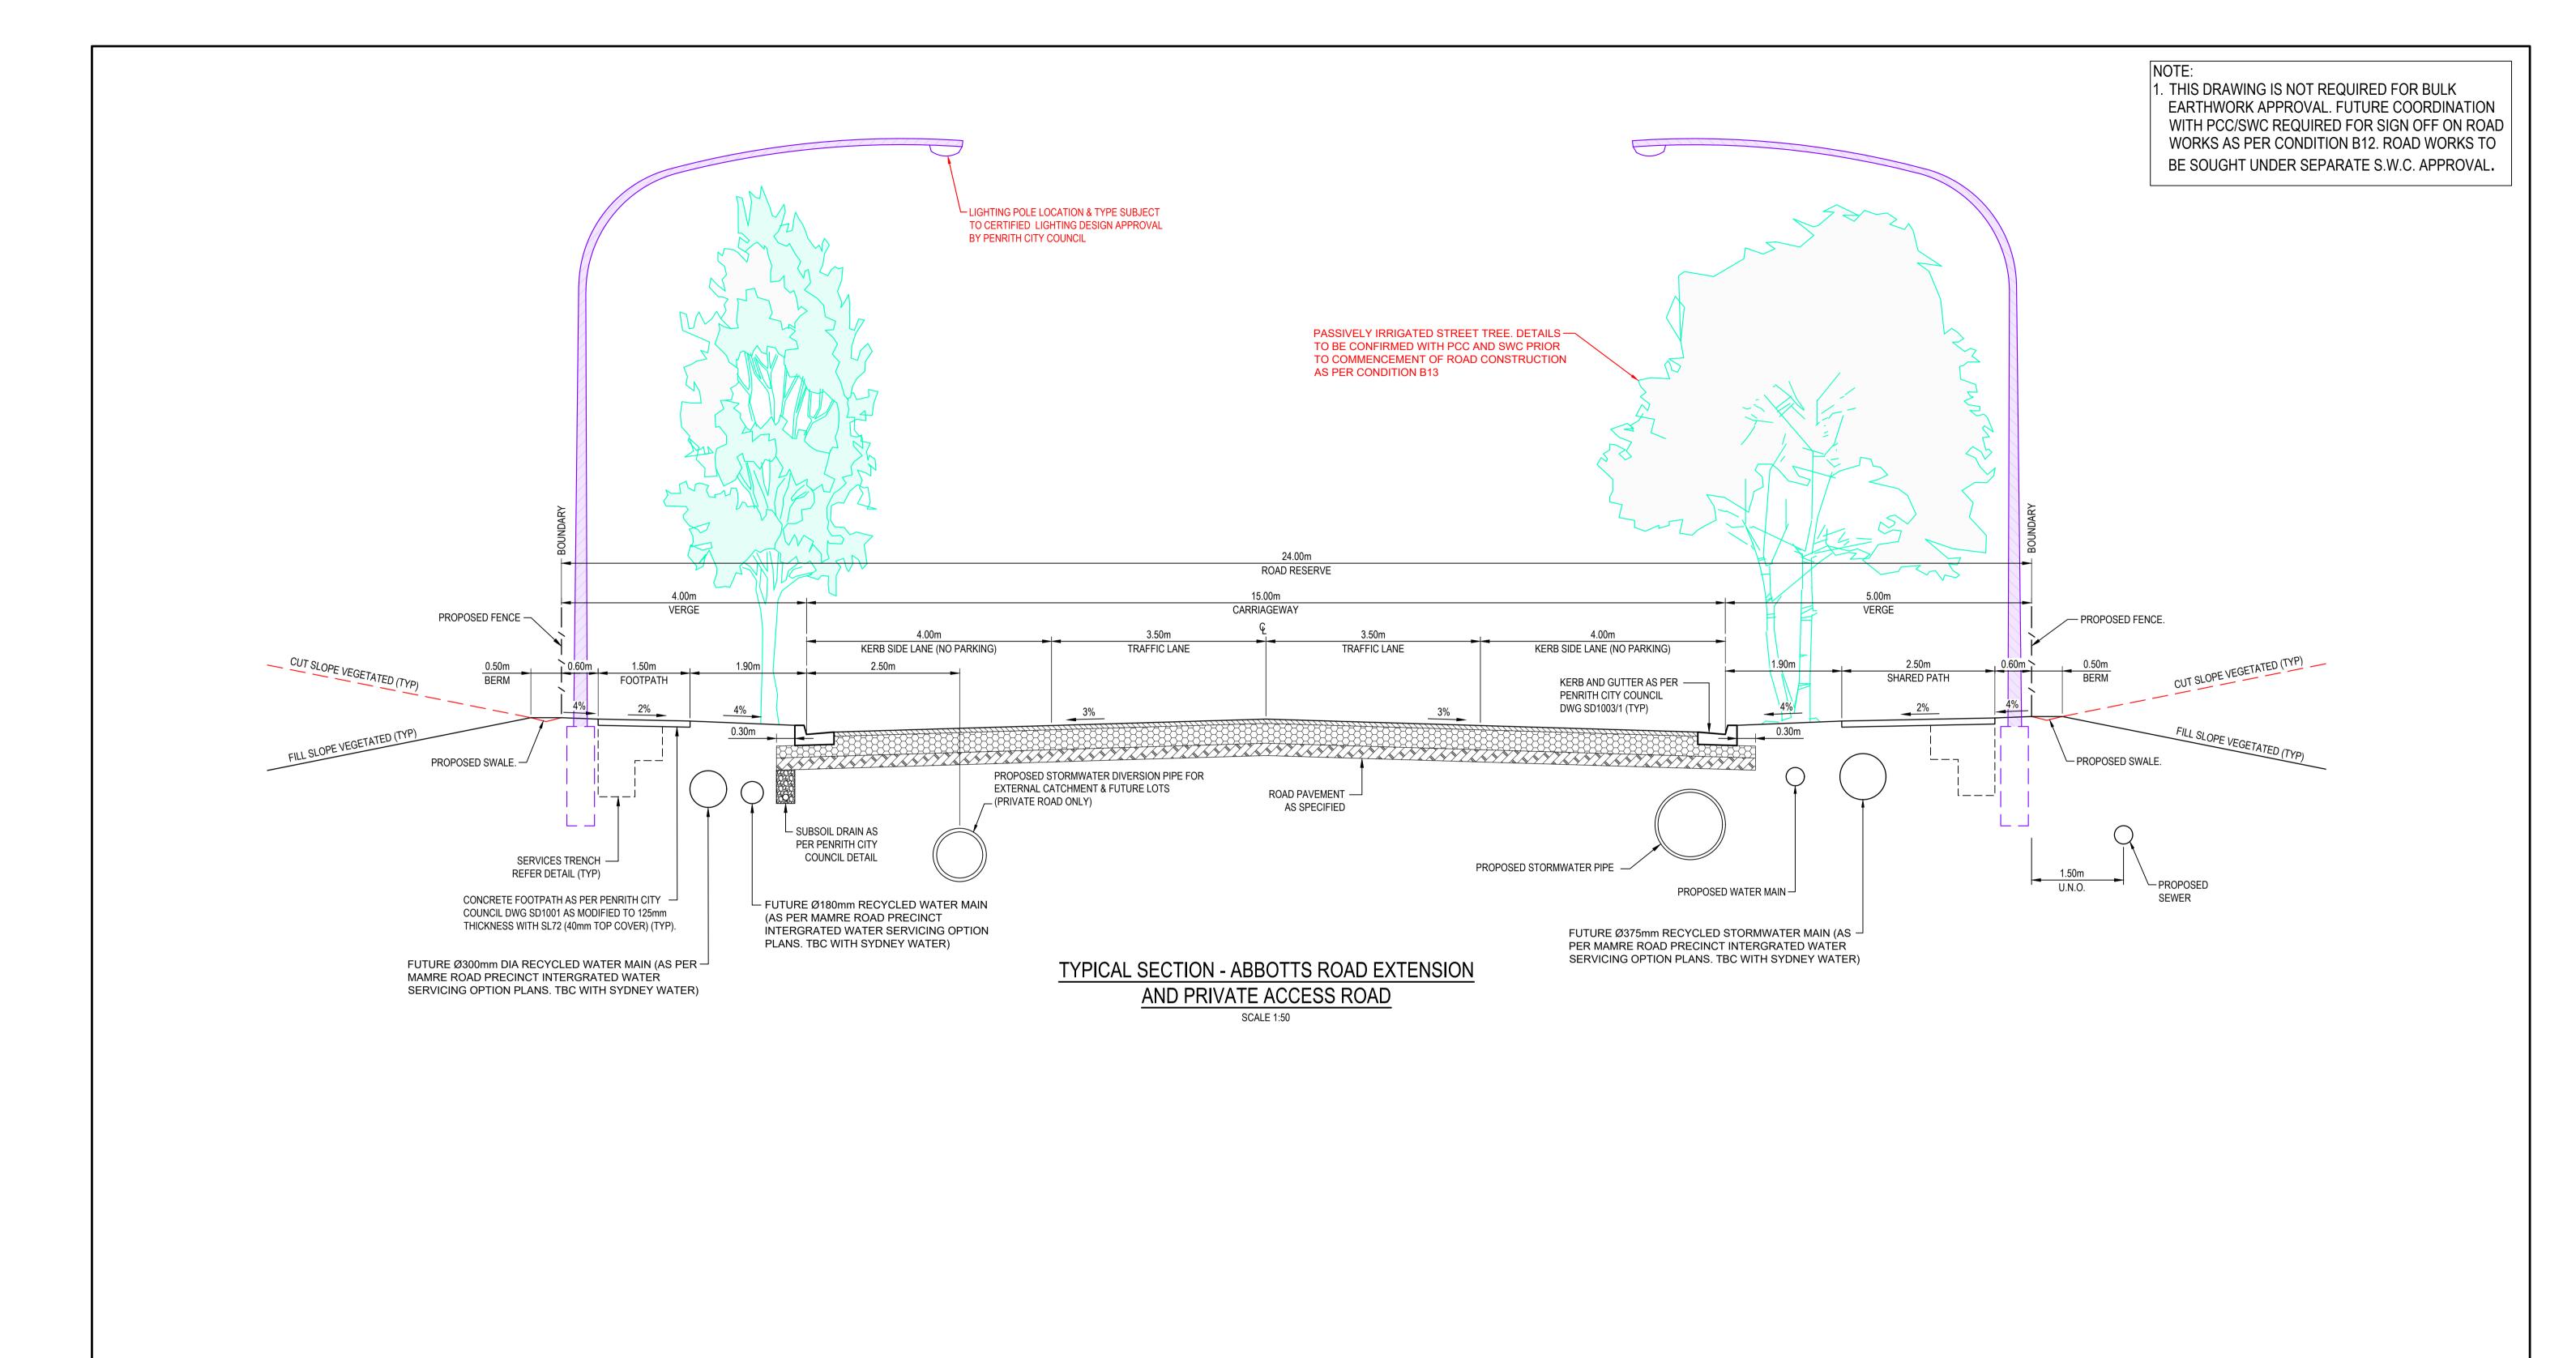
DEVELOPMENT

GENERAL NOTES

info@atl.net.au FOR APPROVAL NOT TO BE USED FOR CONSTRUCTION

Project - Drawing No. 20-748-C11002



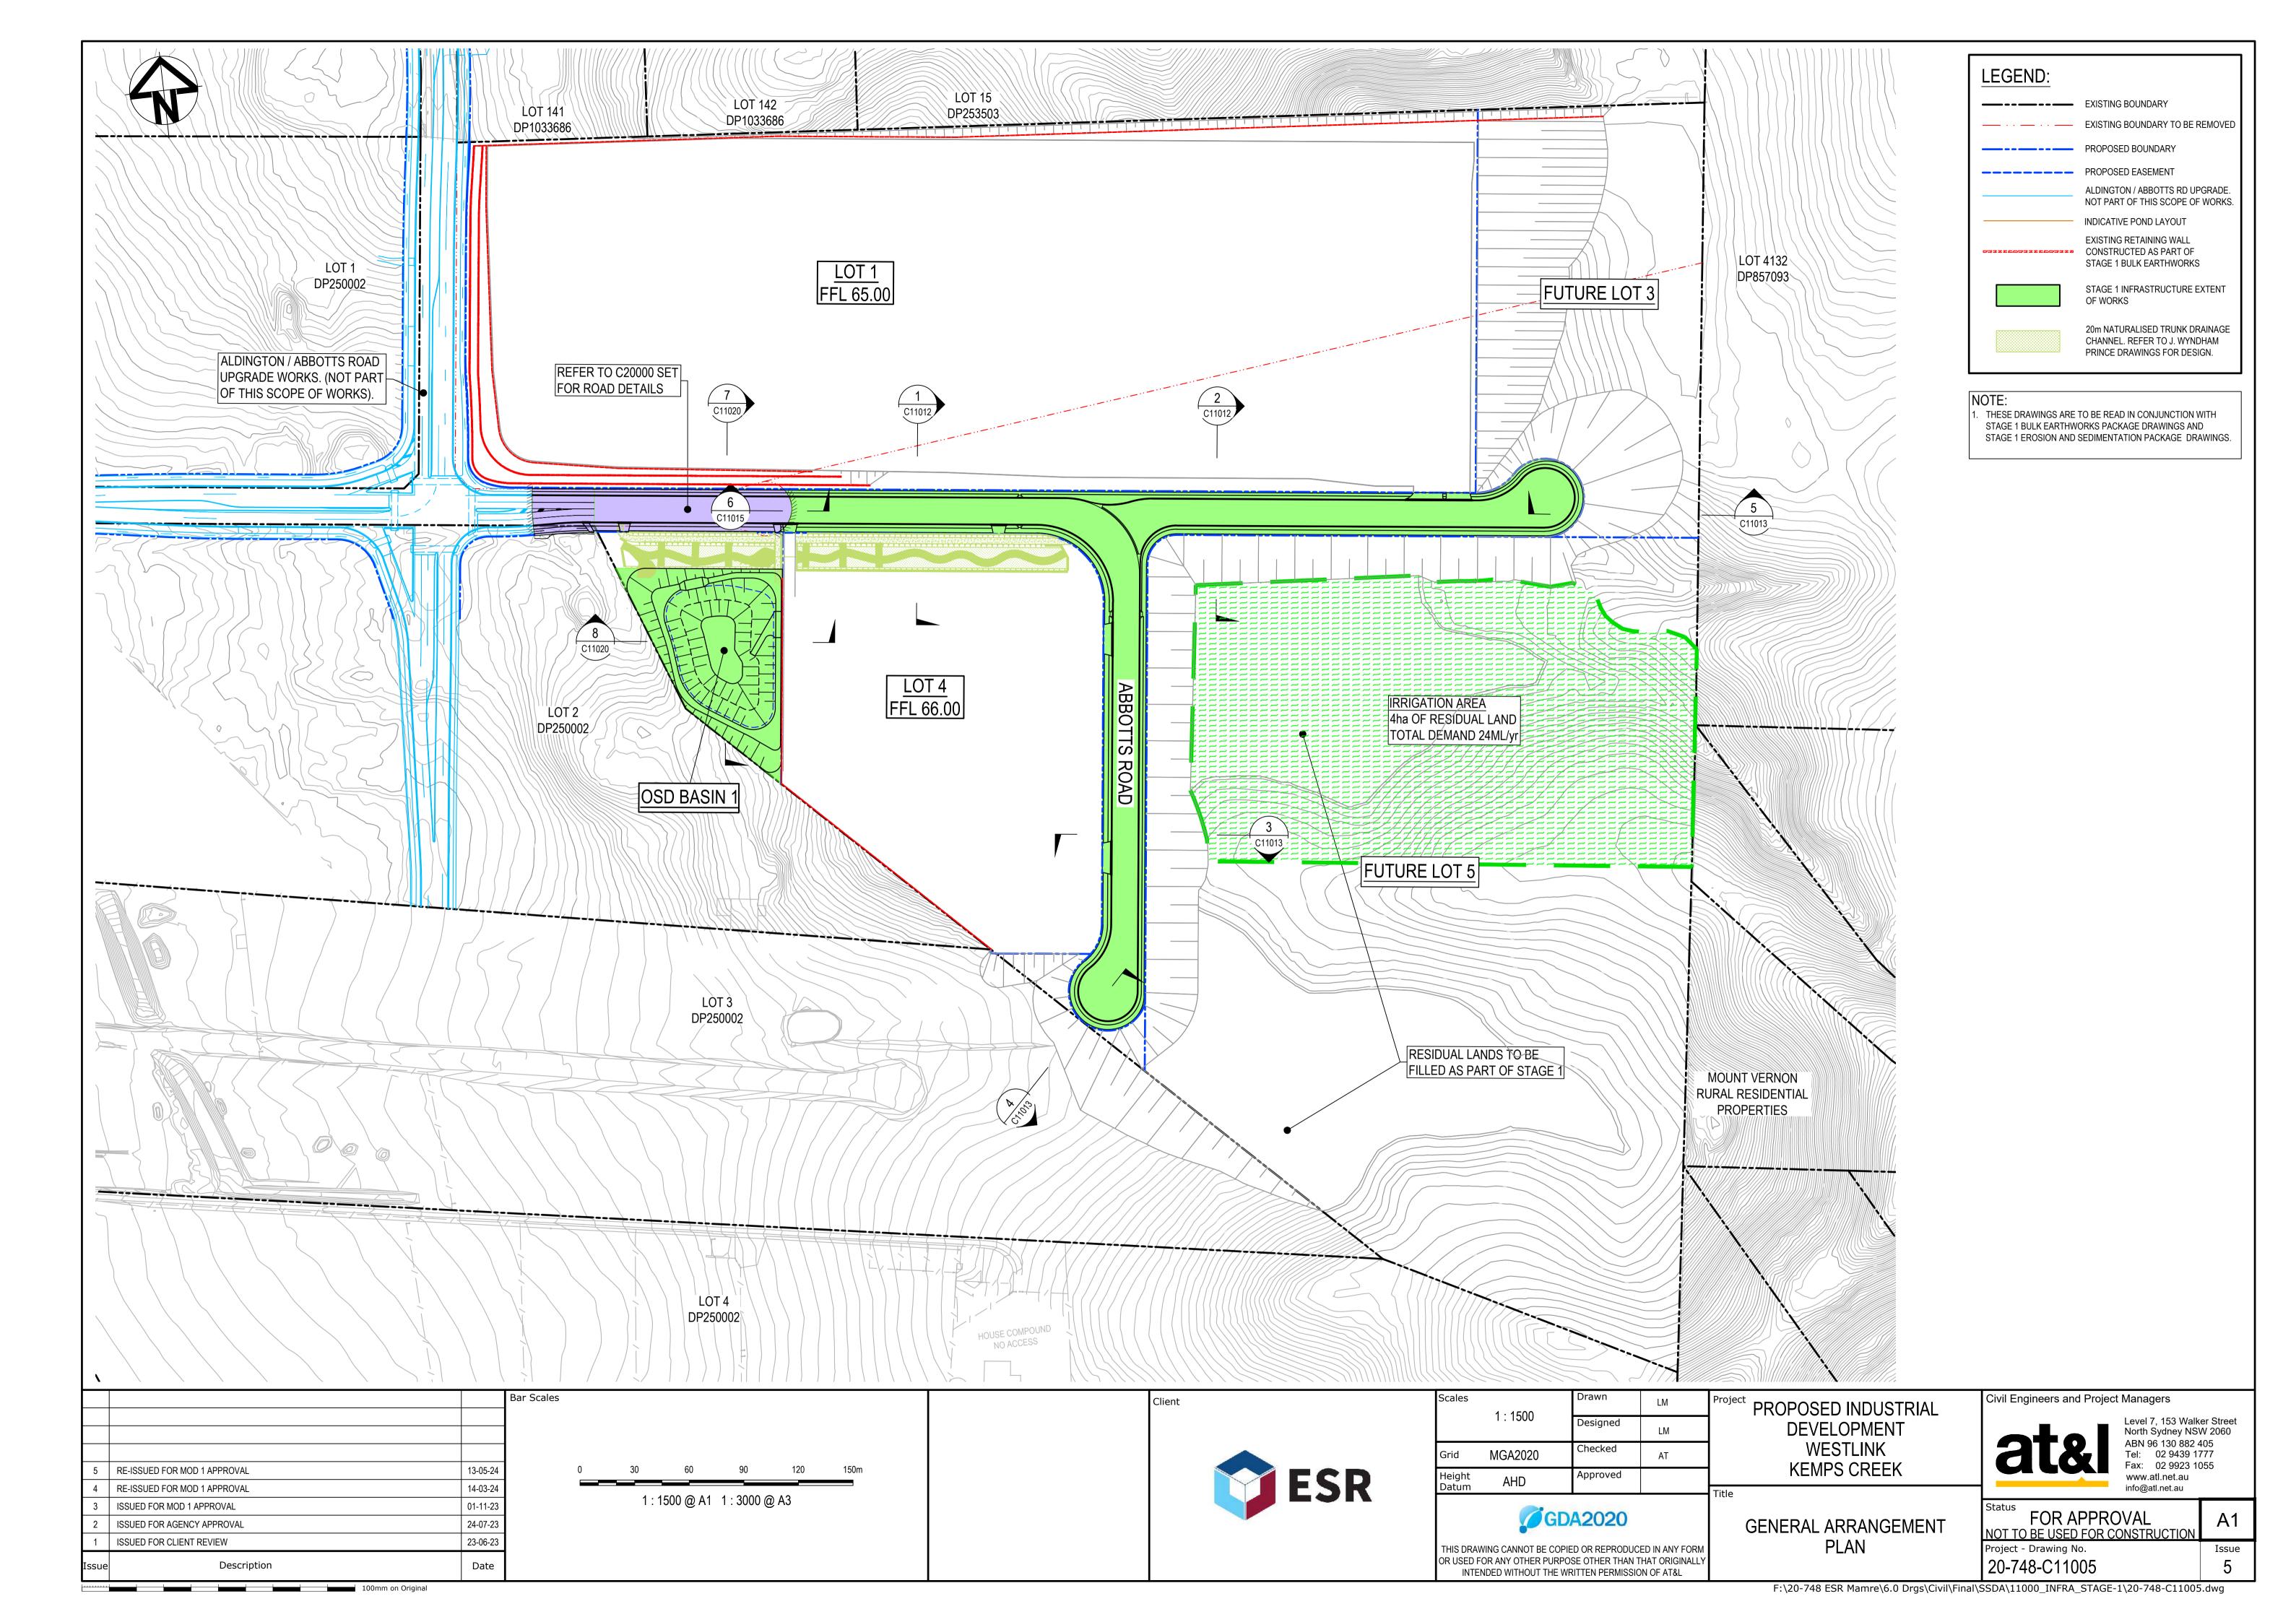

			Bar Scales	Client
5	RE-ISSUED FOR MOD 1 APPROVAL	13-05-24		
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3	ISSUED FOR MOD 1 APPROVAL	01-11-23		
2	ISSUED FOR AGENCY APPROVAL	24-07-23		
1	ISSUED FOR CLIENT REVIEW	23-06-23		

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	AS SHOWN	Designed	LM	DEVELOPMENT
Grid	MGA2020	Checked	AT	WESTLINK
Height	AHD	Approved		KEMPS CREEK

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ROAD SECTIONS

SHEET 1

Civil Engineers and Project Managers

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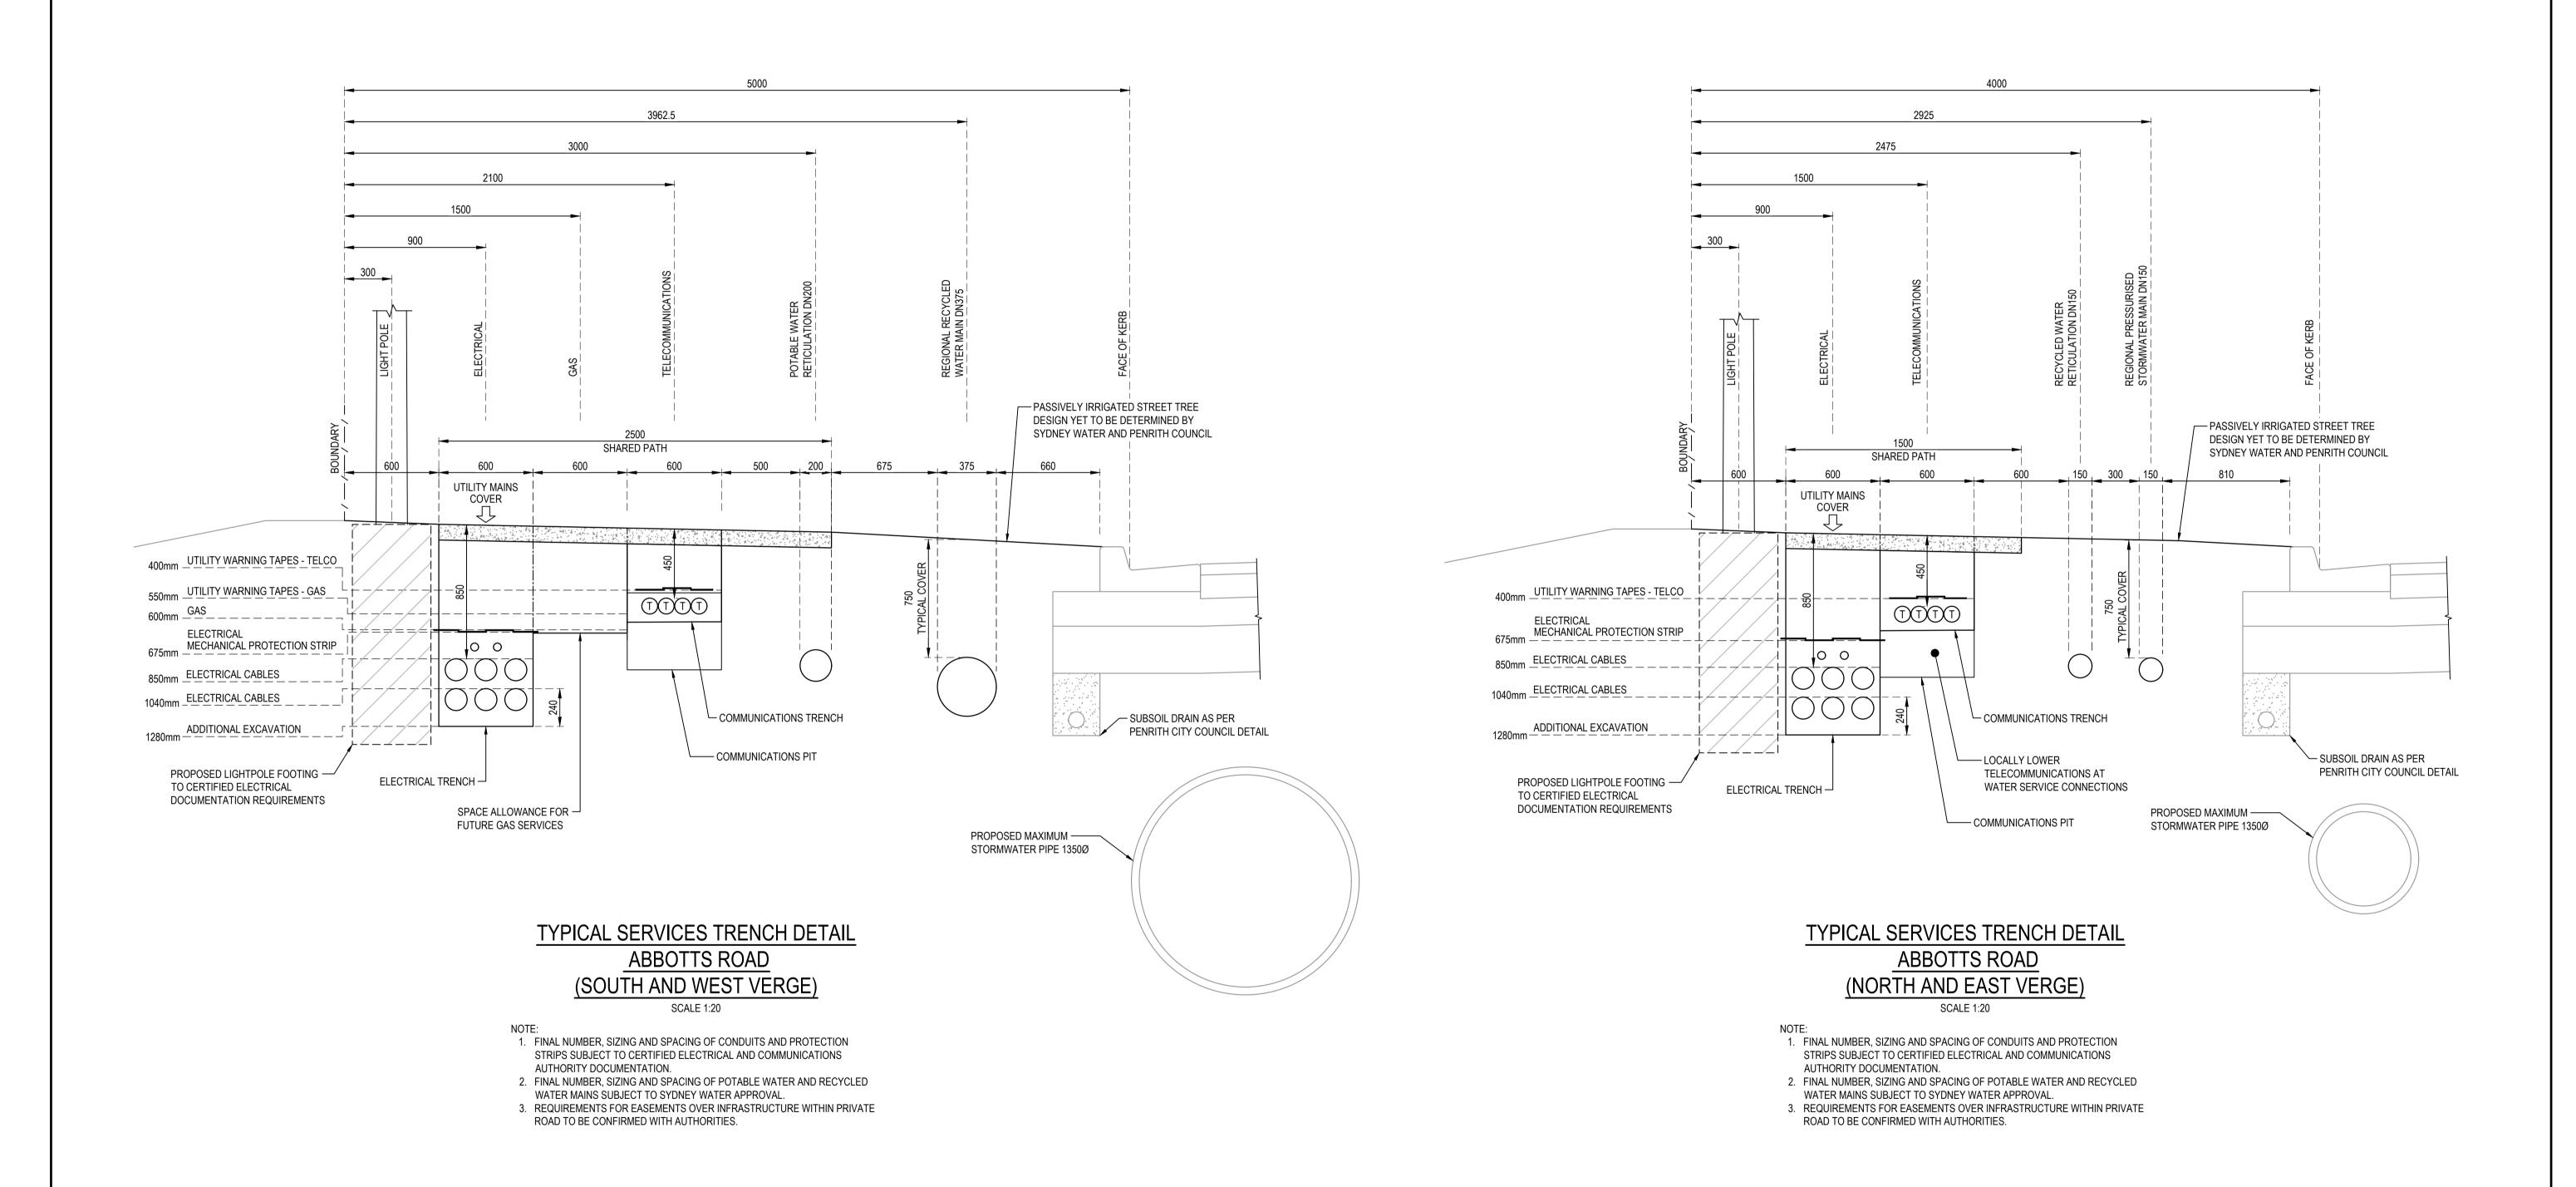
FOR APPROVAL NOT TO BE USED FOR CONSTRUCTION Project - Drawing No. 20-748-C11010

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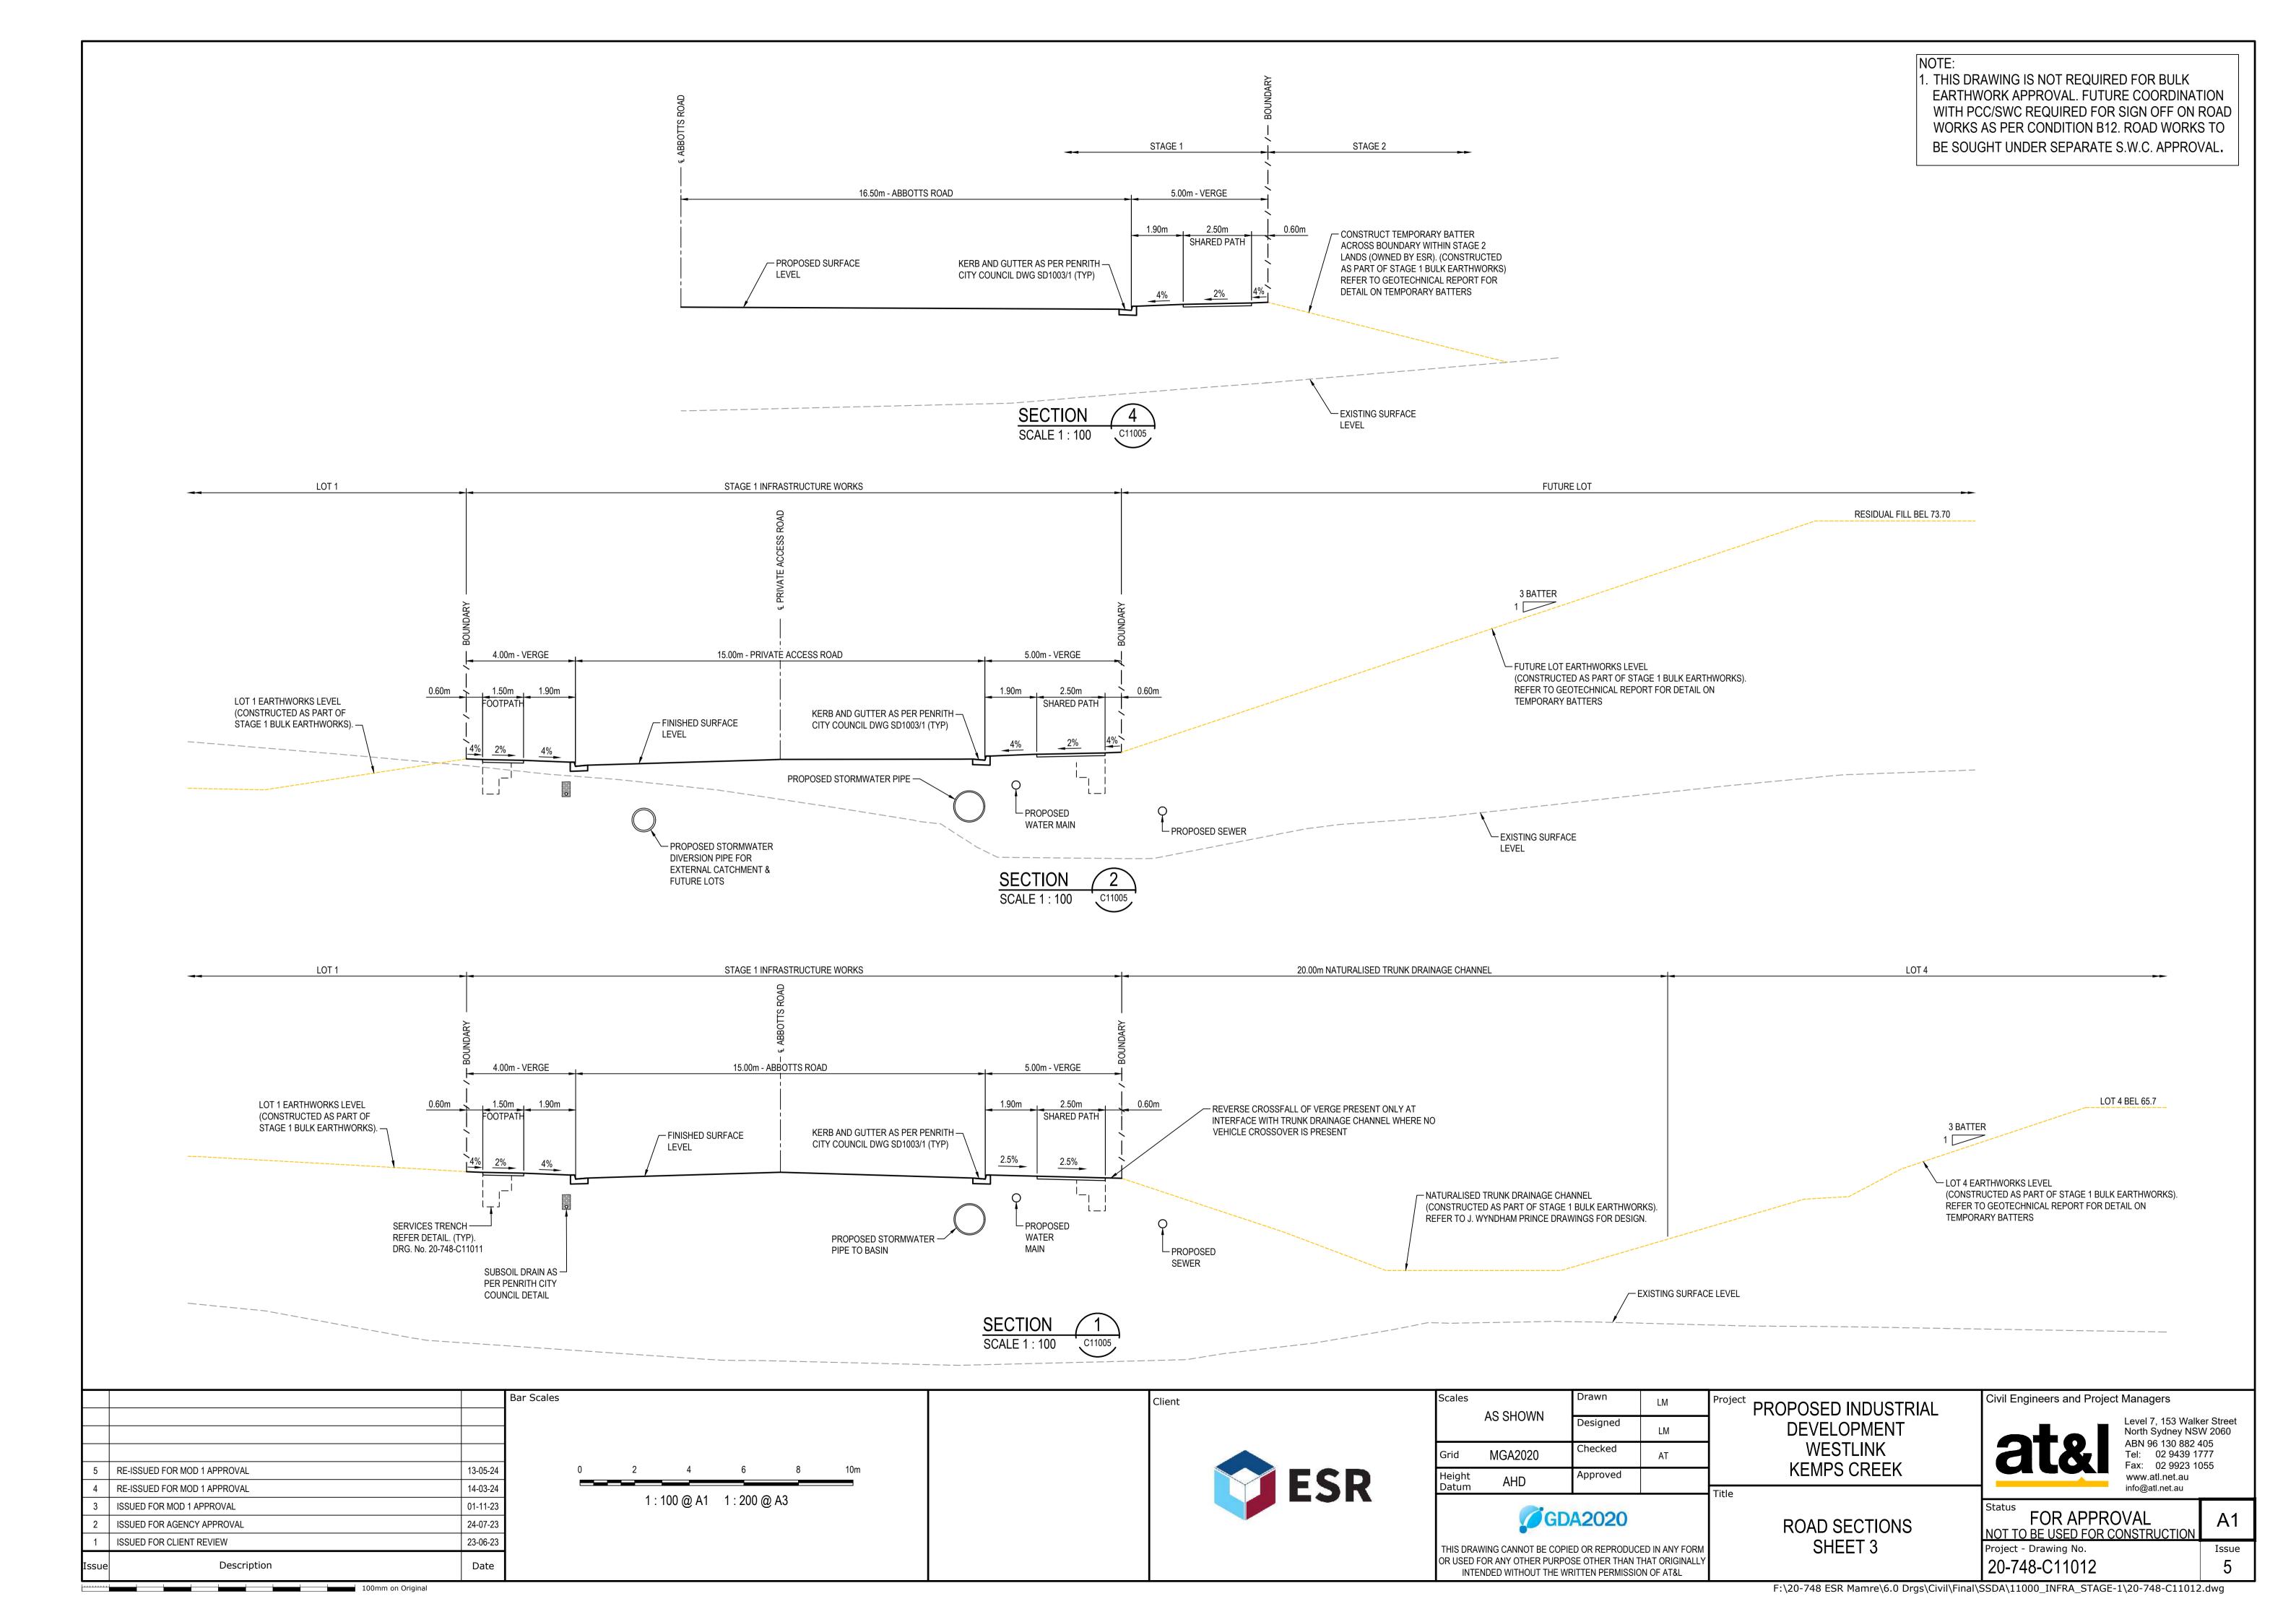
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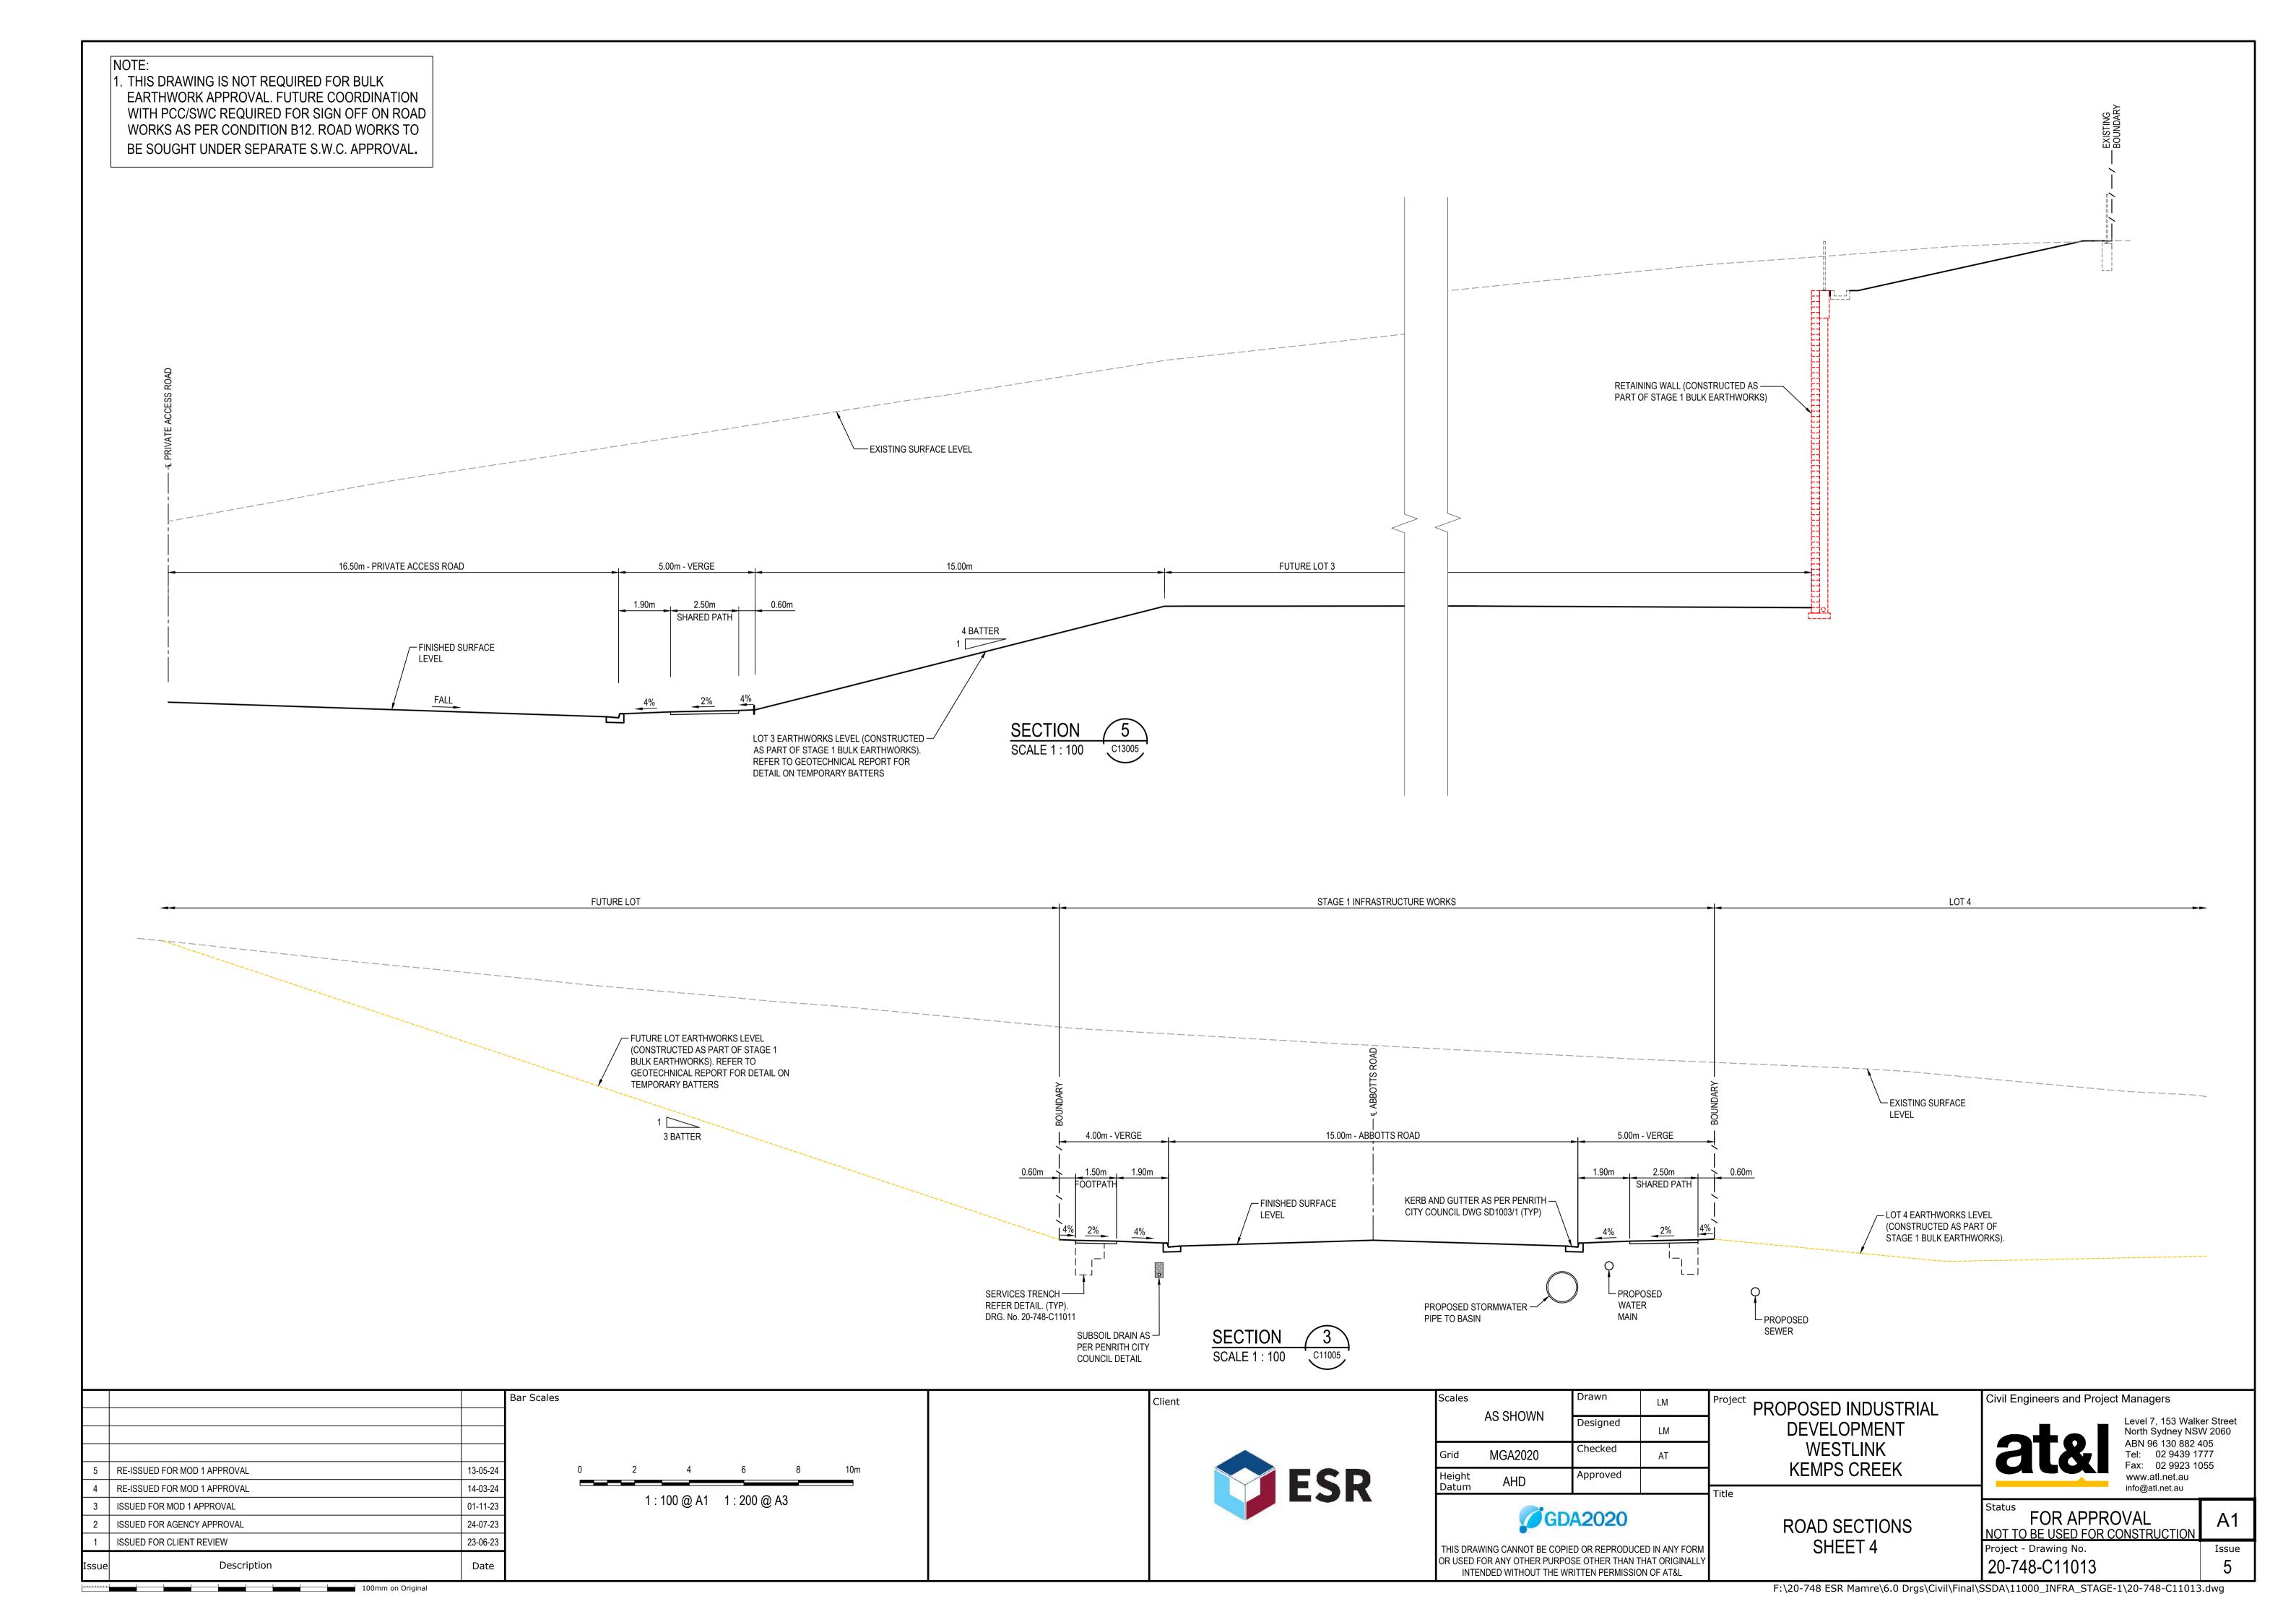
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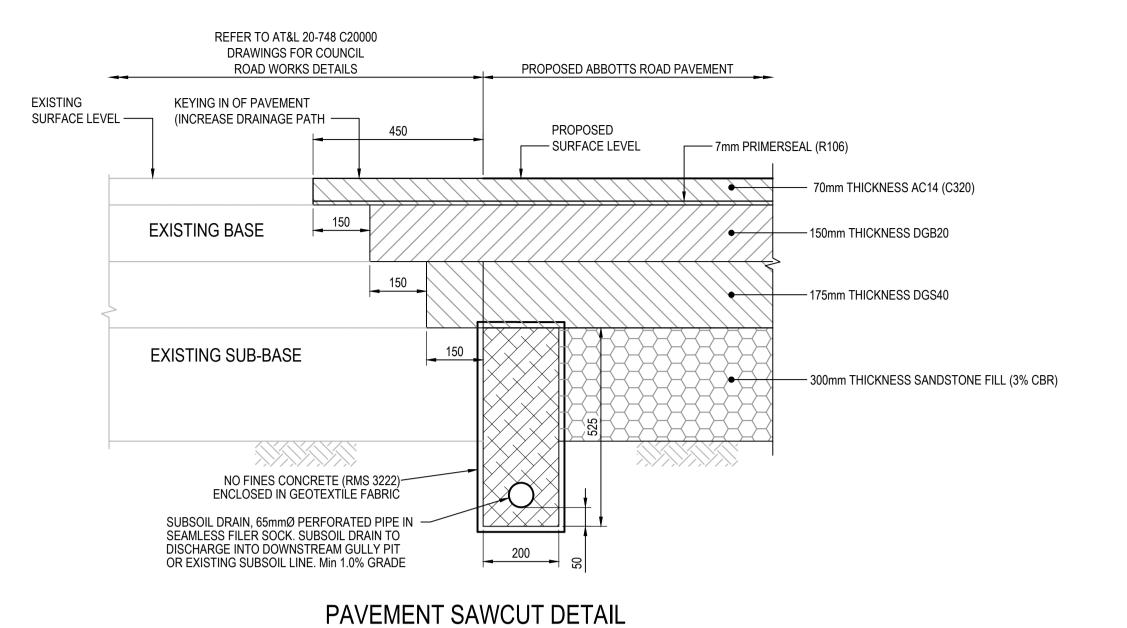
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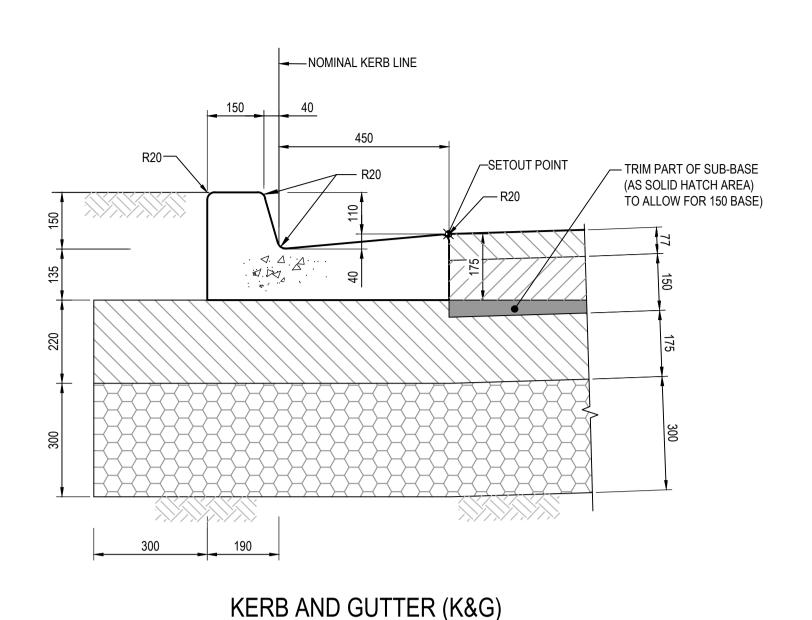


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1 ISSUED FOR CLIENT REVIEW SHEET 2 Project - Drawing No.	_ A1
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	Issue
OR USED FOR ANY OTHER PURPOSE OTHER THAN THAT ORIGINALLY INTENDED WITHOUT THE WRITTEN PERMISSION OF AT&L Description Date 20-748-C11011	5













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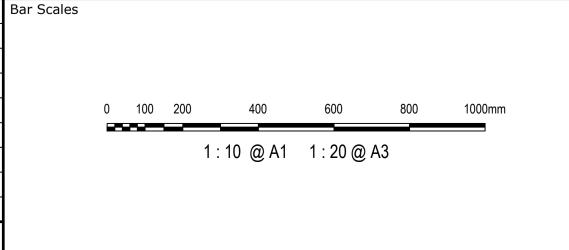


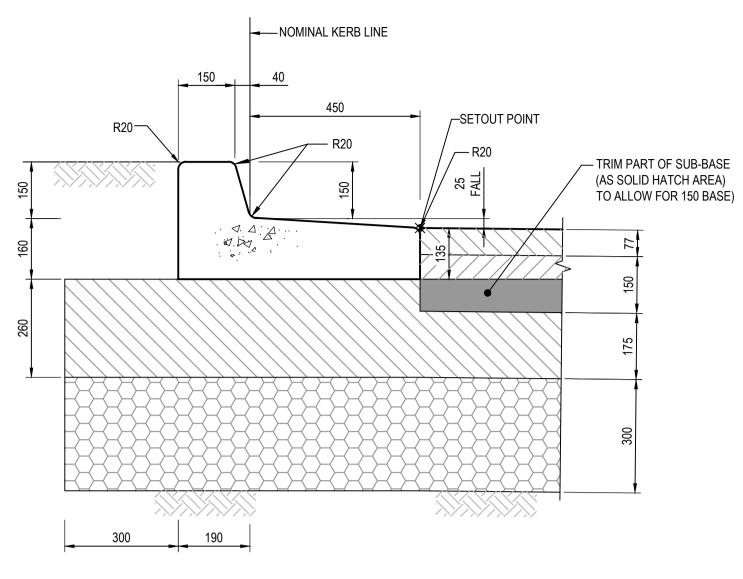DISH CROSSING (DC) SCALE 1:10 (REFER PCC DWG. SD1003/2)

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Issue	Description	Date	
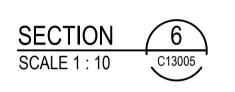
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Client

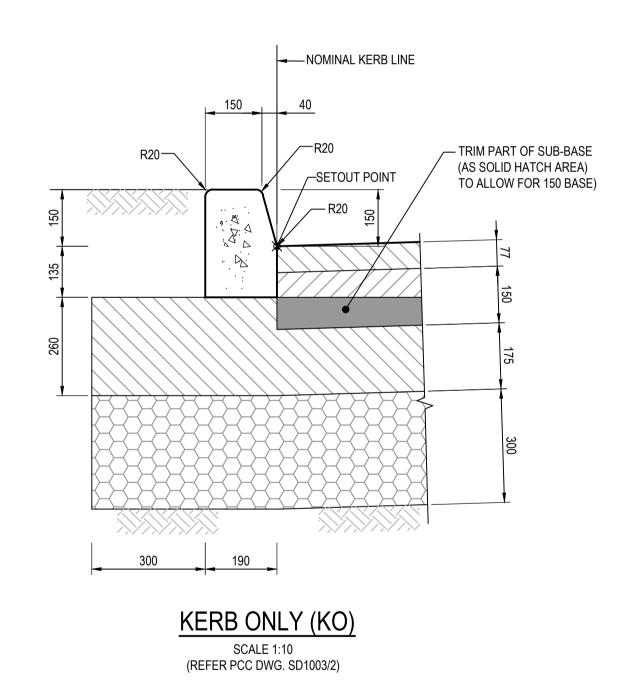Scales	AS SHOWN	Drawn	LM	Projec
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Grid	MGA2020	Checked	AT	
Height	ΔHD	Approved		
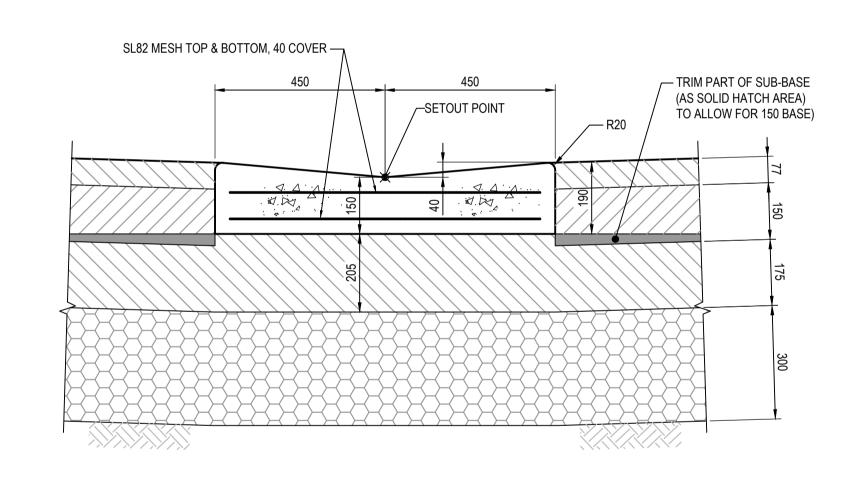
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oject	PROPOSED INDUSTRIAL
	DEVELOPMENT
	WESTLINK
	KEMPS CREEK


ROAD DETAILS SHEET 1


Civil Engineers and Pro	ject Managers
ate	Level 7, 15 North Sydr ABN 96 13 Tel: 02

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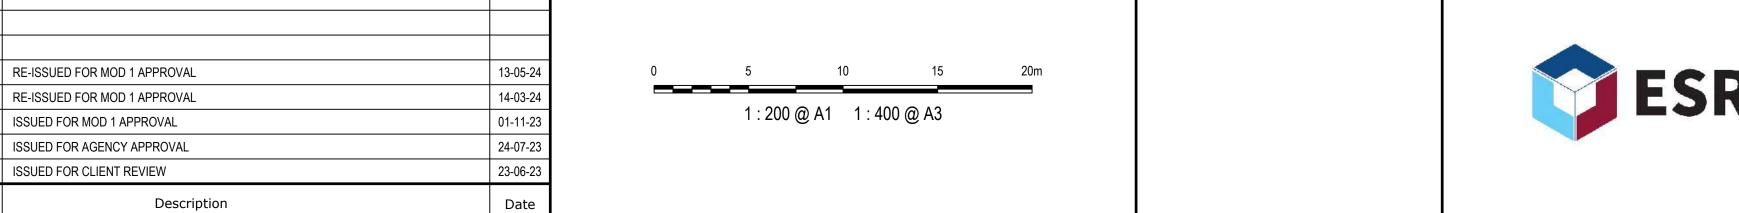
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Client



Bar Scales

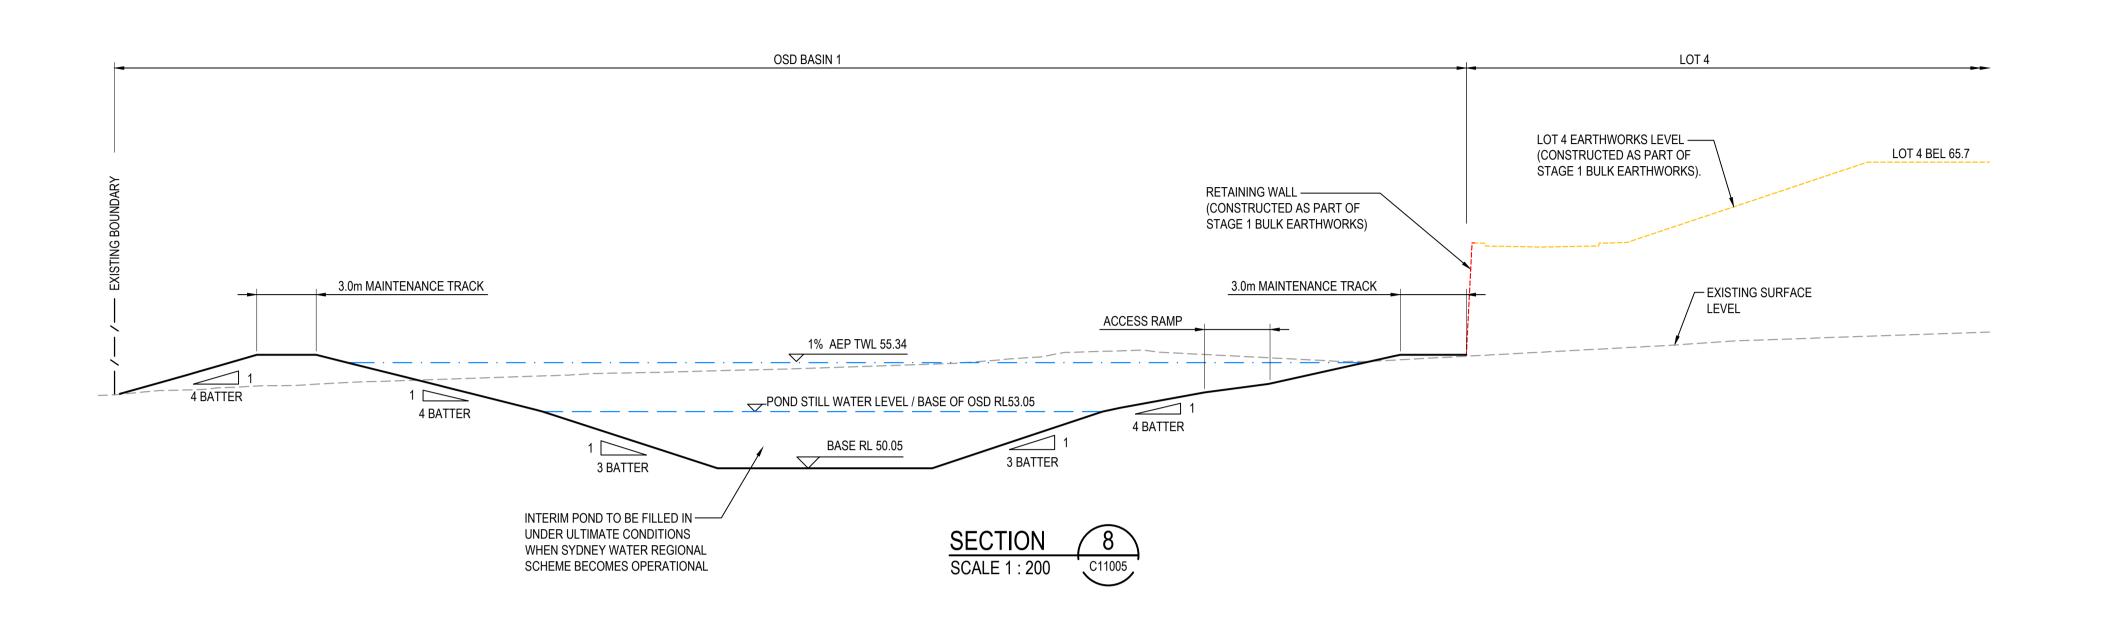Description

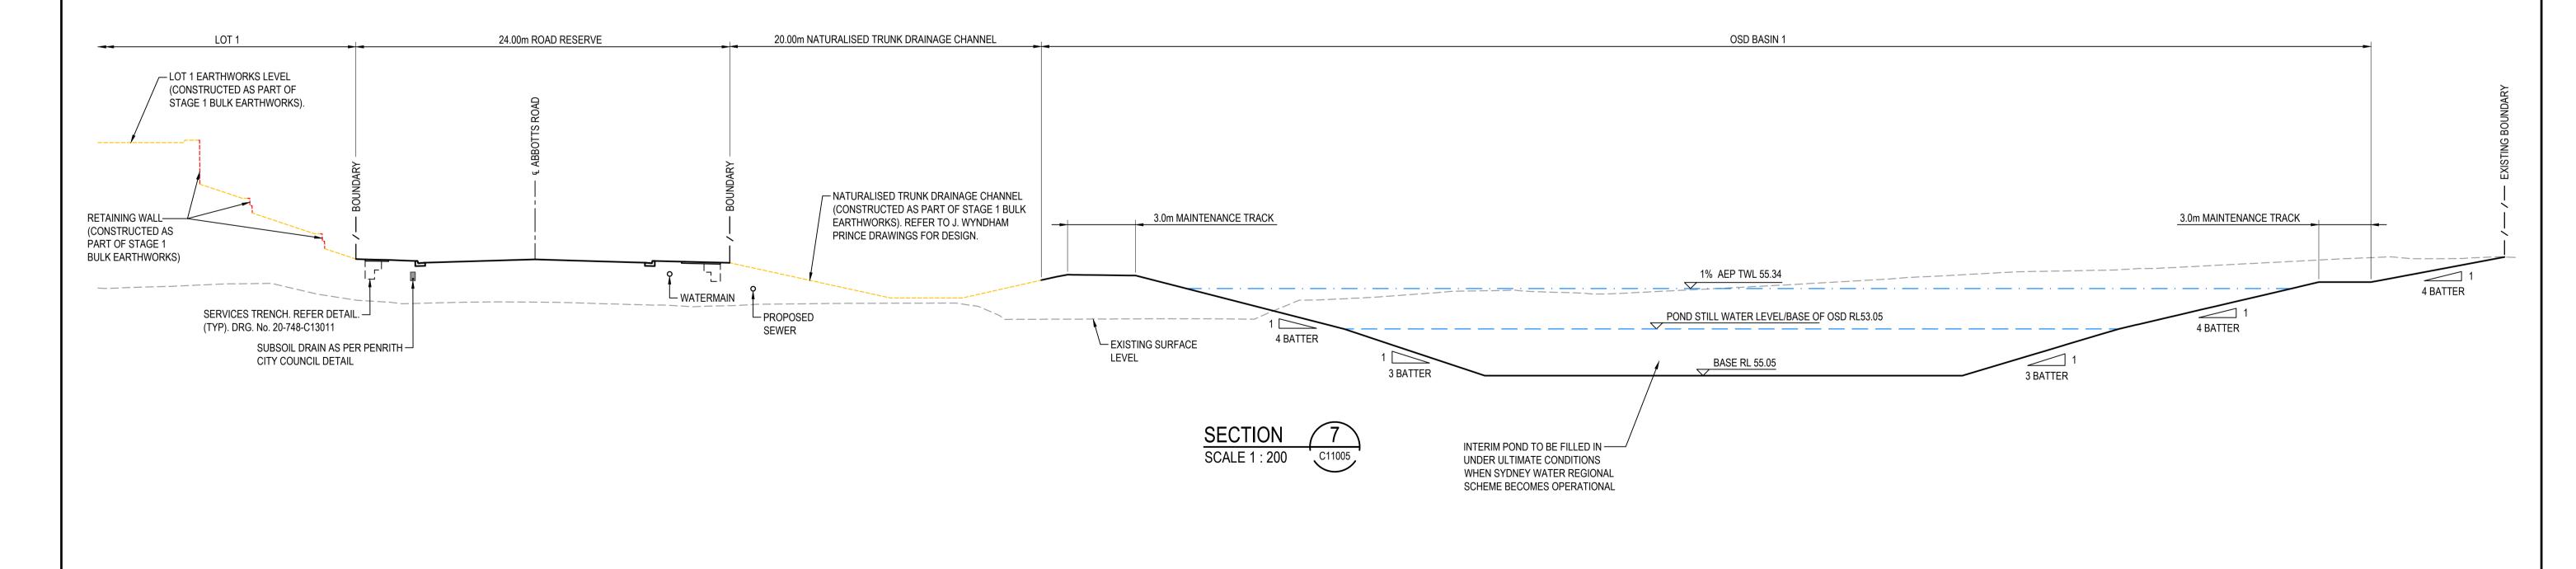

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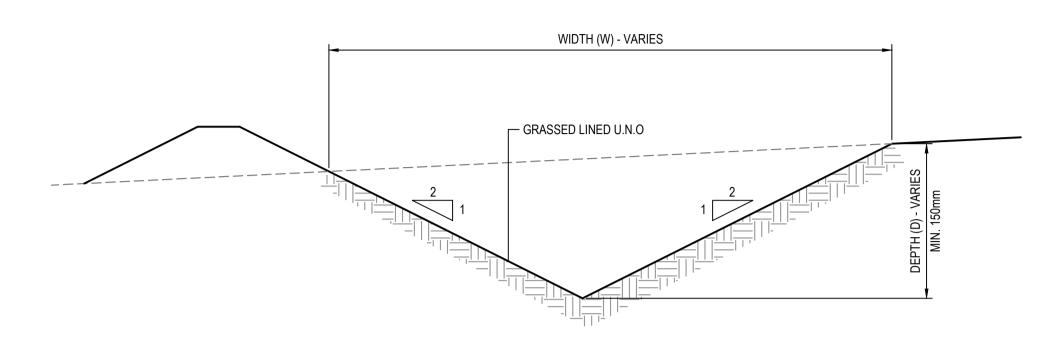
SITE SECTIONS SHEET 1 THIS DRAWING CANNOT BE COPIED OR REPRODUCED IN ANY FORM OR USED FOR ANY OTHER PURPOSE OTHER THAN THAT ORIGINALLY INTENDED WITHOUT THE WRITTEN PERMISSION OF AT&L

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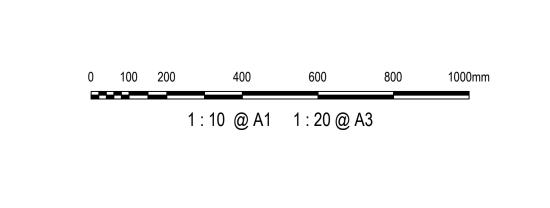
Civil Engineers and Project Managers



CATCH DRAIN DETAIL (DIRTY WATER)

5	RE-ISSUED FOR MOD 1 APPROVAL	13-05-24		
4	RE-ISSUED FOR MOD 1 APPROVAL	14-03-24		
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2	ISSUED FOR AGENCY APPROVAL	24-07-23		
1	ISSUED FOR CLIENT REVIEW	23-06-23		
Issue	Description	Date		

100mm on Original





Client

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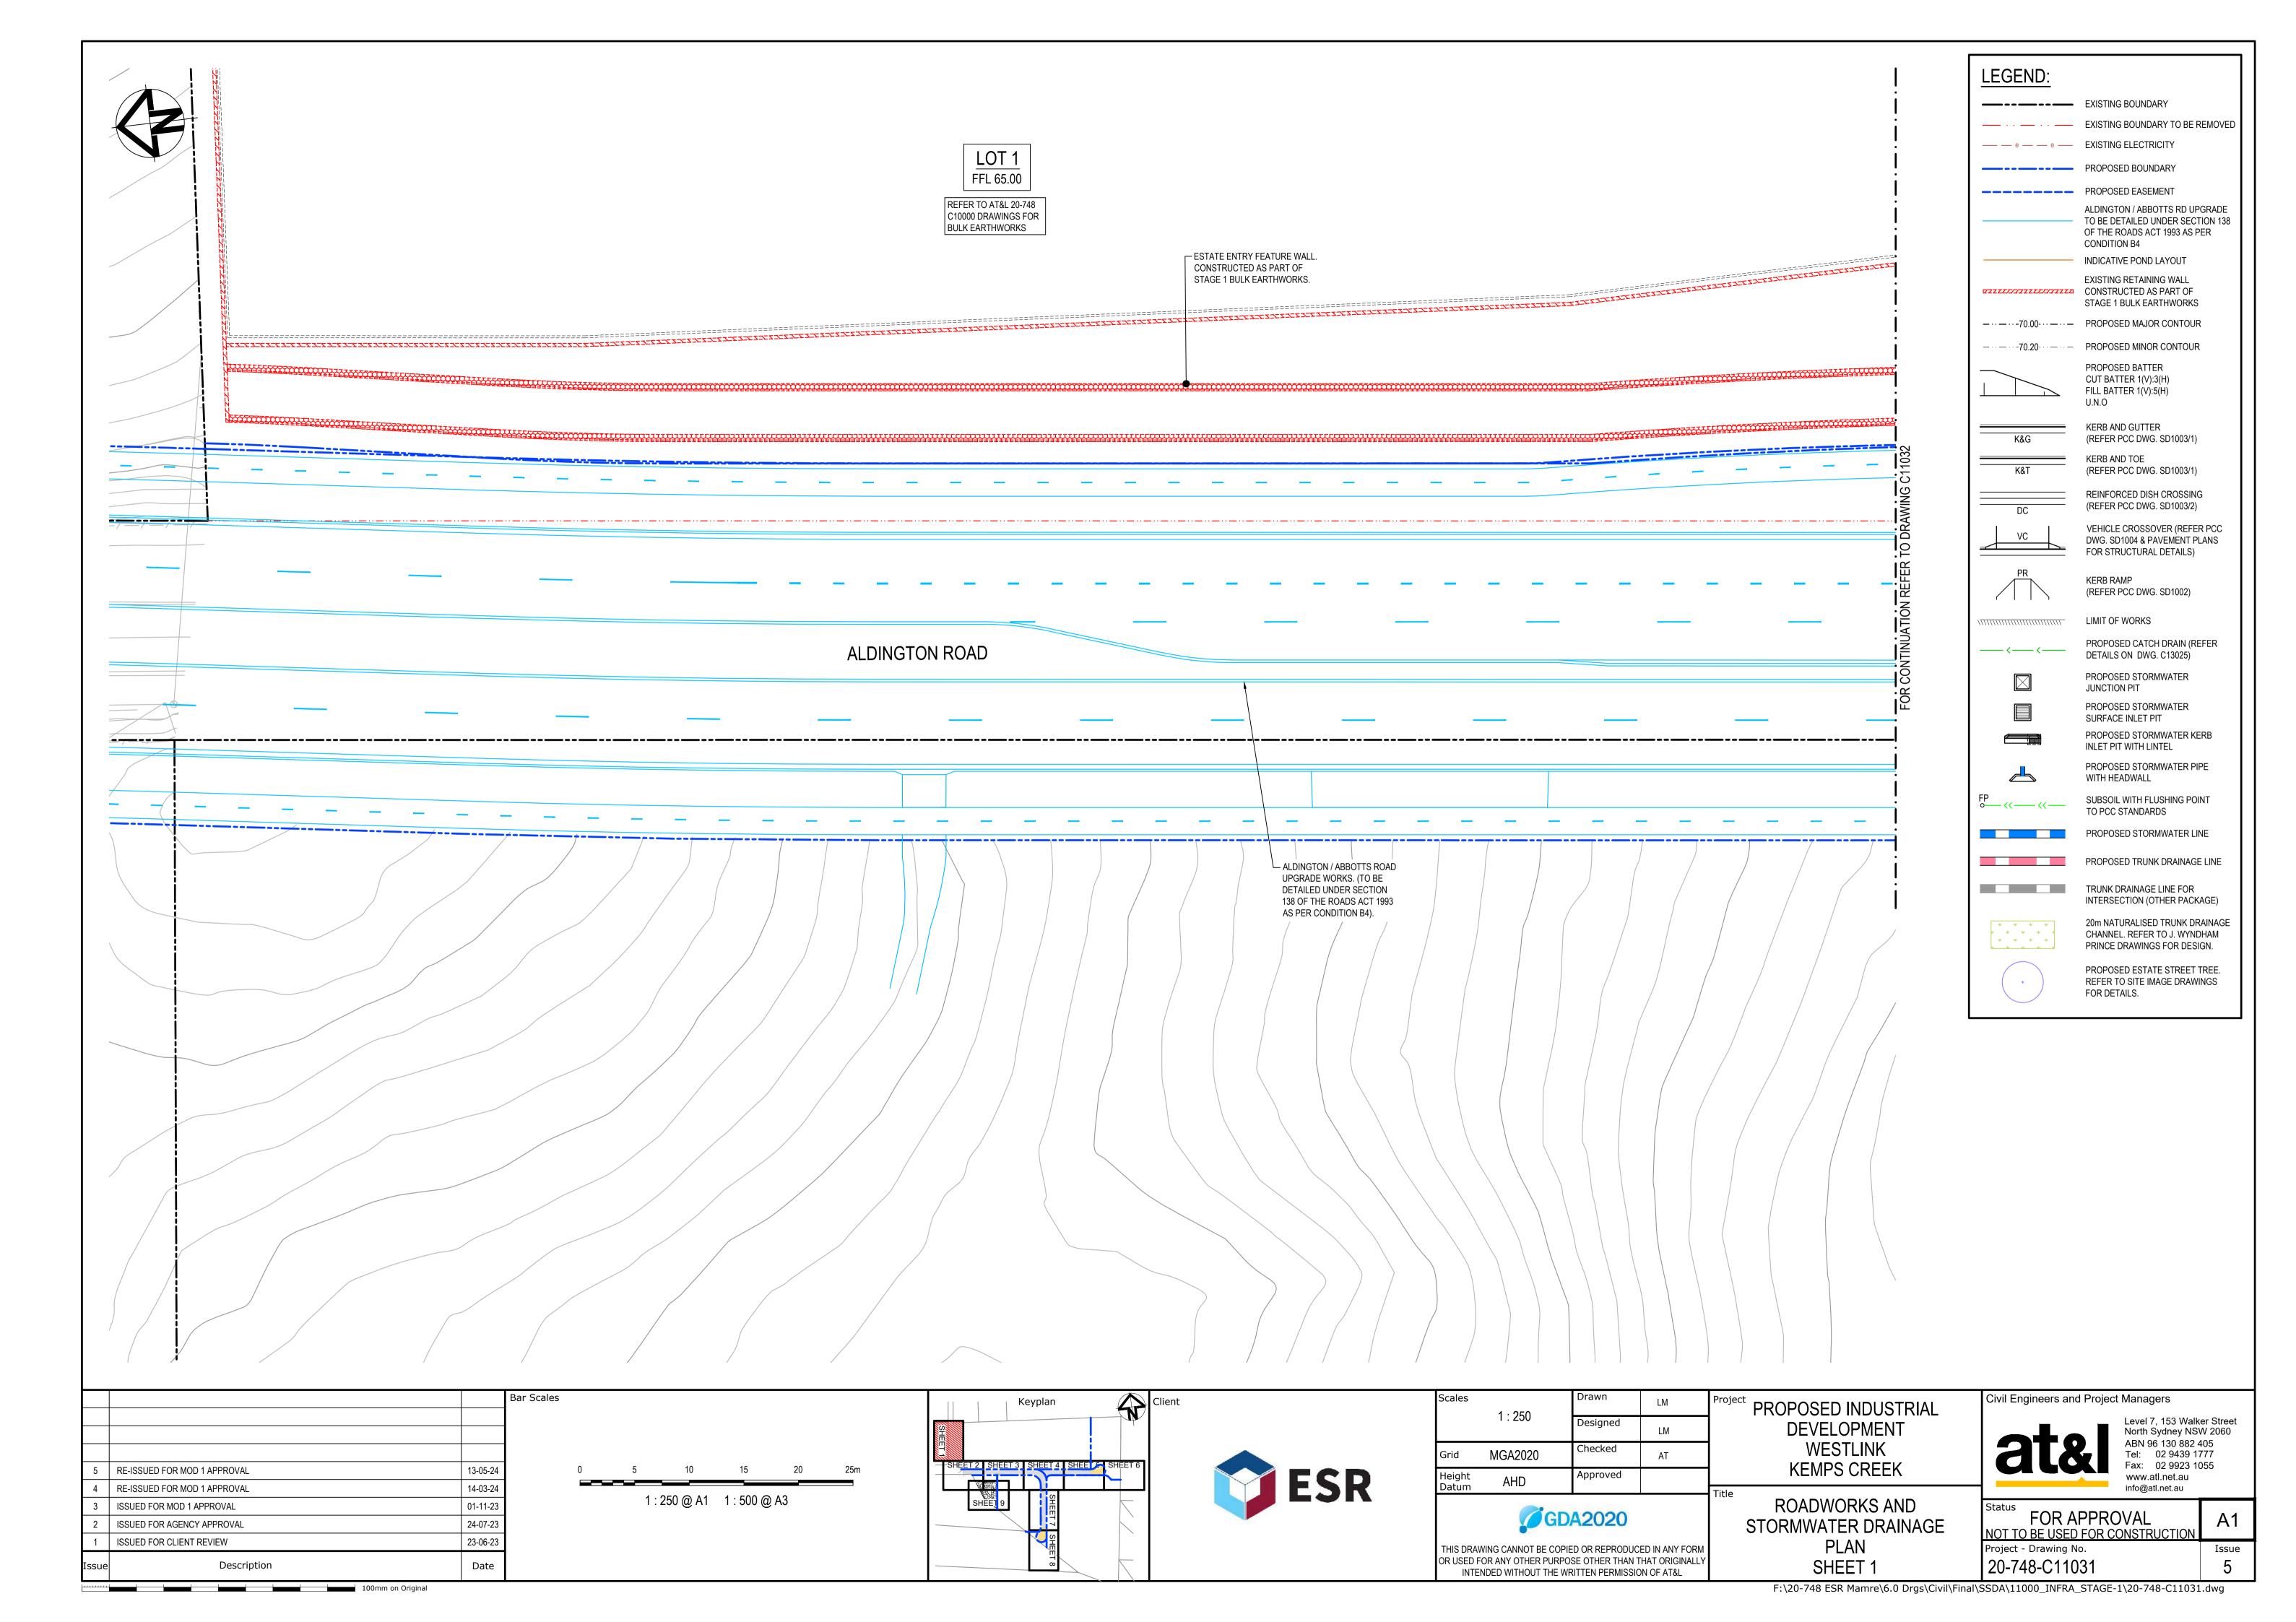
ct	PROPOSED INDUSTRIAL
	DEVELOPMENT
	WESTLINK
	KEMPS CREEK


SITE DETAILS SHEET 1


Civil Engineers and Project Managers							
atol	Level 7, 153 W North Sydney I ABN 96 130 88						


Walker Street by NSW 2060 ABN 96 130 882 405
Tel: 02 9439 1777
Fax: 02 9923 1055
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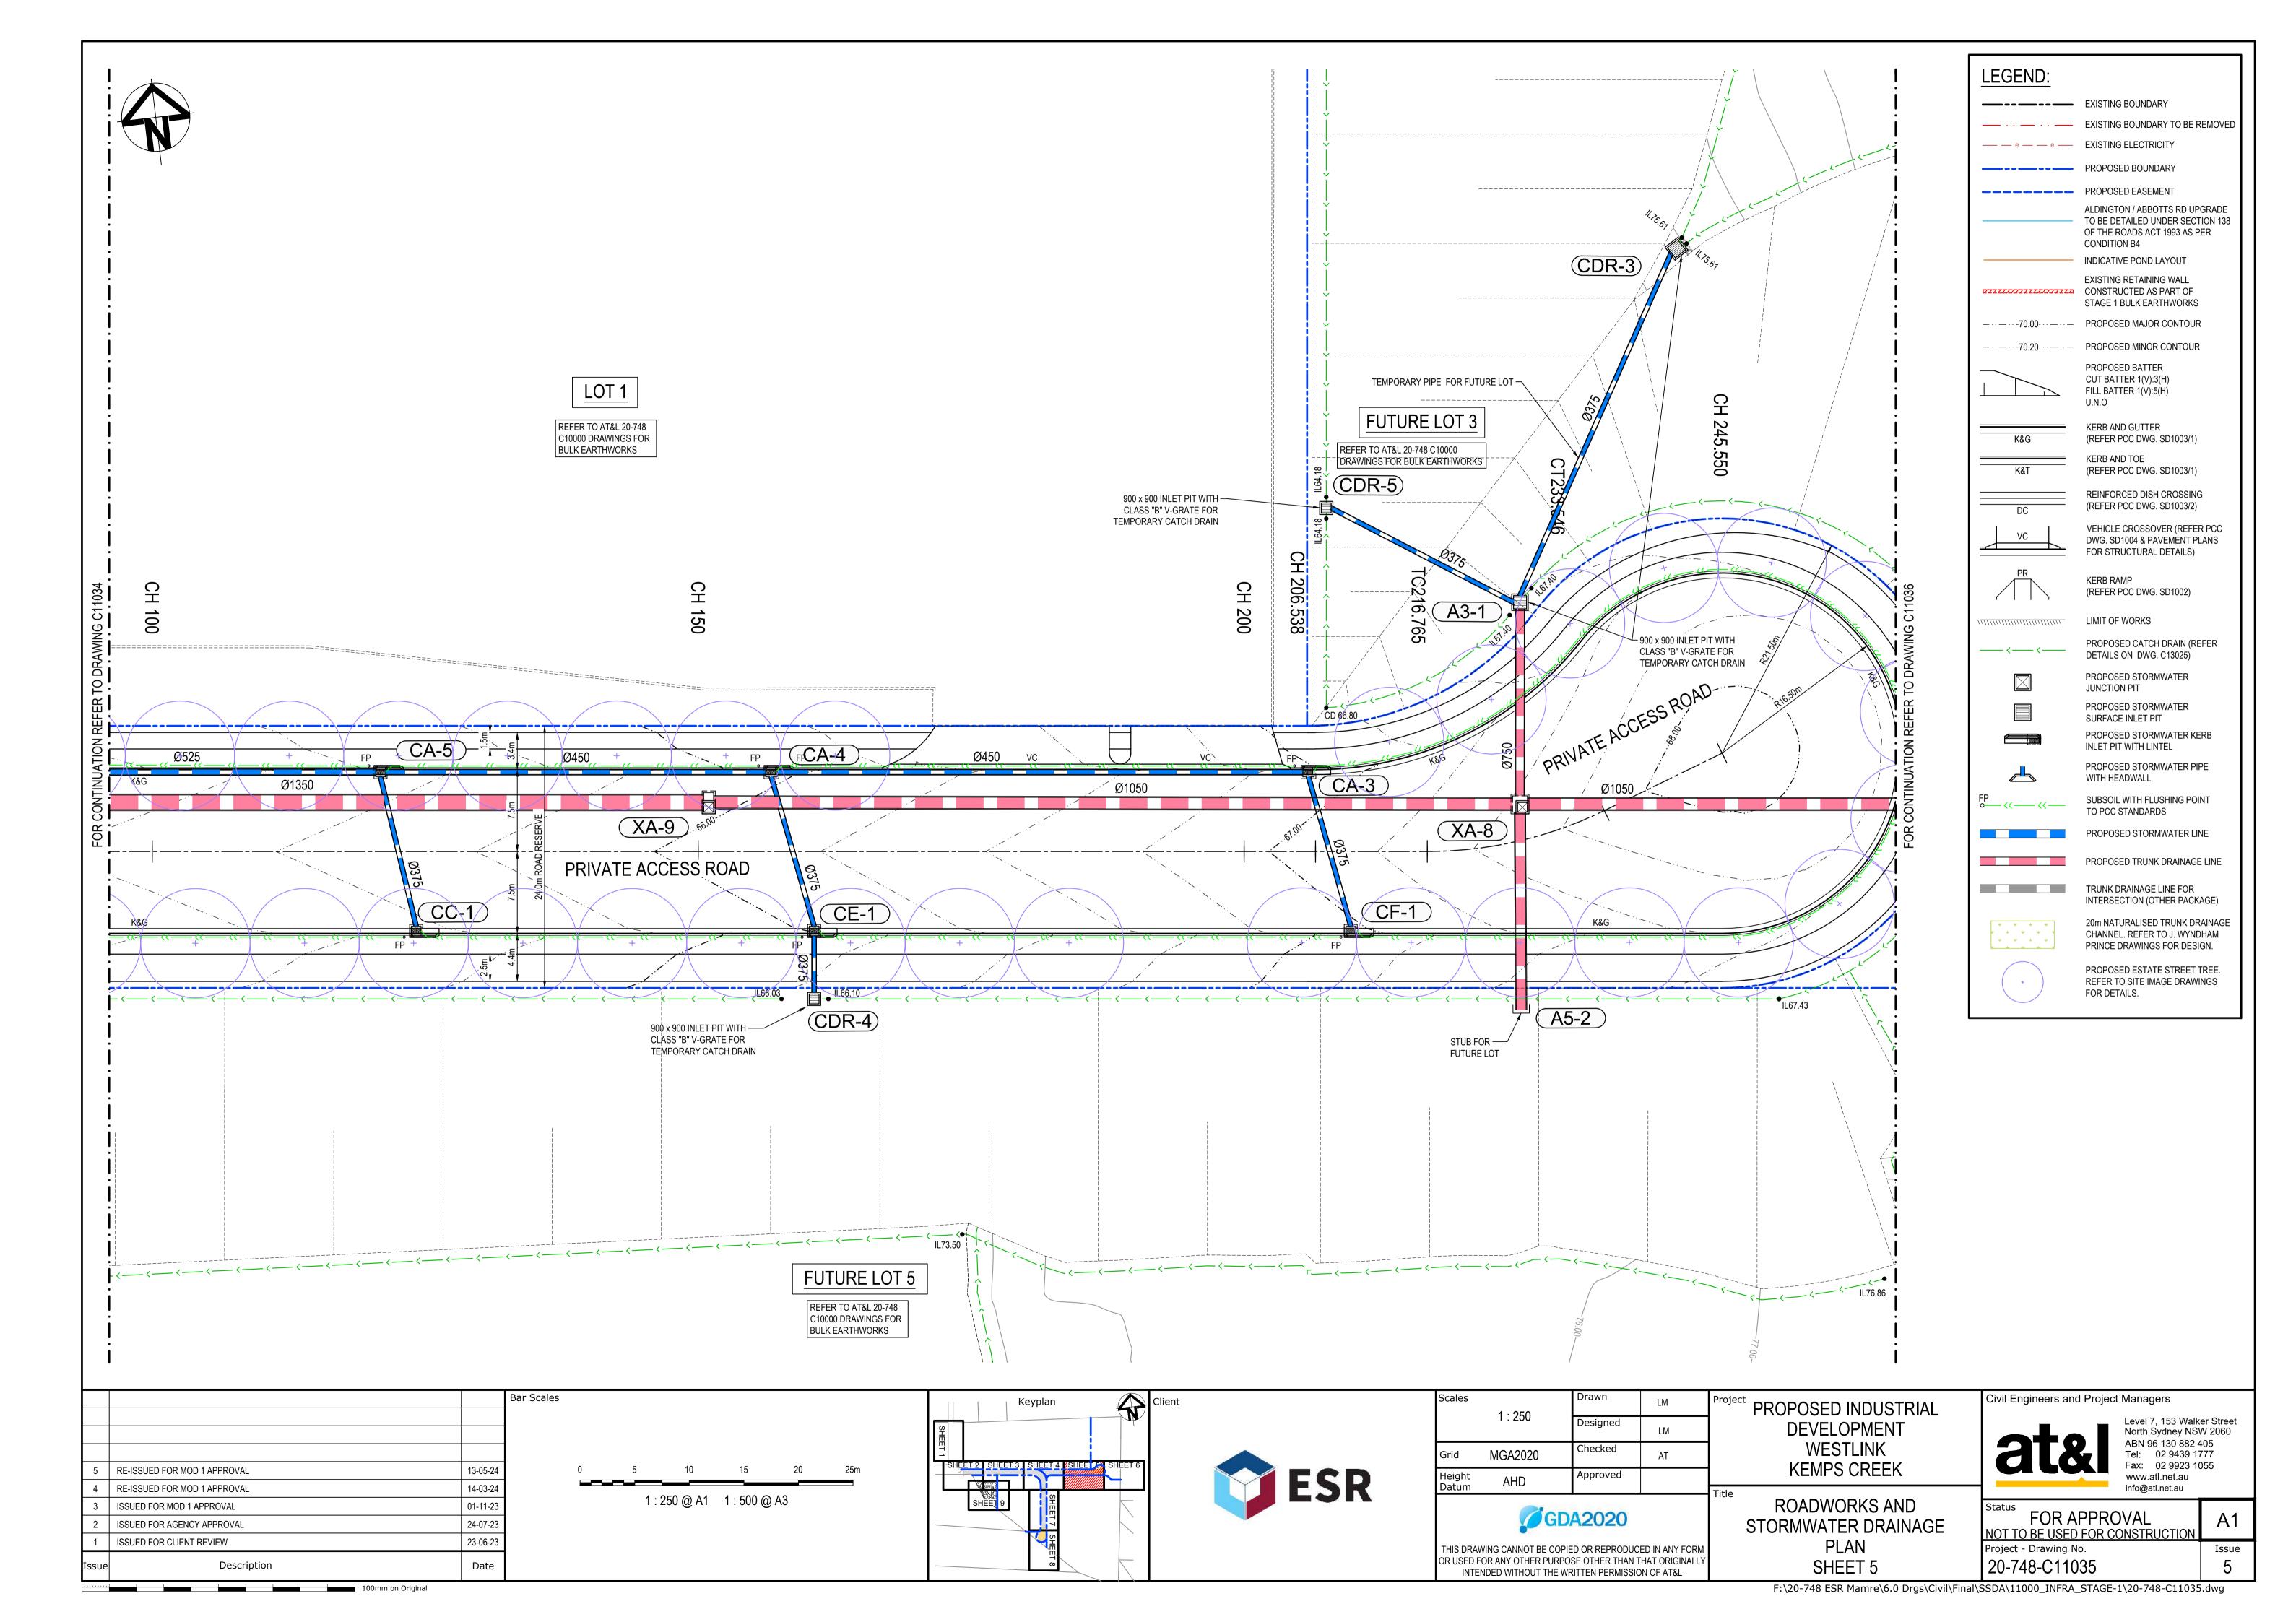
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NOT TO BE USED FOR CONSTRUCTION	
Project - Drawing No.	Issue
20-748-C11025	5







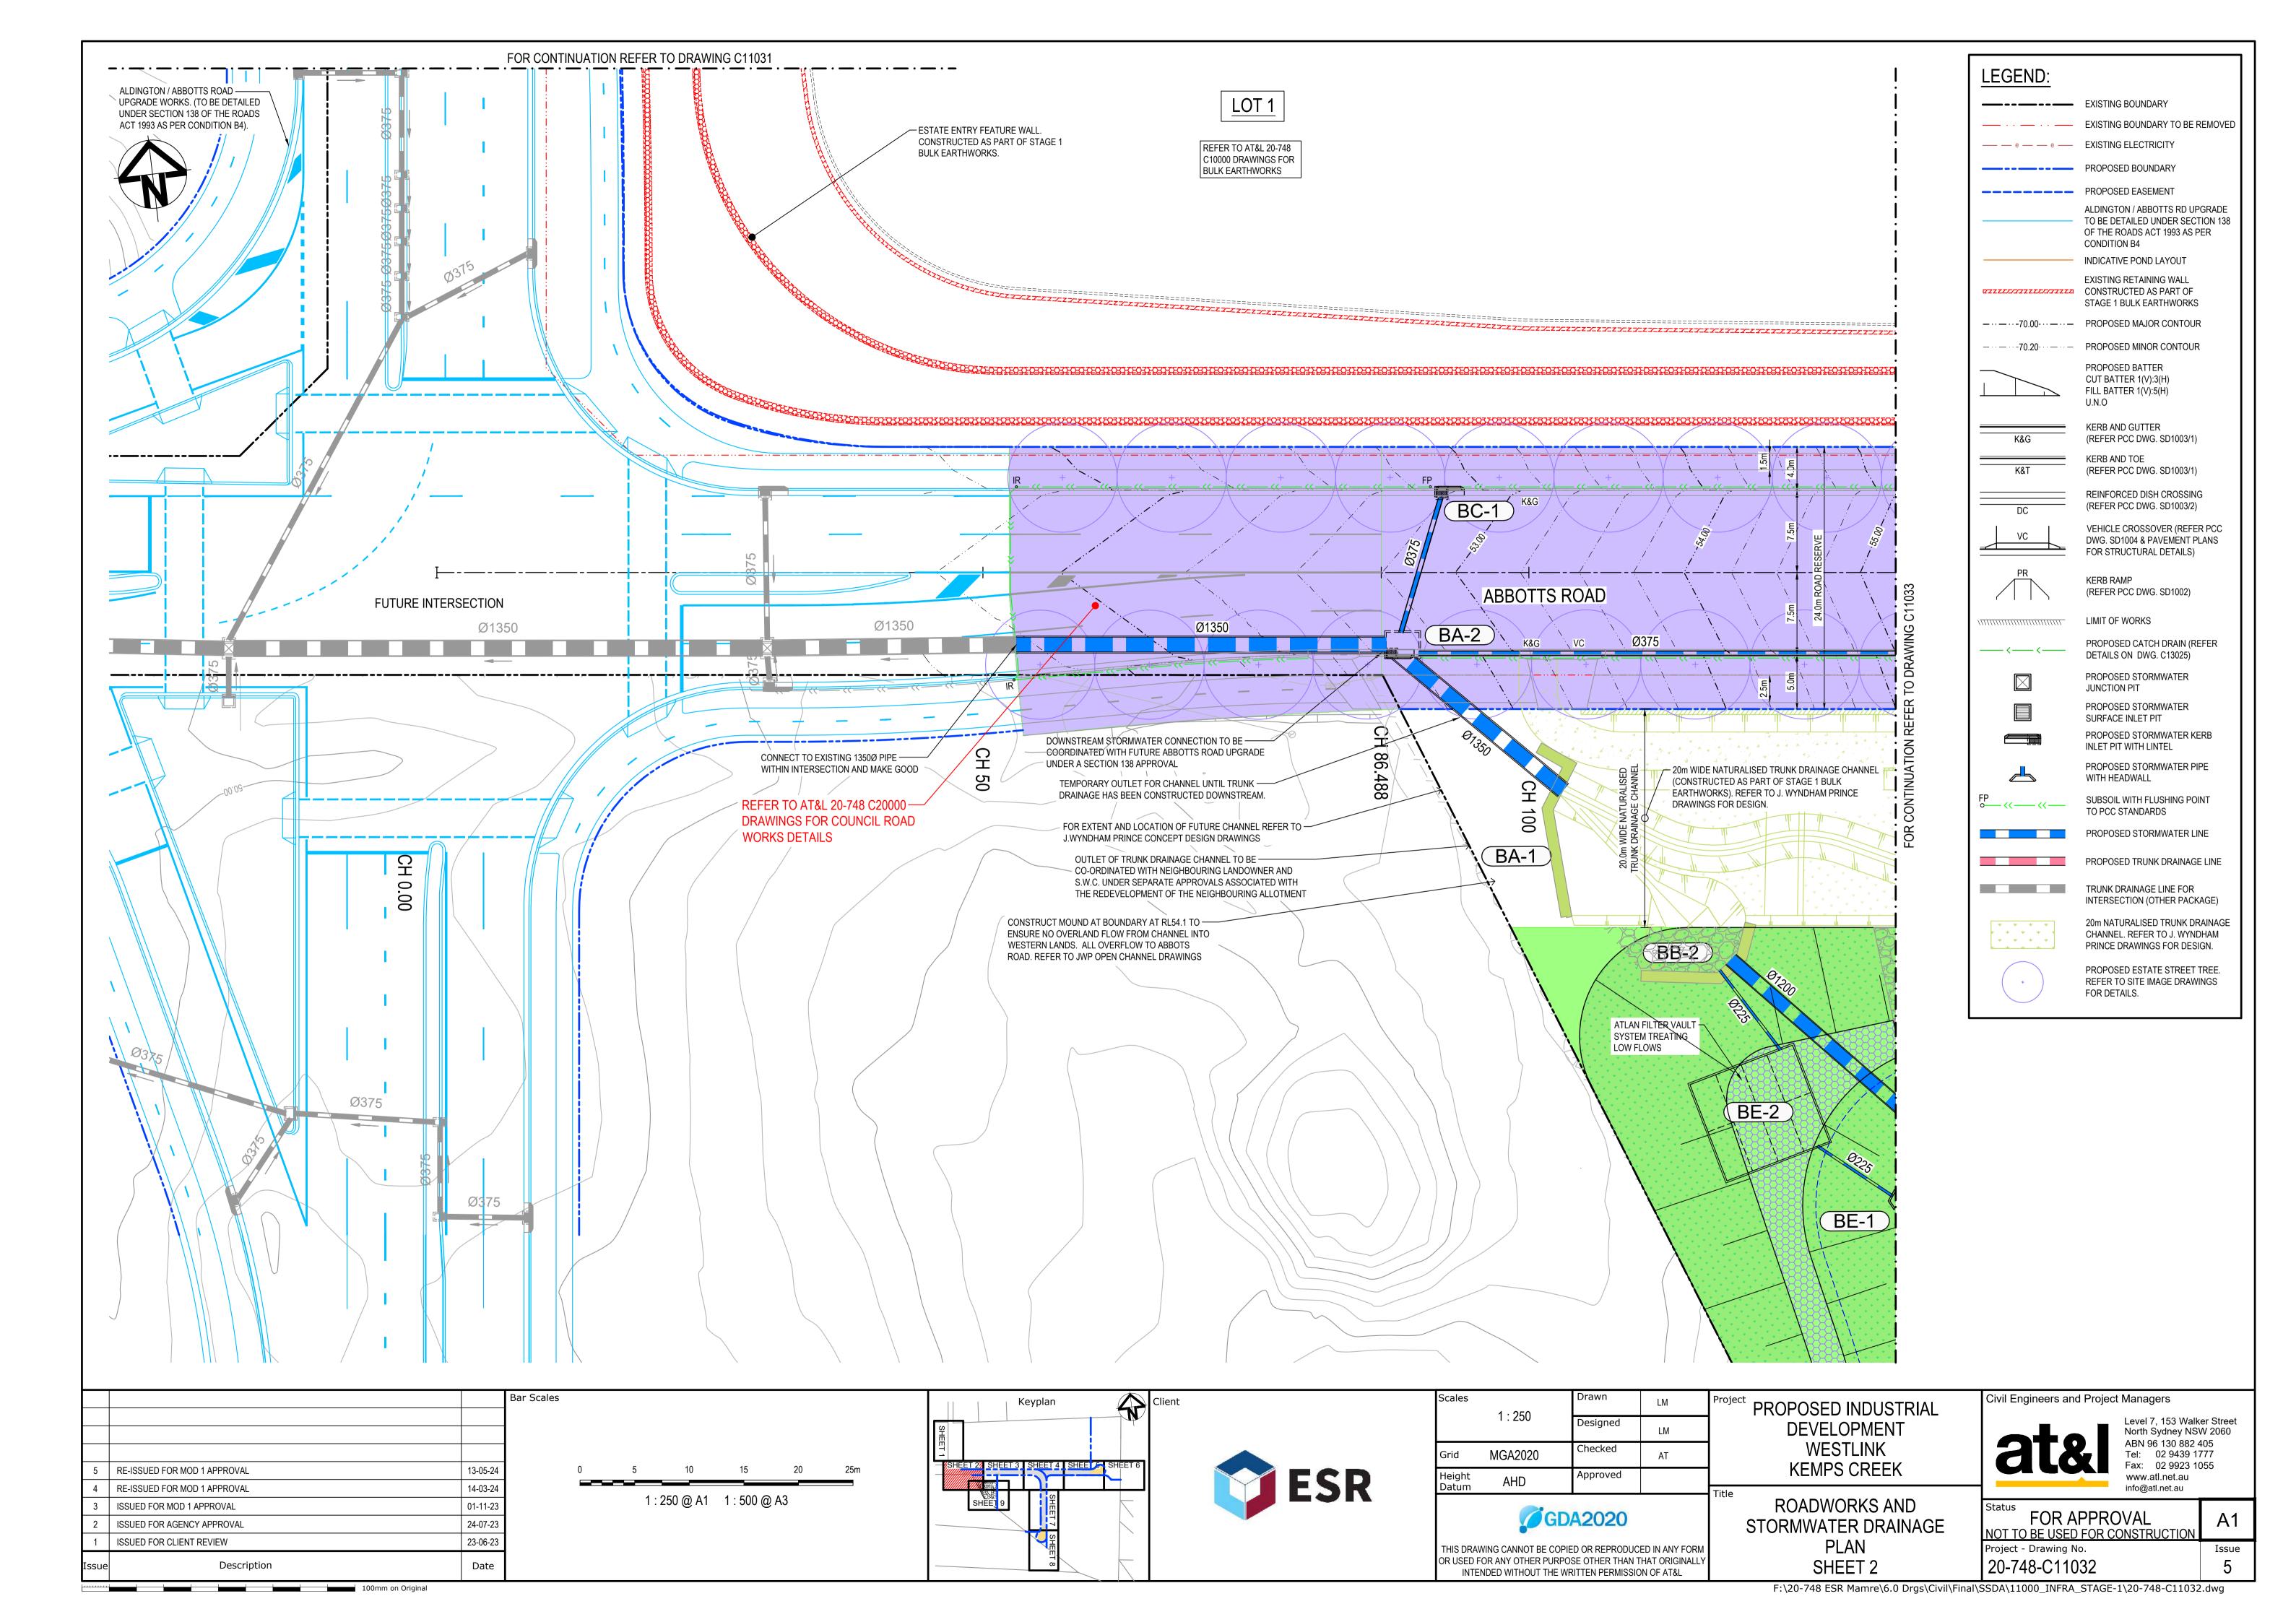


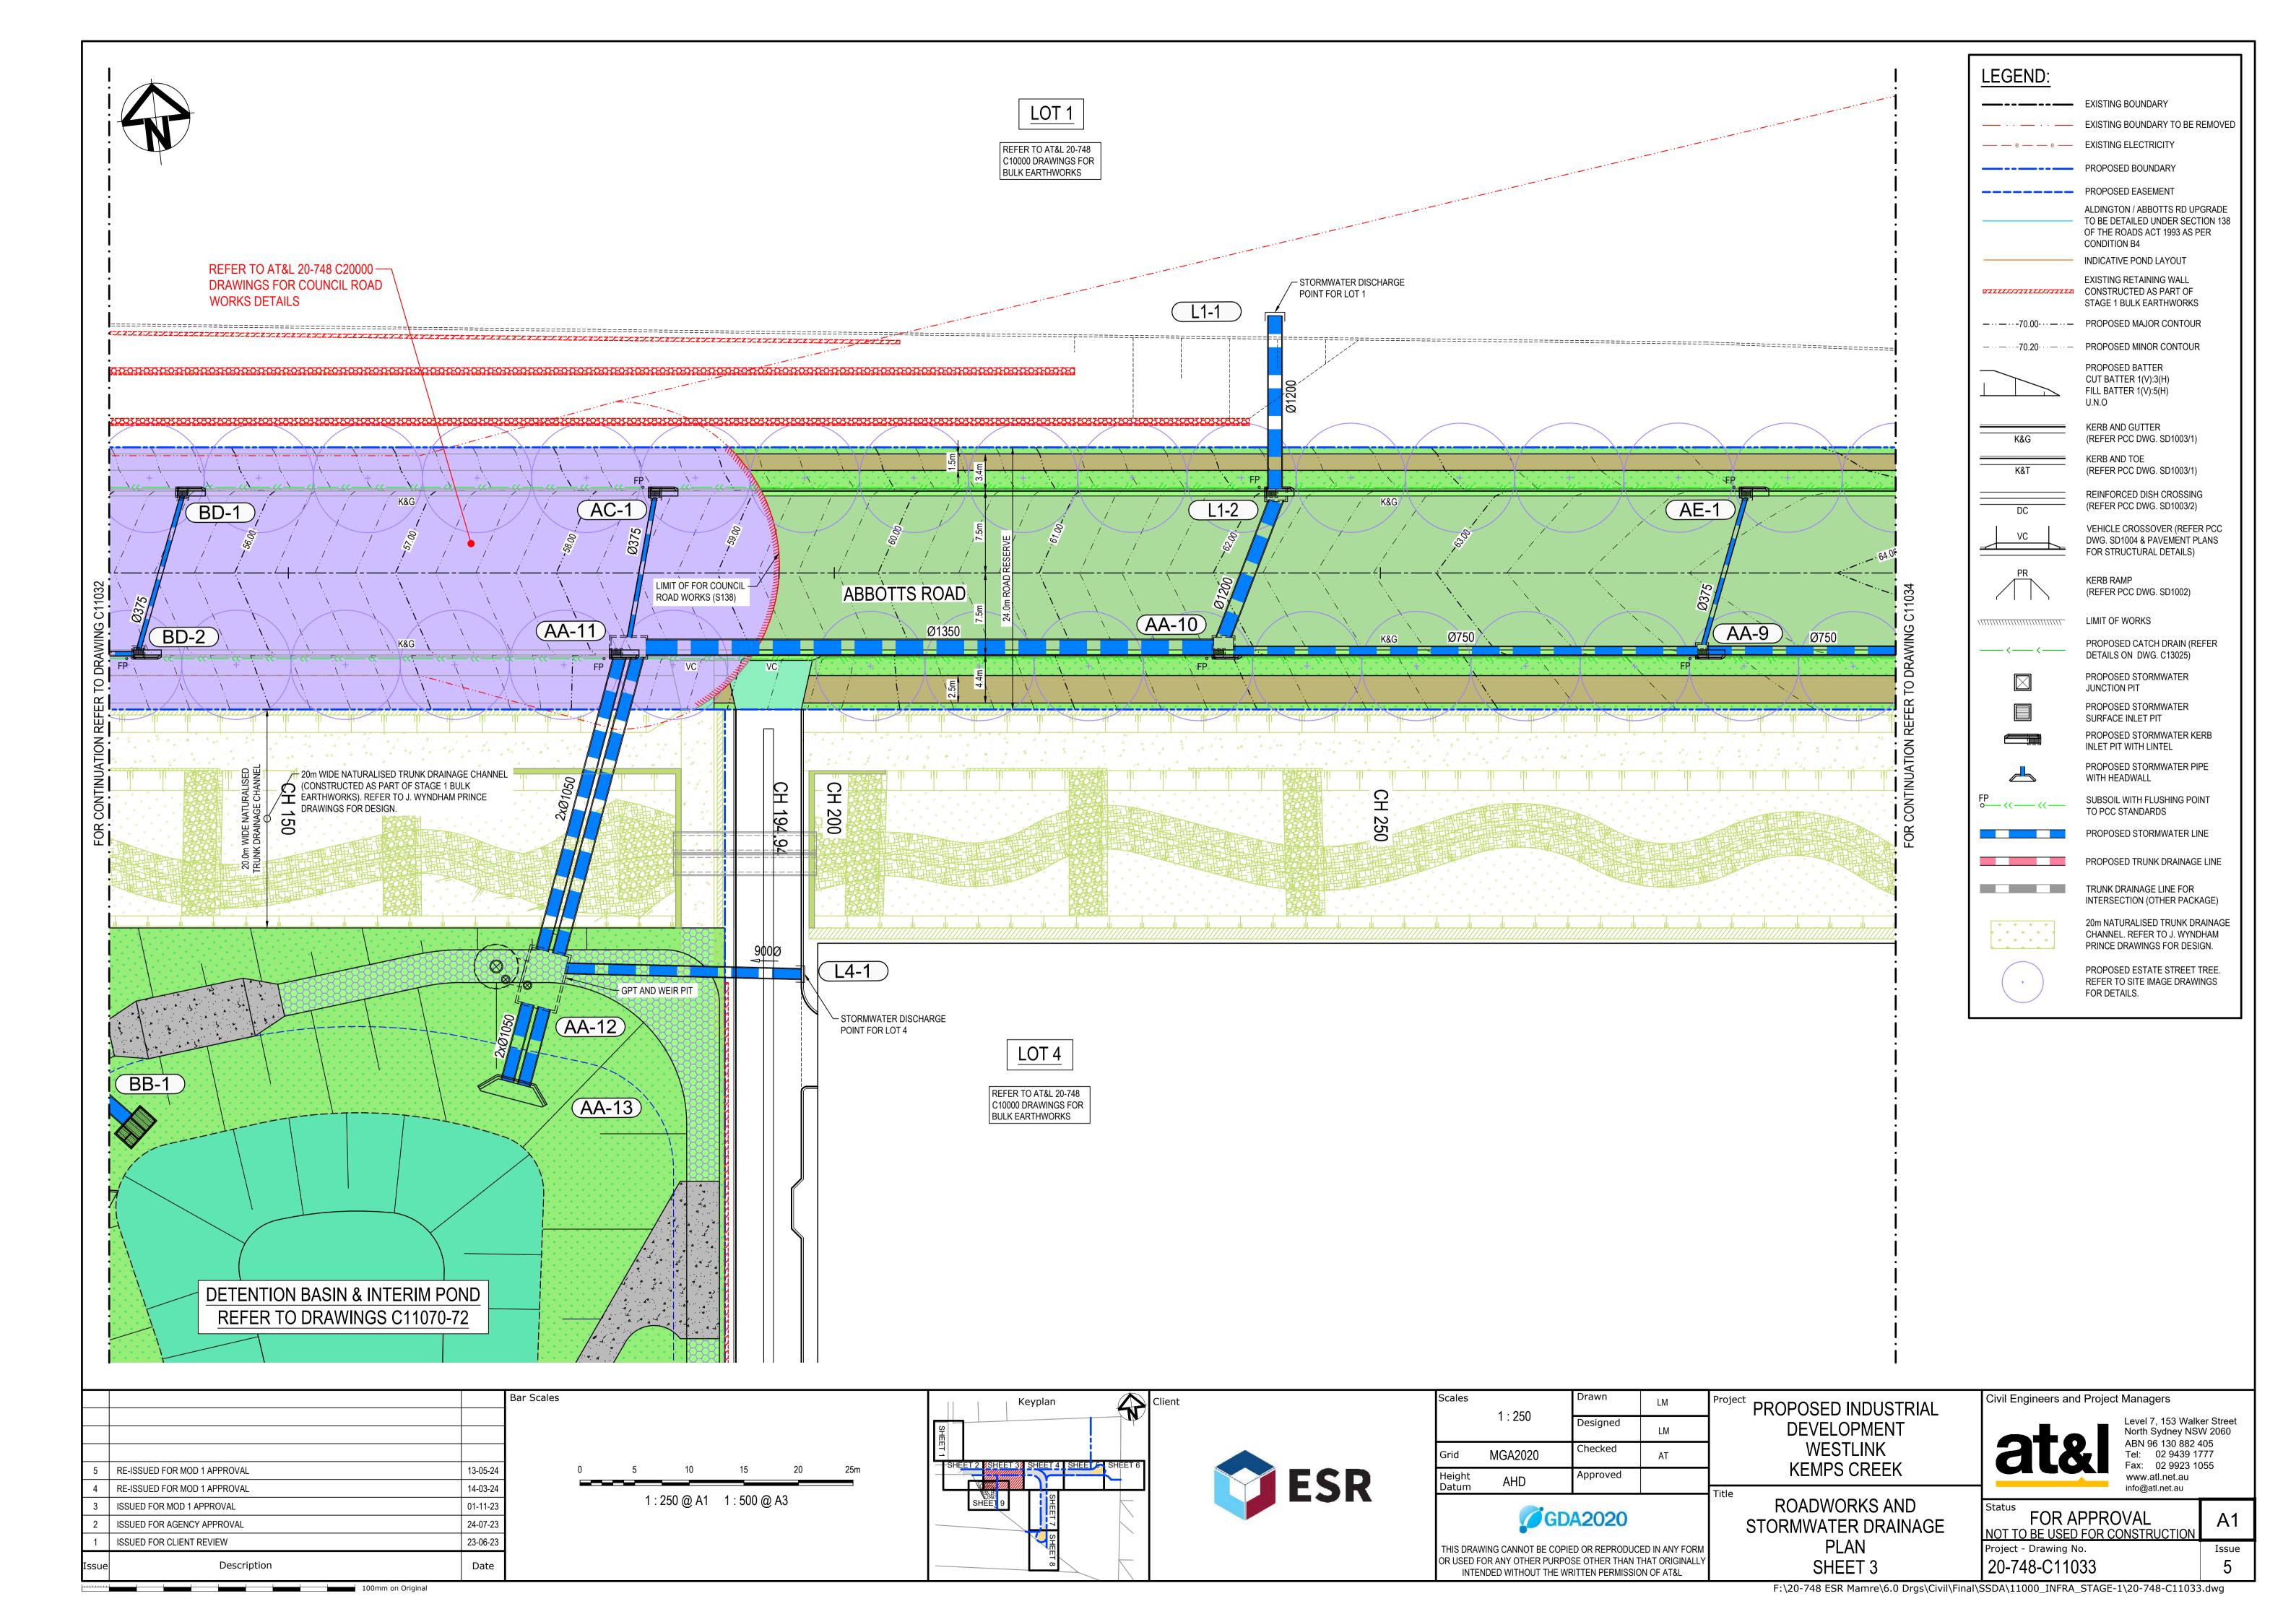


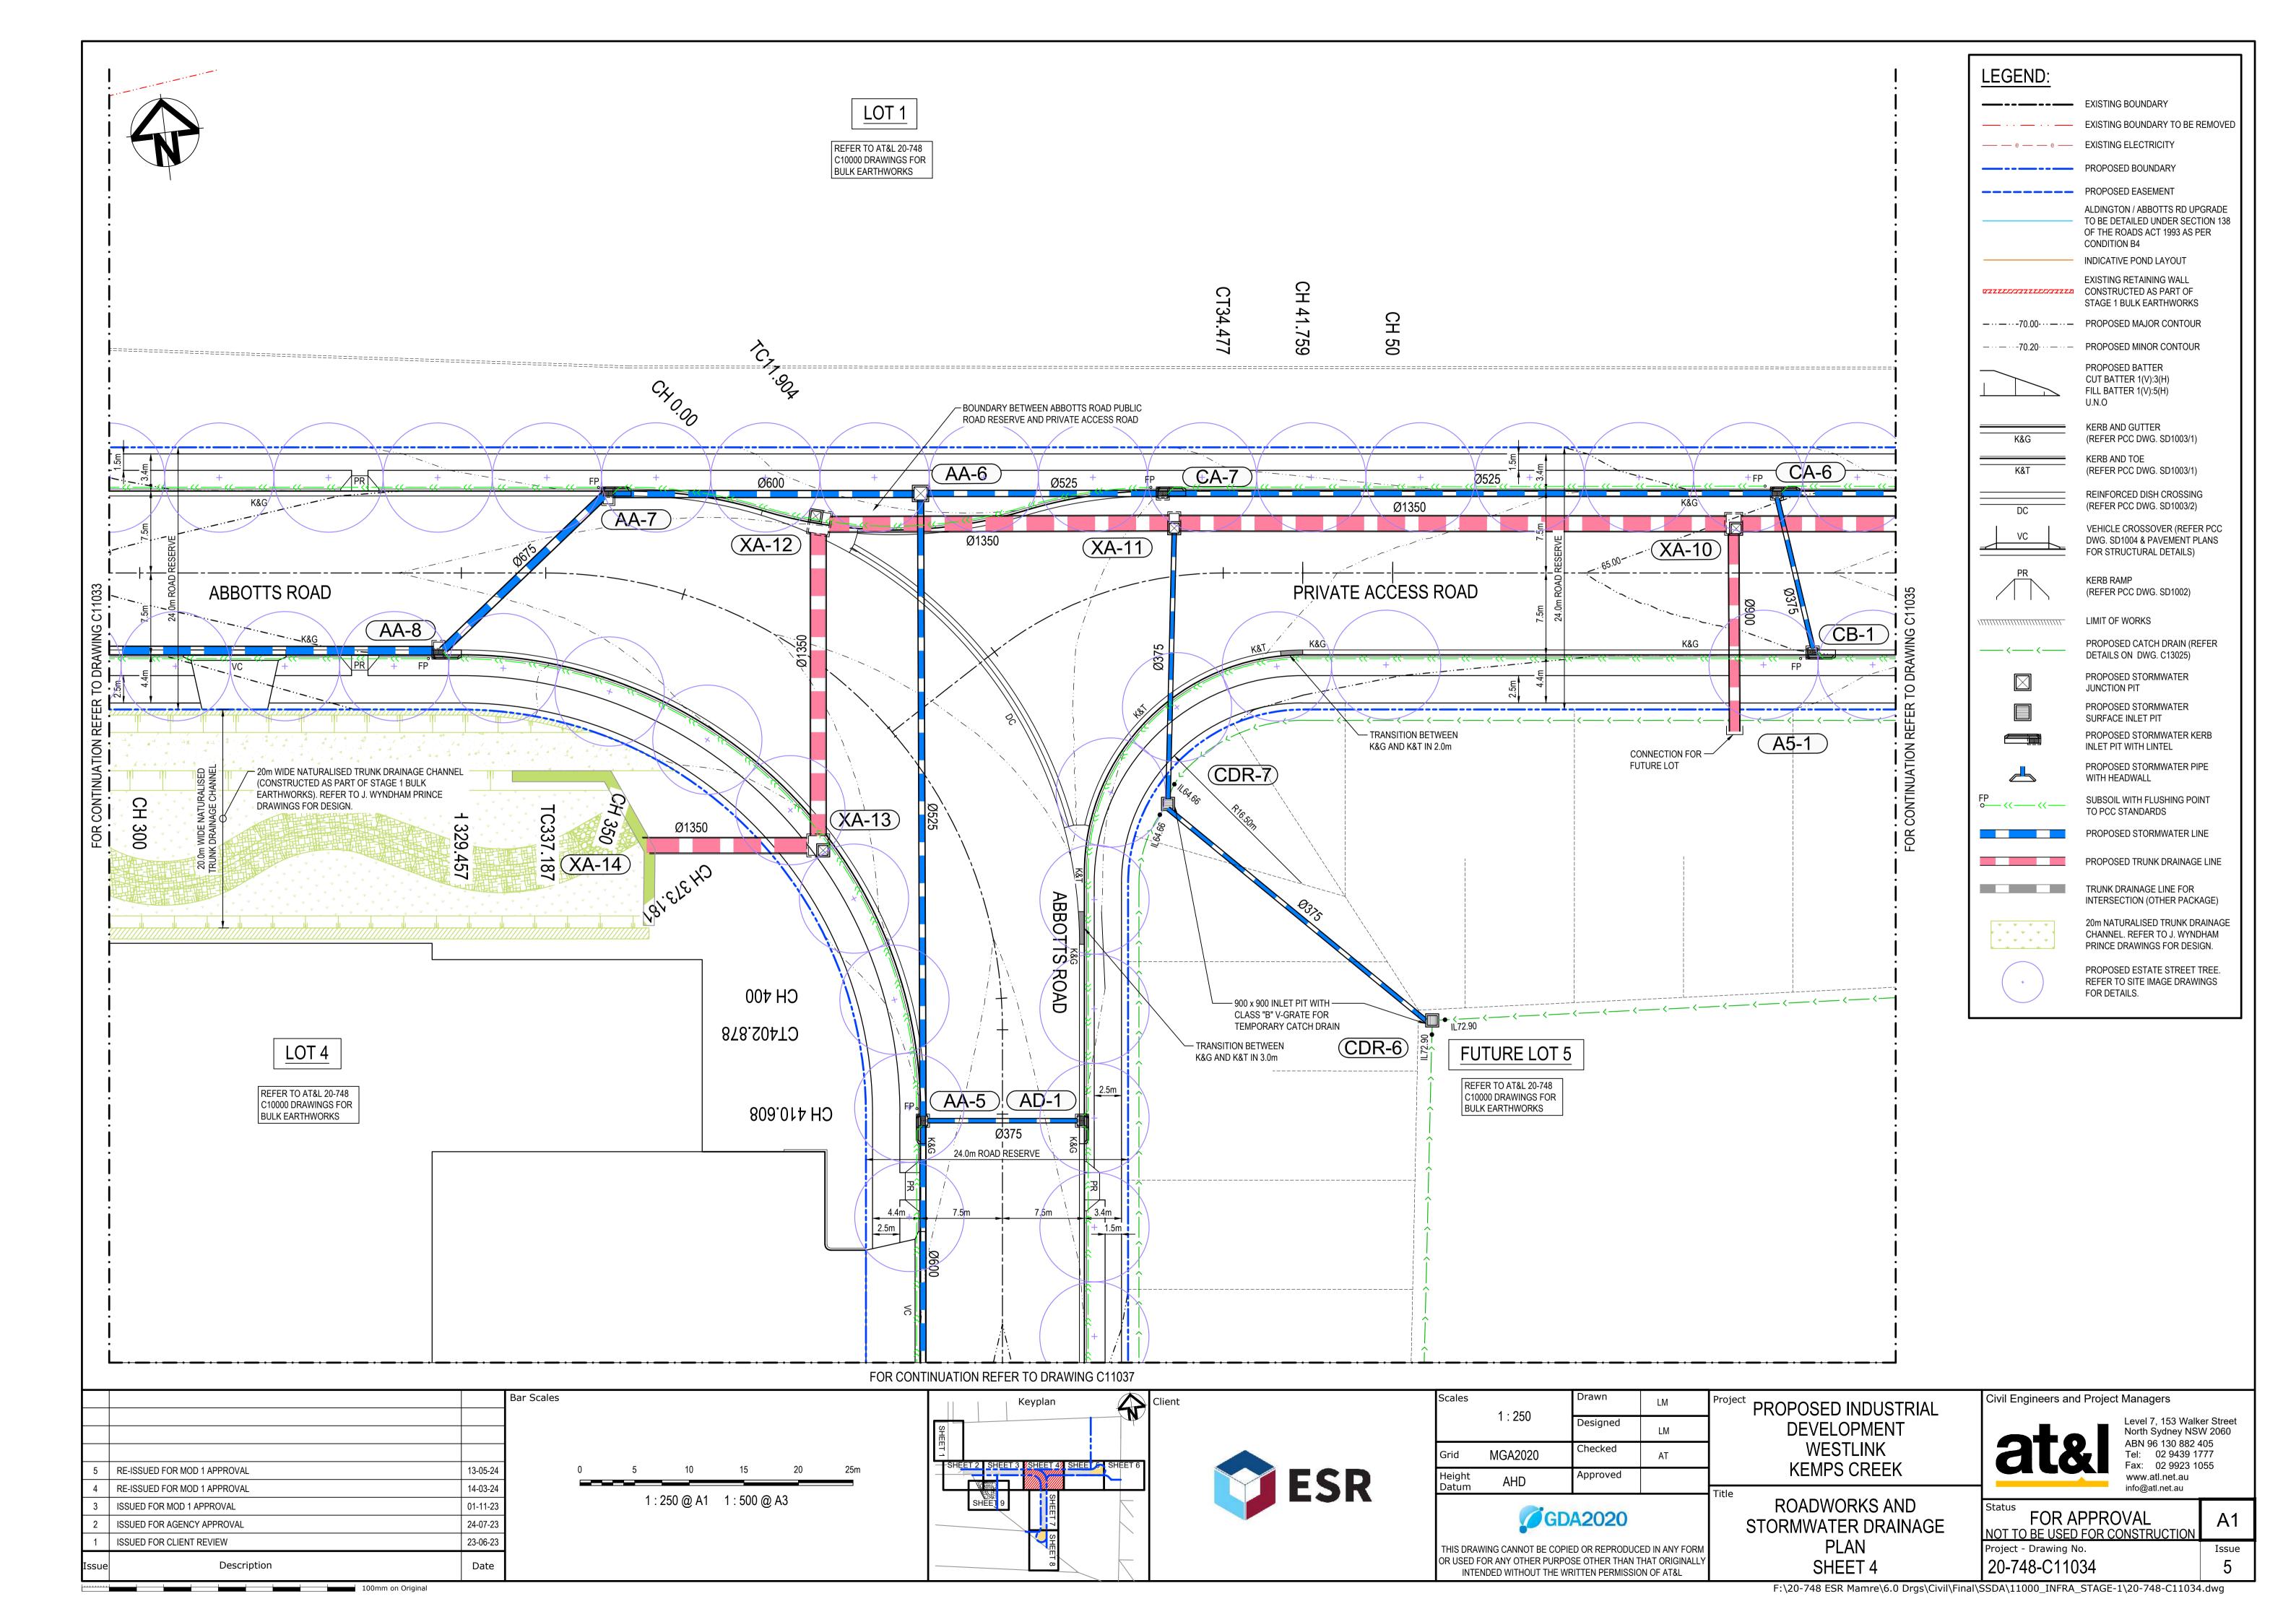


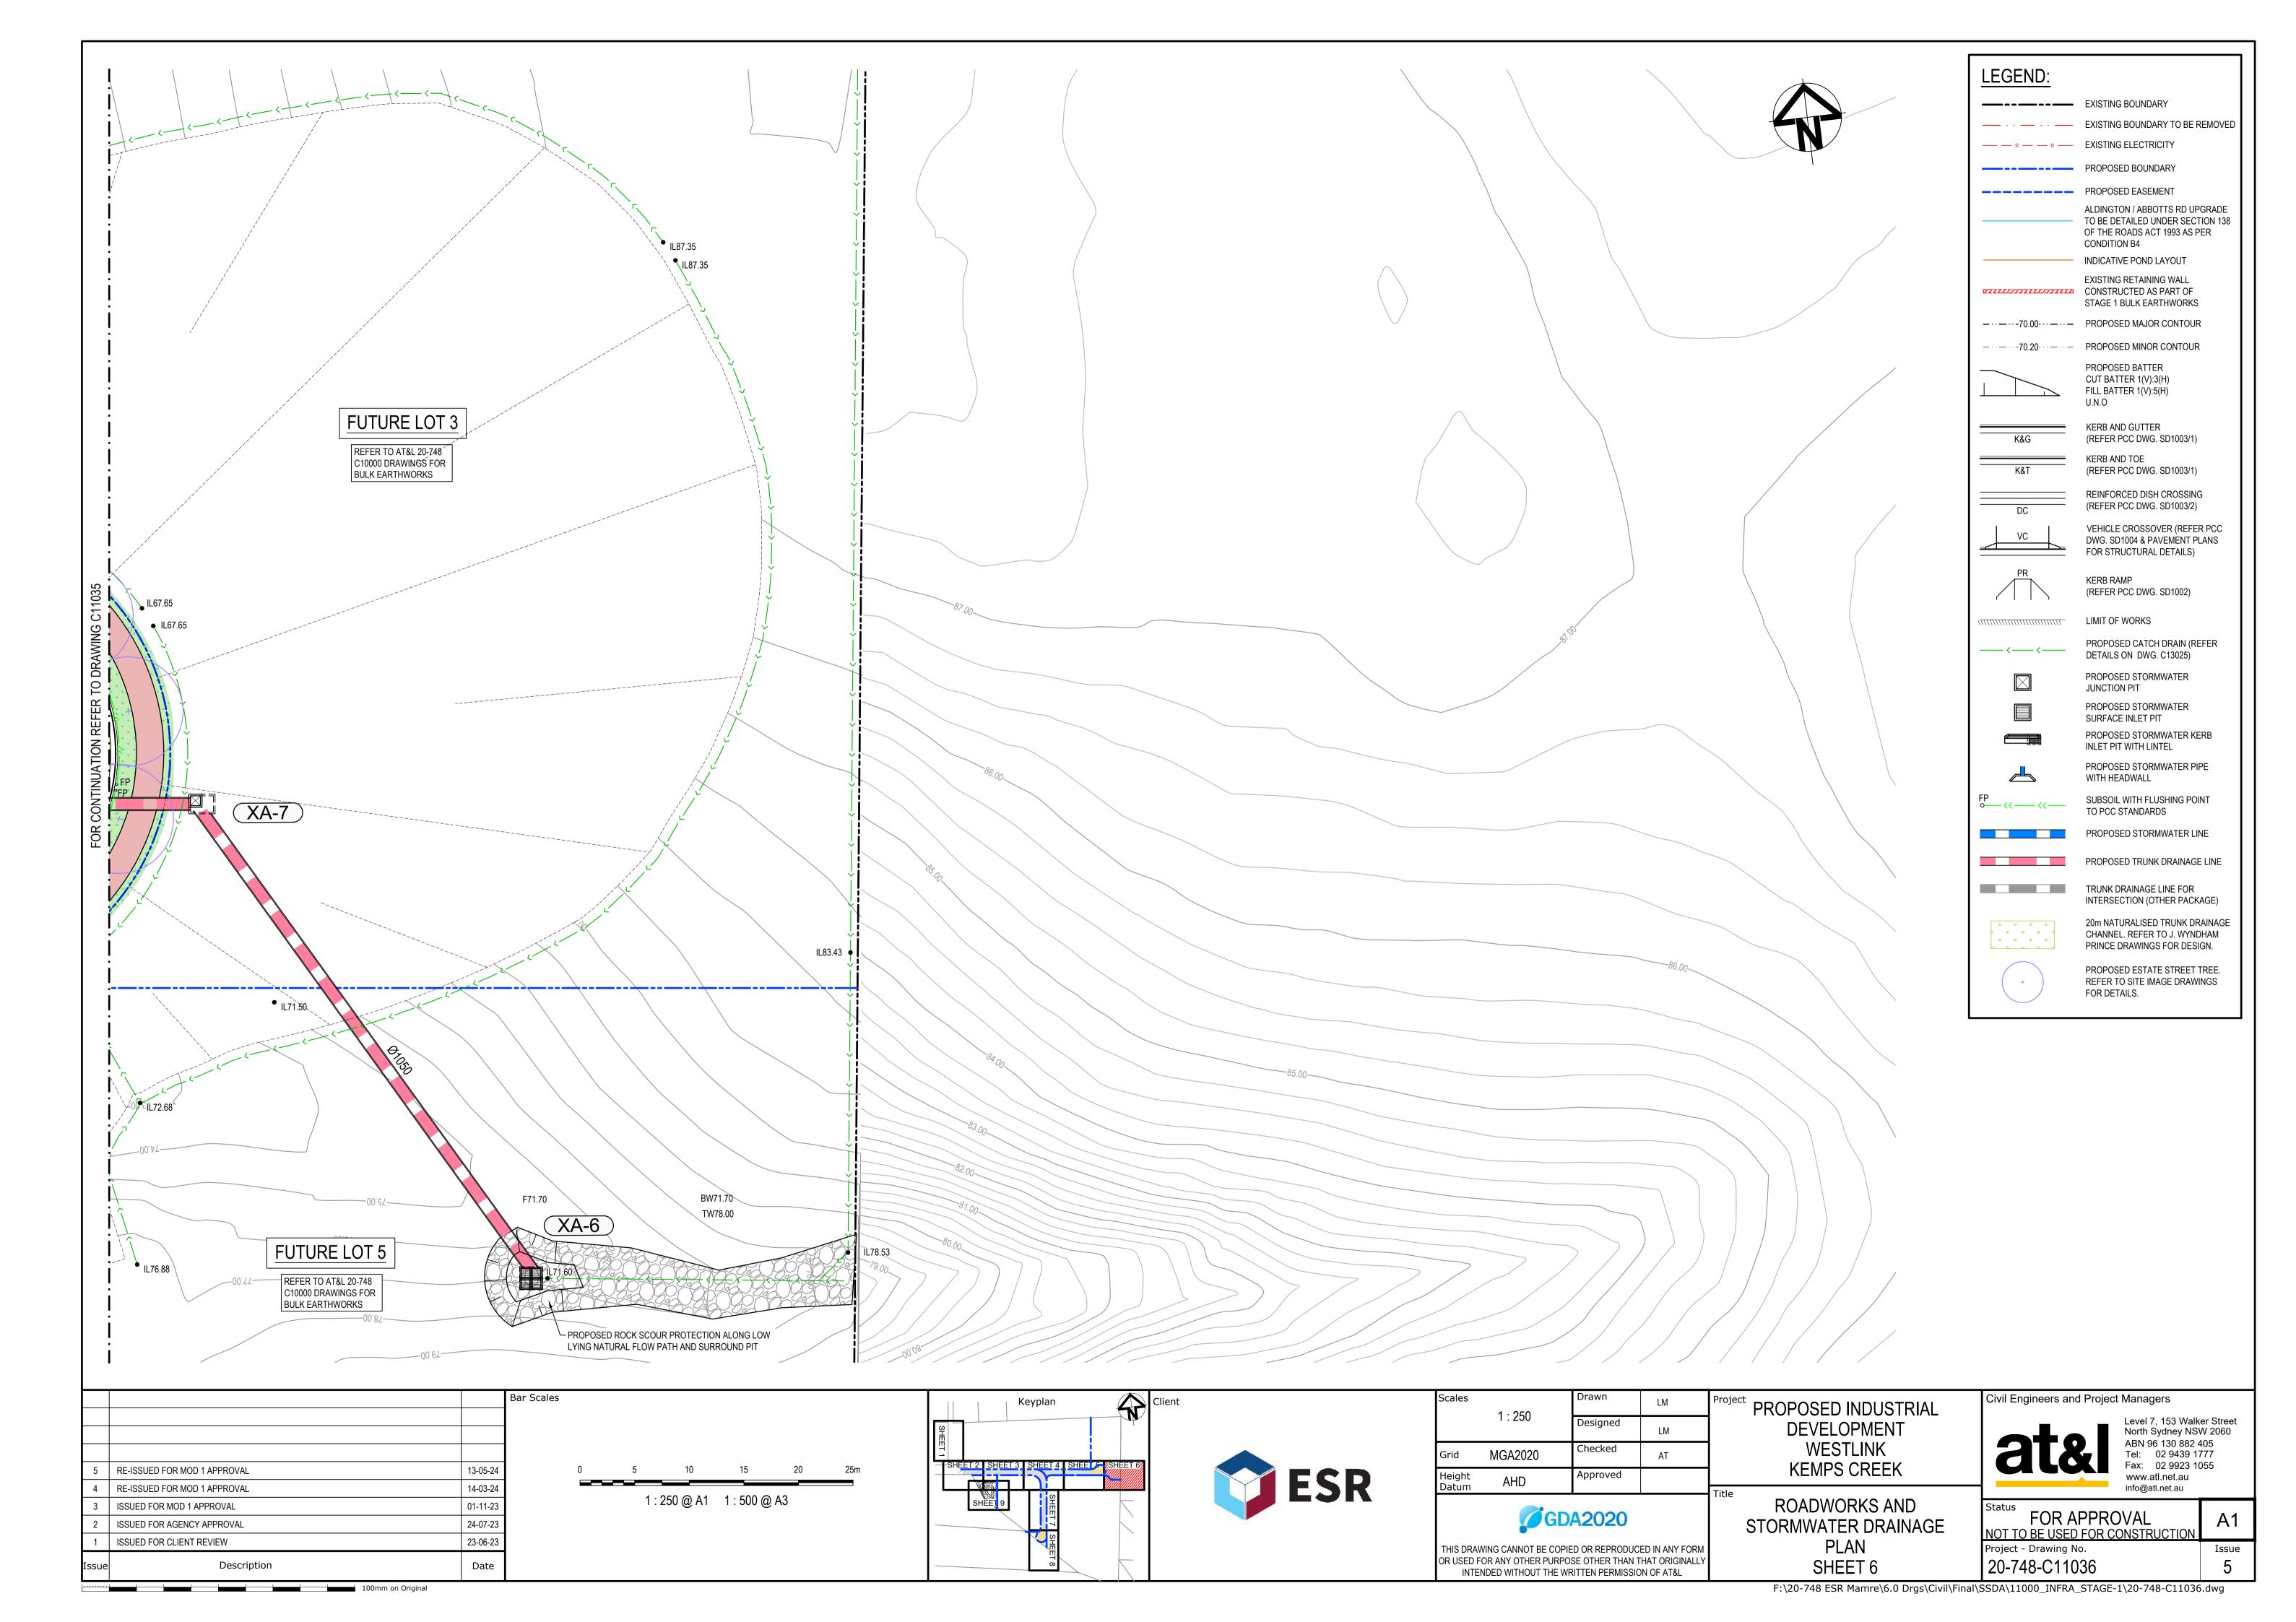


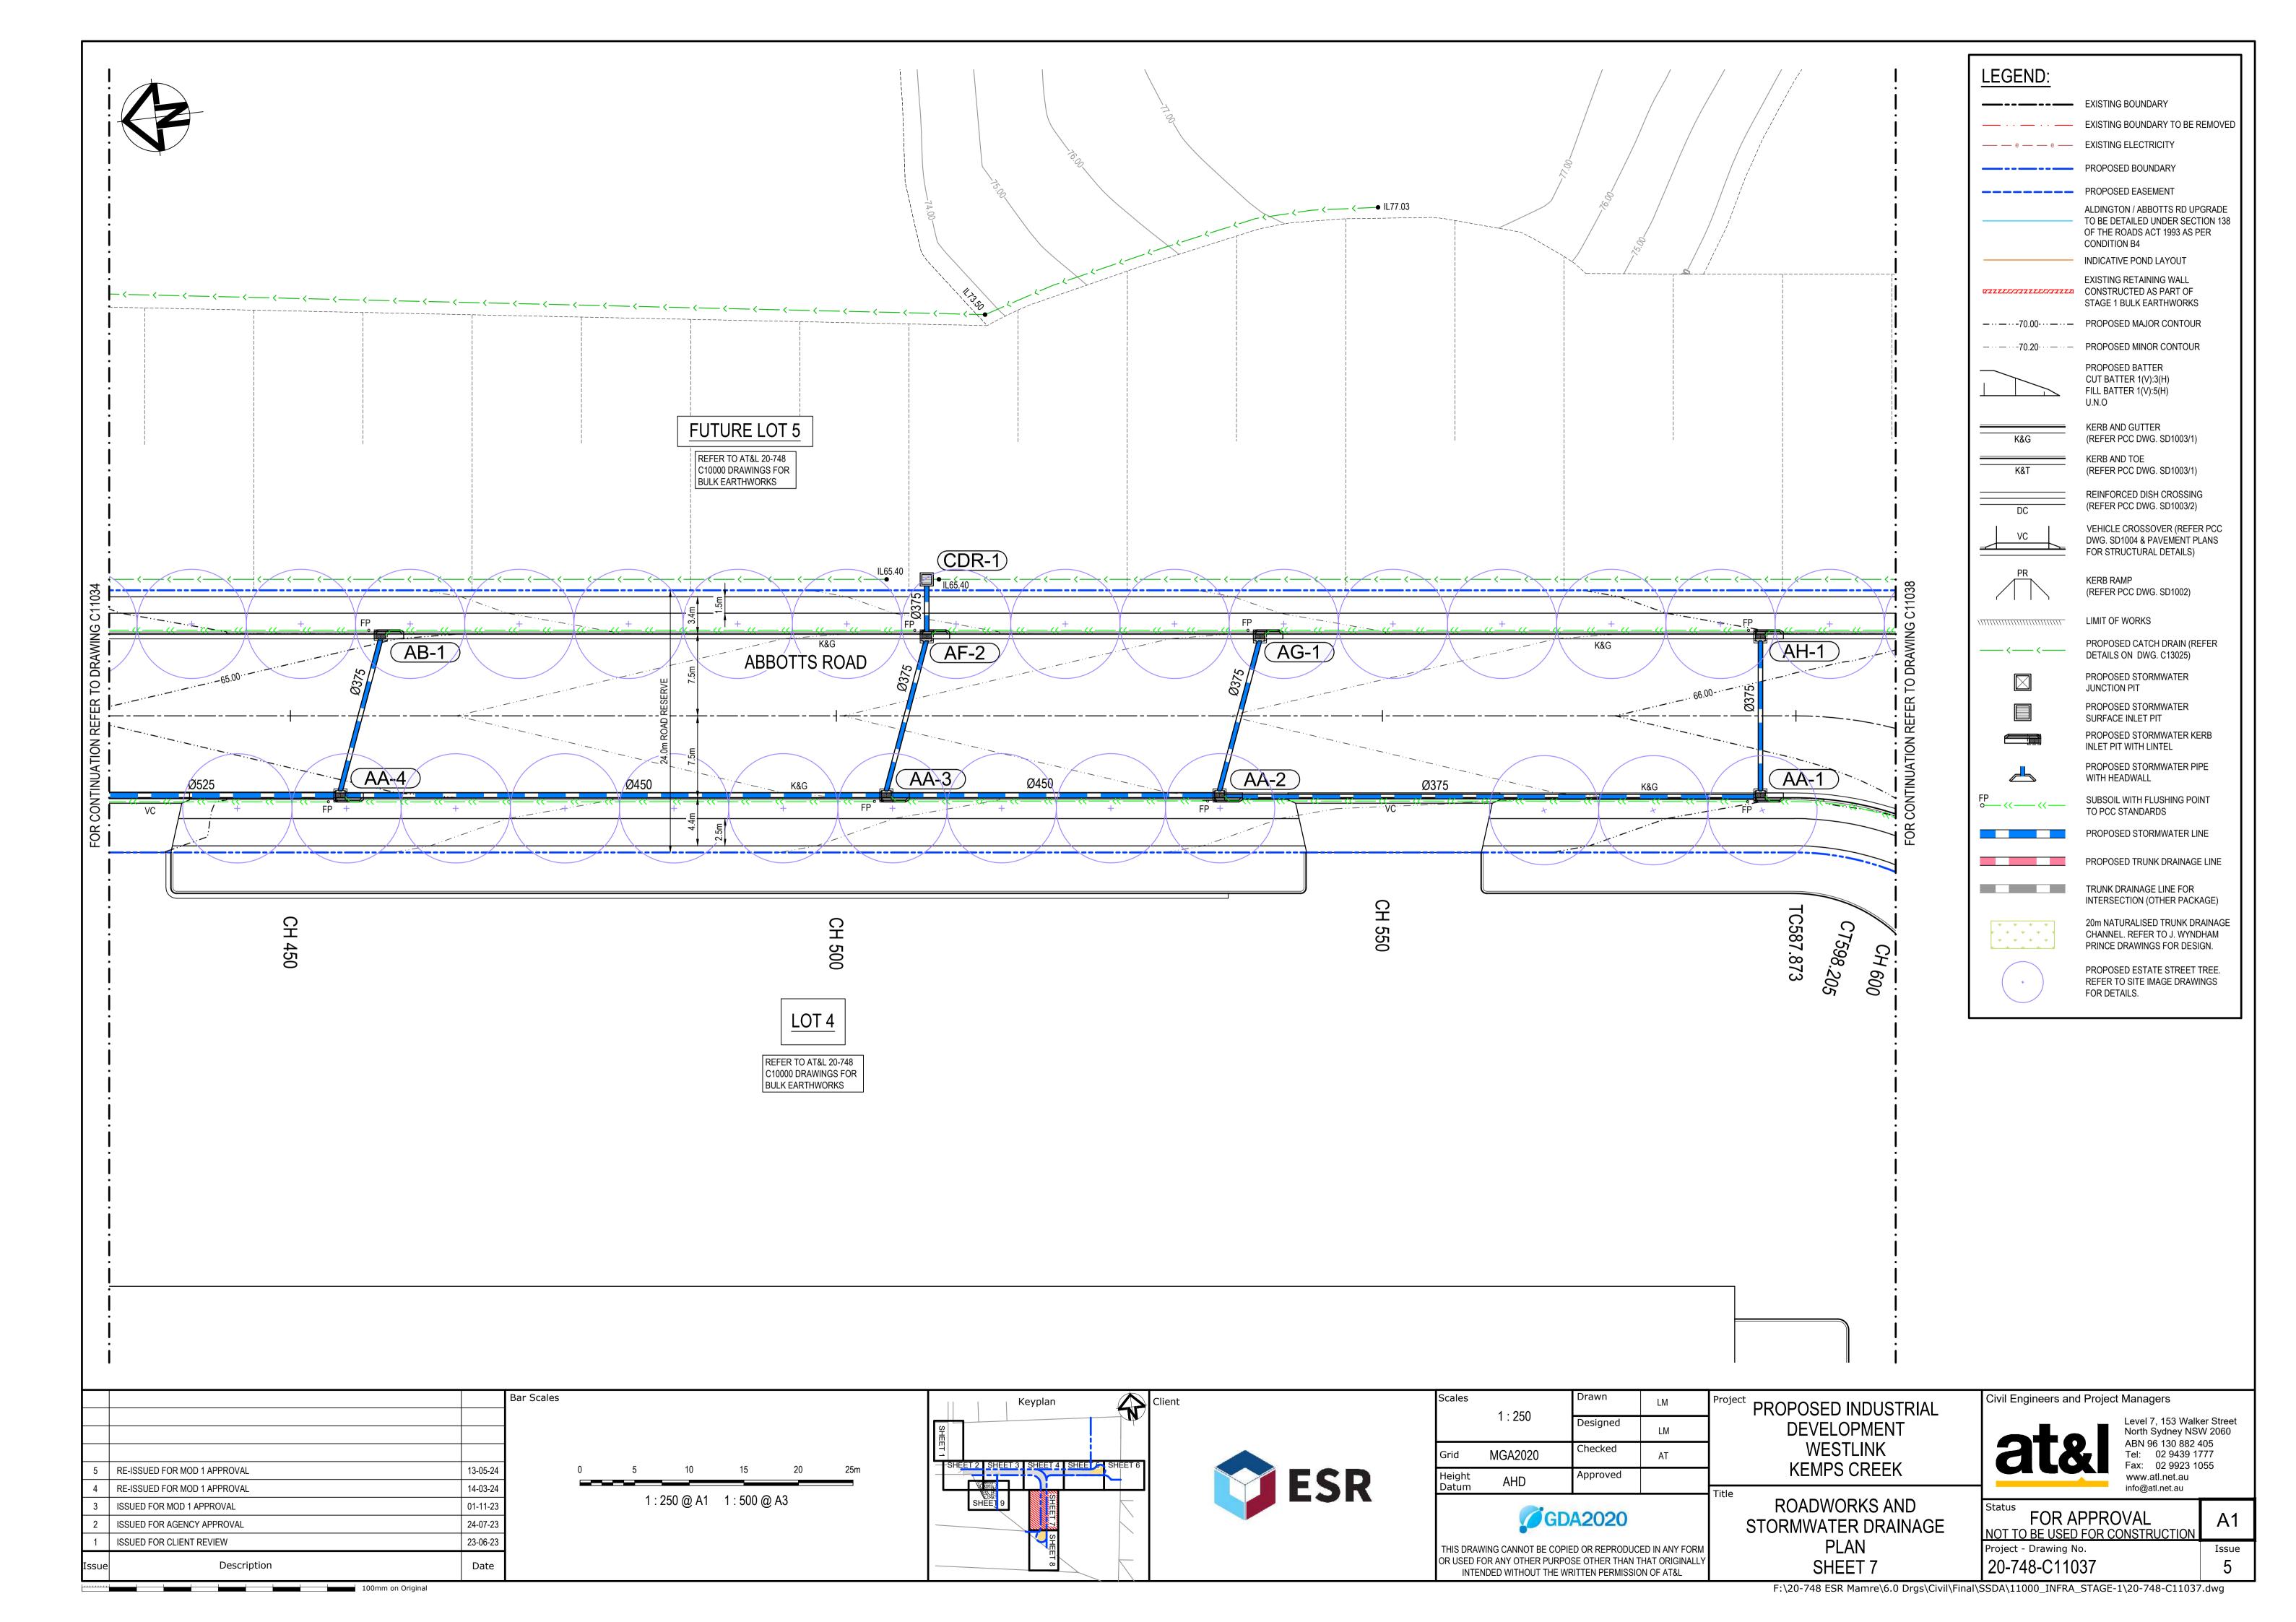


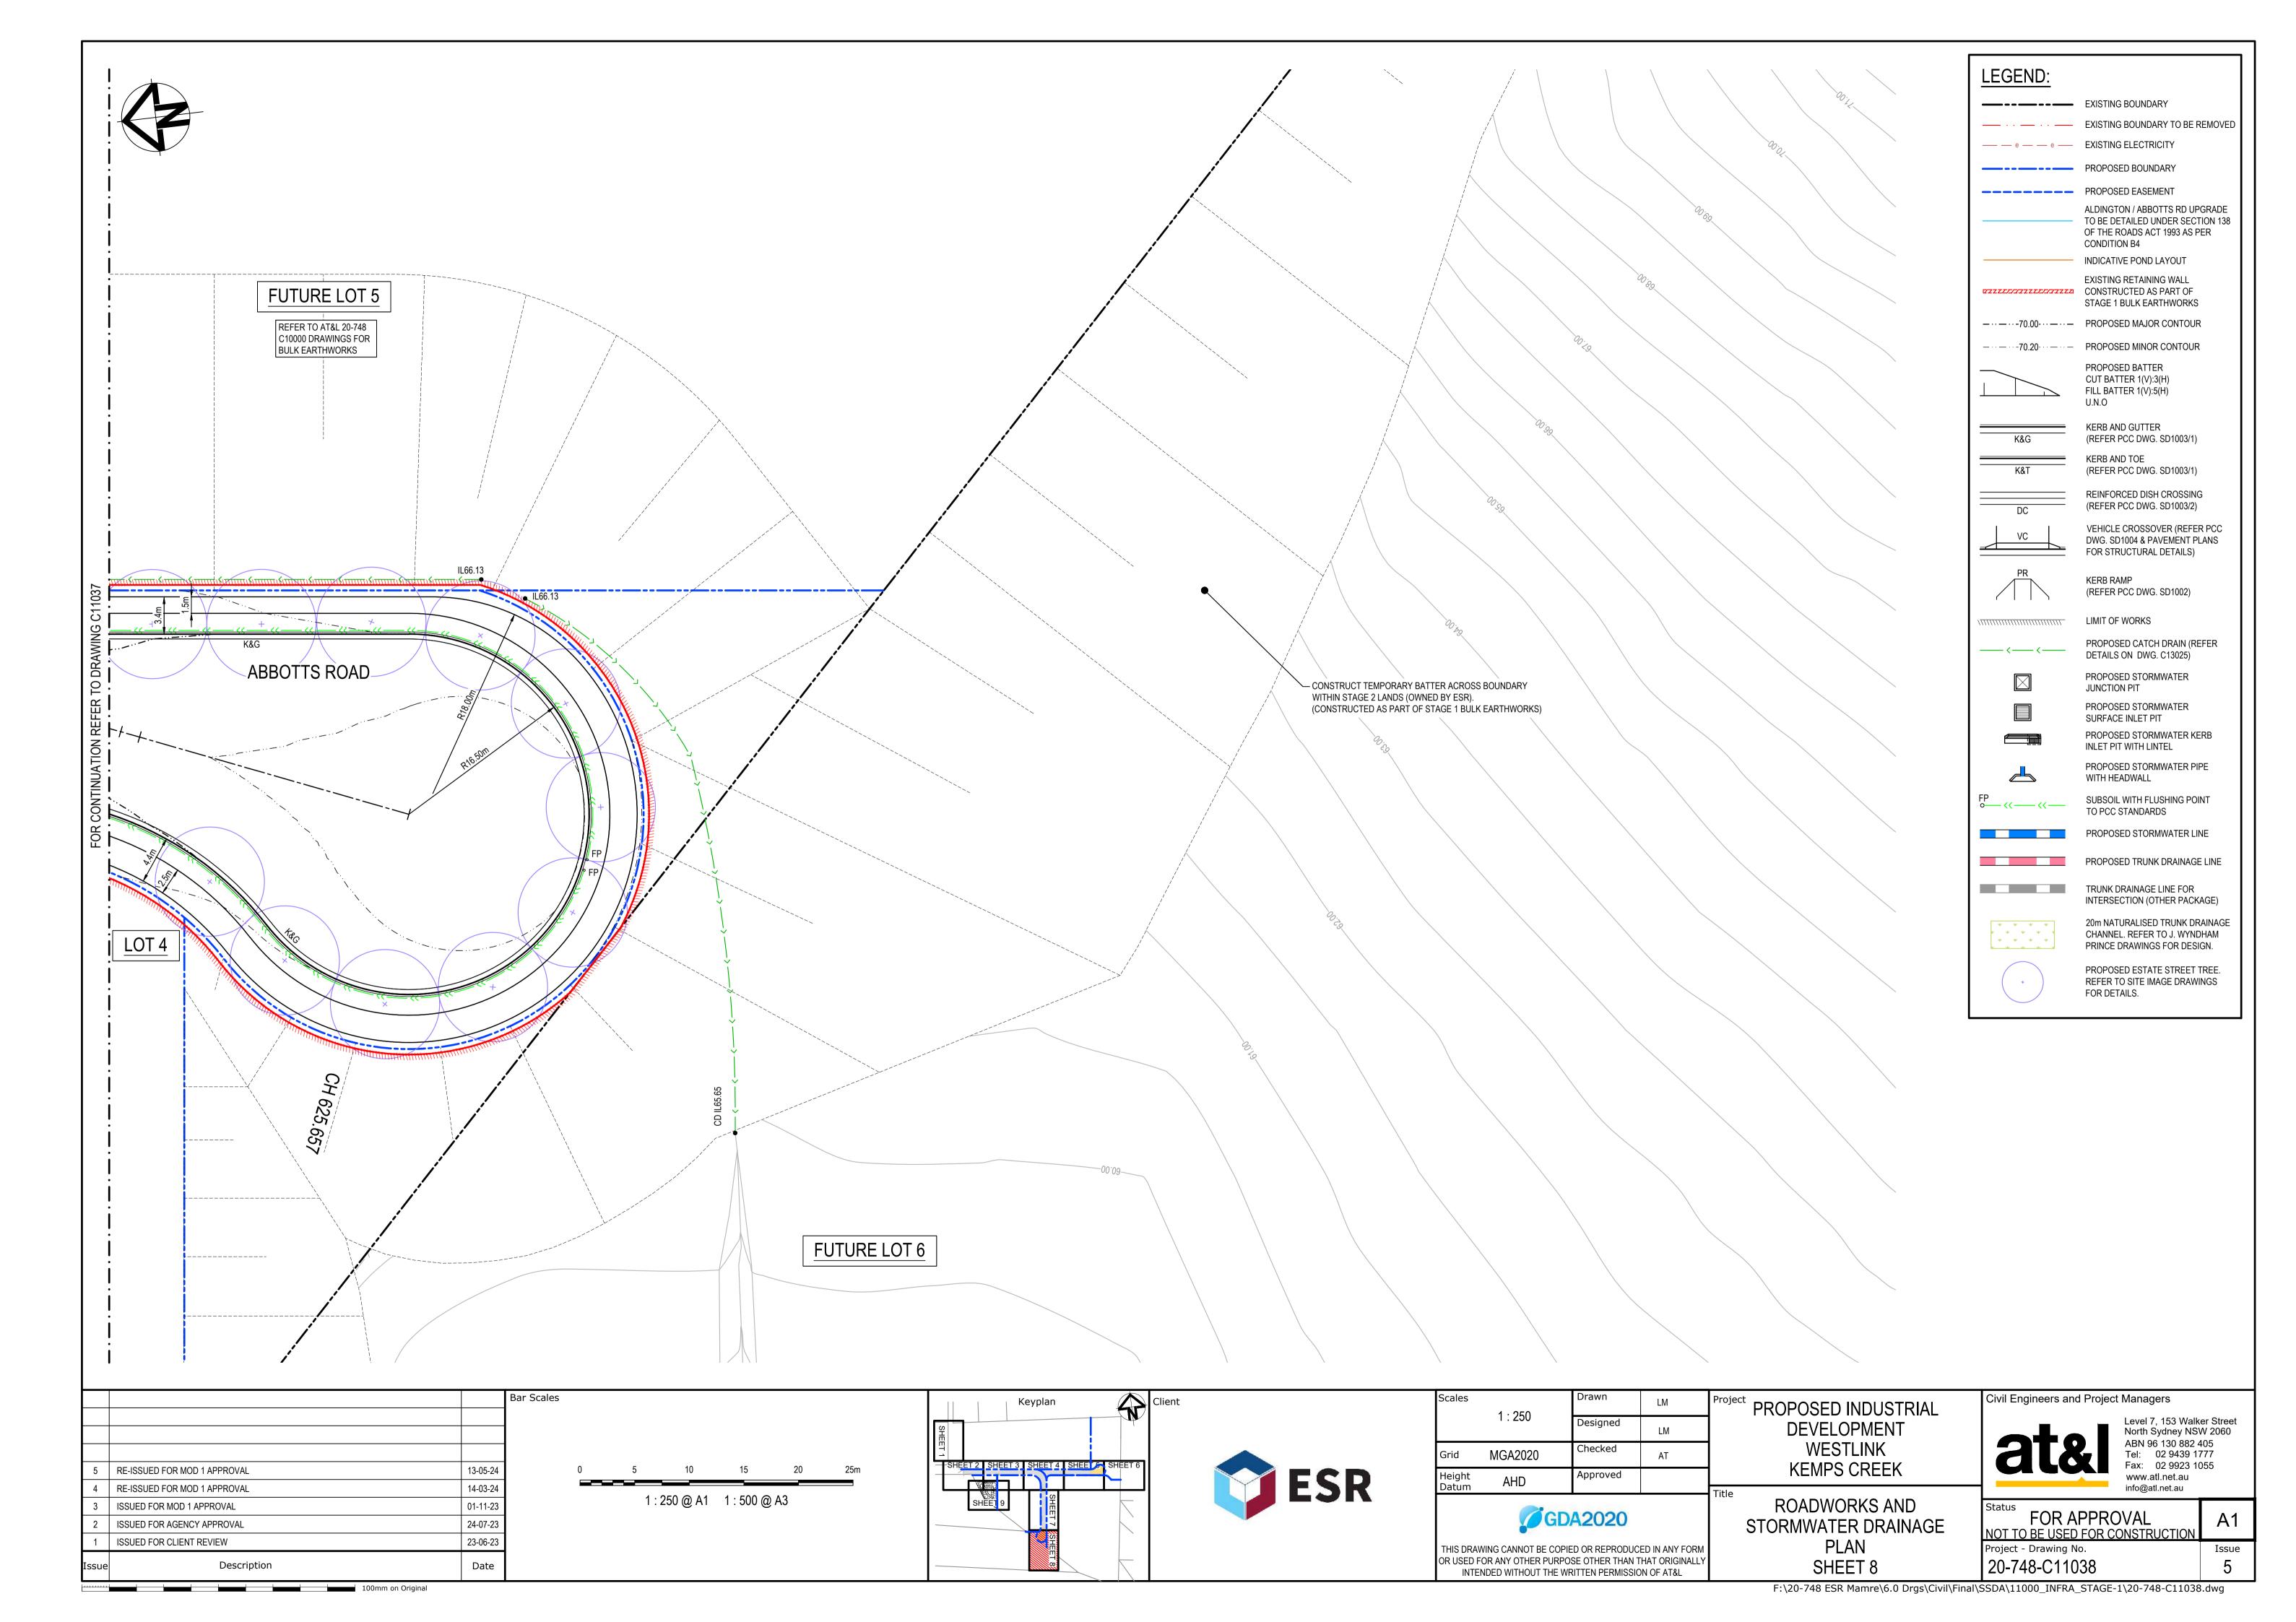

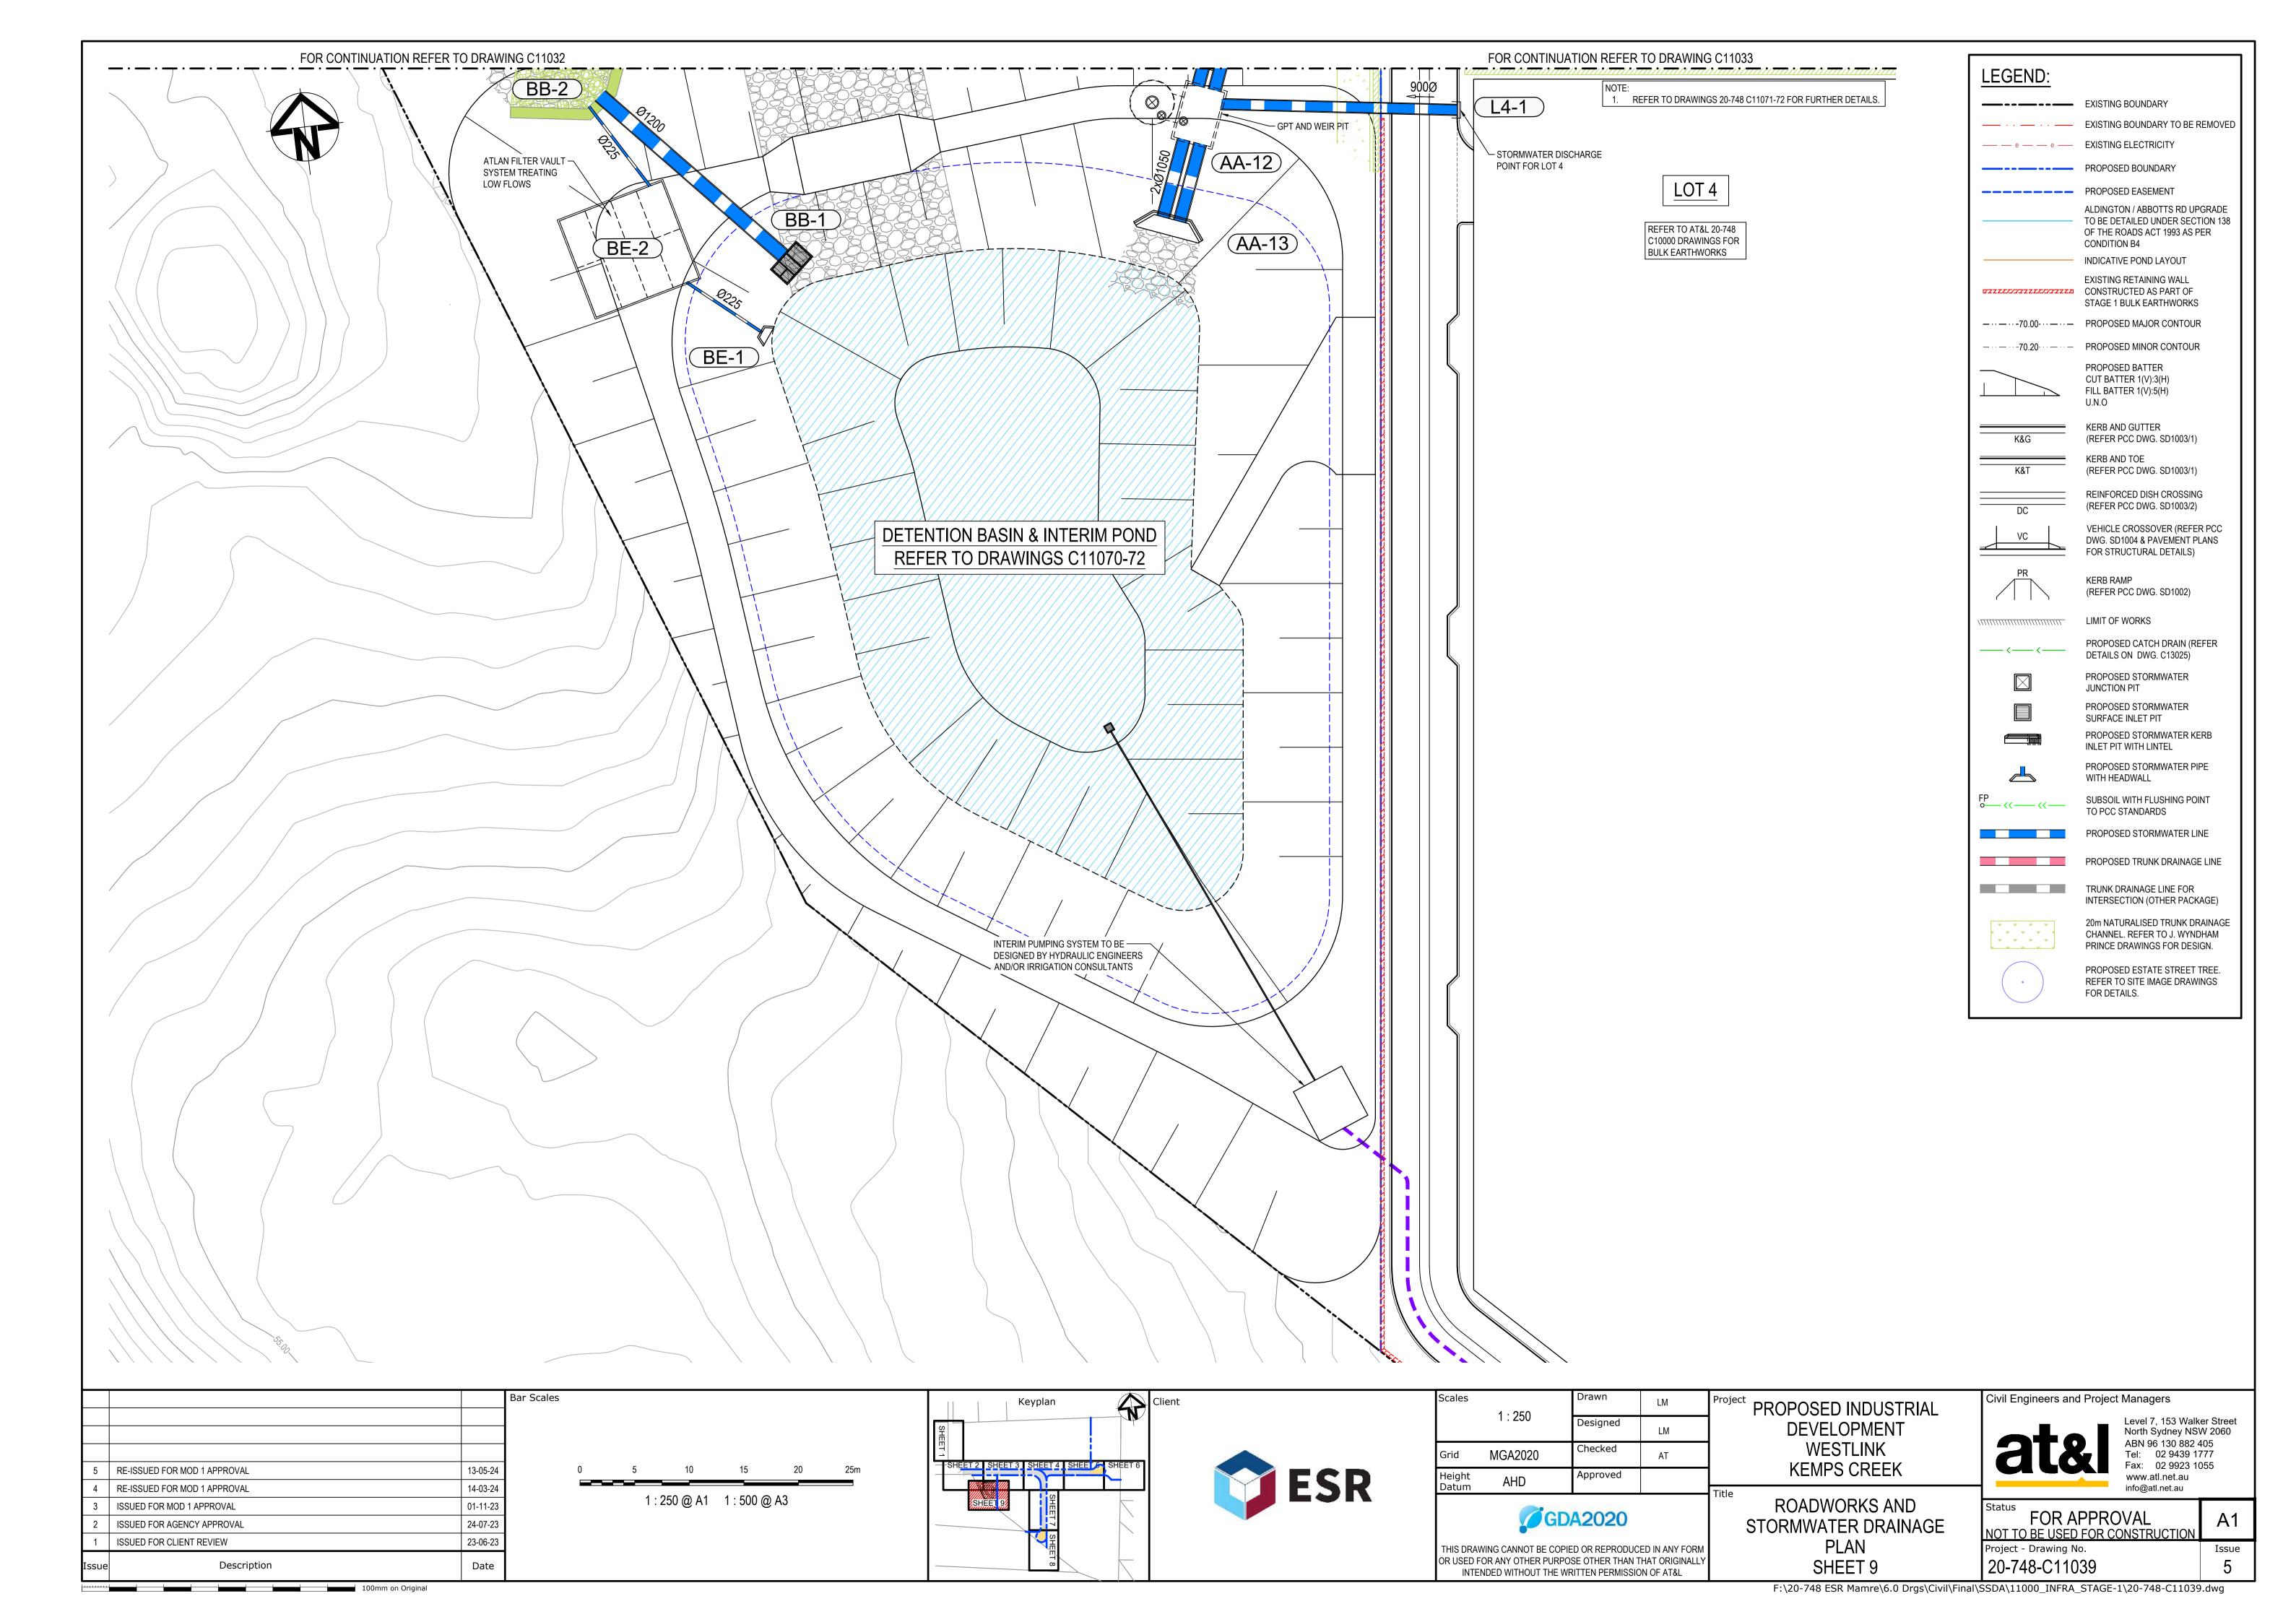

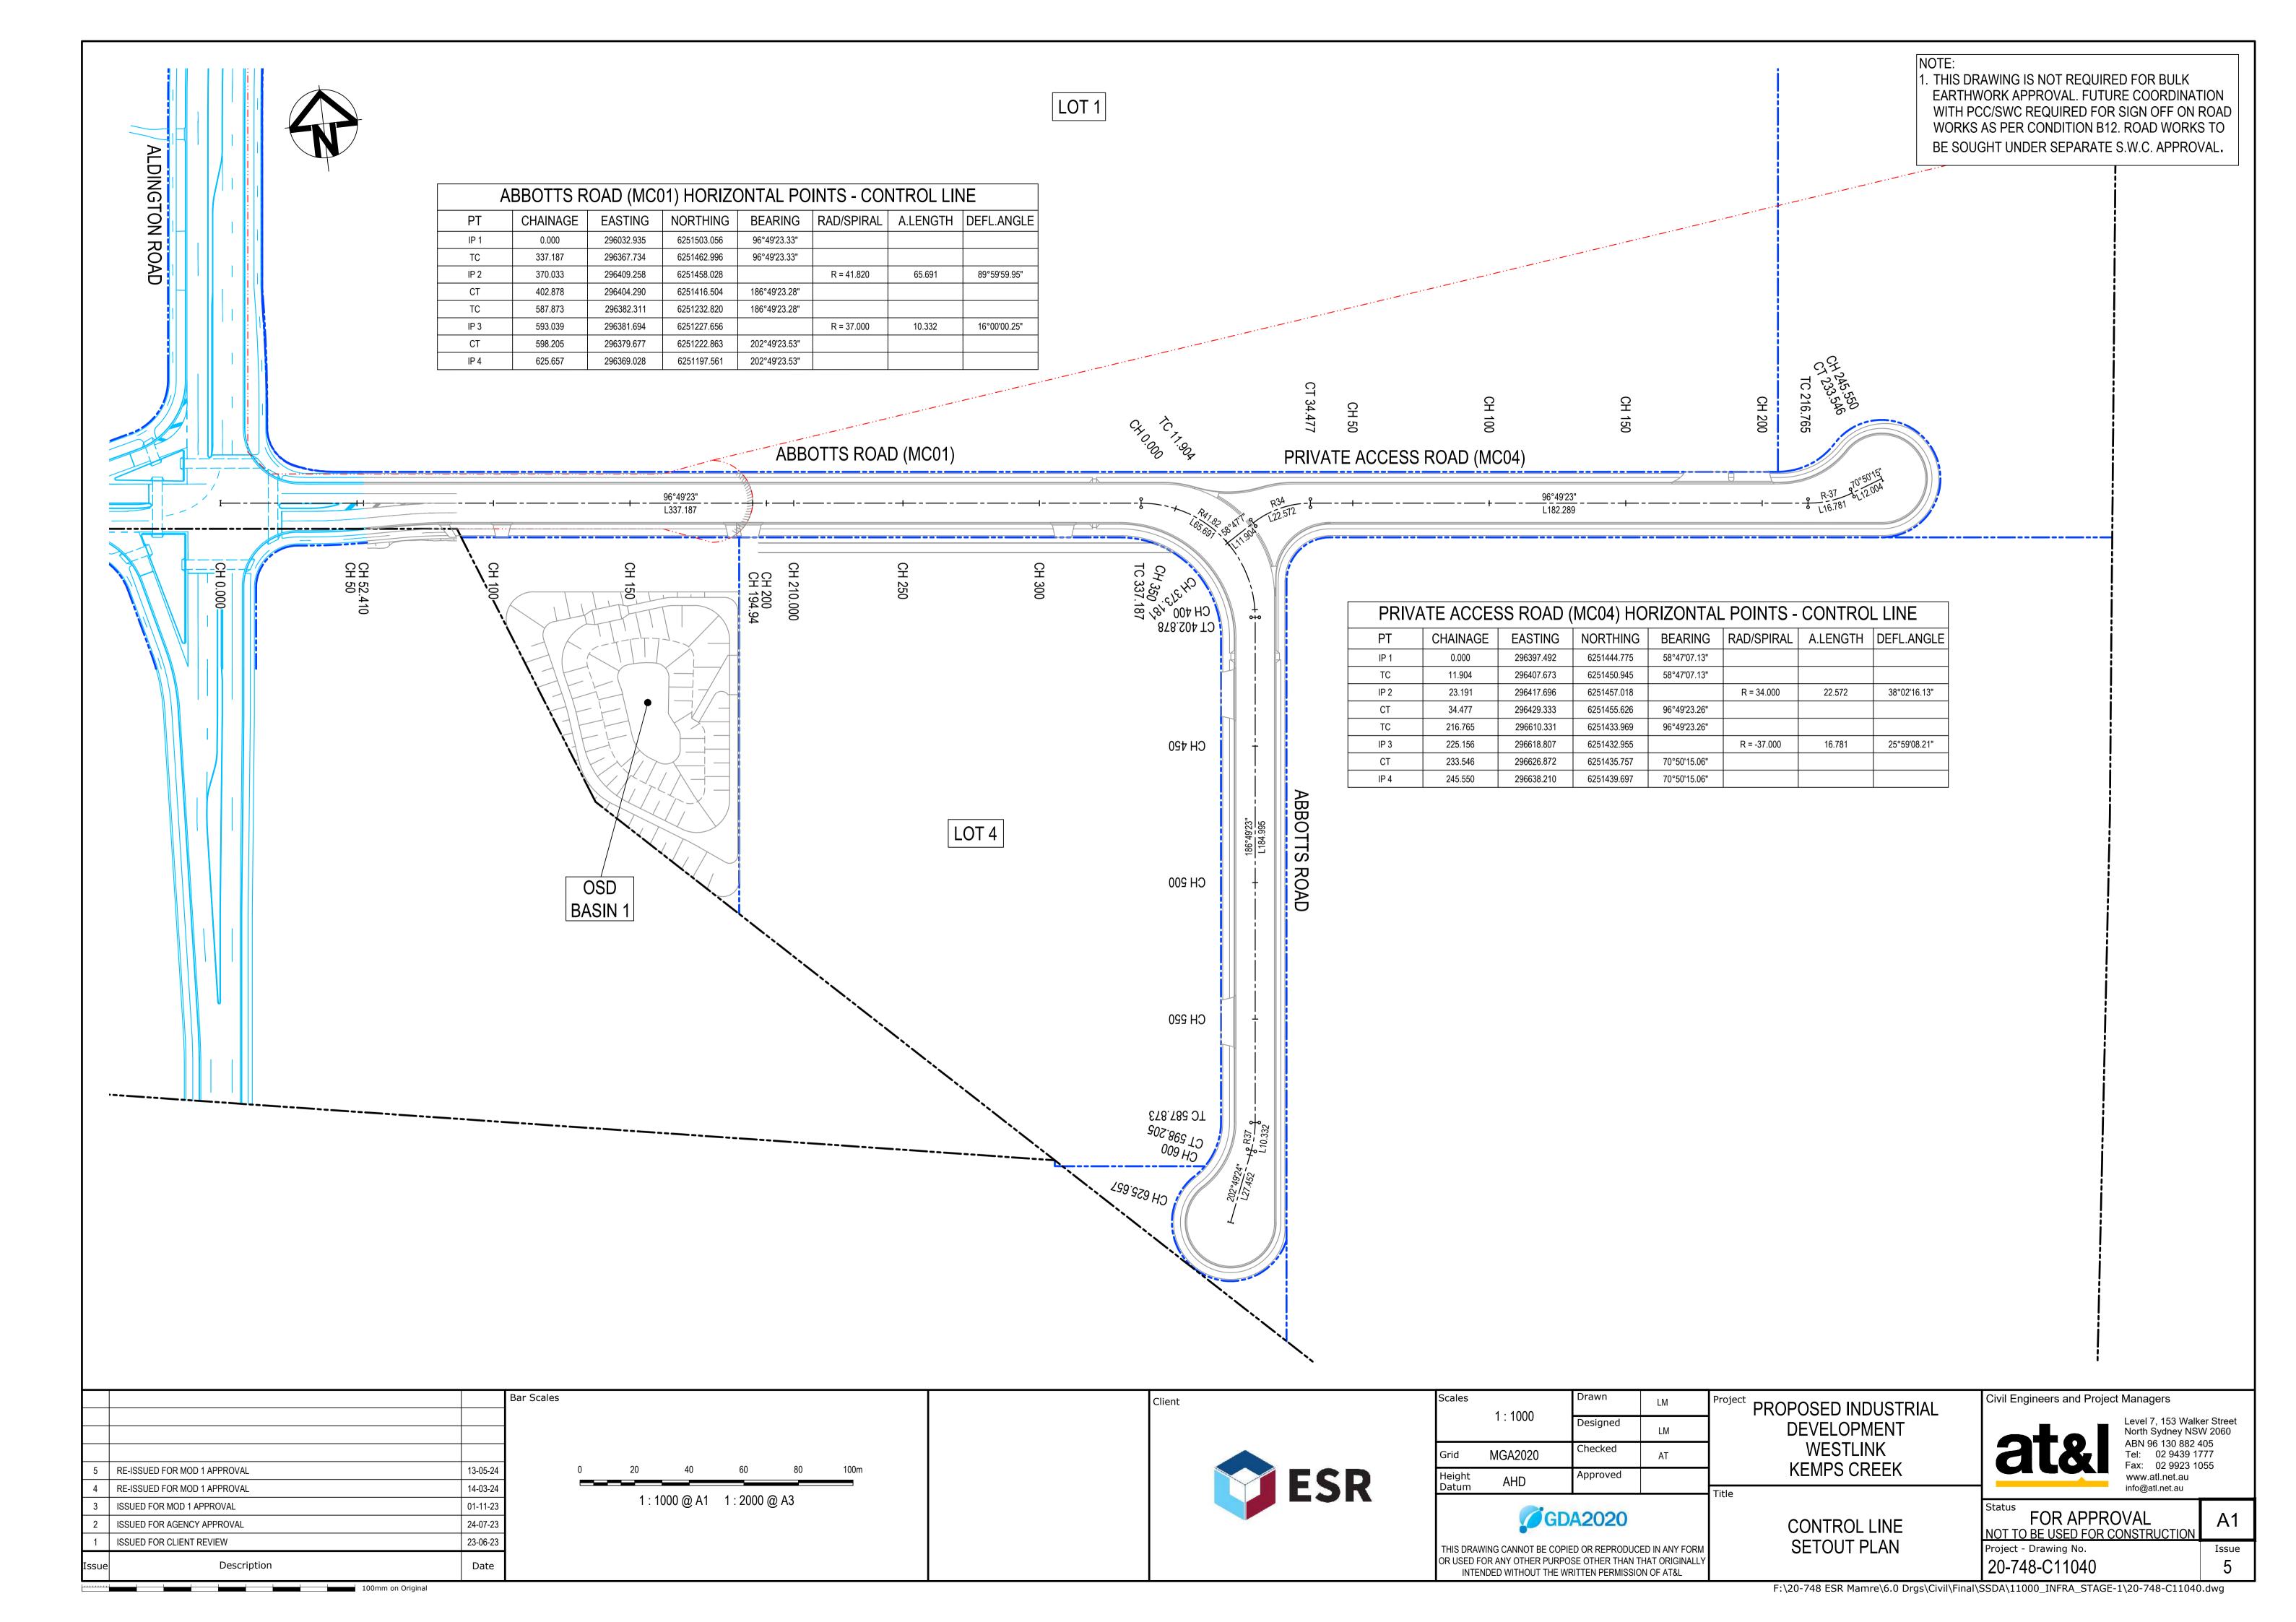

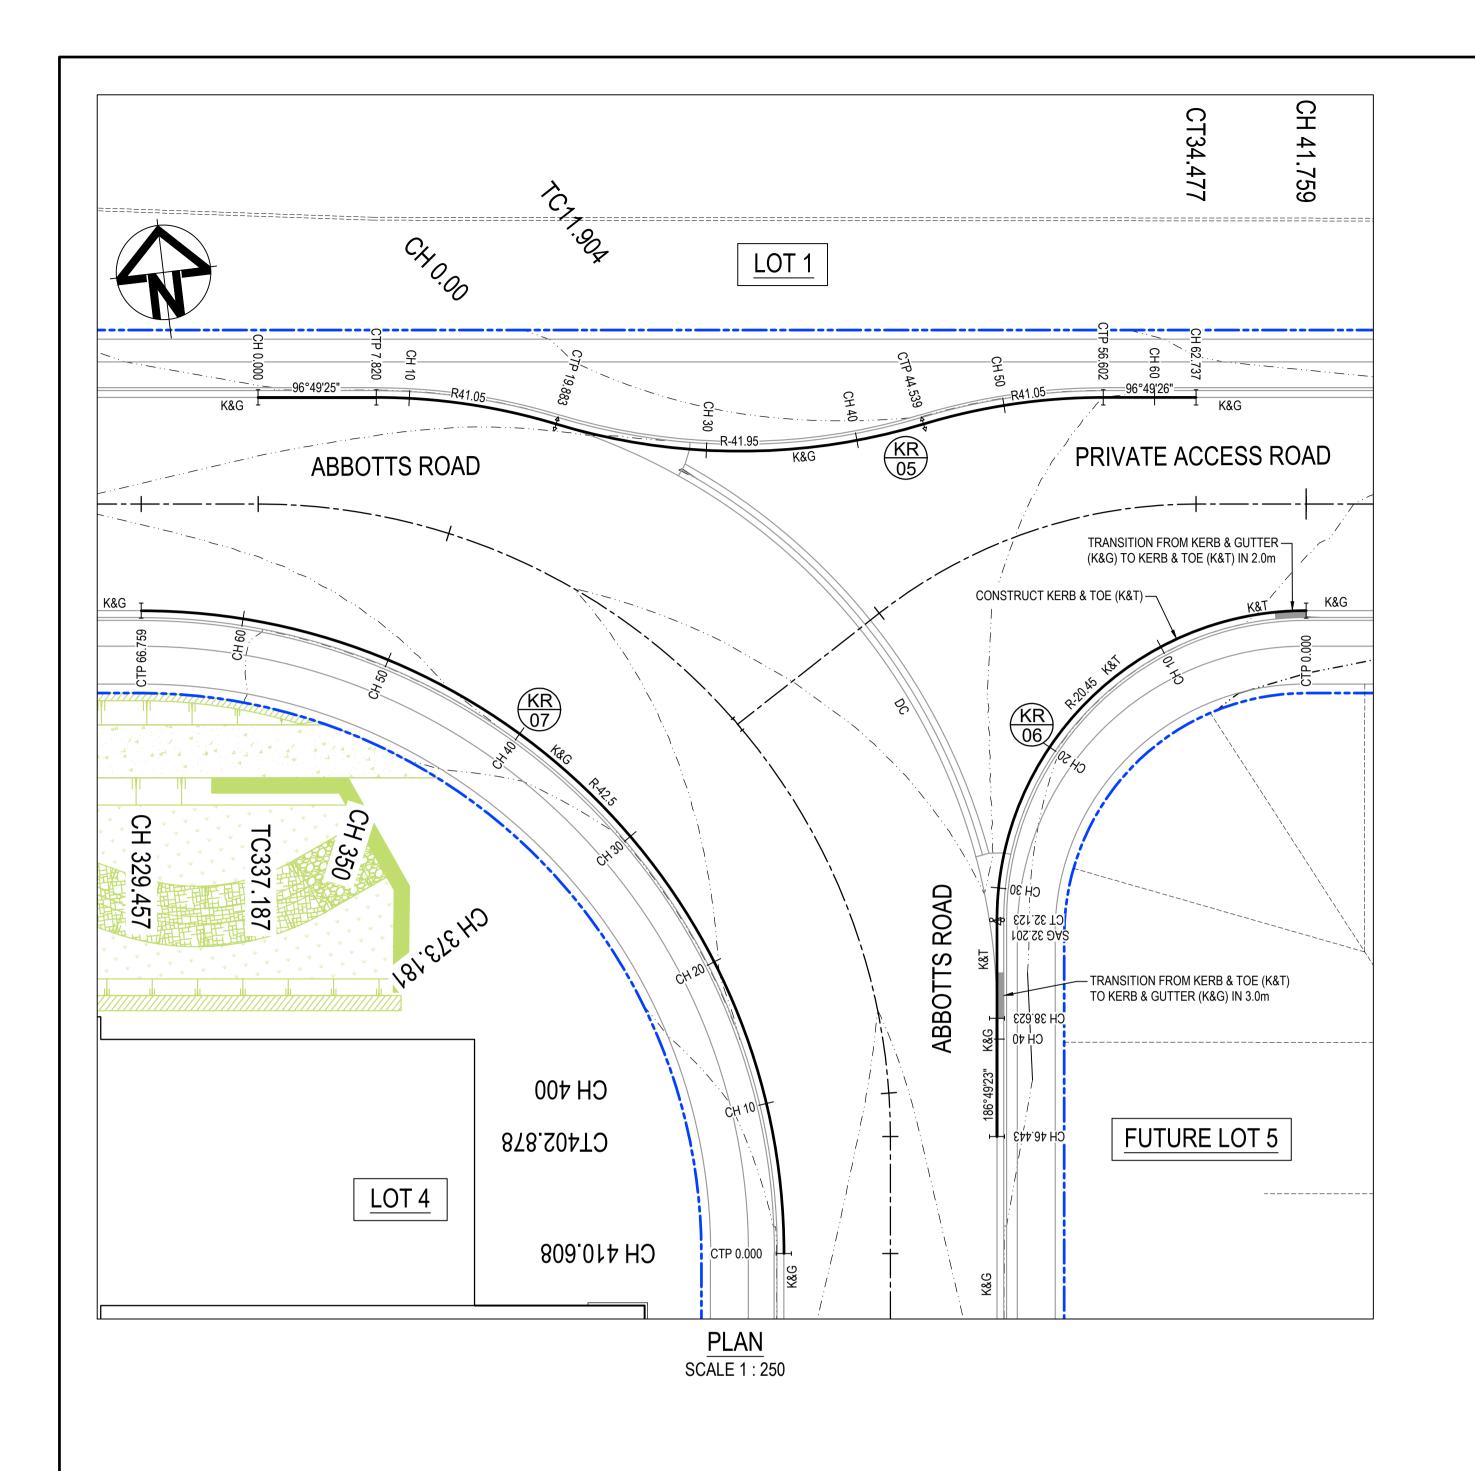

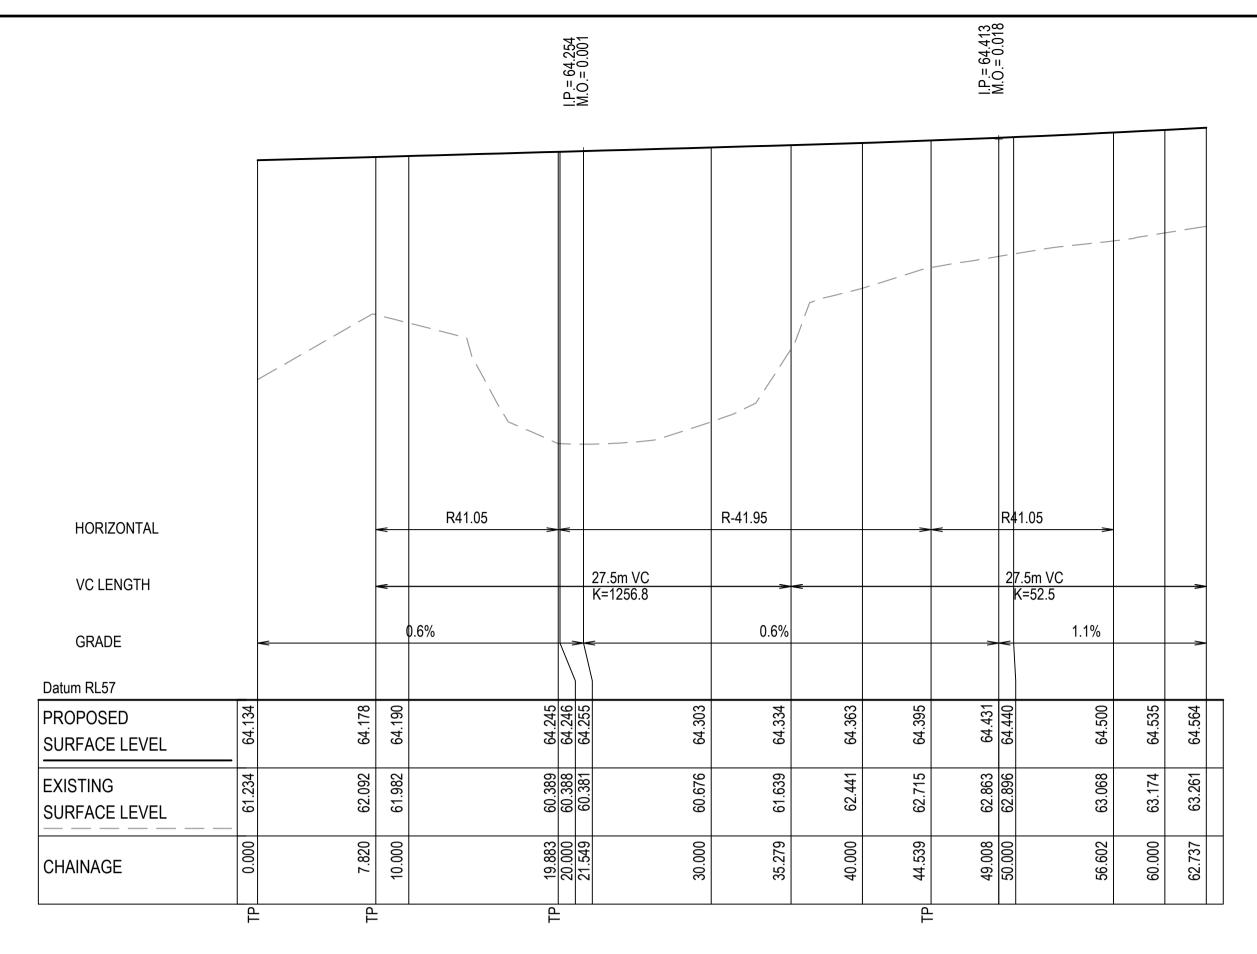

KR05 LONGITUDINAL SECTION SCALE 1:250 HORI. 1:50 VERT.

	KR05 HORIZONTAL POINTS - CONTROL LINE (LIP)							
PT	CHAINAGE	EASTING	NORTHING	BEARING	RAD/SPIRAL	A.LENGTH	DEFL.ANGLE	
IP 1	0.000	296368.572	6251469.997	96°49'24.53"				
TC	7.820	296376.337	6251469.067	96°49'24.53"				
IP 2	13.852	296382.369	6251468.346		R = 41.050	12.063	16°50'13.65"	
CC	19.883	296387.934	6251465.907	113°39'38.18"				
IP 3	32.211	296399.562	6251460.813		R = -41.950	24.656	33°40'29.99"	
CC	44.539	296412.064	6251463.020	79°59'08.18"				
IP 4	50.571	296418.047	6251464.077		R = 41.050	12.063	16°50'14.97"	
IP 5	56.602	296424.079	6251463.355					
IP 6	62.737	296430.170	6251462.626	96°49'25.75"				

KR06 HORIZONTAL POINTS - CONTROL LINE (LIP)							
PT	CHAINAGE	EASTING	NORTHING	BEARING	RAD/SPIRAL	A.LENGTH	DEFL.ANGLE
IP 1	0.000	296435.726	6251447.761	276°49'23.33"			
IP 2	16.061	296415.421	6251450.190		R = -20.450	32.123	90°00'00.00"
IP 3	32.123	296412.991	6251429.885				
IP 4	46.443	296411.290	6251415.667	186°49'22.86"		_	

KR07 HORIZONTAL POINTS - CONTROL LINE (LIP)							
PT	CHAINAGE	EASTING	NORTHING	BEARING	RAD/SPIRAL	A.LENGTH	DEFL.ANGLE
IP 1	0.000	296396.371	6251409.667	6°49'23.33"			
IP 2	33.379	296401.420	6251451.866		R = -42.500	66.759	90°00'00.00"
IP 3	66.759	296359.221	6251456.915	276°49'23.33"			

Bar Scales RE-ISSUED FOR MOD 1 APPROVAL RE-ISSUED FOR MOD 1 APPROVAL 14-03-24 ISSUED FOR MOD 1 APPROVAL 01-11-23 ISSUED FOR AGENCY APPROVAL 24-07-23 23-06-23 ISSUED FOR CLIENT REVIEW Date Description

1. THIS DRAWING IS NOT REQUIRED FOR BULK

EARTHWORK APPROVAL. FUTURE COORDINATION WITH PCC/SWC REQUIRED FOR SIGN OFF ON ROAD WORKS AS PER CONDITION B12. ROAD WORKS TO

BE SOUGHT UNDER SEPARATE S.W.C. APPROVAL.

1 : 250 @ A1 1 : 500 @ A3 1:50 @ A1 1:100 @ A3



Client

Scales	1 : 250	Drawn	LM	Proje
	1 . 250	Designed	LM	
Grid	MGA2020	Checked	AT	
Height	ΔHD	Approved		

GDA2020

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PROPOSED INDUSTRIAL DEVELOPMENT WESTLINK KEMPS CREEK


SHEET 1

INTERSECTION PLAN

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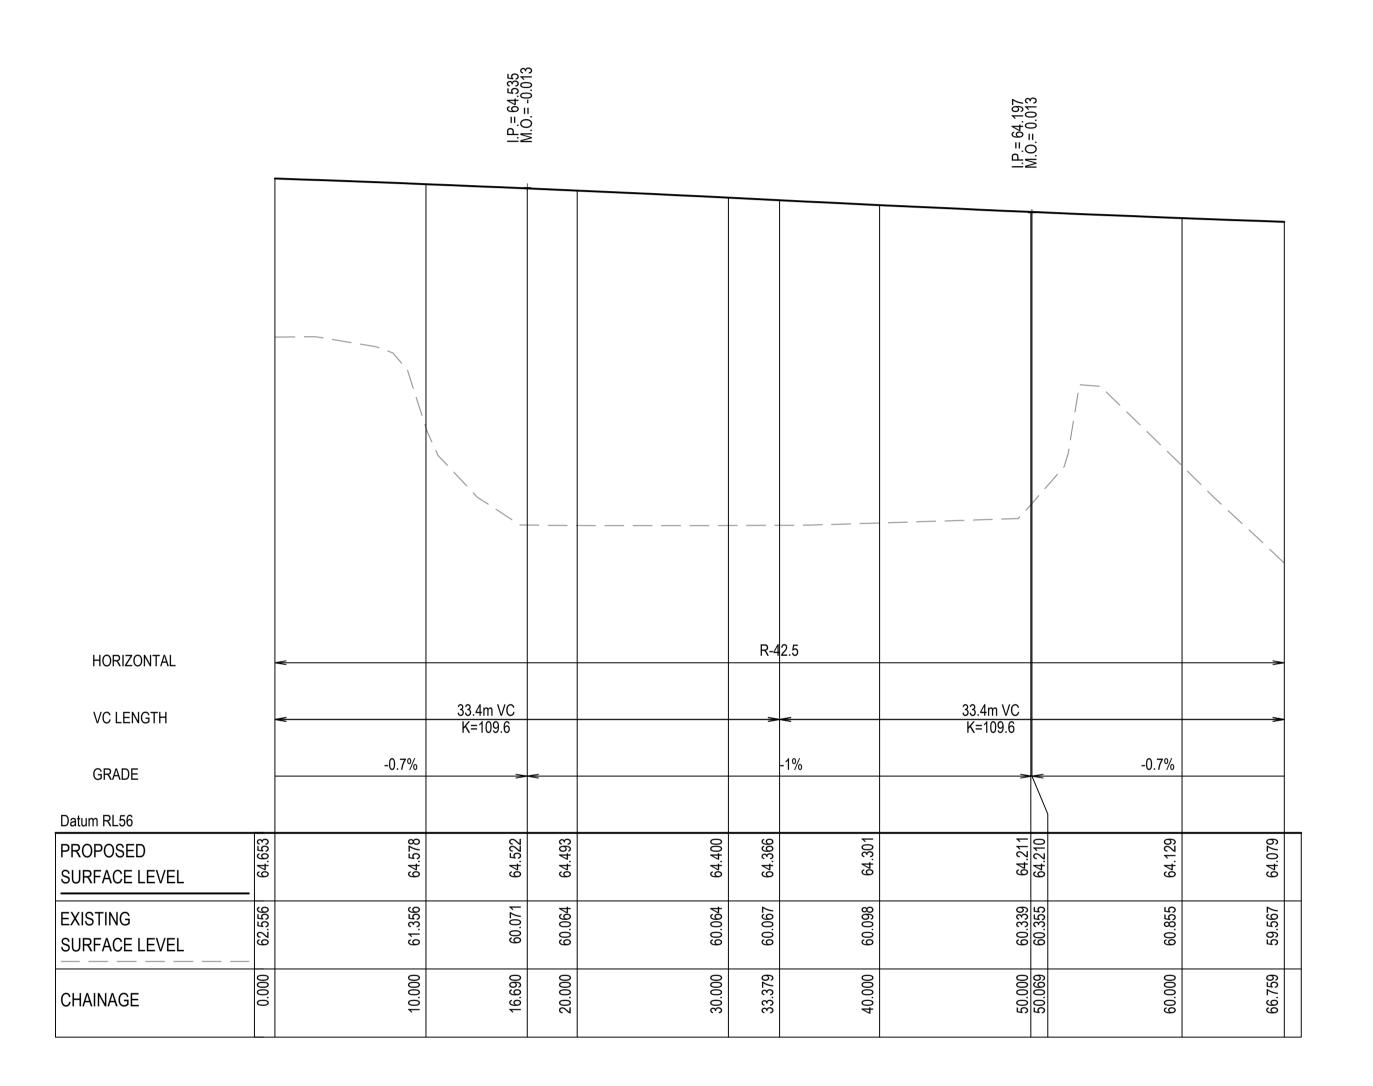
Civil Engineers and Project Managers

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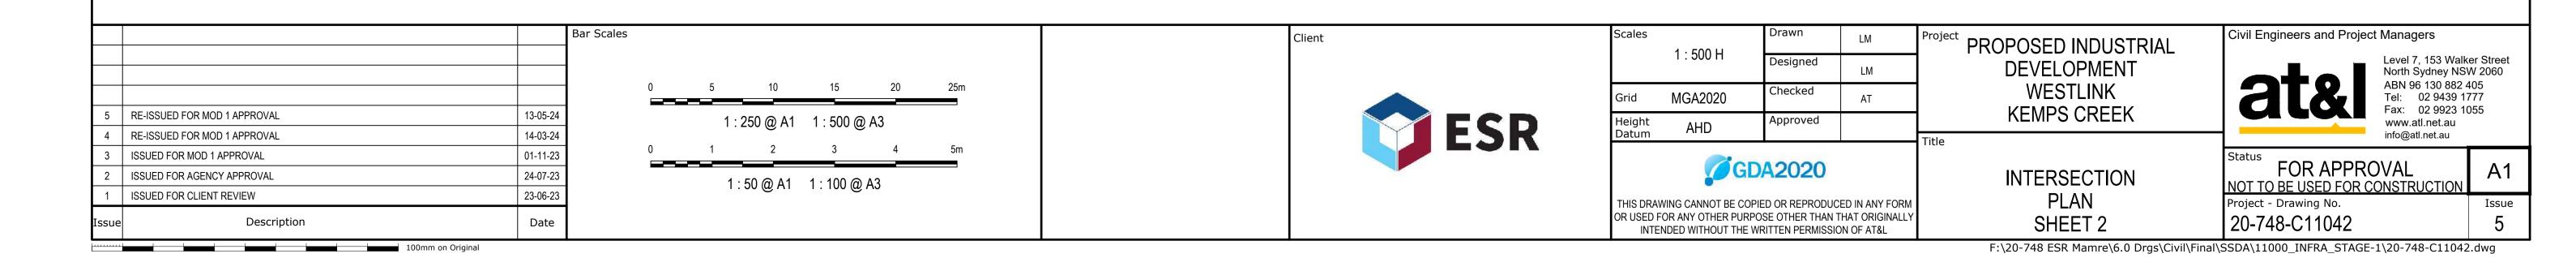



KR06 LONGITUDINAL SECTION

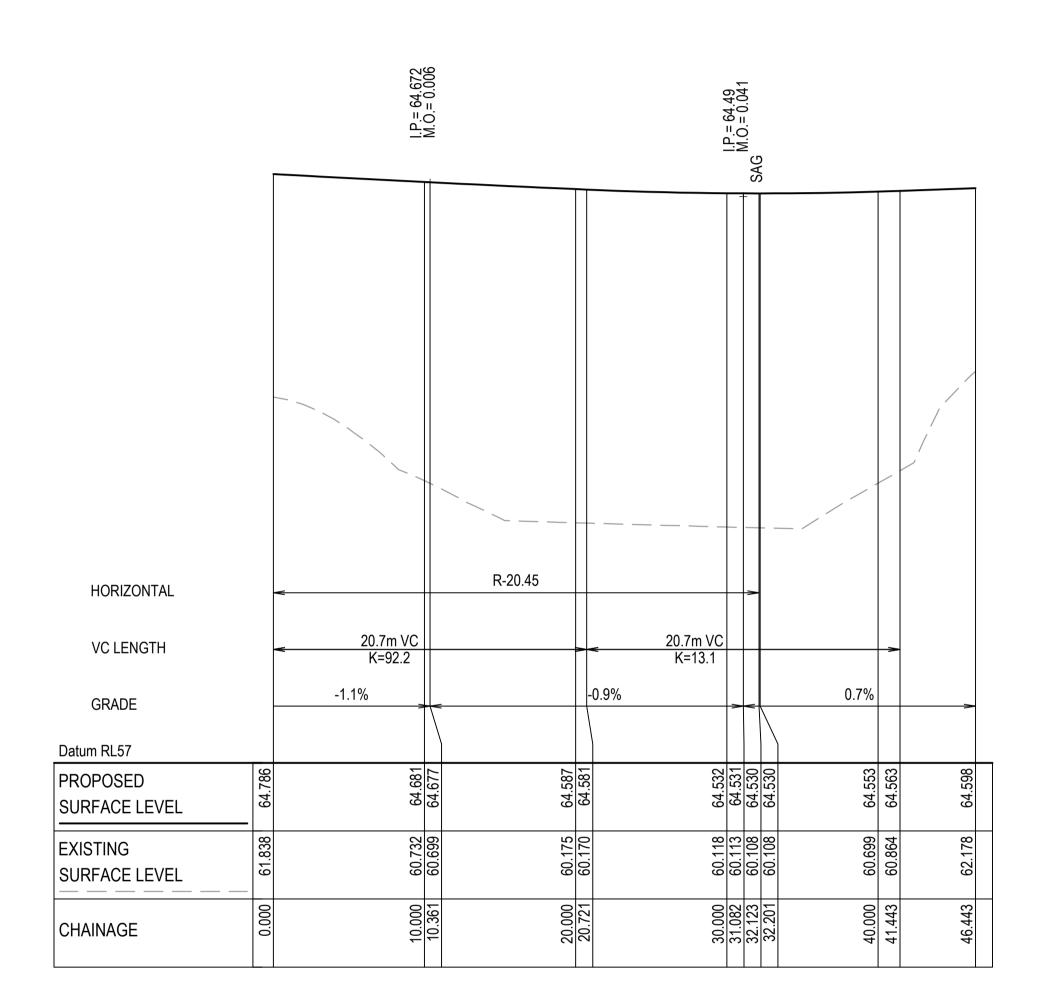
SCALE 1:250 HORI.
1:50 VERT.




KR07 LONGITUDINAL SECTION
SCALE 1:250 HORI.
1:50 VERT.



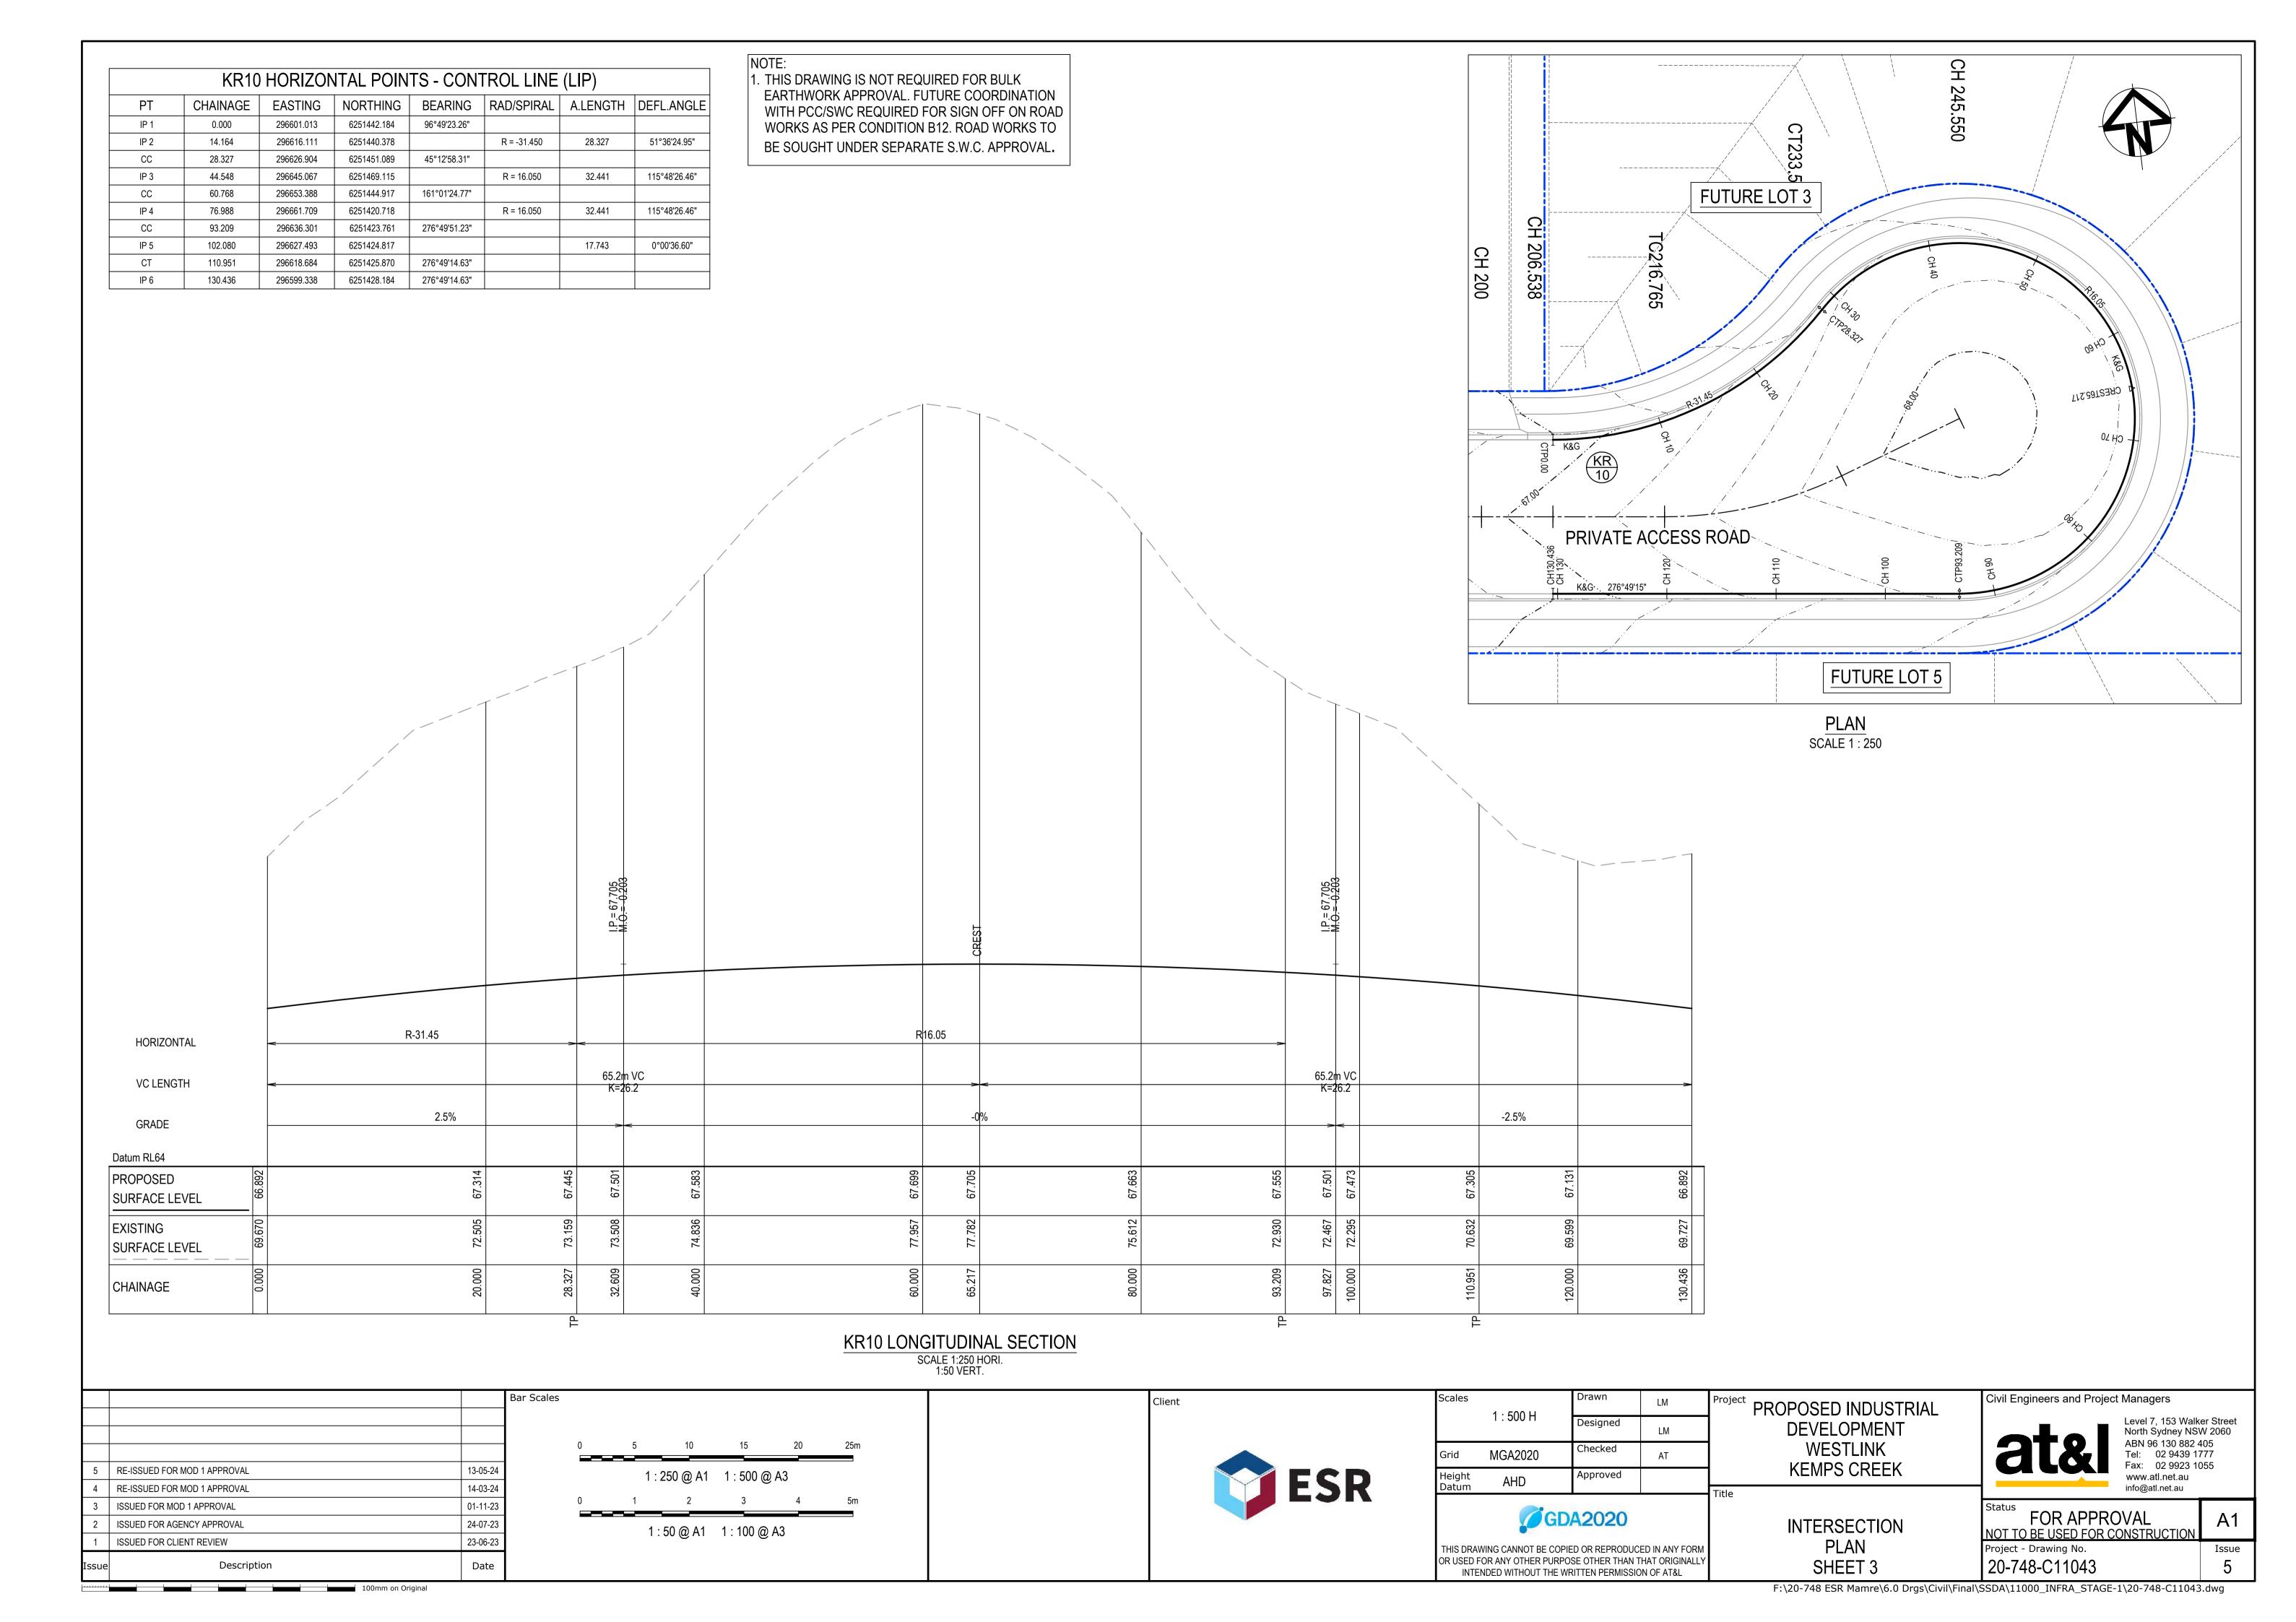

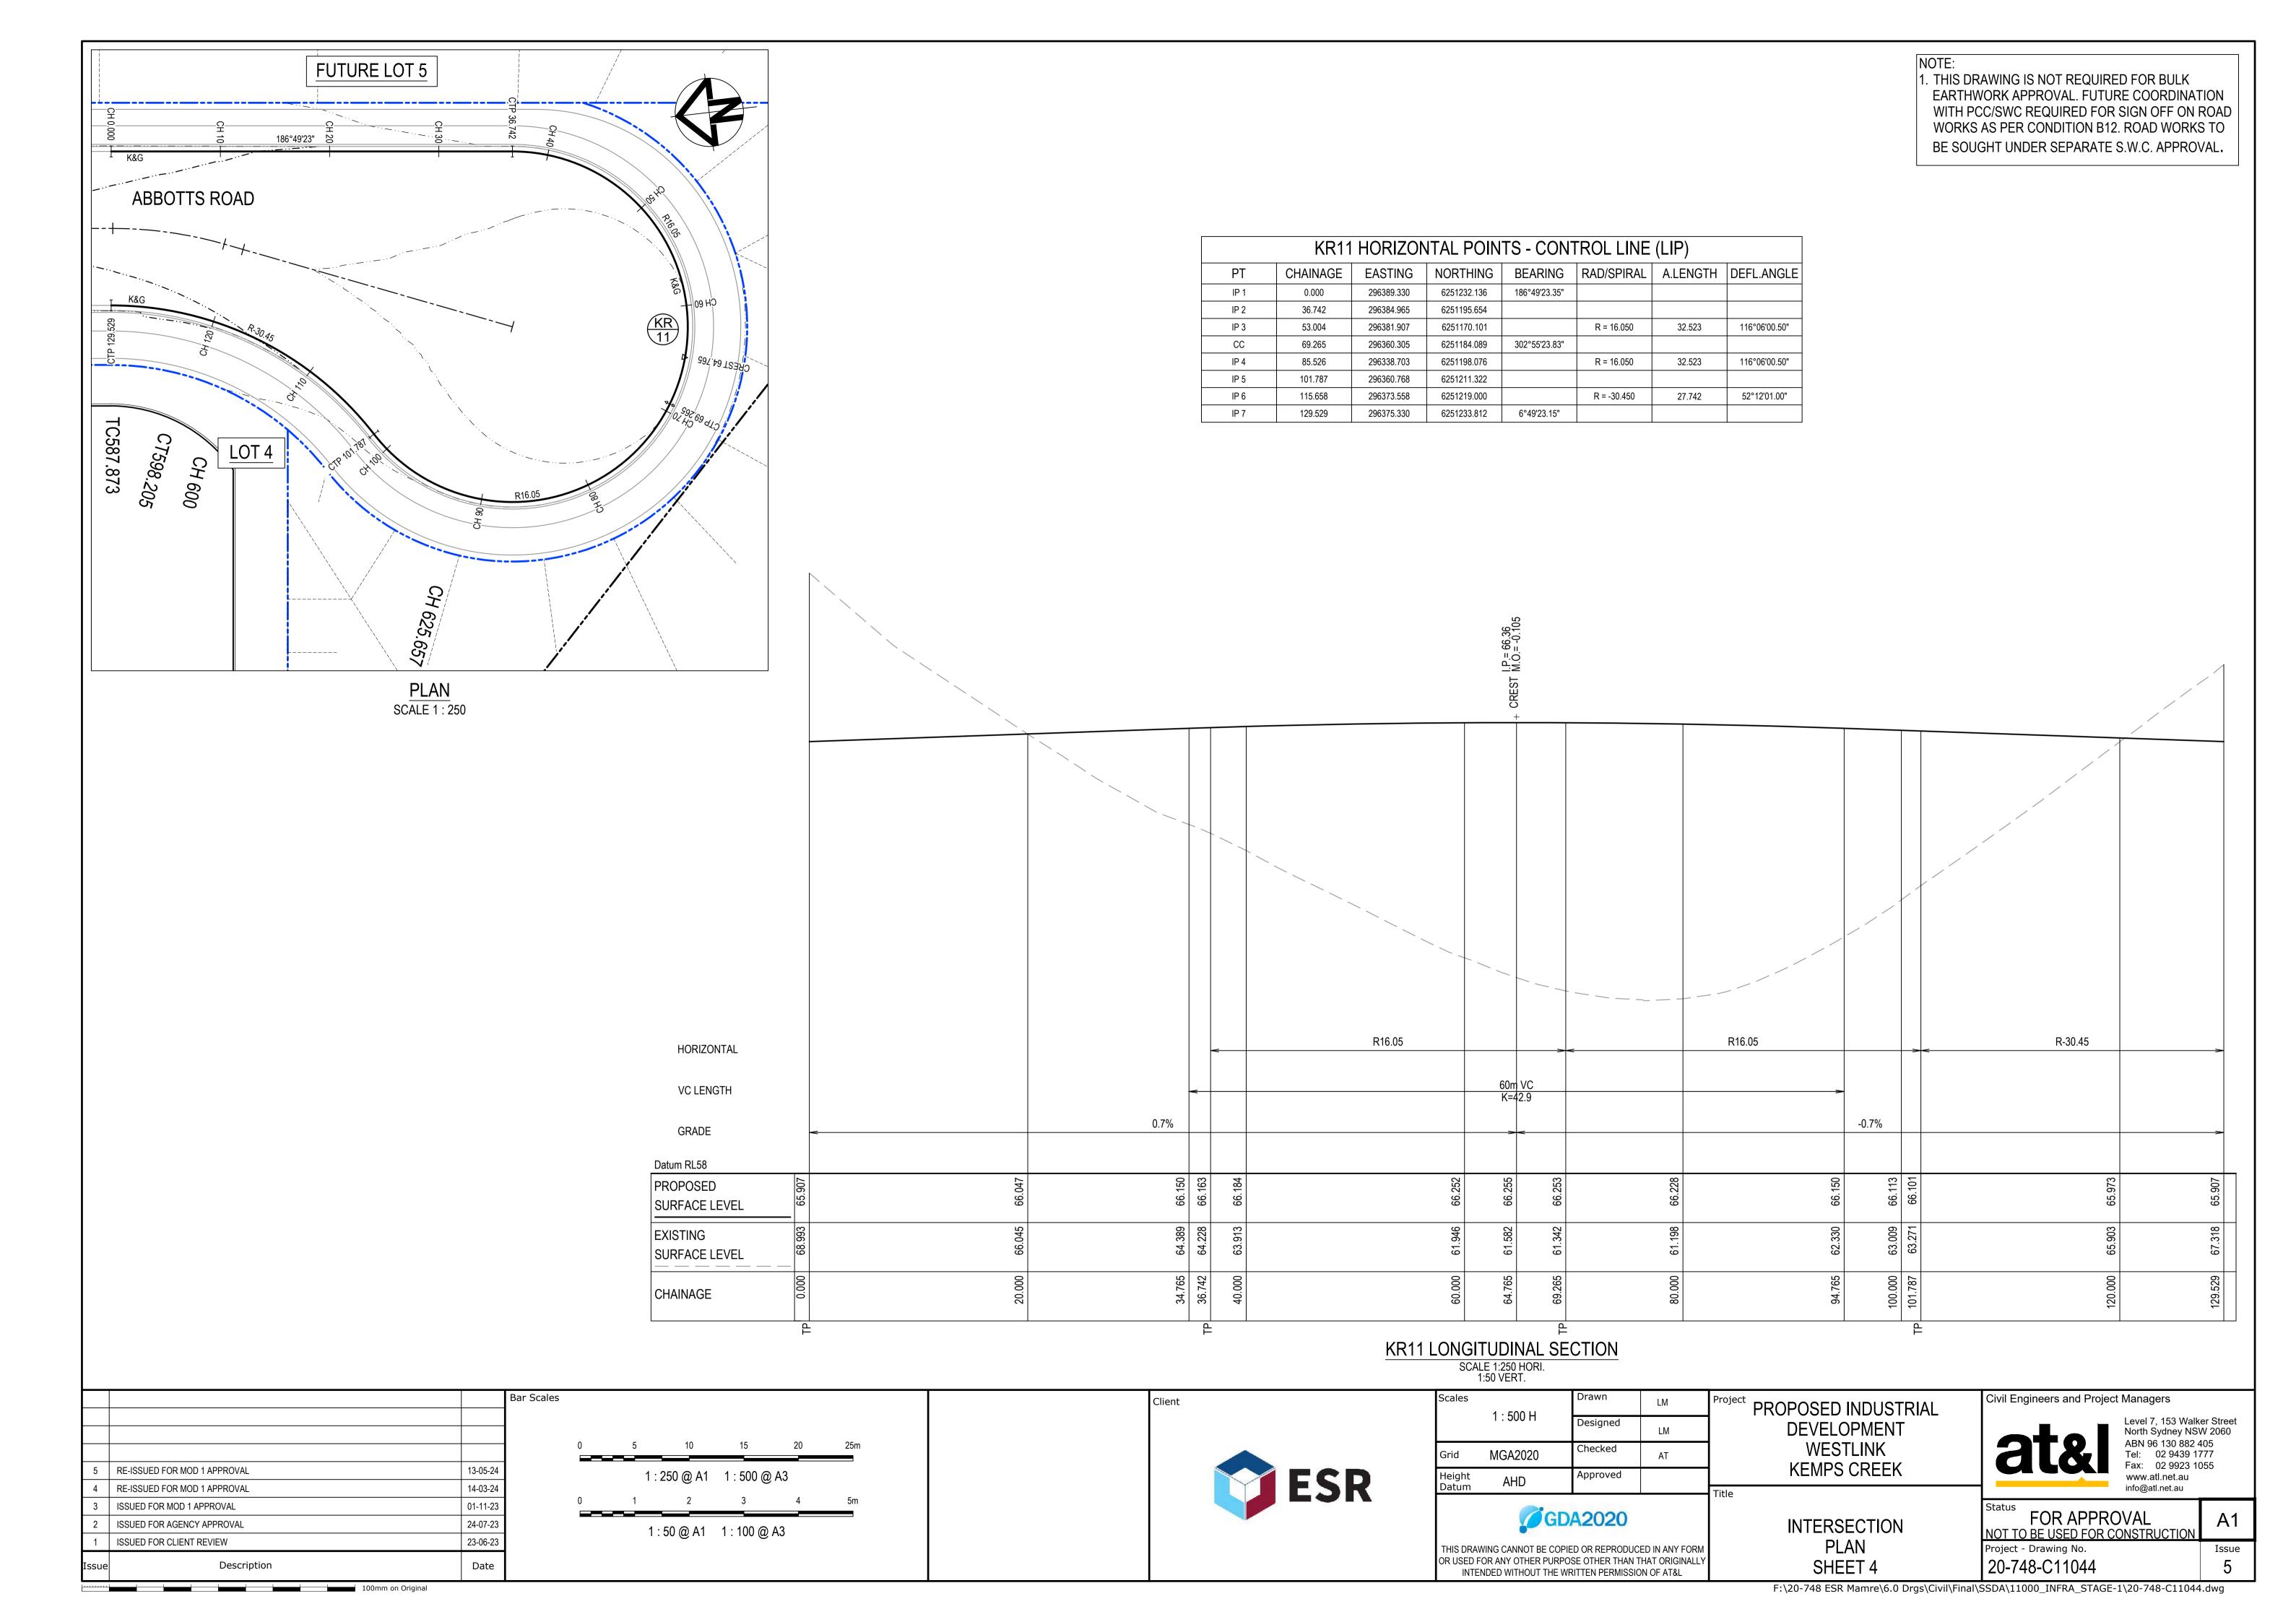



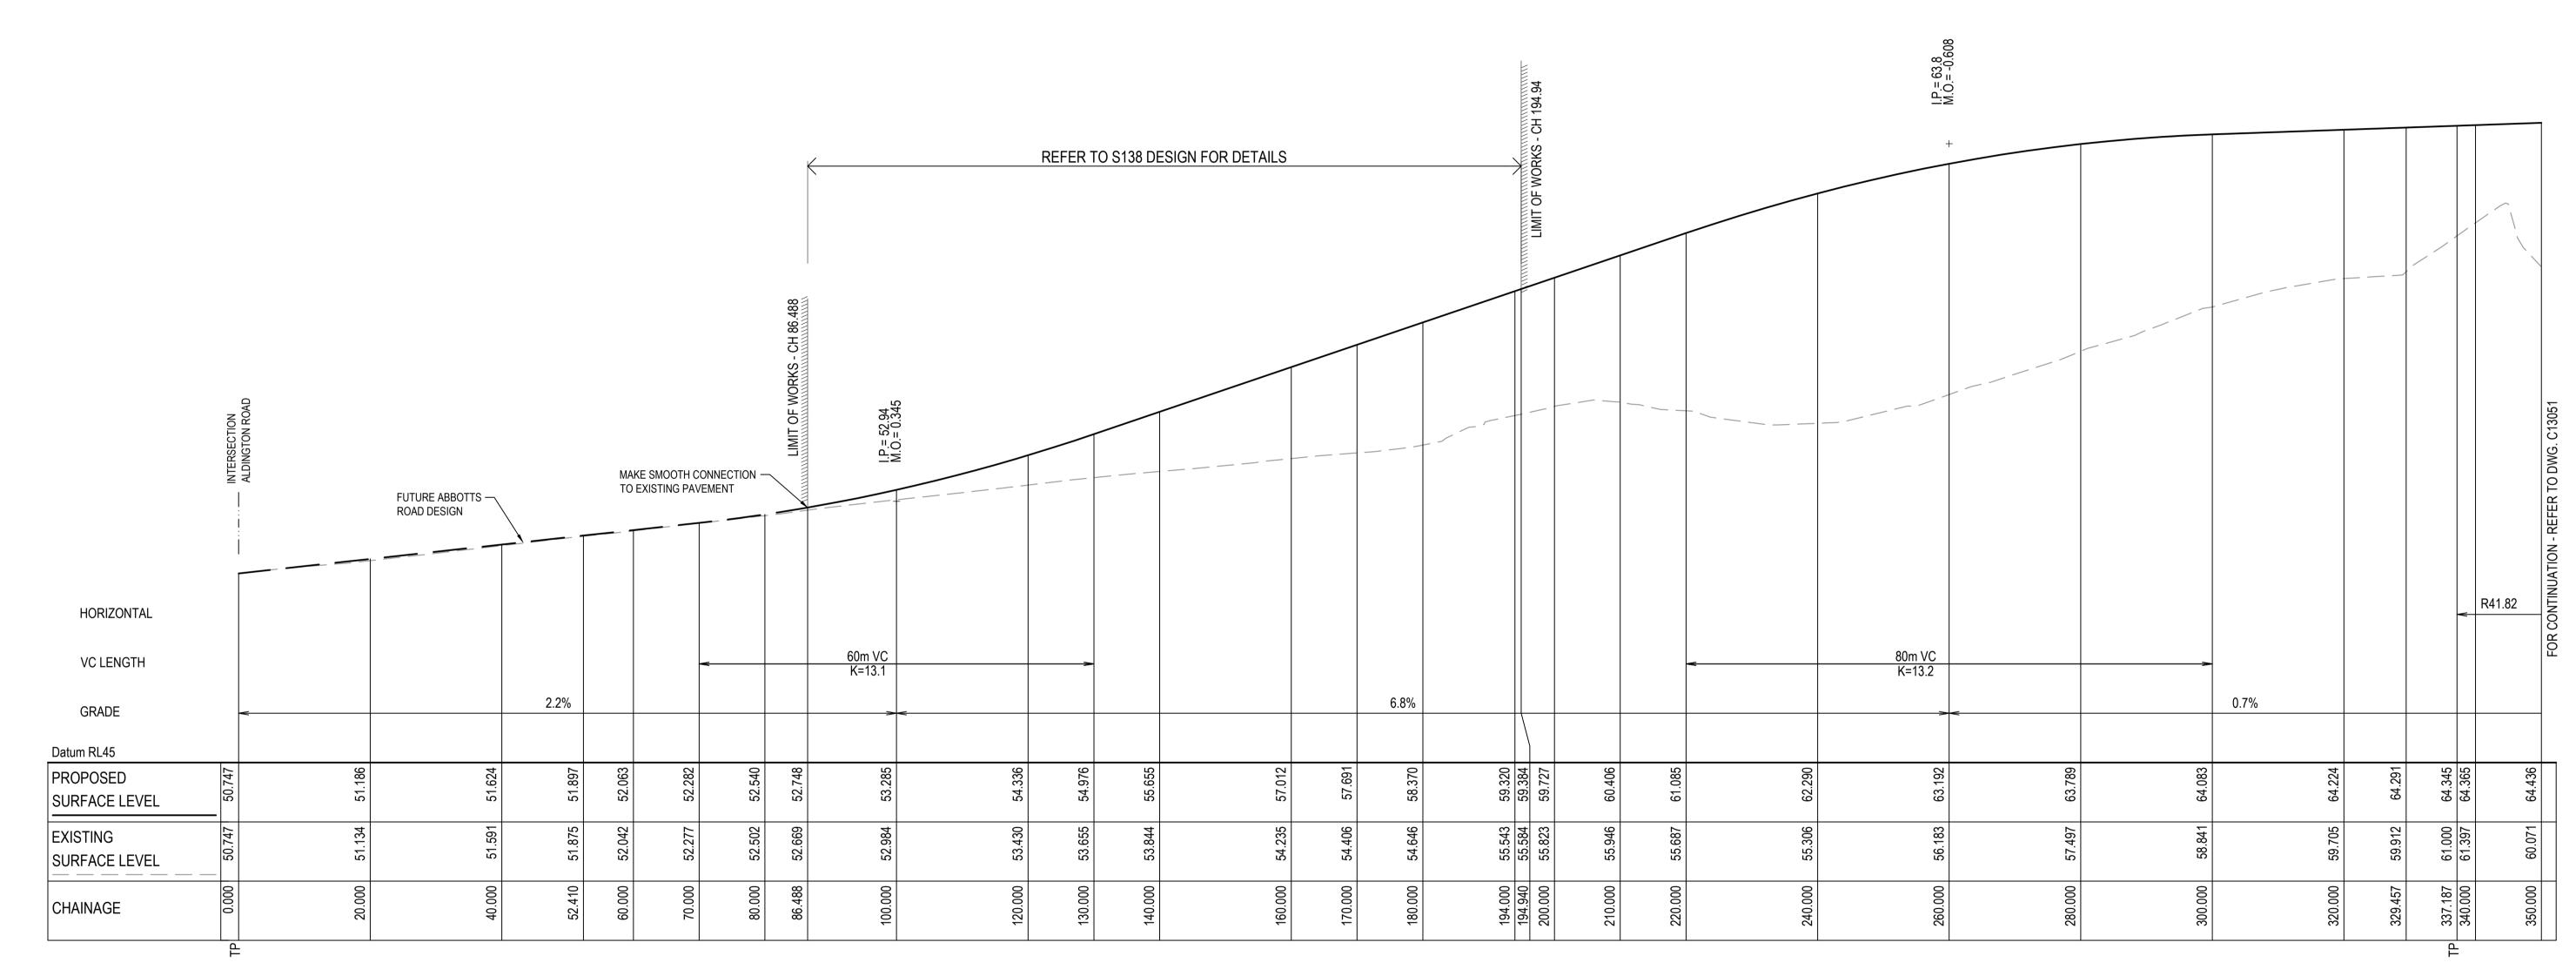


ABBOTTS ROAD (MC01) LONGITUDINAL SECTION

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1:100 VERT.


5 RE-ISSUED FOR MOD 1 APPROVAL 4 RE-ISSUED FOR MOD 1 APPROVAL	13-05-24 14-03-24	0 2 4 6 8 10m 1:100@A1 1:200@A3	Client	Scales 1:100 V 1:500 H Grid MGA2020 Height AHD	Drawn LM Designed LM Checked AT Approved	Project PROPOSED INDUSTRIAL DEVELOPMENT WESTLINK KEMPS CREEK	Civil Engineers and Project Managers Level 7, 153 W North Sydney ABN 96 130 8 Tel: 02 943: Fax: 02 992: www.atl.net.au info@atl.net.au	NSW 2060 882 405 89 1777 23 1055
3 ISSUED FOR MOD 1 APPROVAL 2 ISSUED FOR AGENCY APPROVAL	01-11-23 24-07-23	1 : 500 @ A1 1 : 1000 @ A3		G GE	DA2020	ABBOTTS ROAD (MC01)	FOR APPROVAL NOT TO BE USED FOR CONSTRUCTION	A1
1 ISSUED FOR CLIENT REVIEW Issue Description	23-06-23 Date			OR USED FOR ANY OTHER PURP	PIED OR REPRODUCED IN ANY FORM POSE OTHER THAN THAT ORIGINALLY WRITTEN PERMISSION OF AT&L	LONGITUDINAL SECTIONS SHEET 1	Project - Drawing No. 20-748-C11050	Issue 5
100m	nm on Original	<u> </u>	<u> </u>	•		F:\20-748 ESR Mamre\6.0 Drgs\Civil\Fi	nal\SSDA\11000_INFRA_STAGE-1\20-748-C110	050.dwg



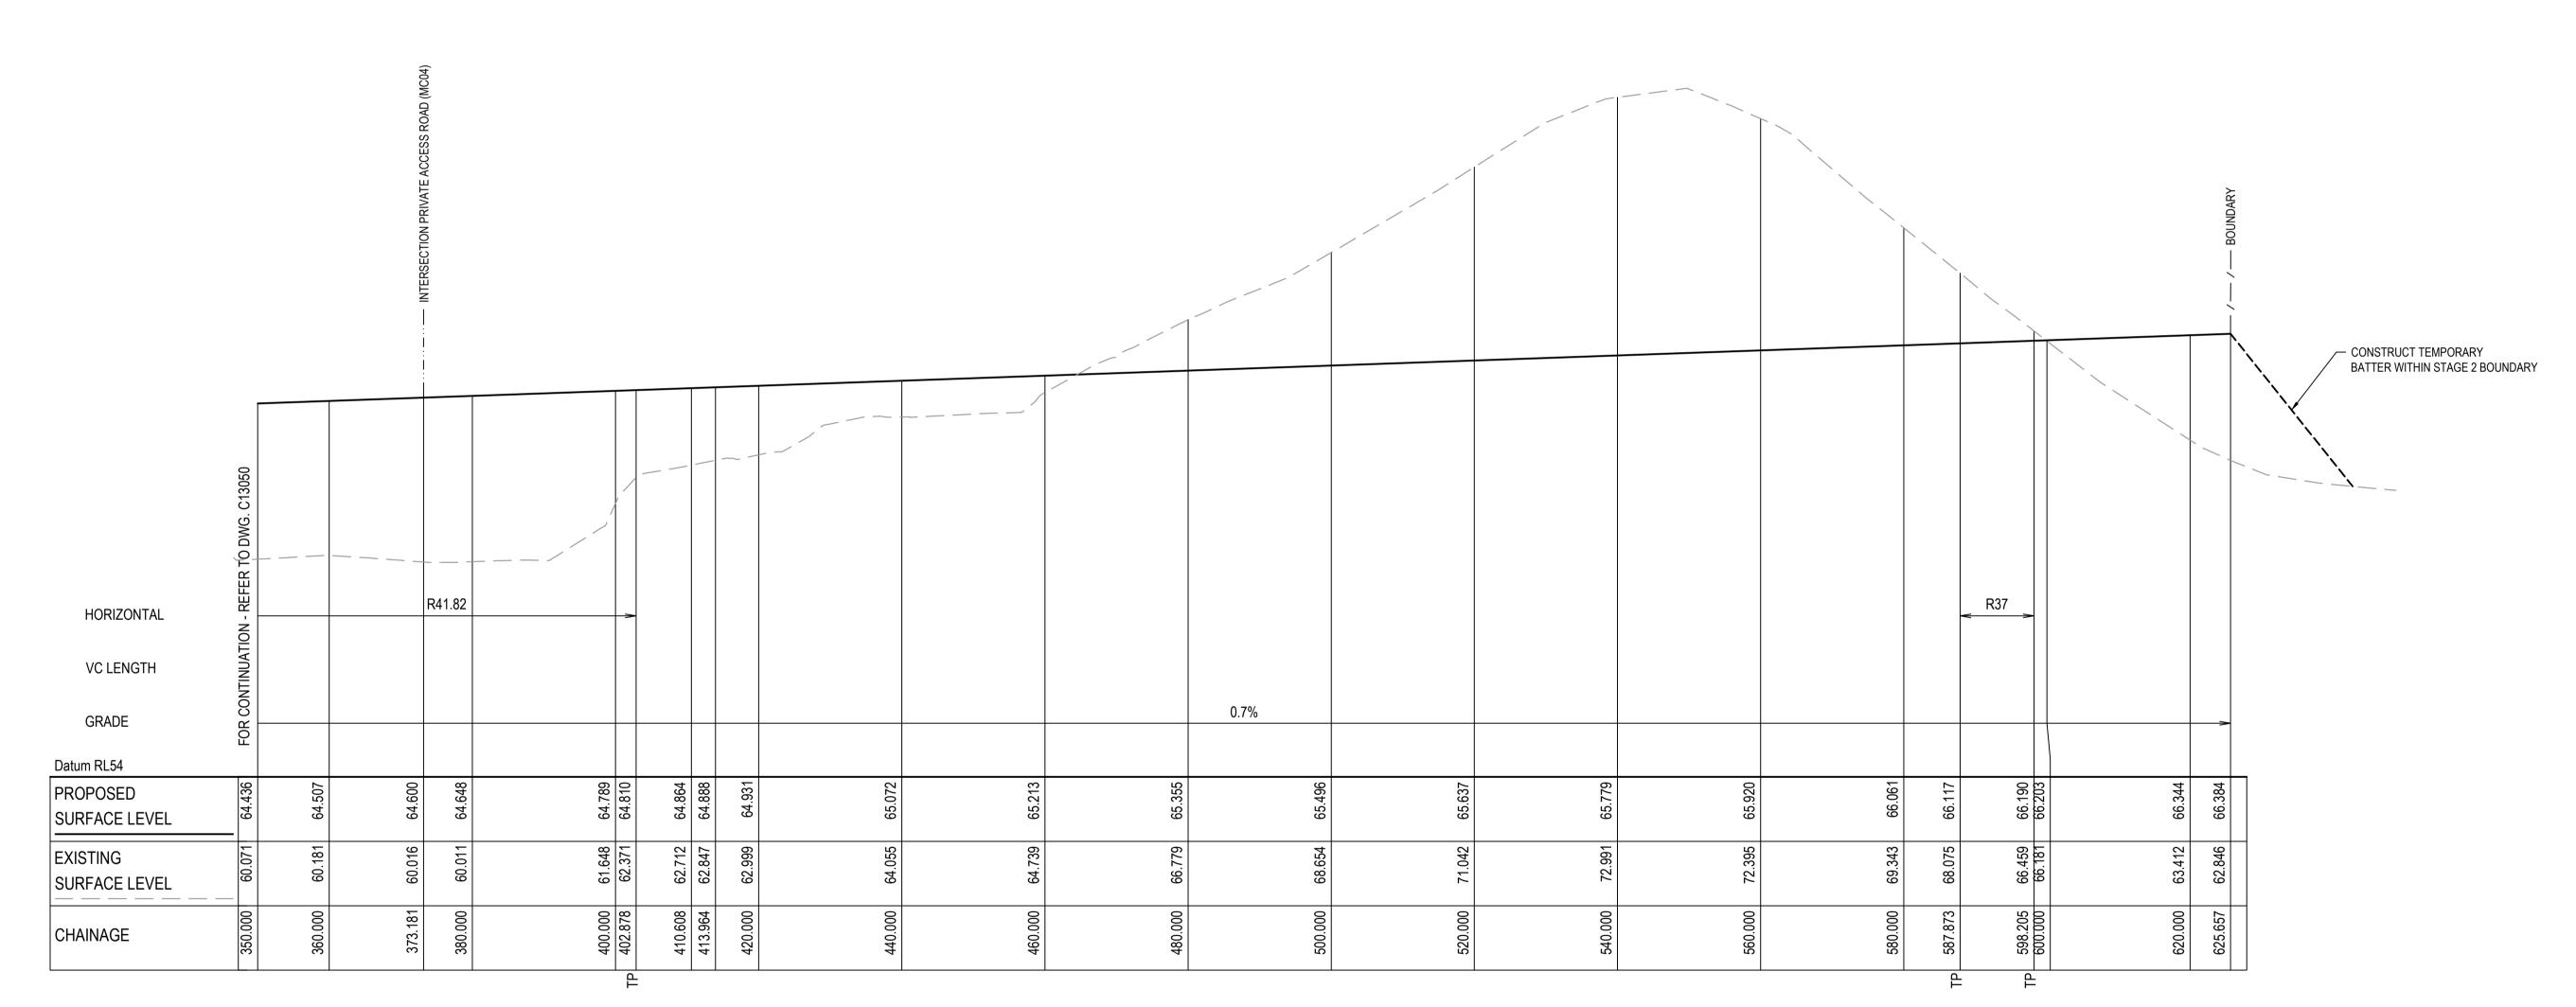


ABBOTTS ROAD (MC01) LONGITUDINAL SECTION - CONTINUED

SCALE 1:500 HORI.
1:100 VERT.

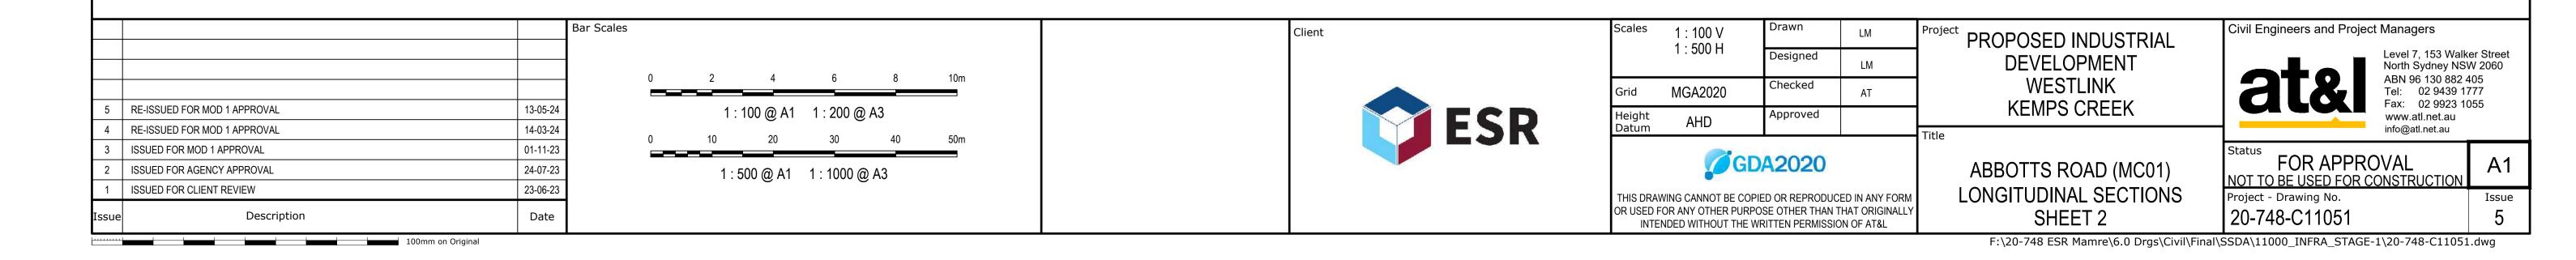

NOTE:


1. THIS DRAWING IS NOT REQUIRED FOR BULK EARTHWORK APPROVAL. FUTURE COORDINATION WITH PCC/SWC REQUIRED FOR SIGN OFF ON ROAD WORKS AS PER CONDITION B12. ROAD WORKS TO BE SOUGHT UNDER SEPARATE S.W.C. APPROVAL.

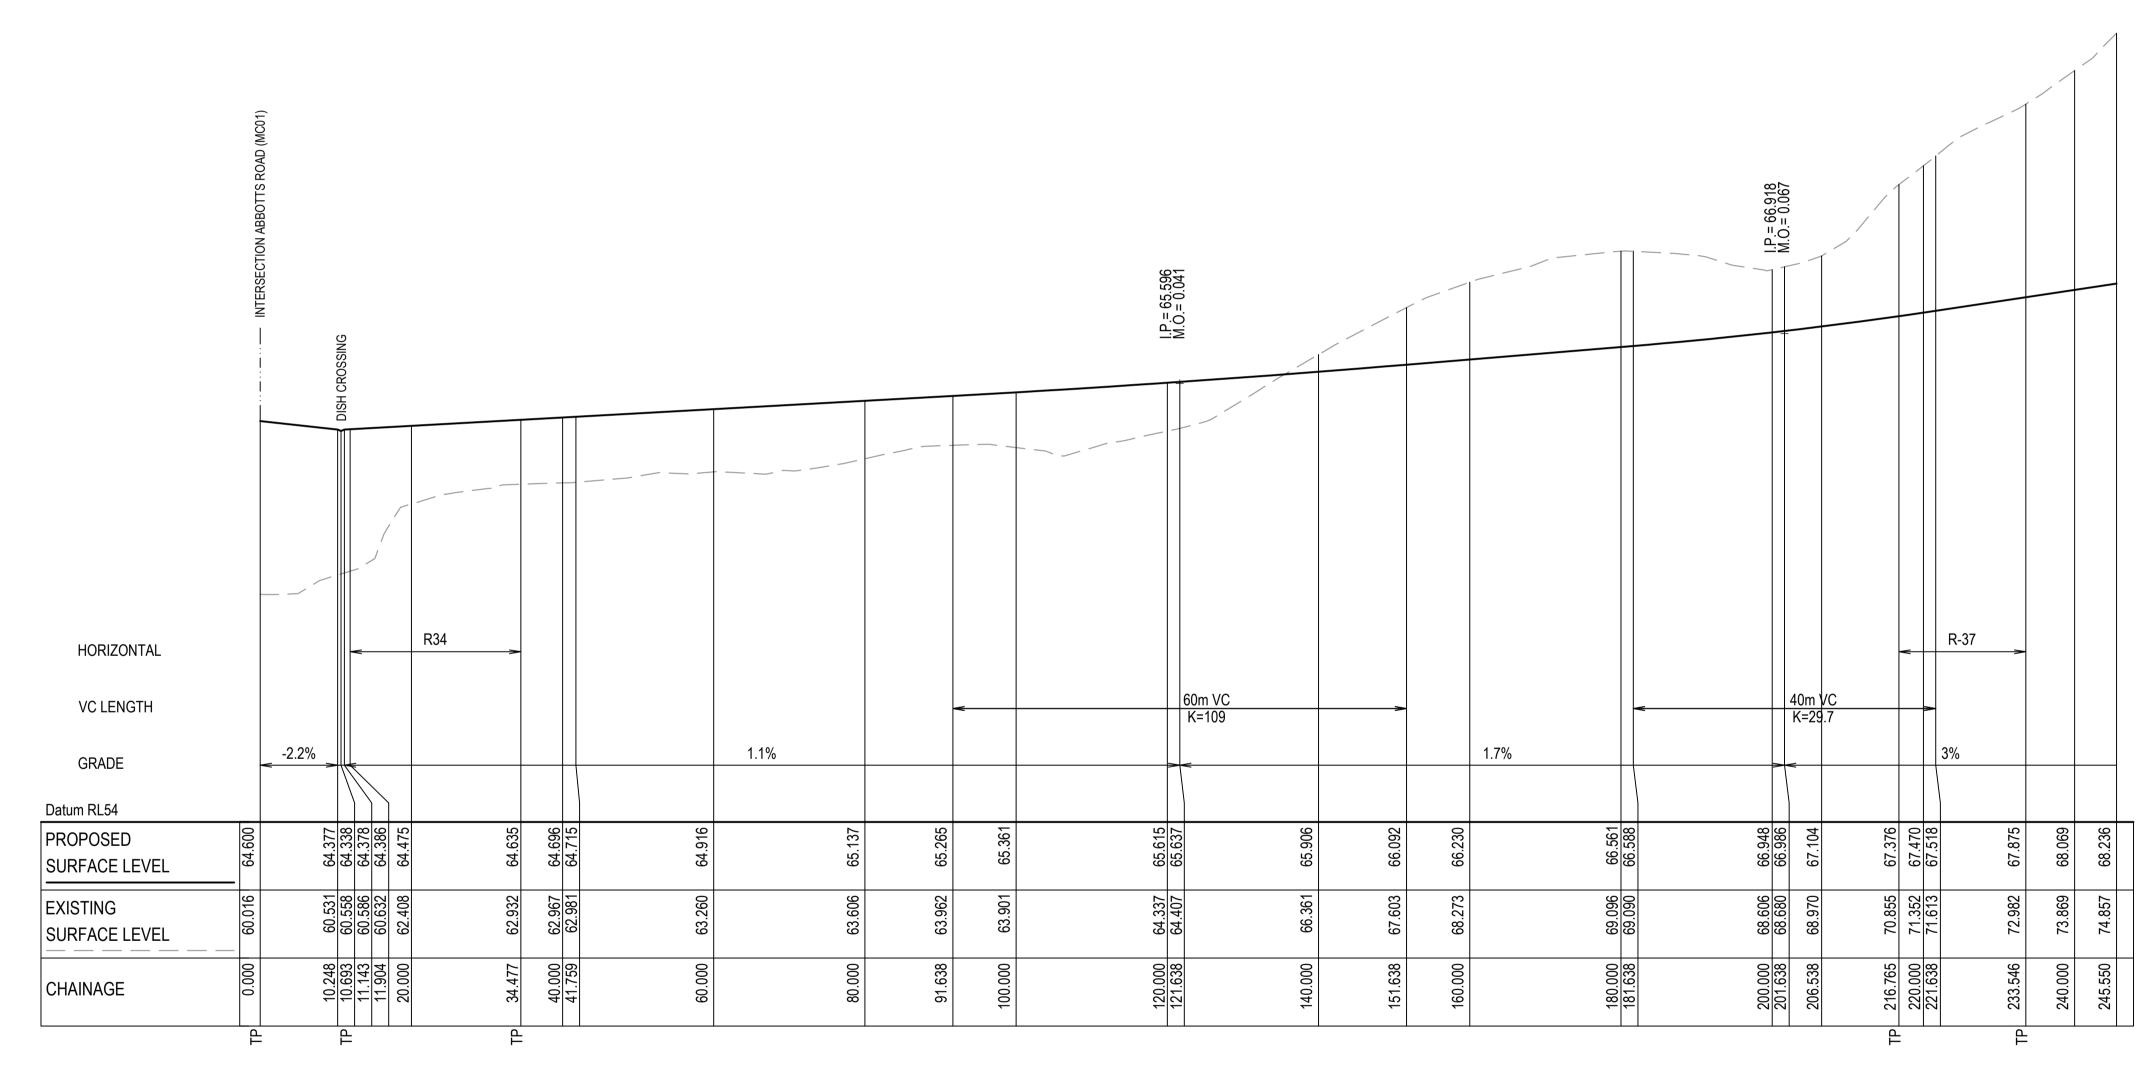


PRIVATE ACCESS ROAD (MC04) LONGITUDINAL SECTION

SCALE 1:500 HORI.
1:100 VERT.

5 RE-ISSUED FOR MOD 1 APPROVAL 4 RE-ISSUED FOR MOD 1 APPROVAL	13-05-24 14-03-24	0 2 4 6 8 10m 1:100@A1 1:200@A3	Client	Scales 1:100 V 1:500 H Grid MGA2020 Height AHD	Drawn LM Designed LM Checked AT Approved	Project PROPOSED INDUSTRIAL DEVELOPMENT WESTLINK KEMPS CREEK	Civil Engineers and Project Managers Level 7, 153 Wa North Sydney N ABN 96 130 88. Tel: 02 9439 Fax: 02 9923 www.atl.net.au info@atl.net.au	NSW 2060 2 405 1777 3 1055
3 ISSUED FOR MOD 1 APPROVAL	01-11-23	0 10 20 30 40 50m		COD	40000		Status FOD ADDDOVAL	A 4
2 ISSUED FOR AGENCY APPROVAL	24-07-23	1 : 500 @ A1 1 : 1000 @ A3		GD	A2020	PRIVATE ACCESS ROAD (MC04)	FOR APPROVAL NOT TO BE USED FOR CONSTRUCTION	A1
1 ISSUED FOR CLIENT REVIEW	23-06-23			THIS DRAWING CANNOT BE COPIE	ED OR REPRODUCED IN ANY FORM	LONGITUDINAL SECTION	Project - Drawing No.	Issue
Issue Description	Date			OR USED FOR ANY OTHER PURPO INTENDED WITHOUT THE WI	SE OTHER THAN THAT ORIGINALLY RITTEN PERMISSION OF AT&L	SHEET 1	20-748-C11052	5
100r	mm on Original	•				F:\20-748 ESR Mamre\6.0 Drgs\Civil\Final	\\SSDA\11000_INFRA_STAGE-1\20-748-C110	52.dwg

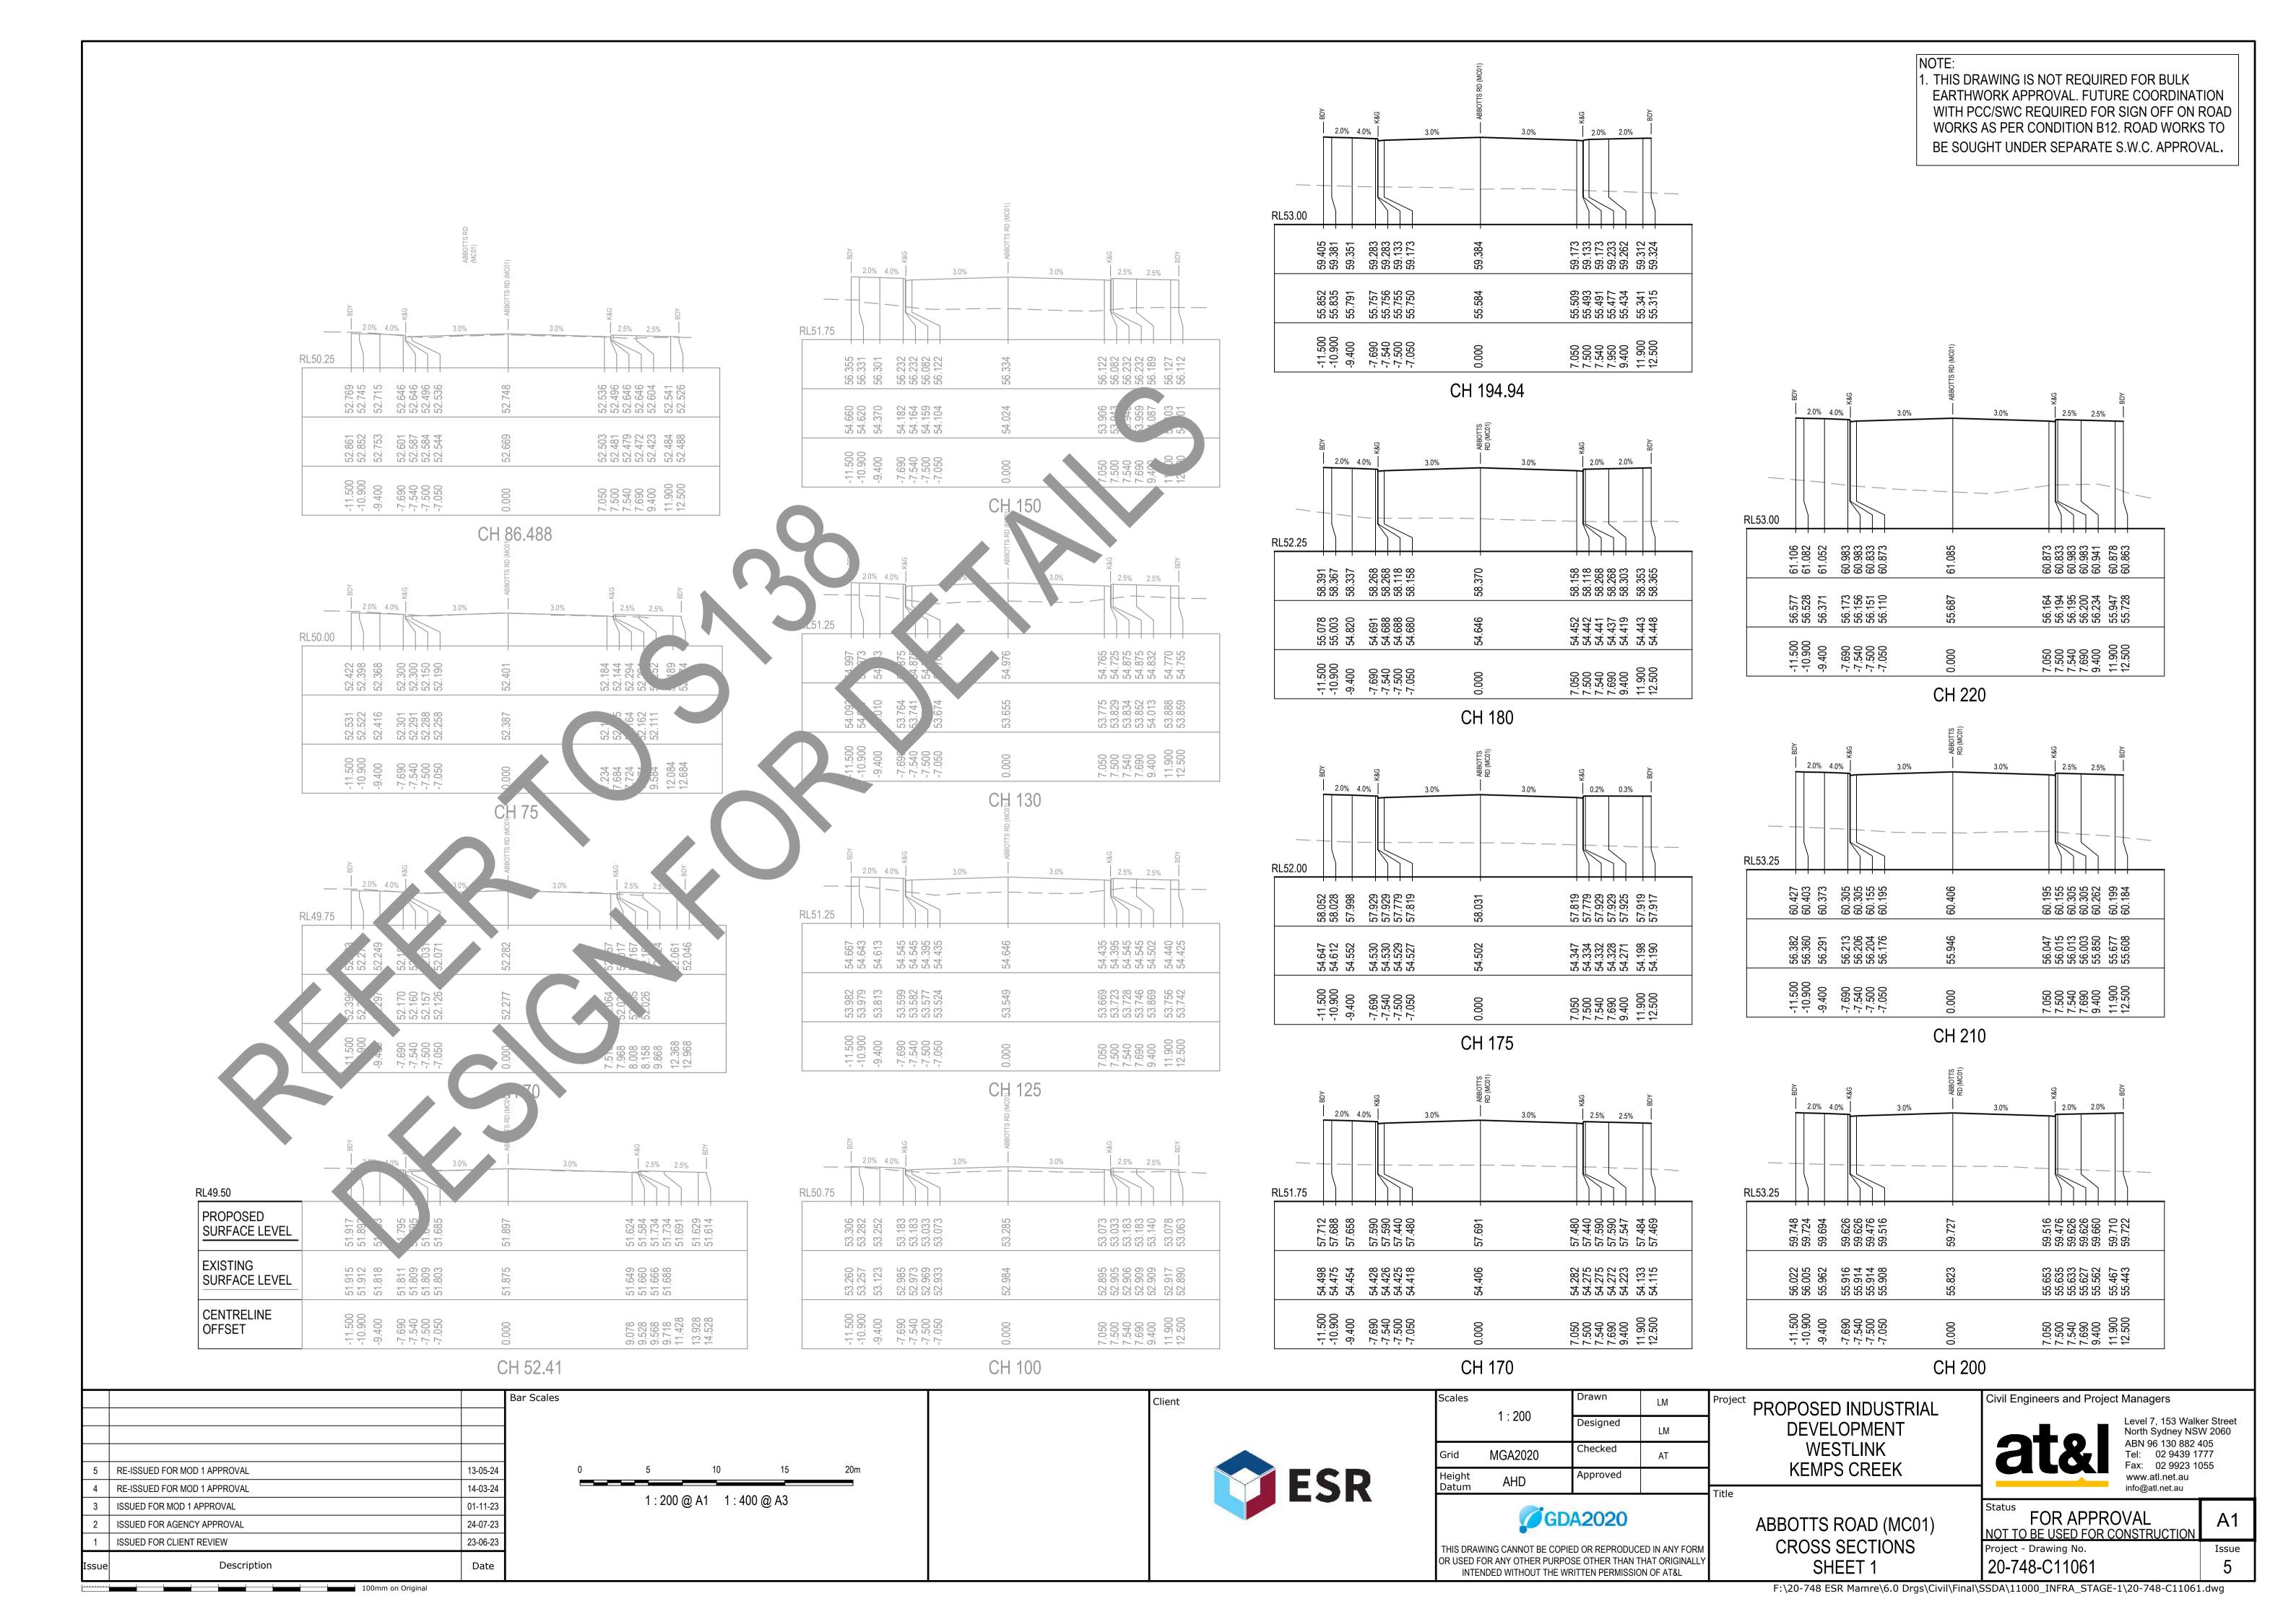

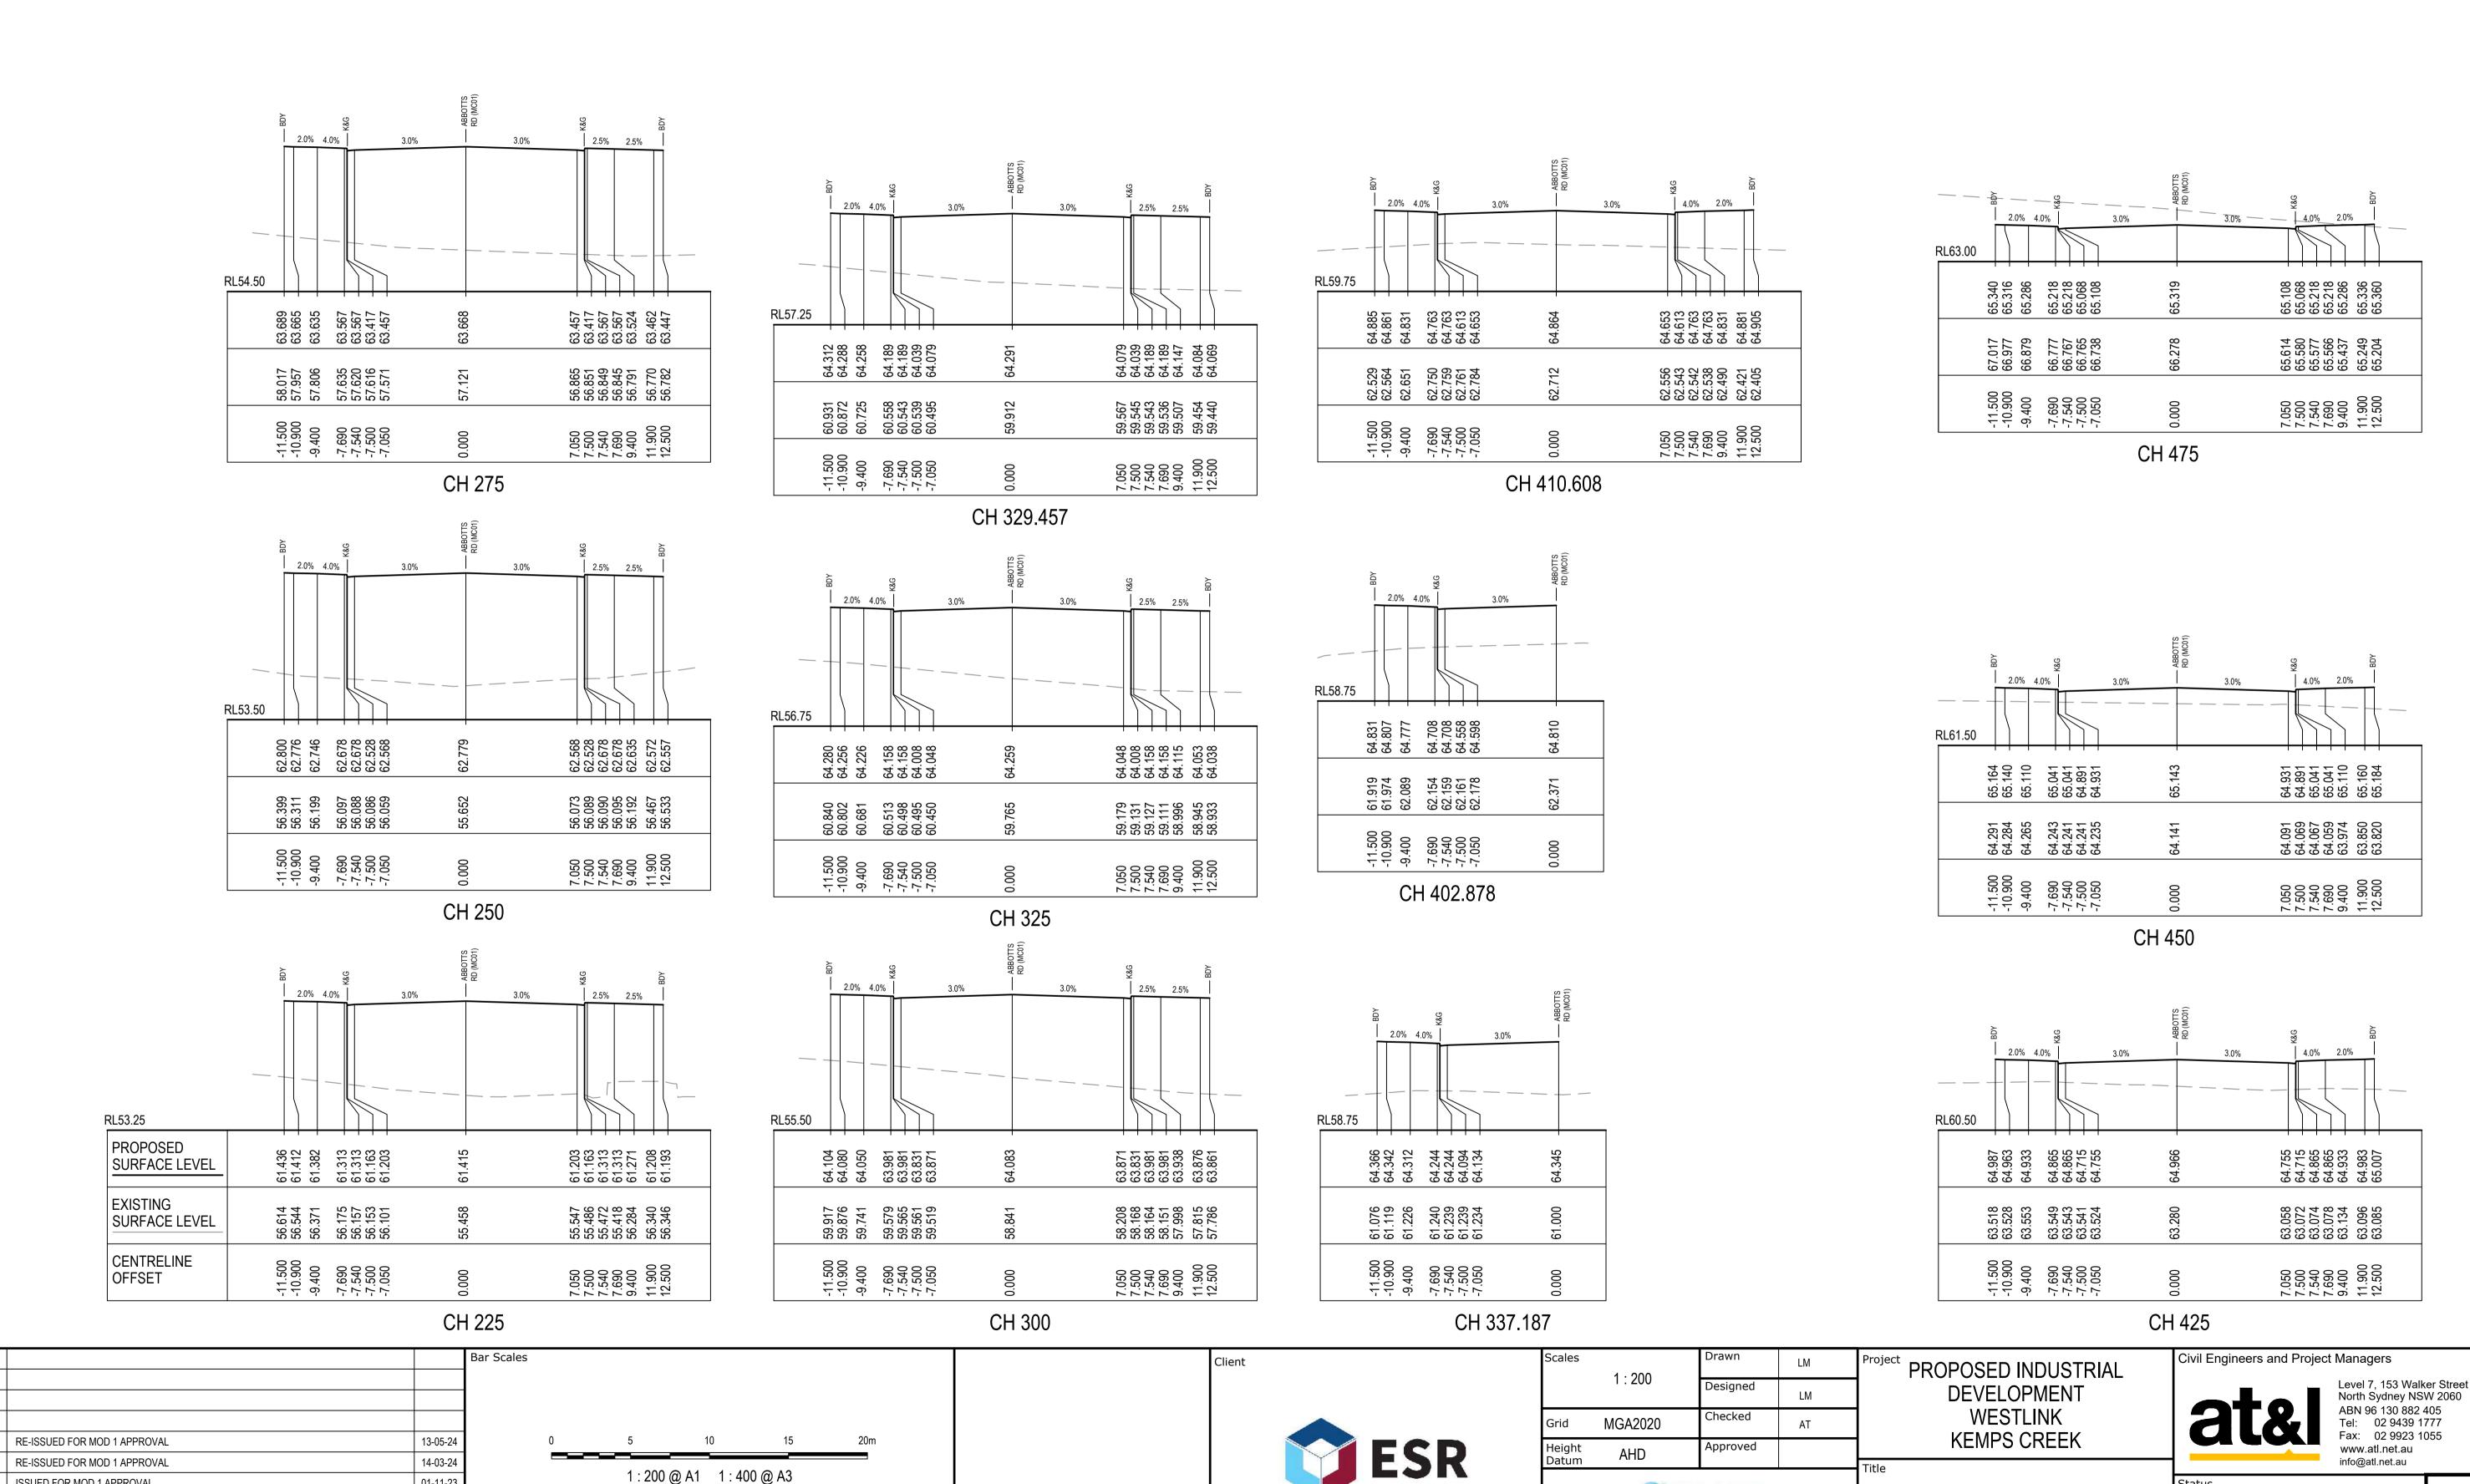

ISSUED FOR MOD 1 APPROVAL

ISSUED FOR CLIENT REVIEW

ISSUED FOR AGENCY APPROVAL

Description

100mm on Original

01-11-23

24-07-23

23-06-23

' Date -

Project - Drawing No.

20-748-C11062

ABBOTTS ROAD (MC01)

CROSS SECTIONS

SHEET 2

FOR APPROVAL

NOT TO BE USED FOR CONSTRUCTION

A1


Issue

GDA2020


THIS DRAWING CANNOT BE COPIED OR REPRODUCED IN ANY FORM


OR USED FOR ANY OTHER PURPOSE OTHER THAN THAT ORIGINALLY


INTENDED WITHOUT THE WRITTEN PERMISSION OF AT&L

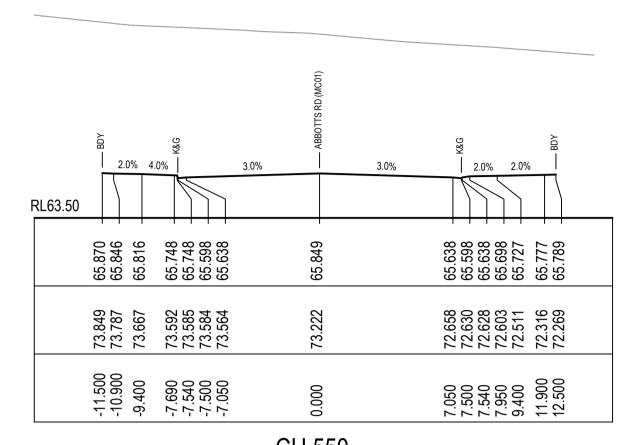


CH 550

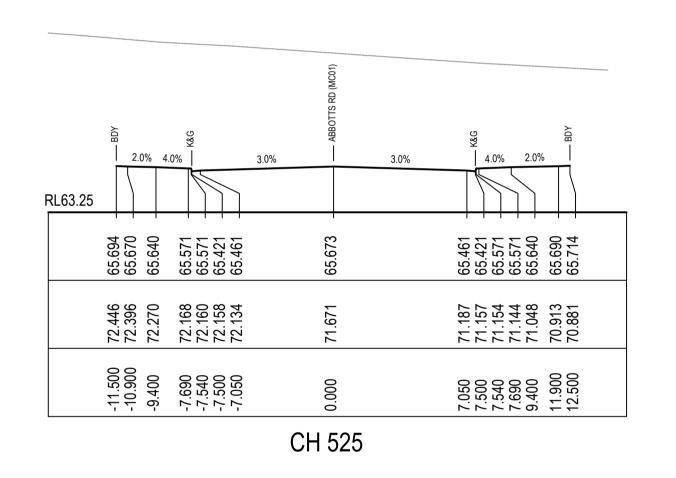

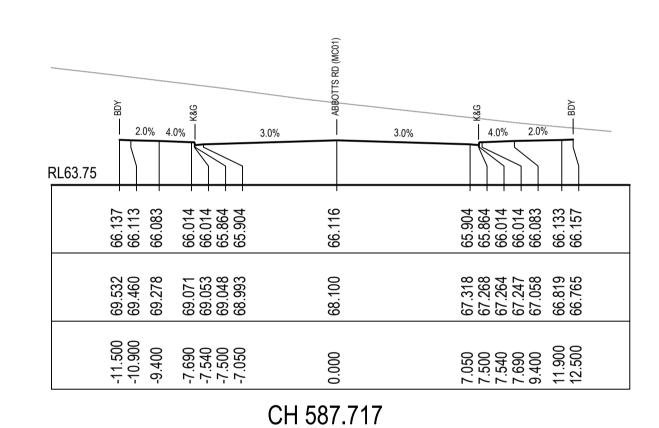

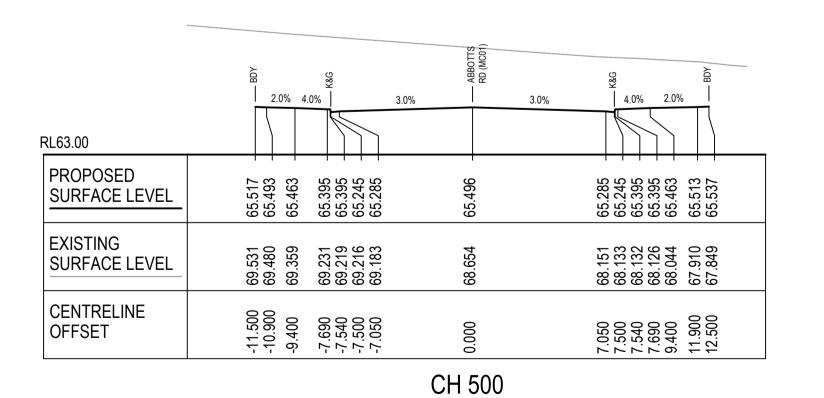

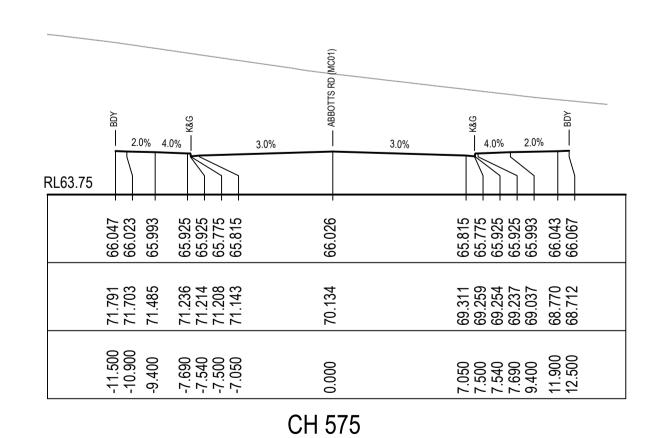

Client

5	RE-ISSUED FOR MOD 1 APPROVAL	13-05-24
4	RE-ISSUED FOR MOD 1 APPROVAL	14-03-24
3	ISSUED FOR MOD 1 APPROVAL	01-11-23
2	ISSUED FOR AGENCY APPROVAL	24-07-23
1	ISSUED FOR CLIENT REVIEW	23-06-23
Issue	Description	Date

100mm on Original

0 5 10 15 20m 1 : 200 @ A1 1 : 400 @ A3

ESR

Scales	1 - 200	Drawn	LM	Proj
	1 : 200	Designed	LM	
Grid	MGA2020	Checked	AT	
Height Datum	AHD	Approved		

GDA2020

THIS DRAWING CANNOT BE COPIED OR REPRODUCED IN ANY FORM
OR USED FOR ANY OTHER PURPOSE OTHER THAN THAT ORIGINALLY
INTENDED WITHOUT THE WRITTEN PERMISSION OF AT&L


ect	PROPOSED INDUSTRIAL
	DEVELOPMENT
	WESTLINK
	KEMPS CREEK


ABBOTTS ROAD (MC01)
CROSS SECTIONS
SHEET 3


Civil Engineers and Pro	ject Managers
ata	Level 7, 153 North Sydney ABN 96 130 Tel: 02 94


Level 7, 153 Walker Street North Sydney NSW 2060 ABN 96 130 882 405 Tel: 02 9439 1777 Fax: 02 9923 1055 www.atl.net.au info@atl.net.au


	FOR APPROVAL NOT TO BE USED FOR CONSTRUCTION	A1
- 1	Project - Drawing No.	Issue
	20-748-C11063	5

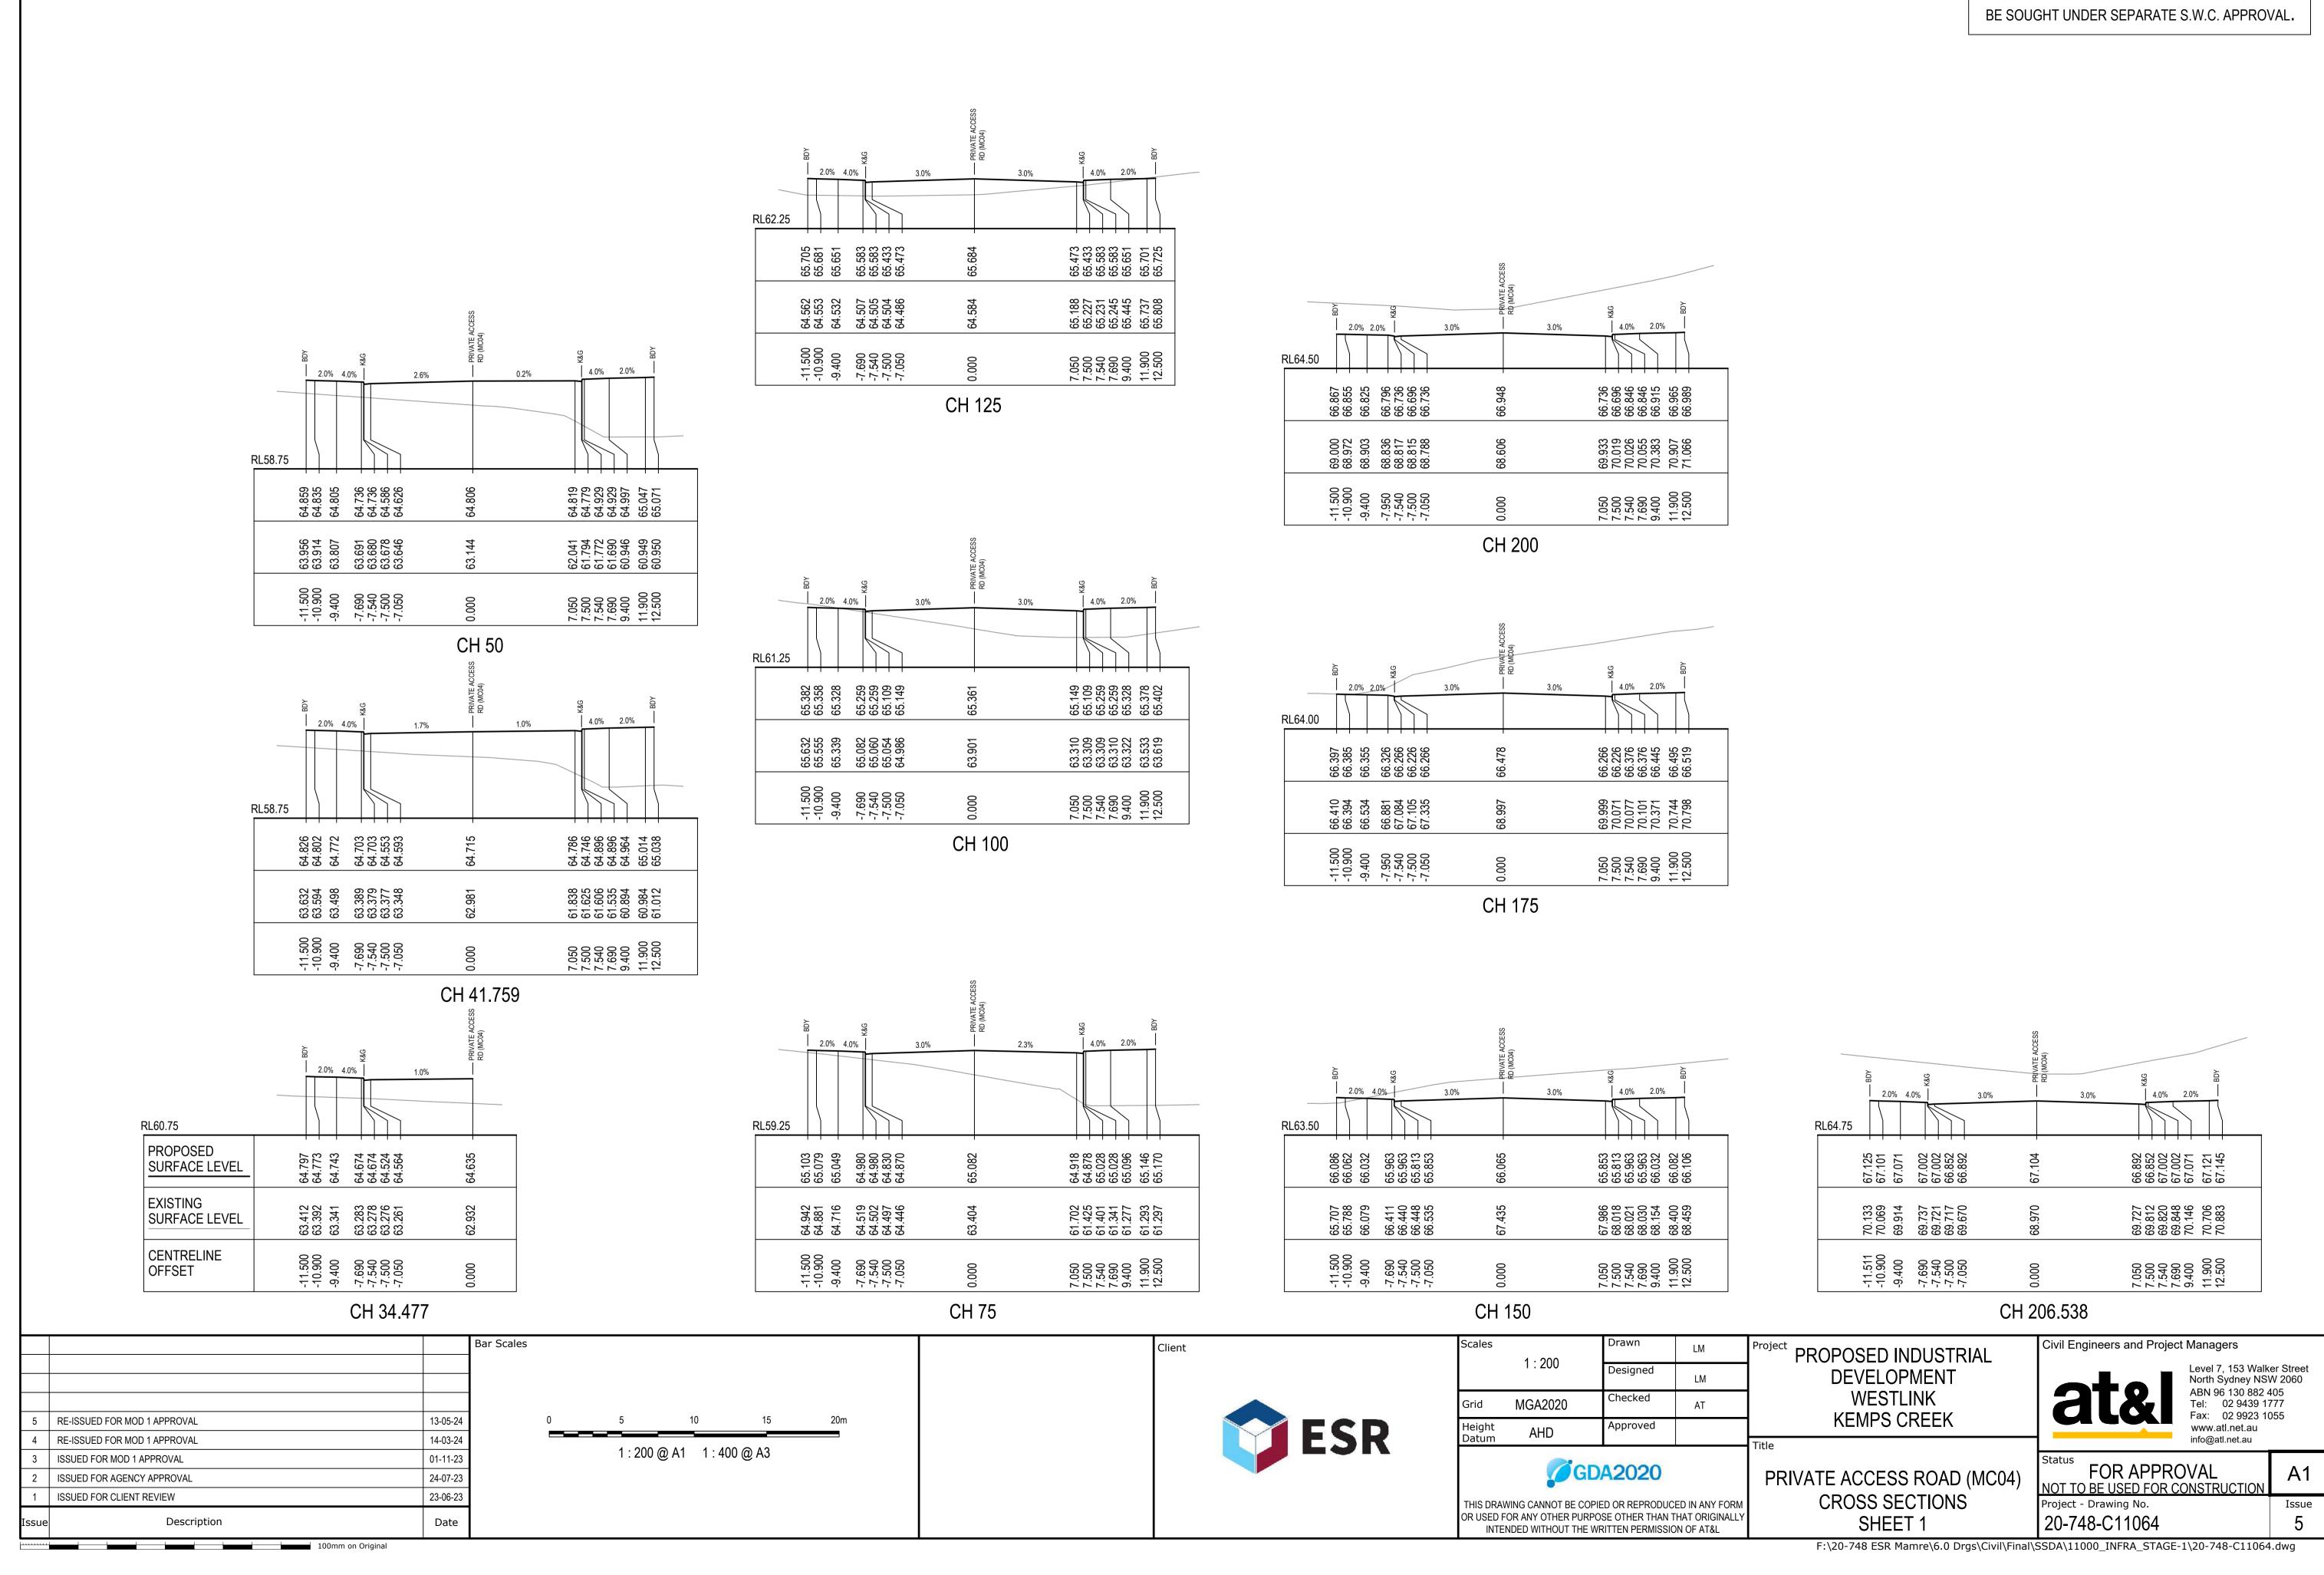


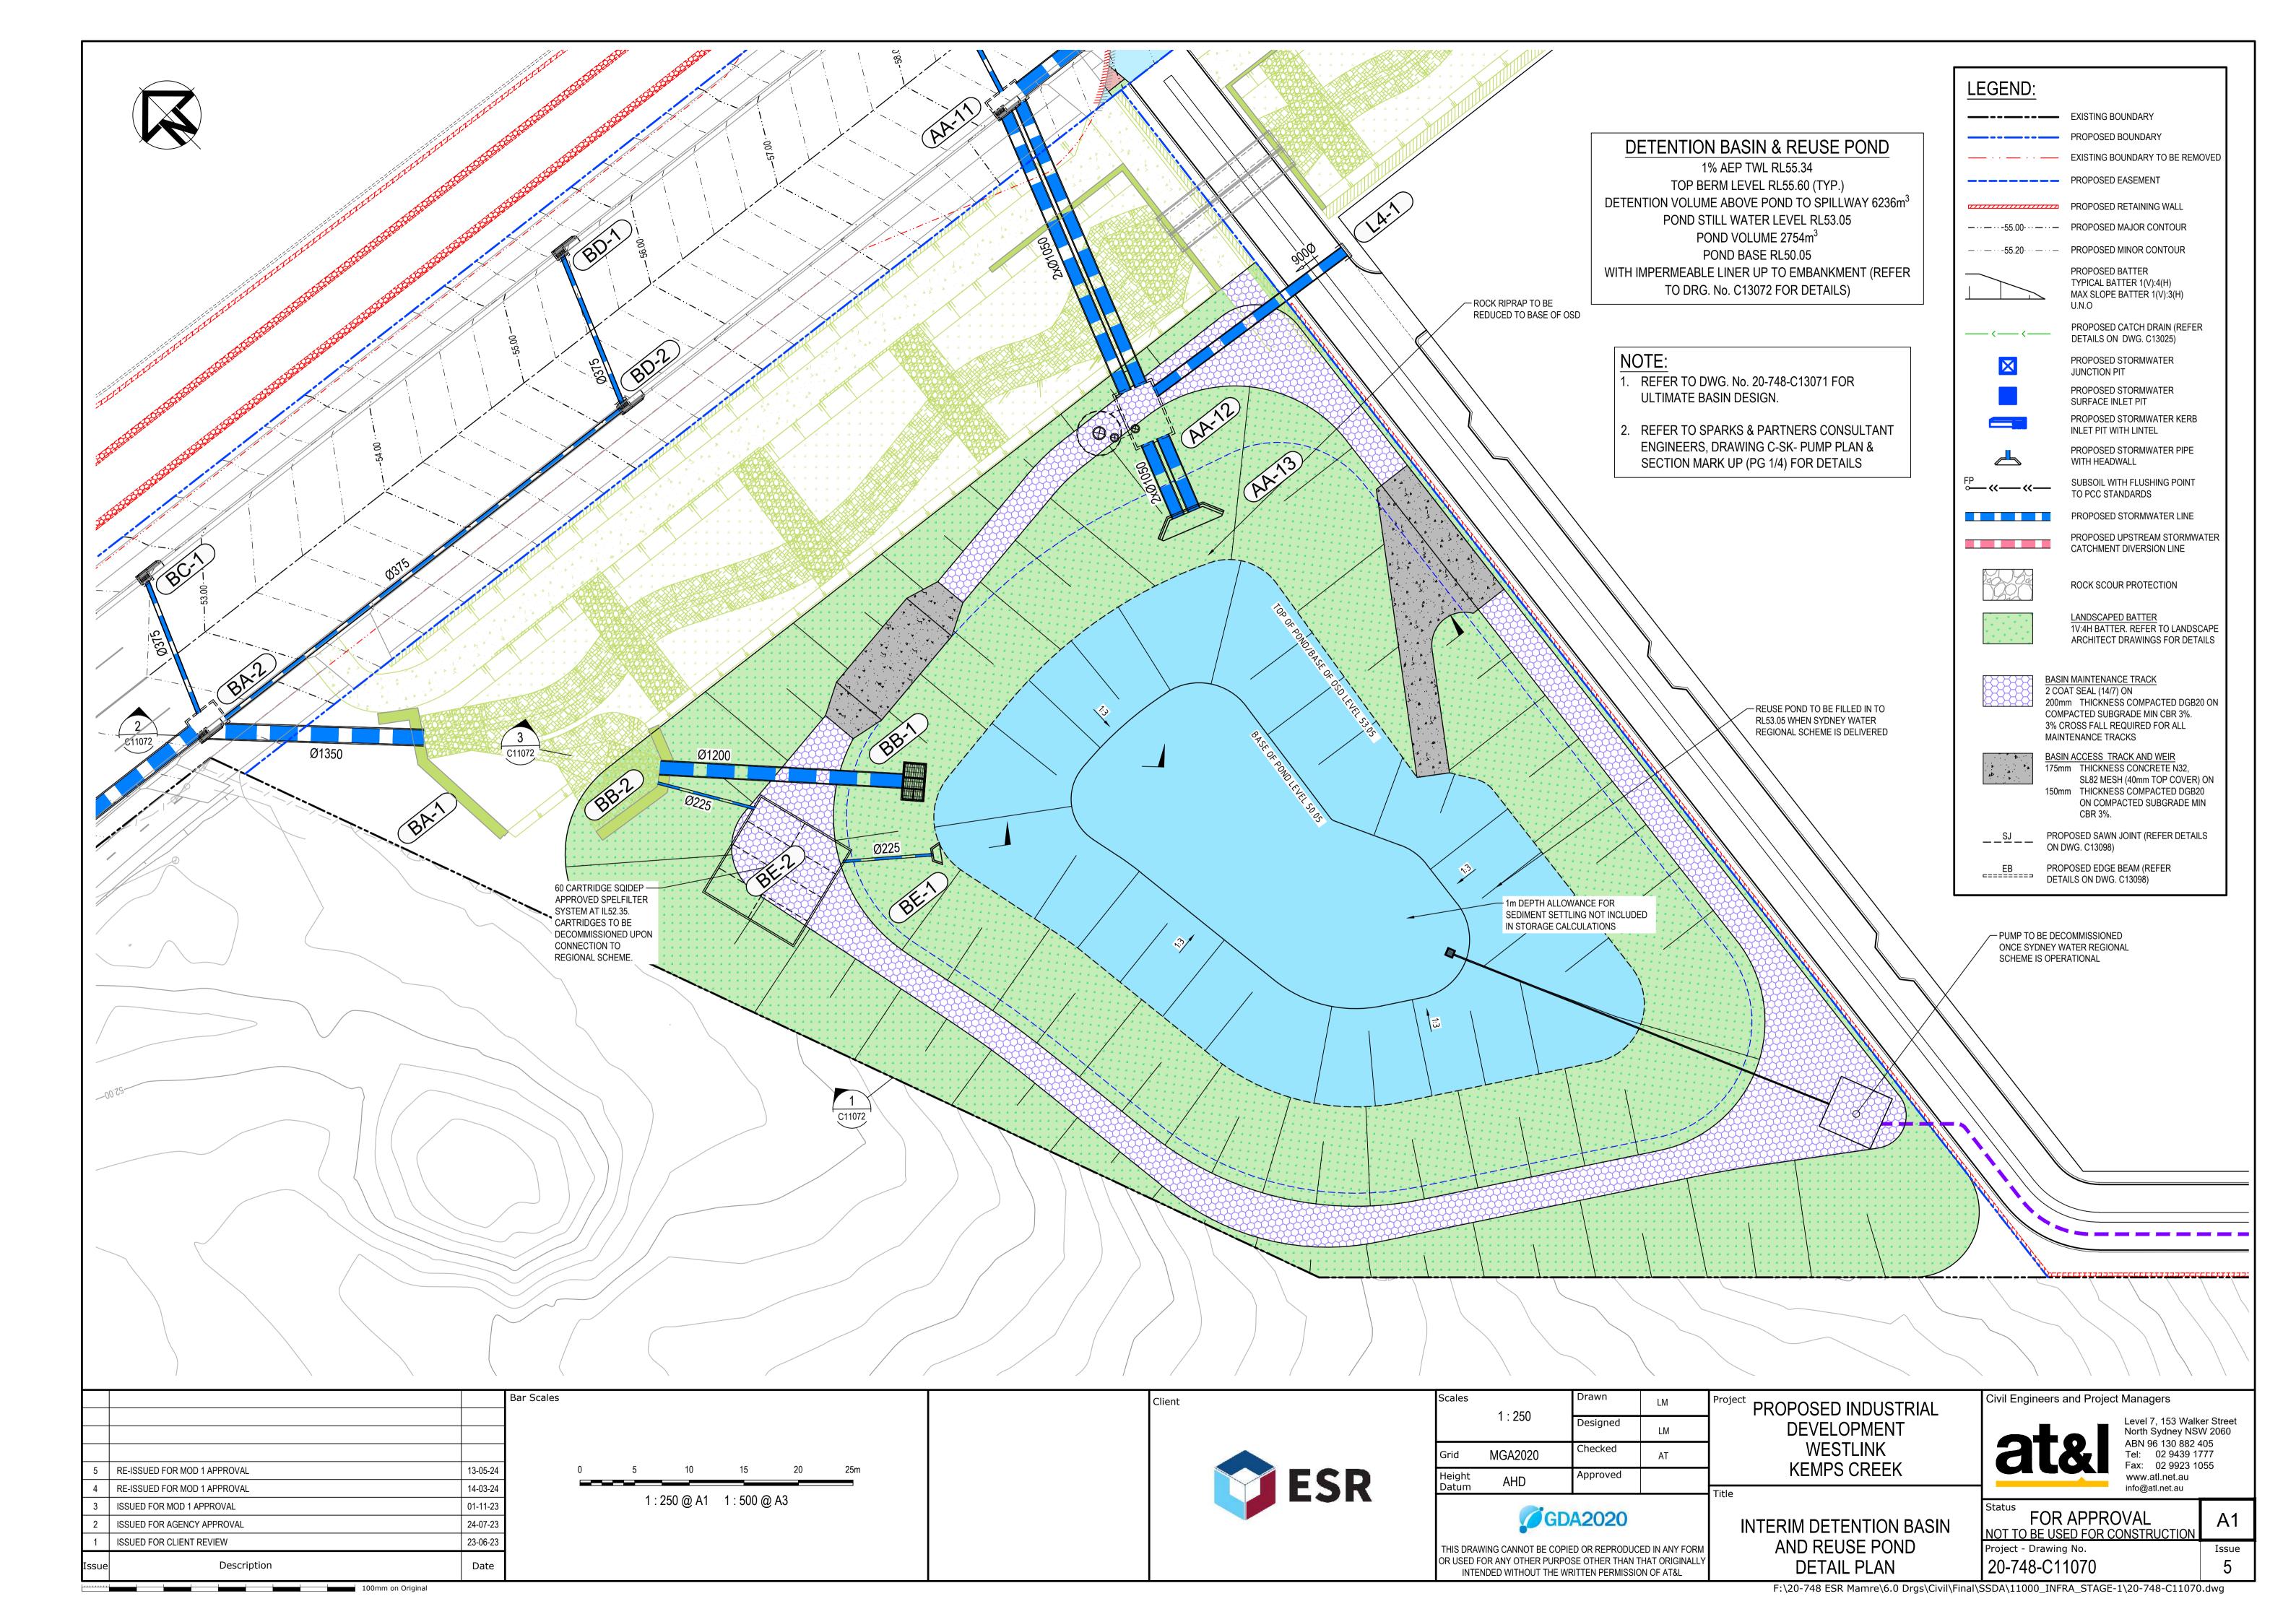


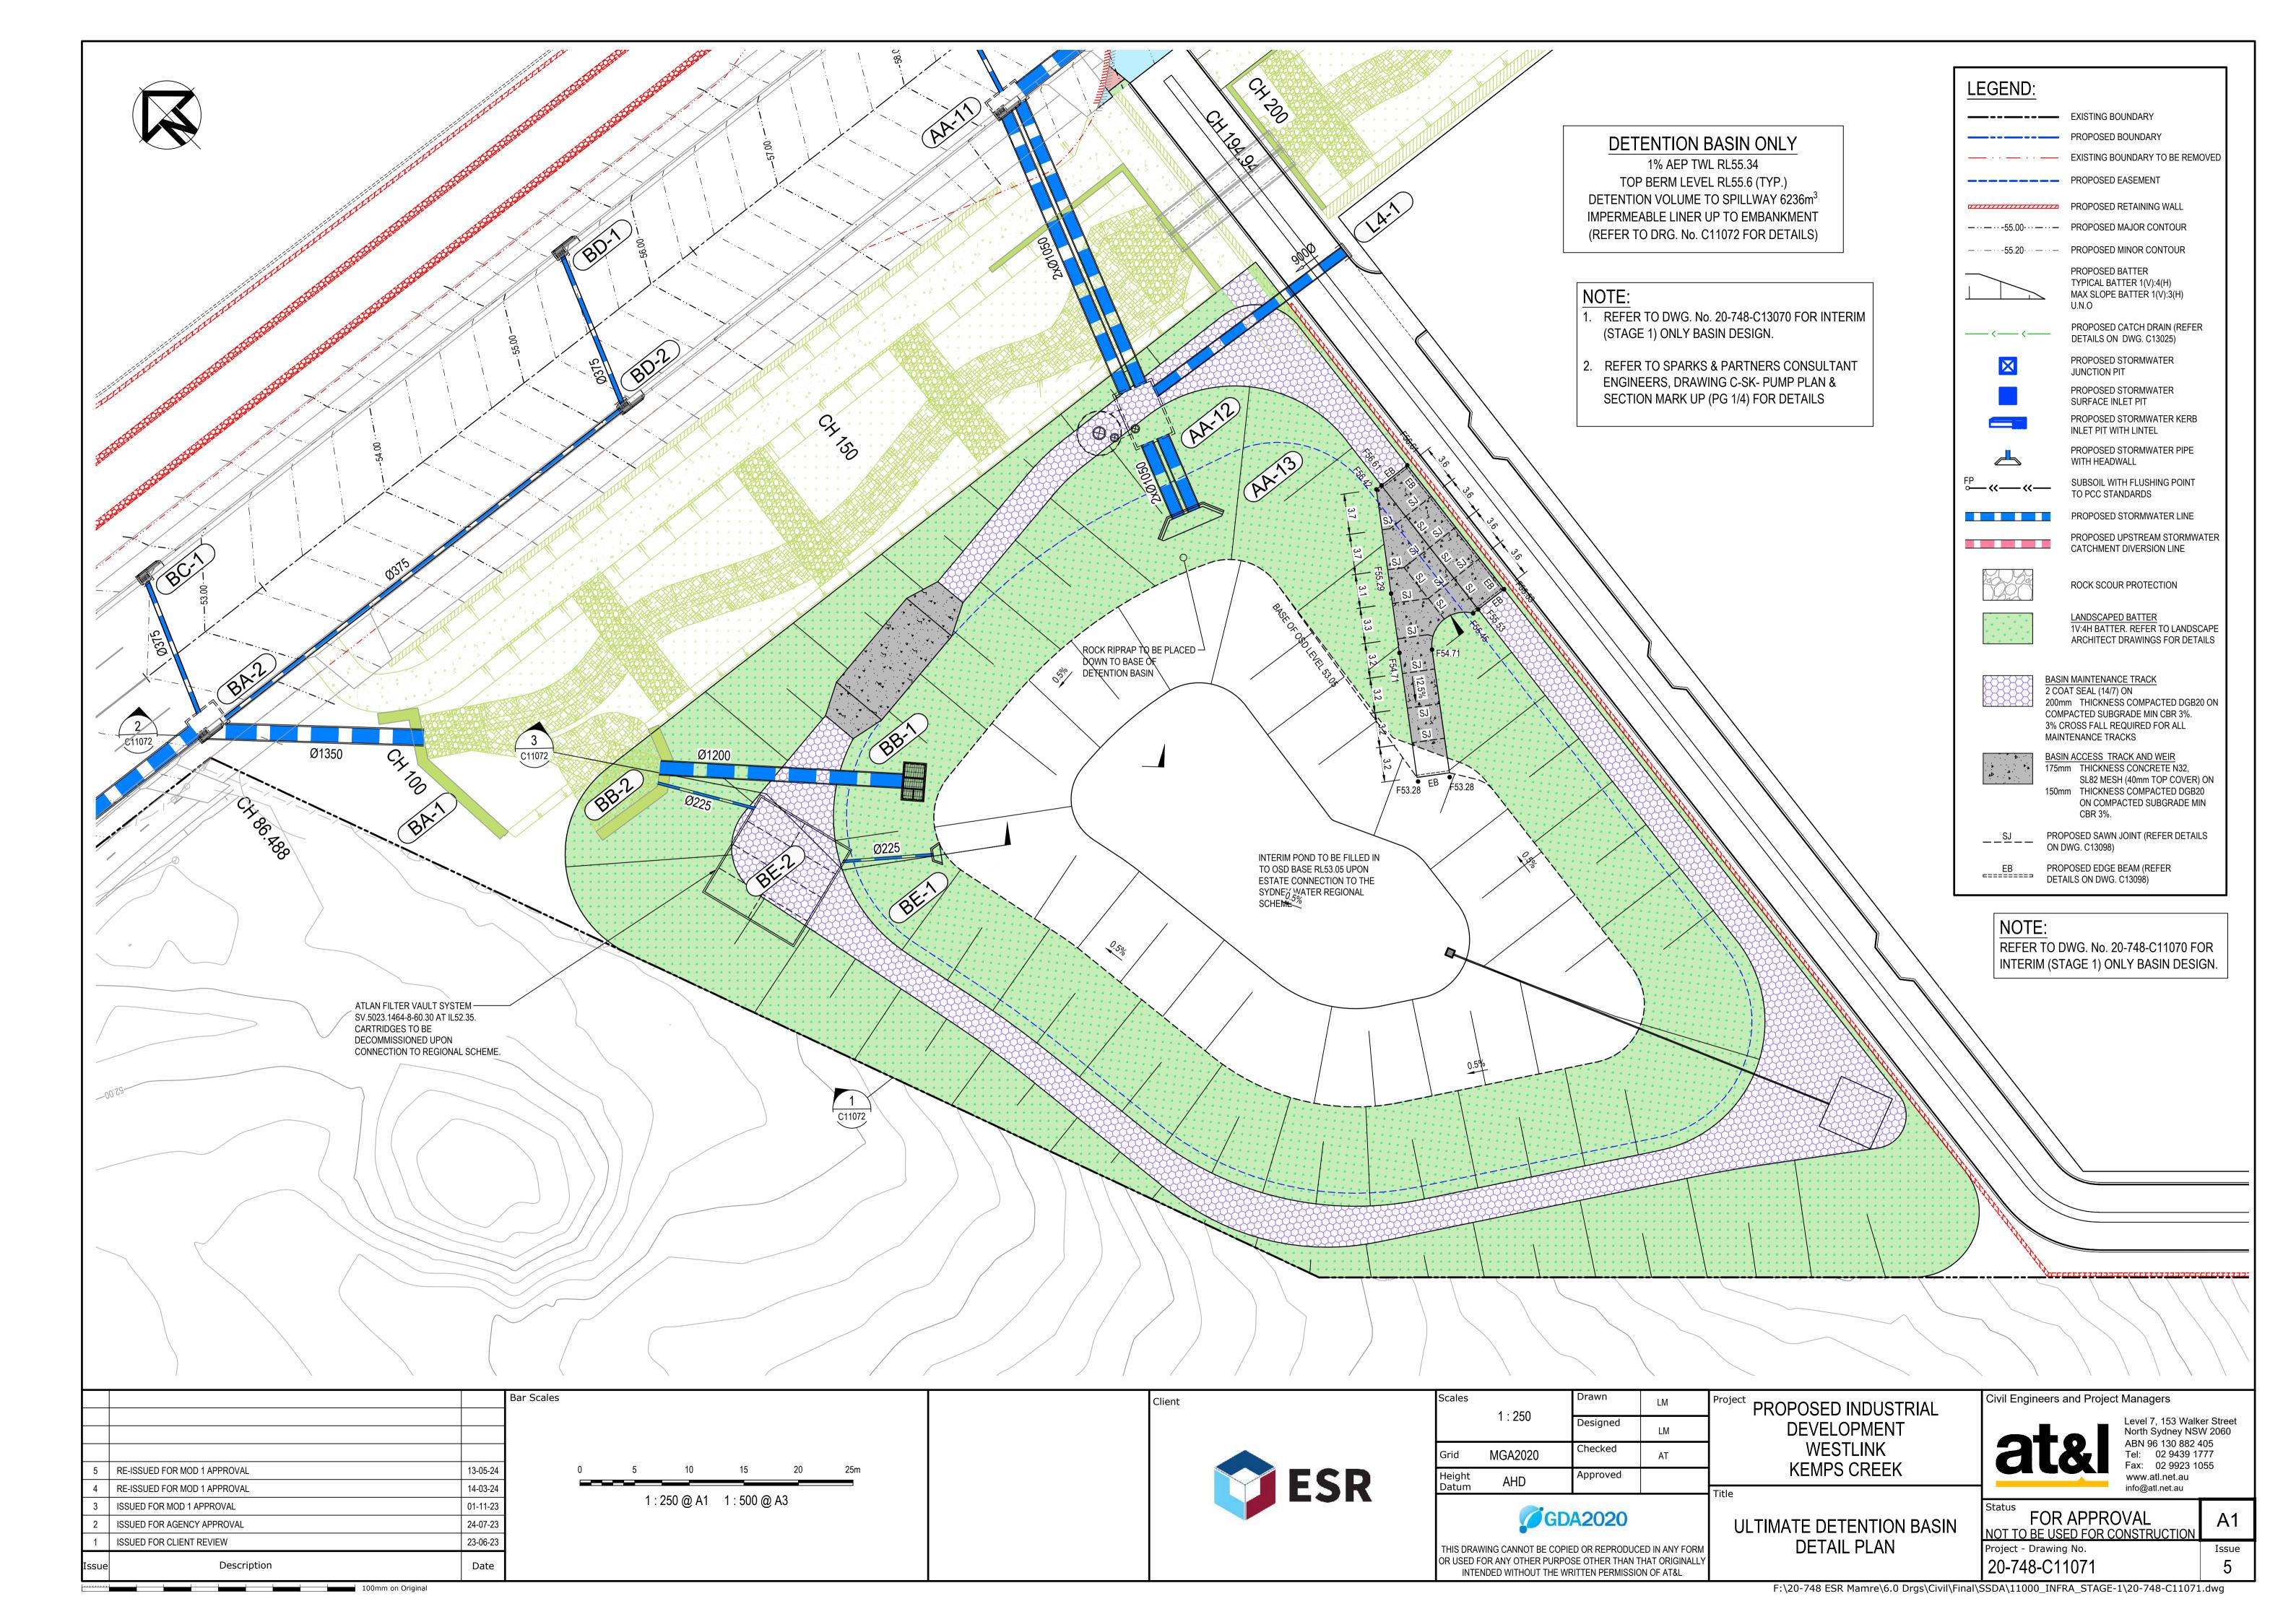


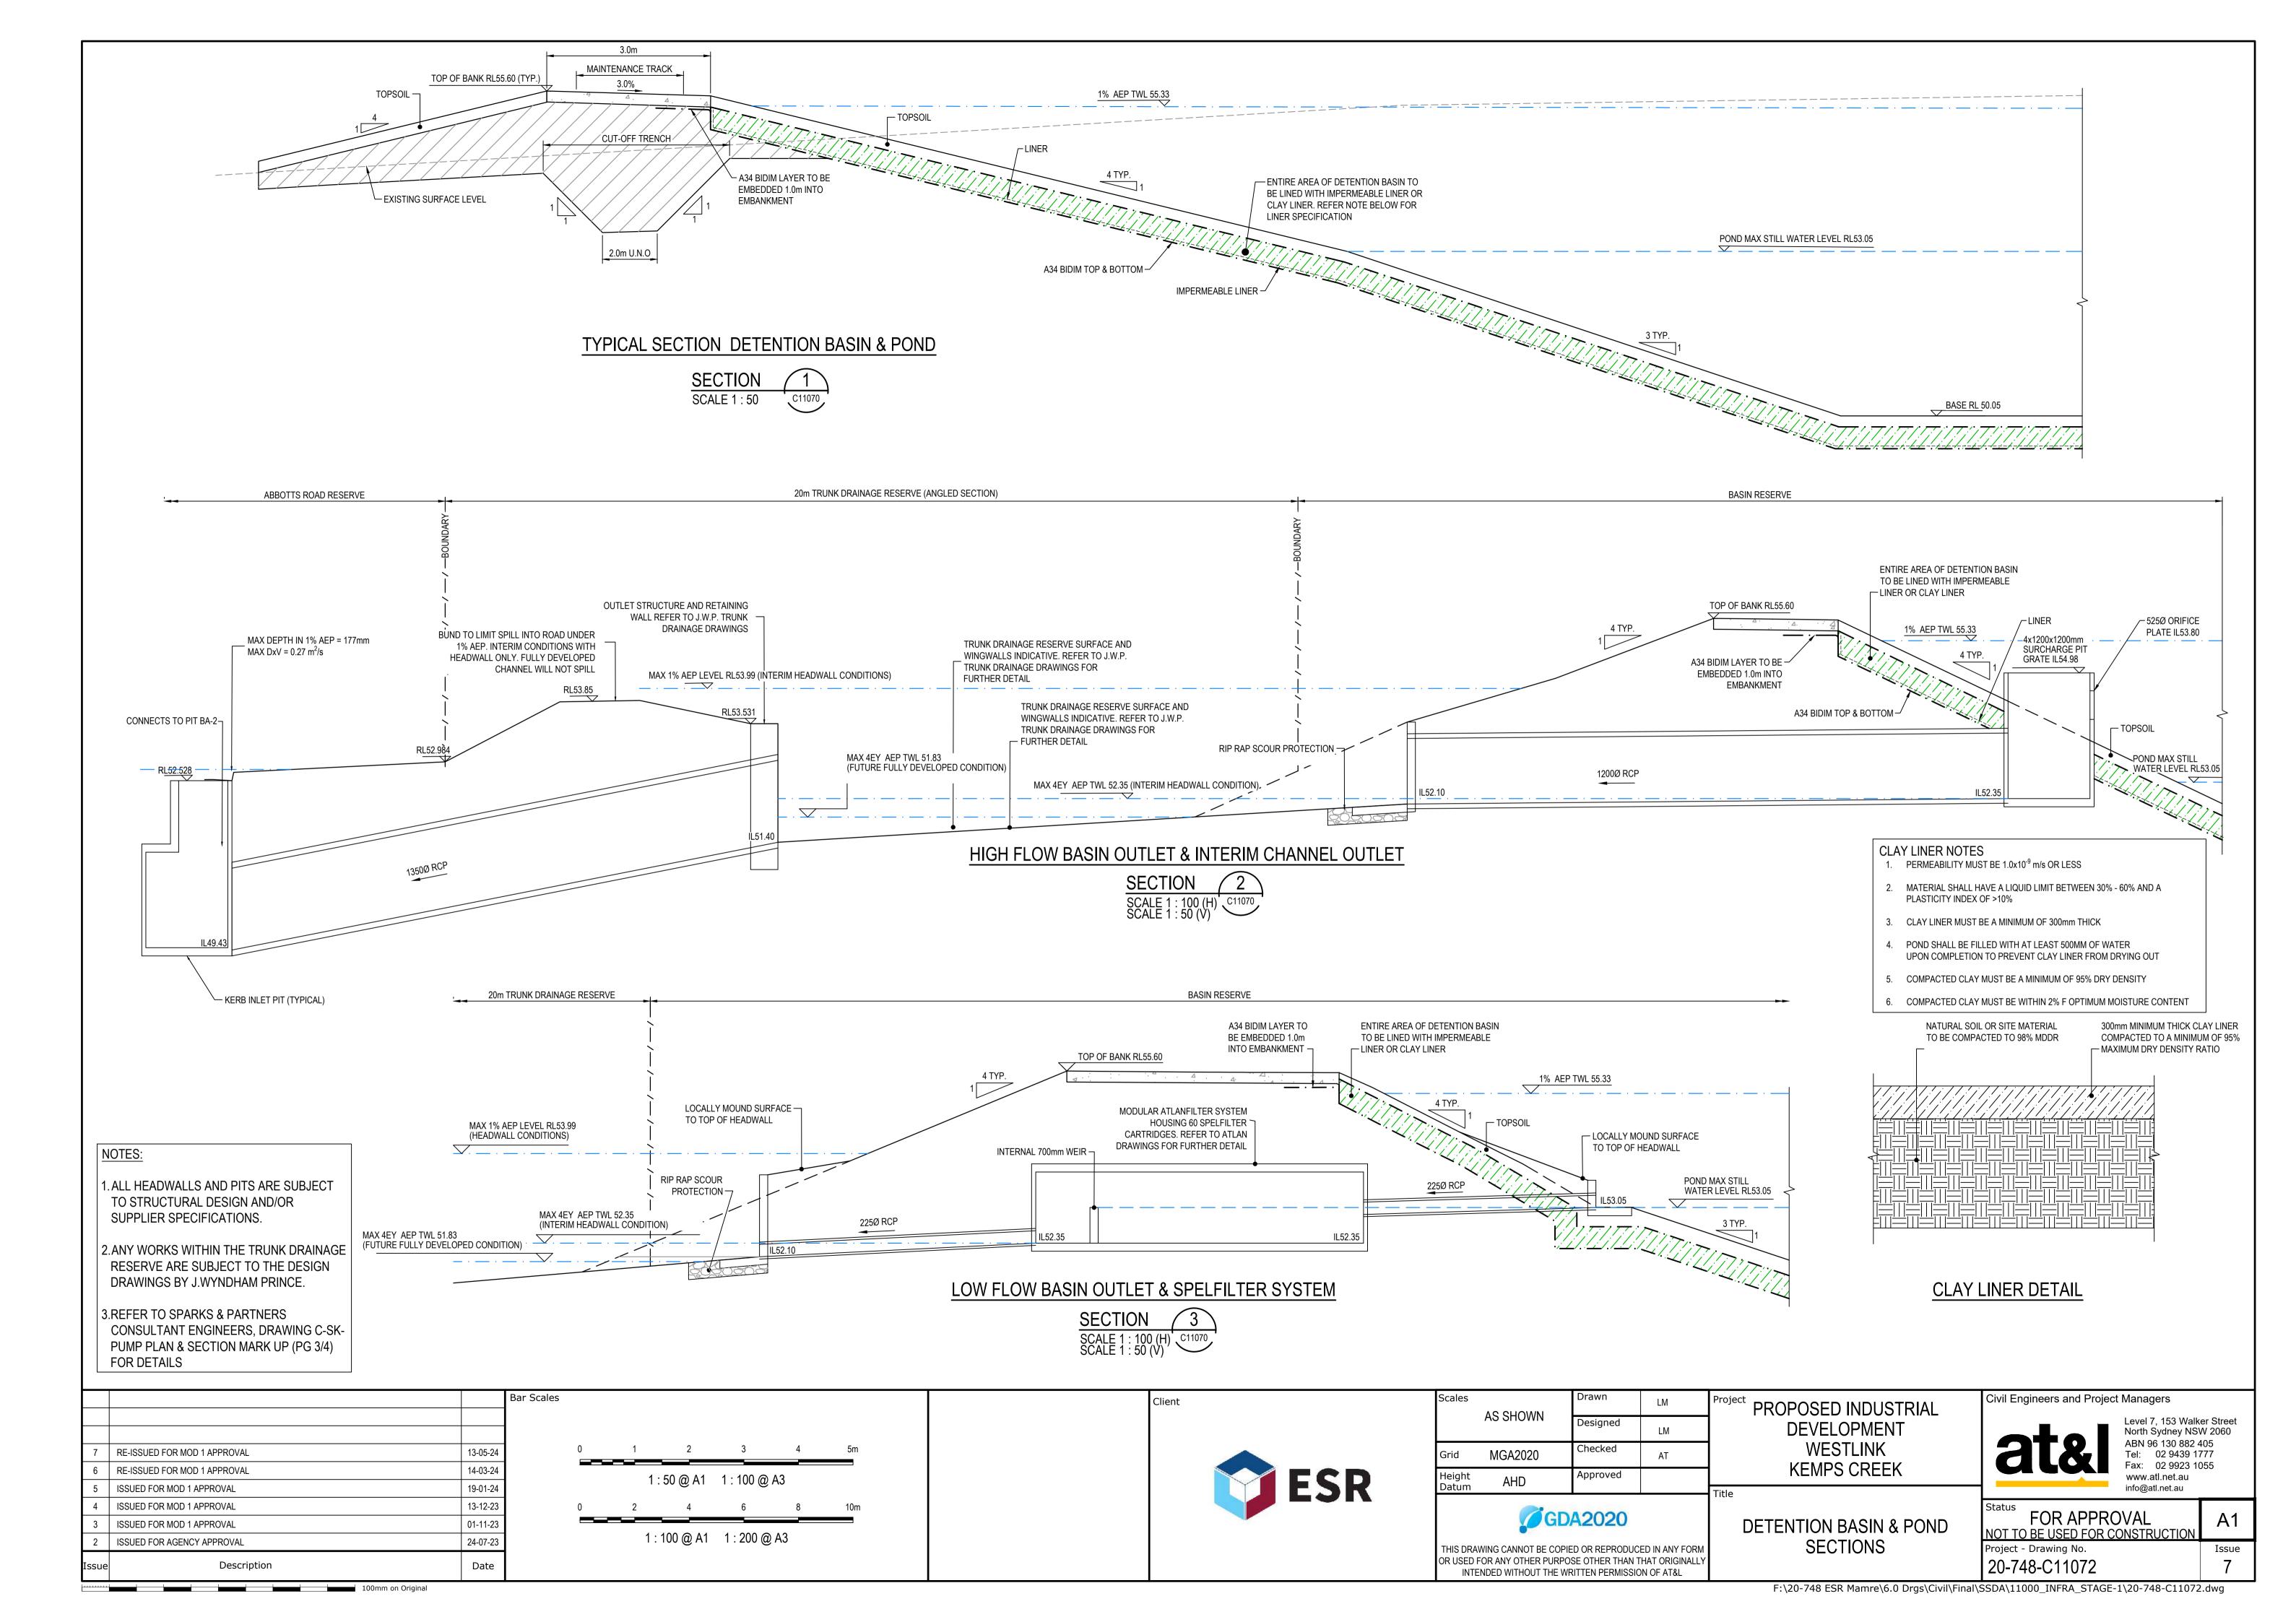


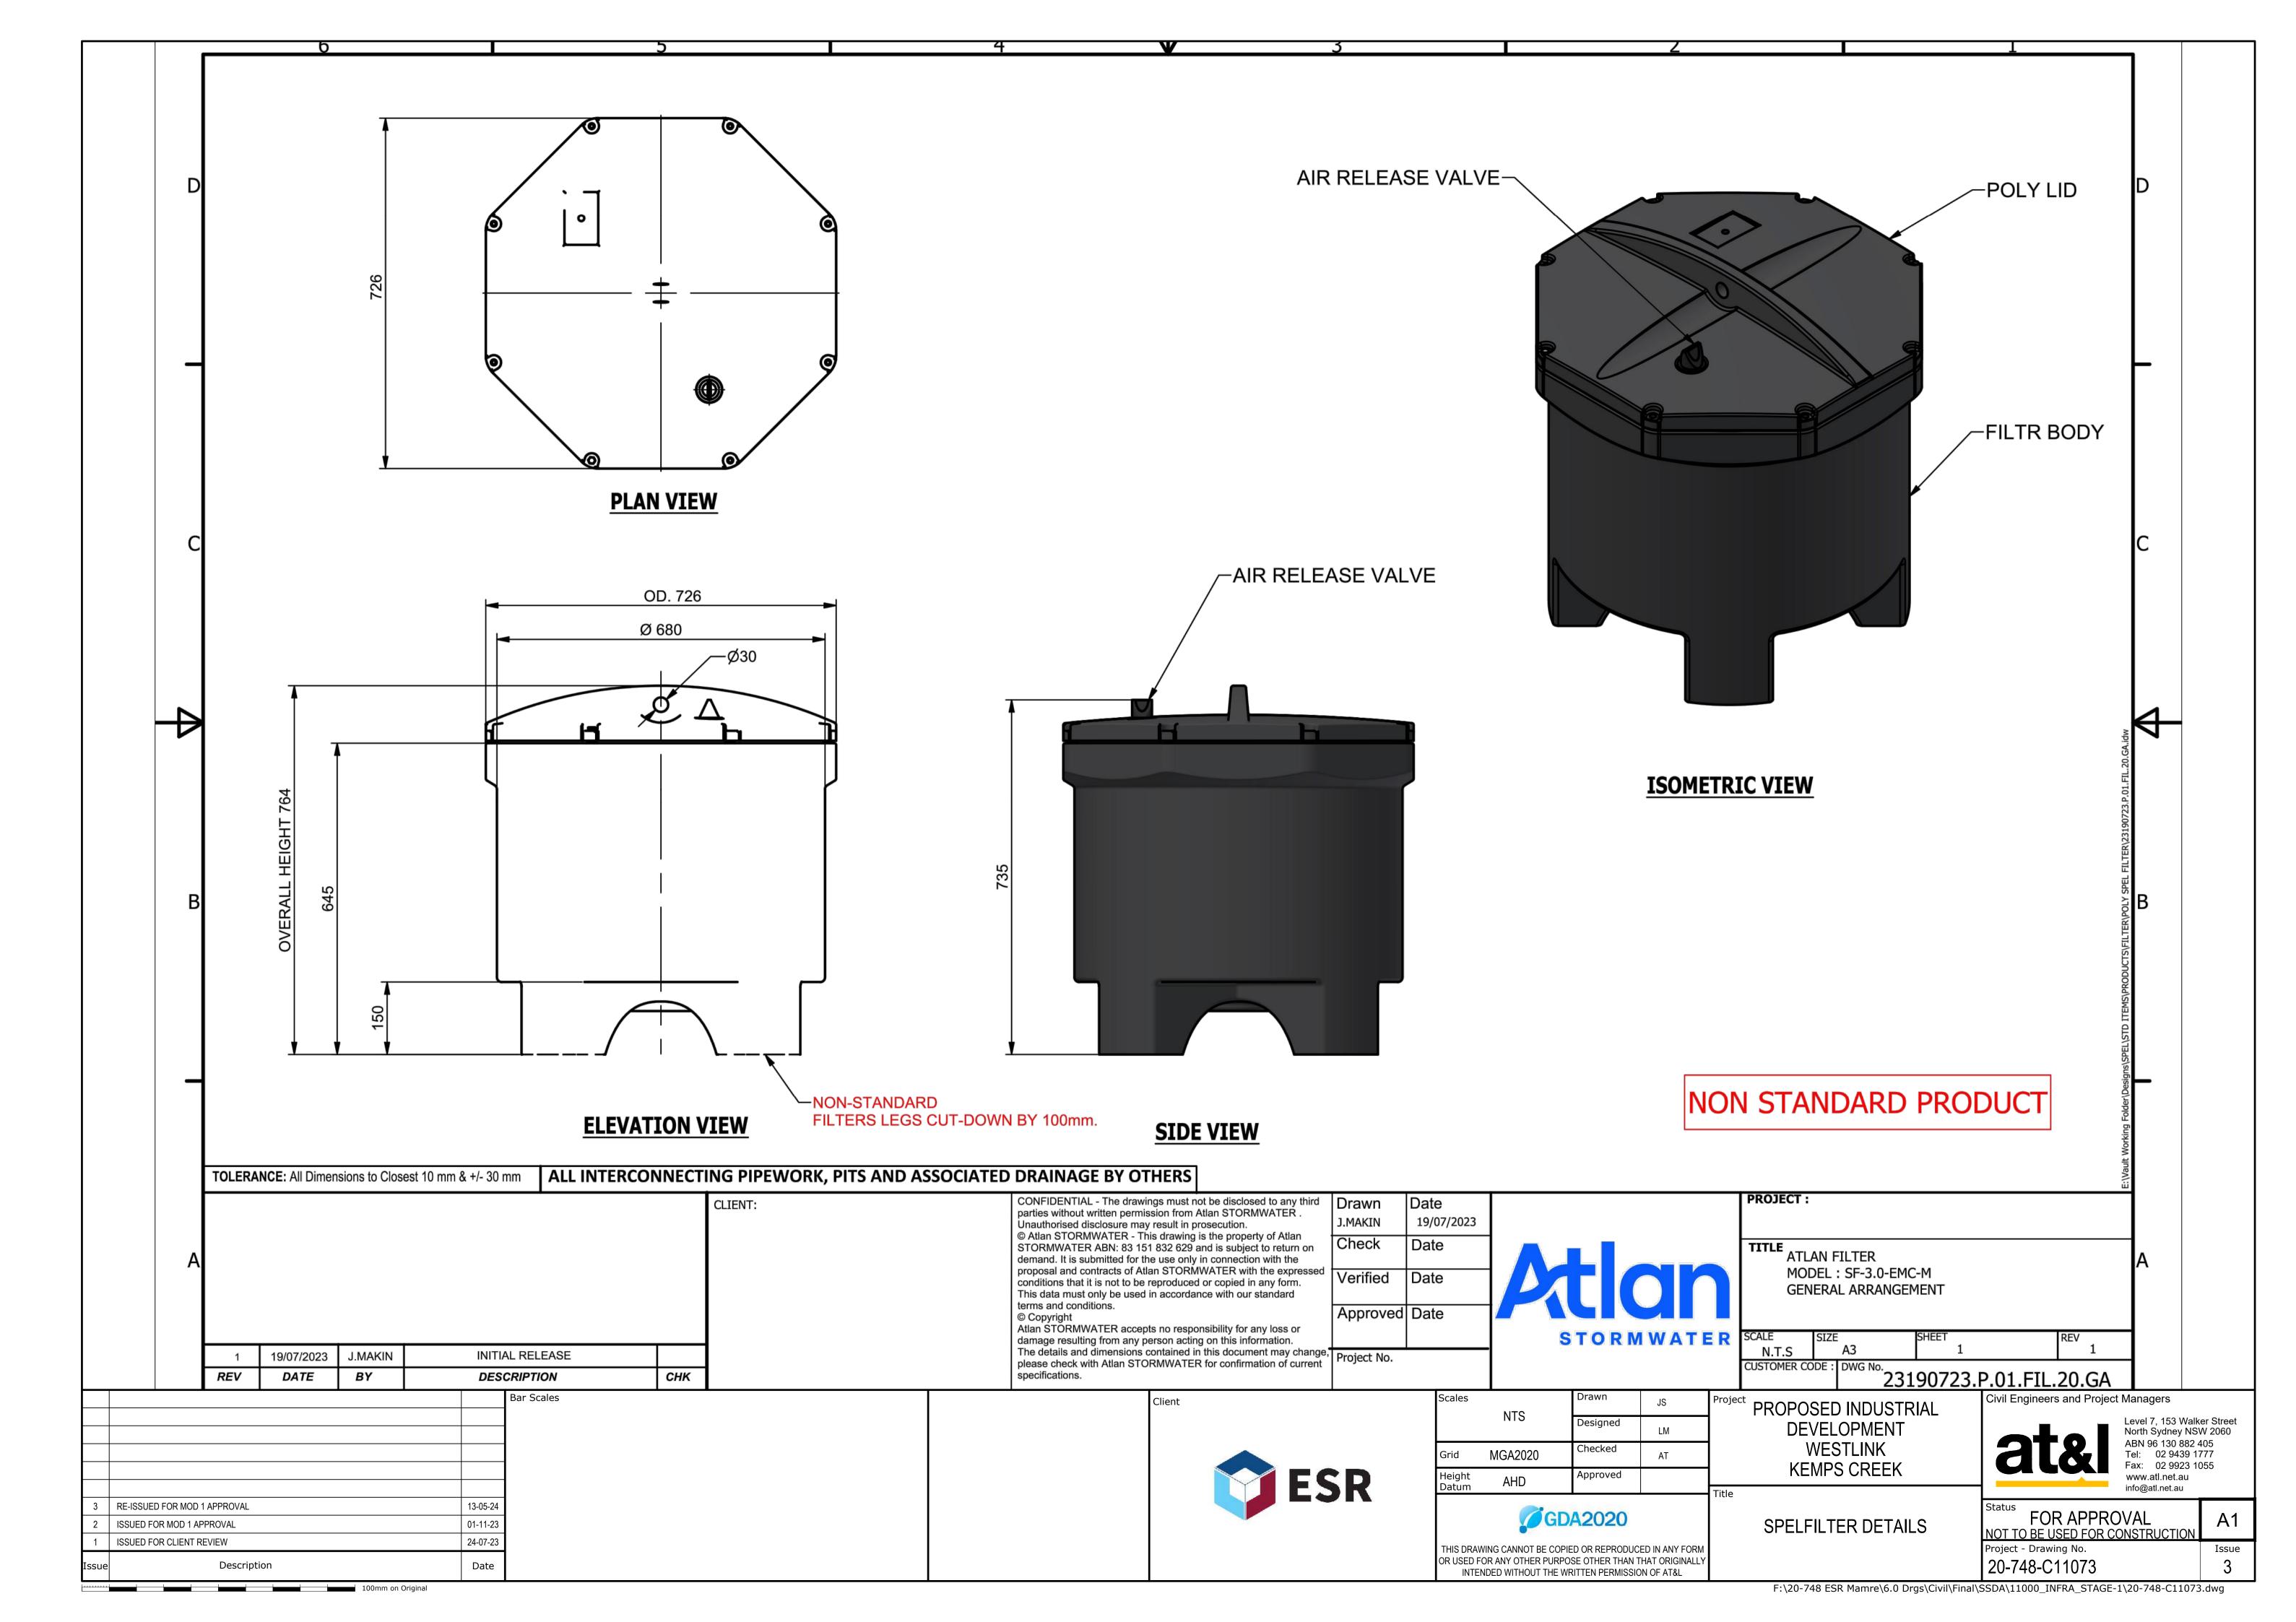


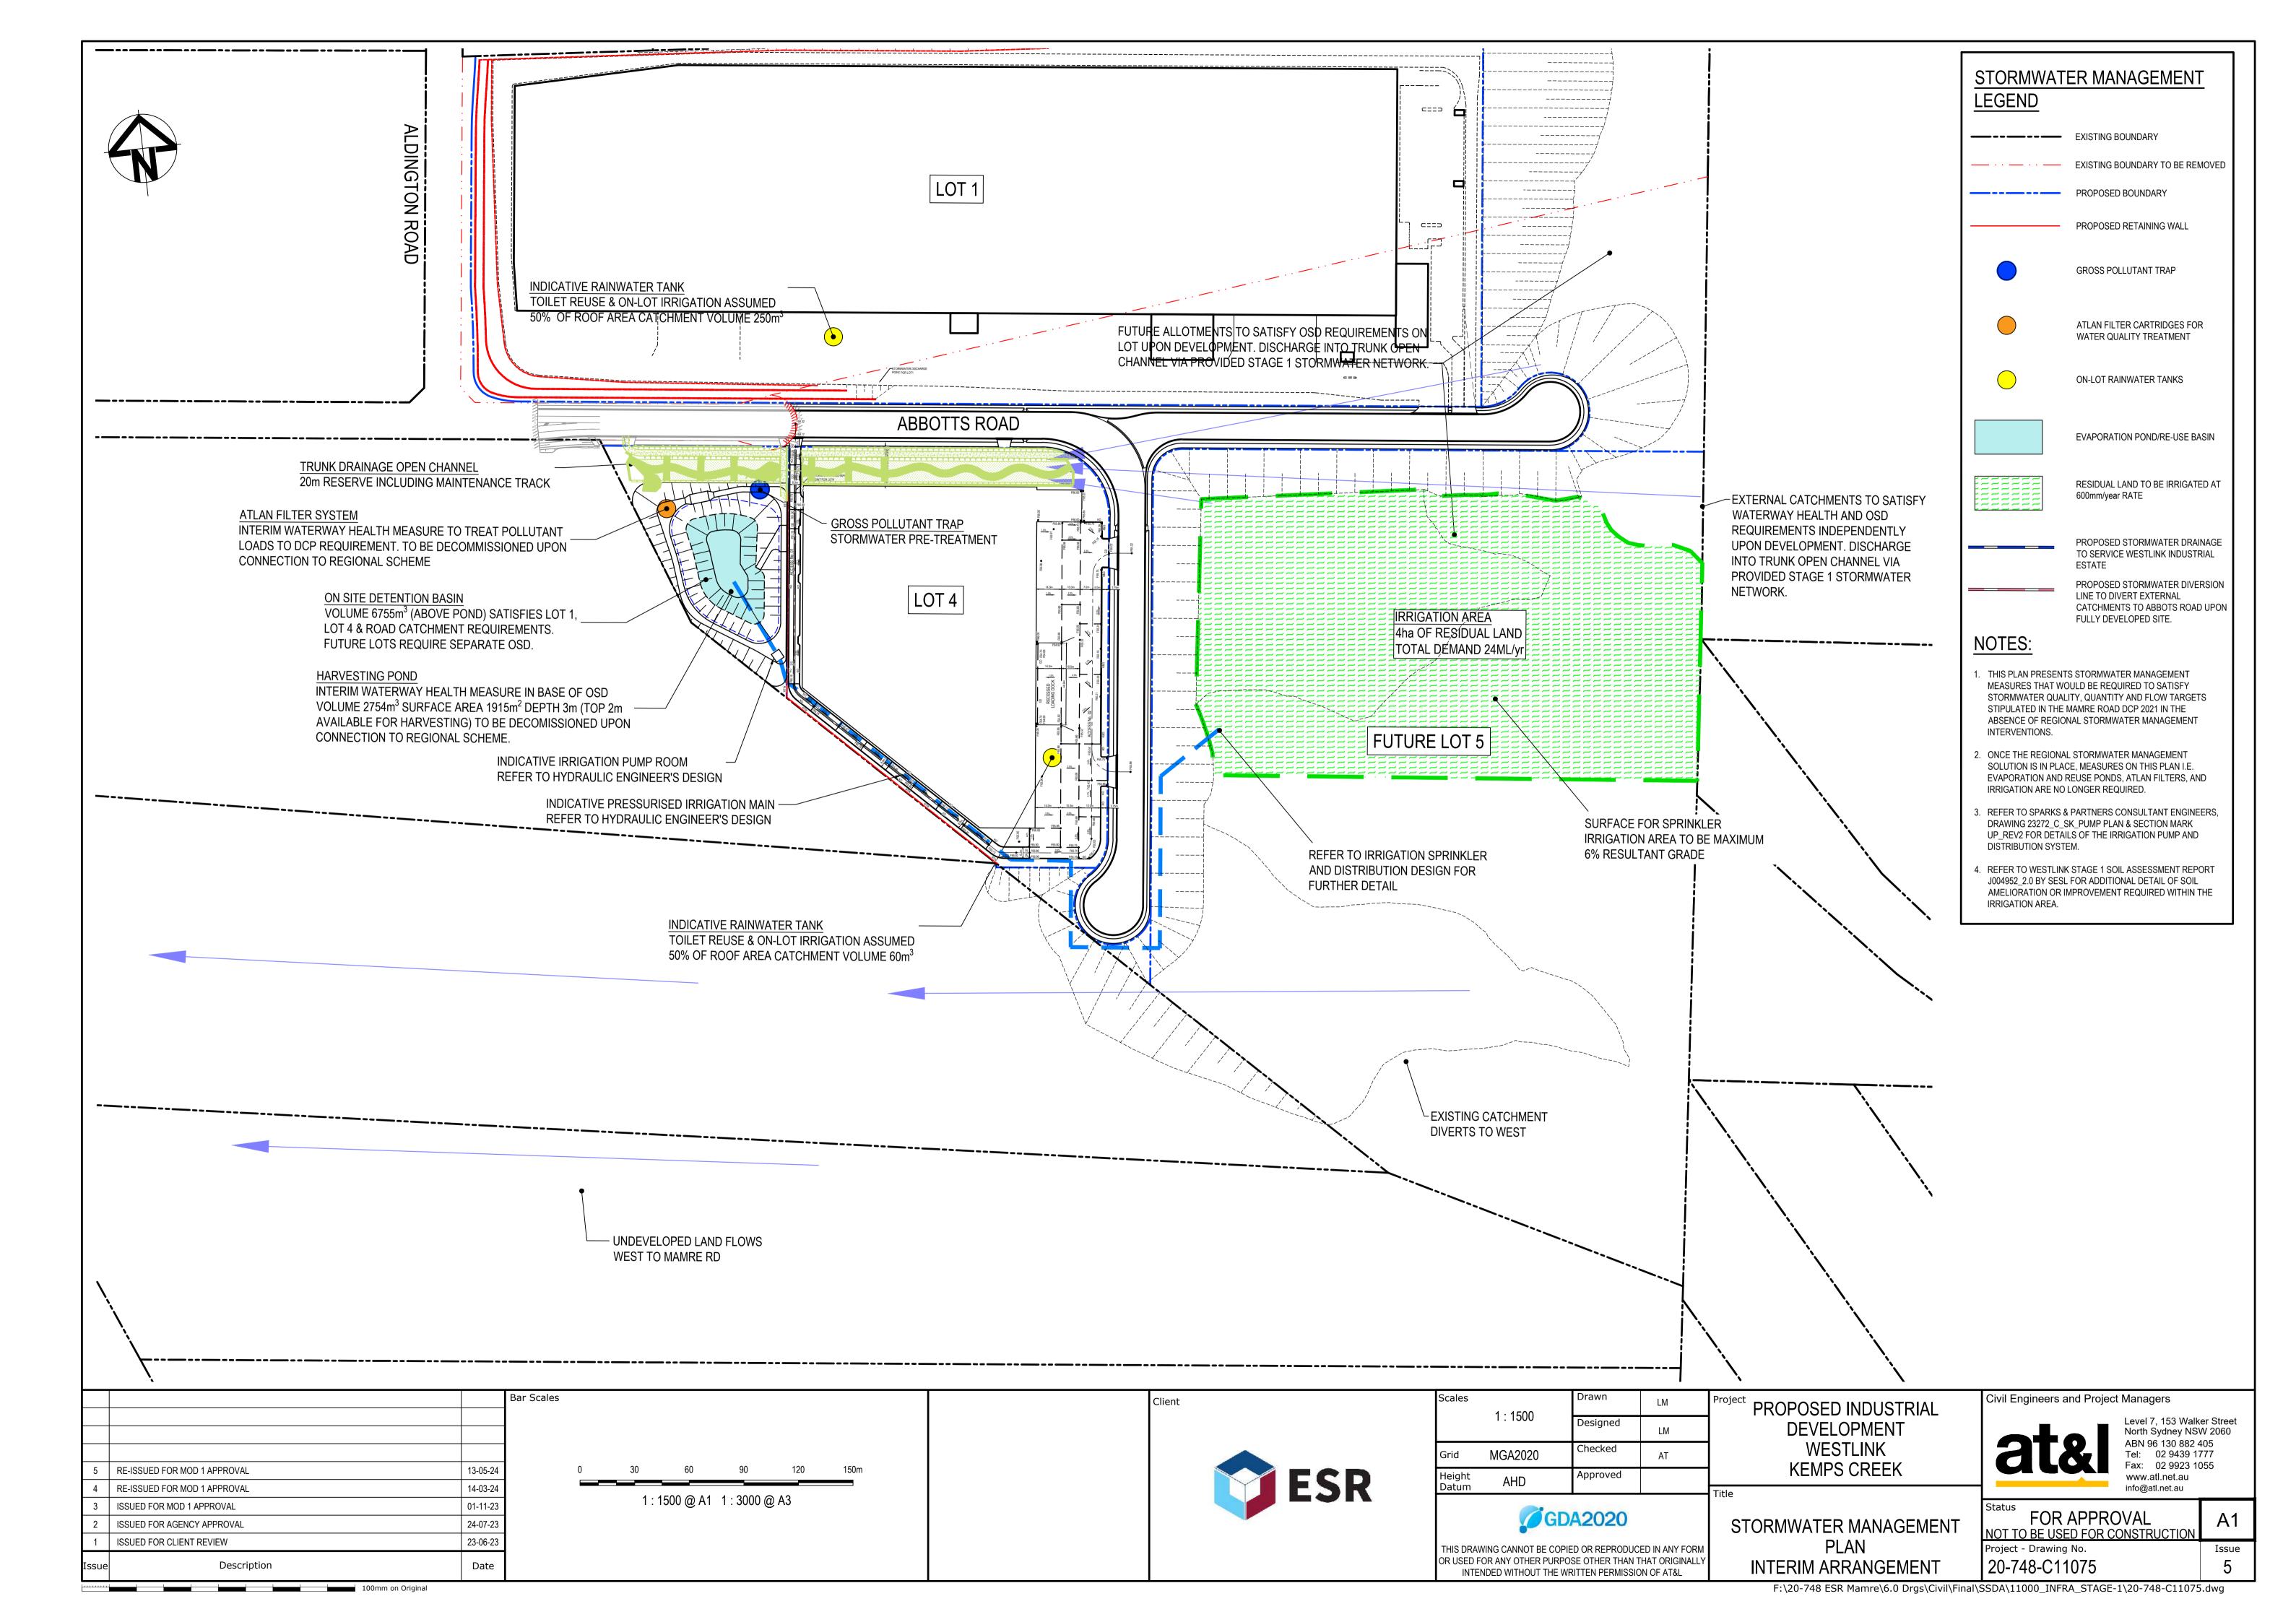


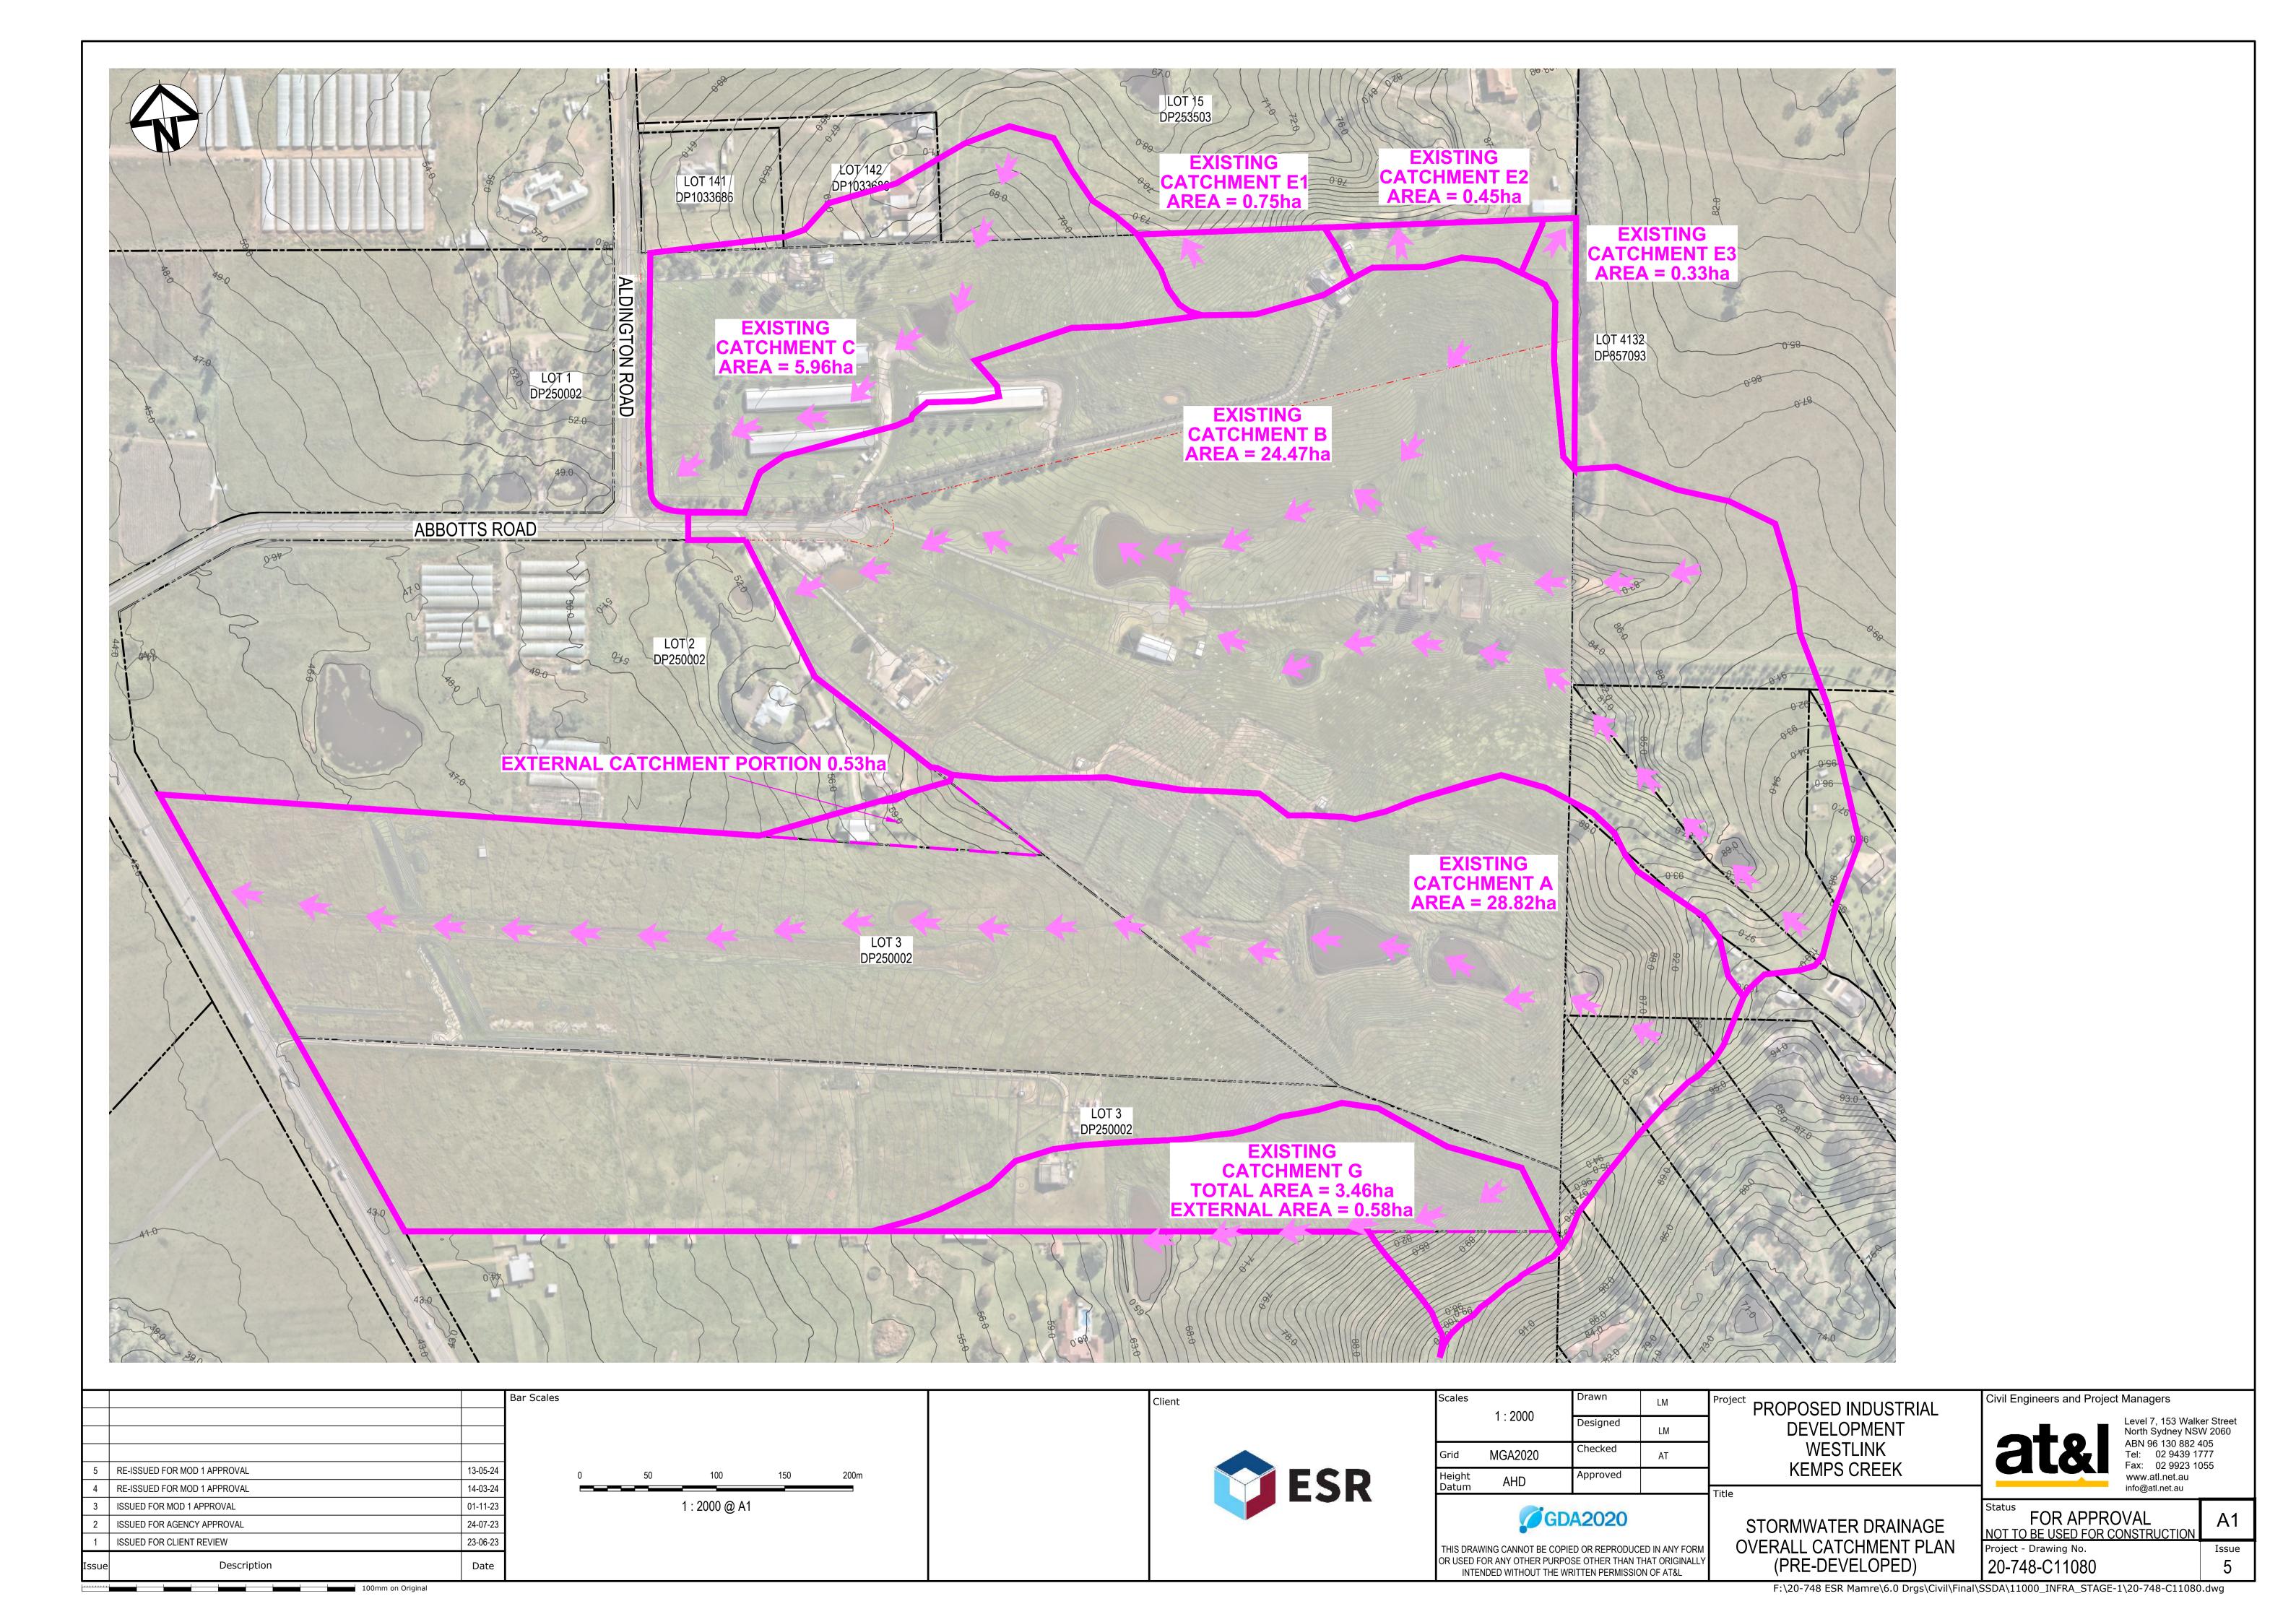

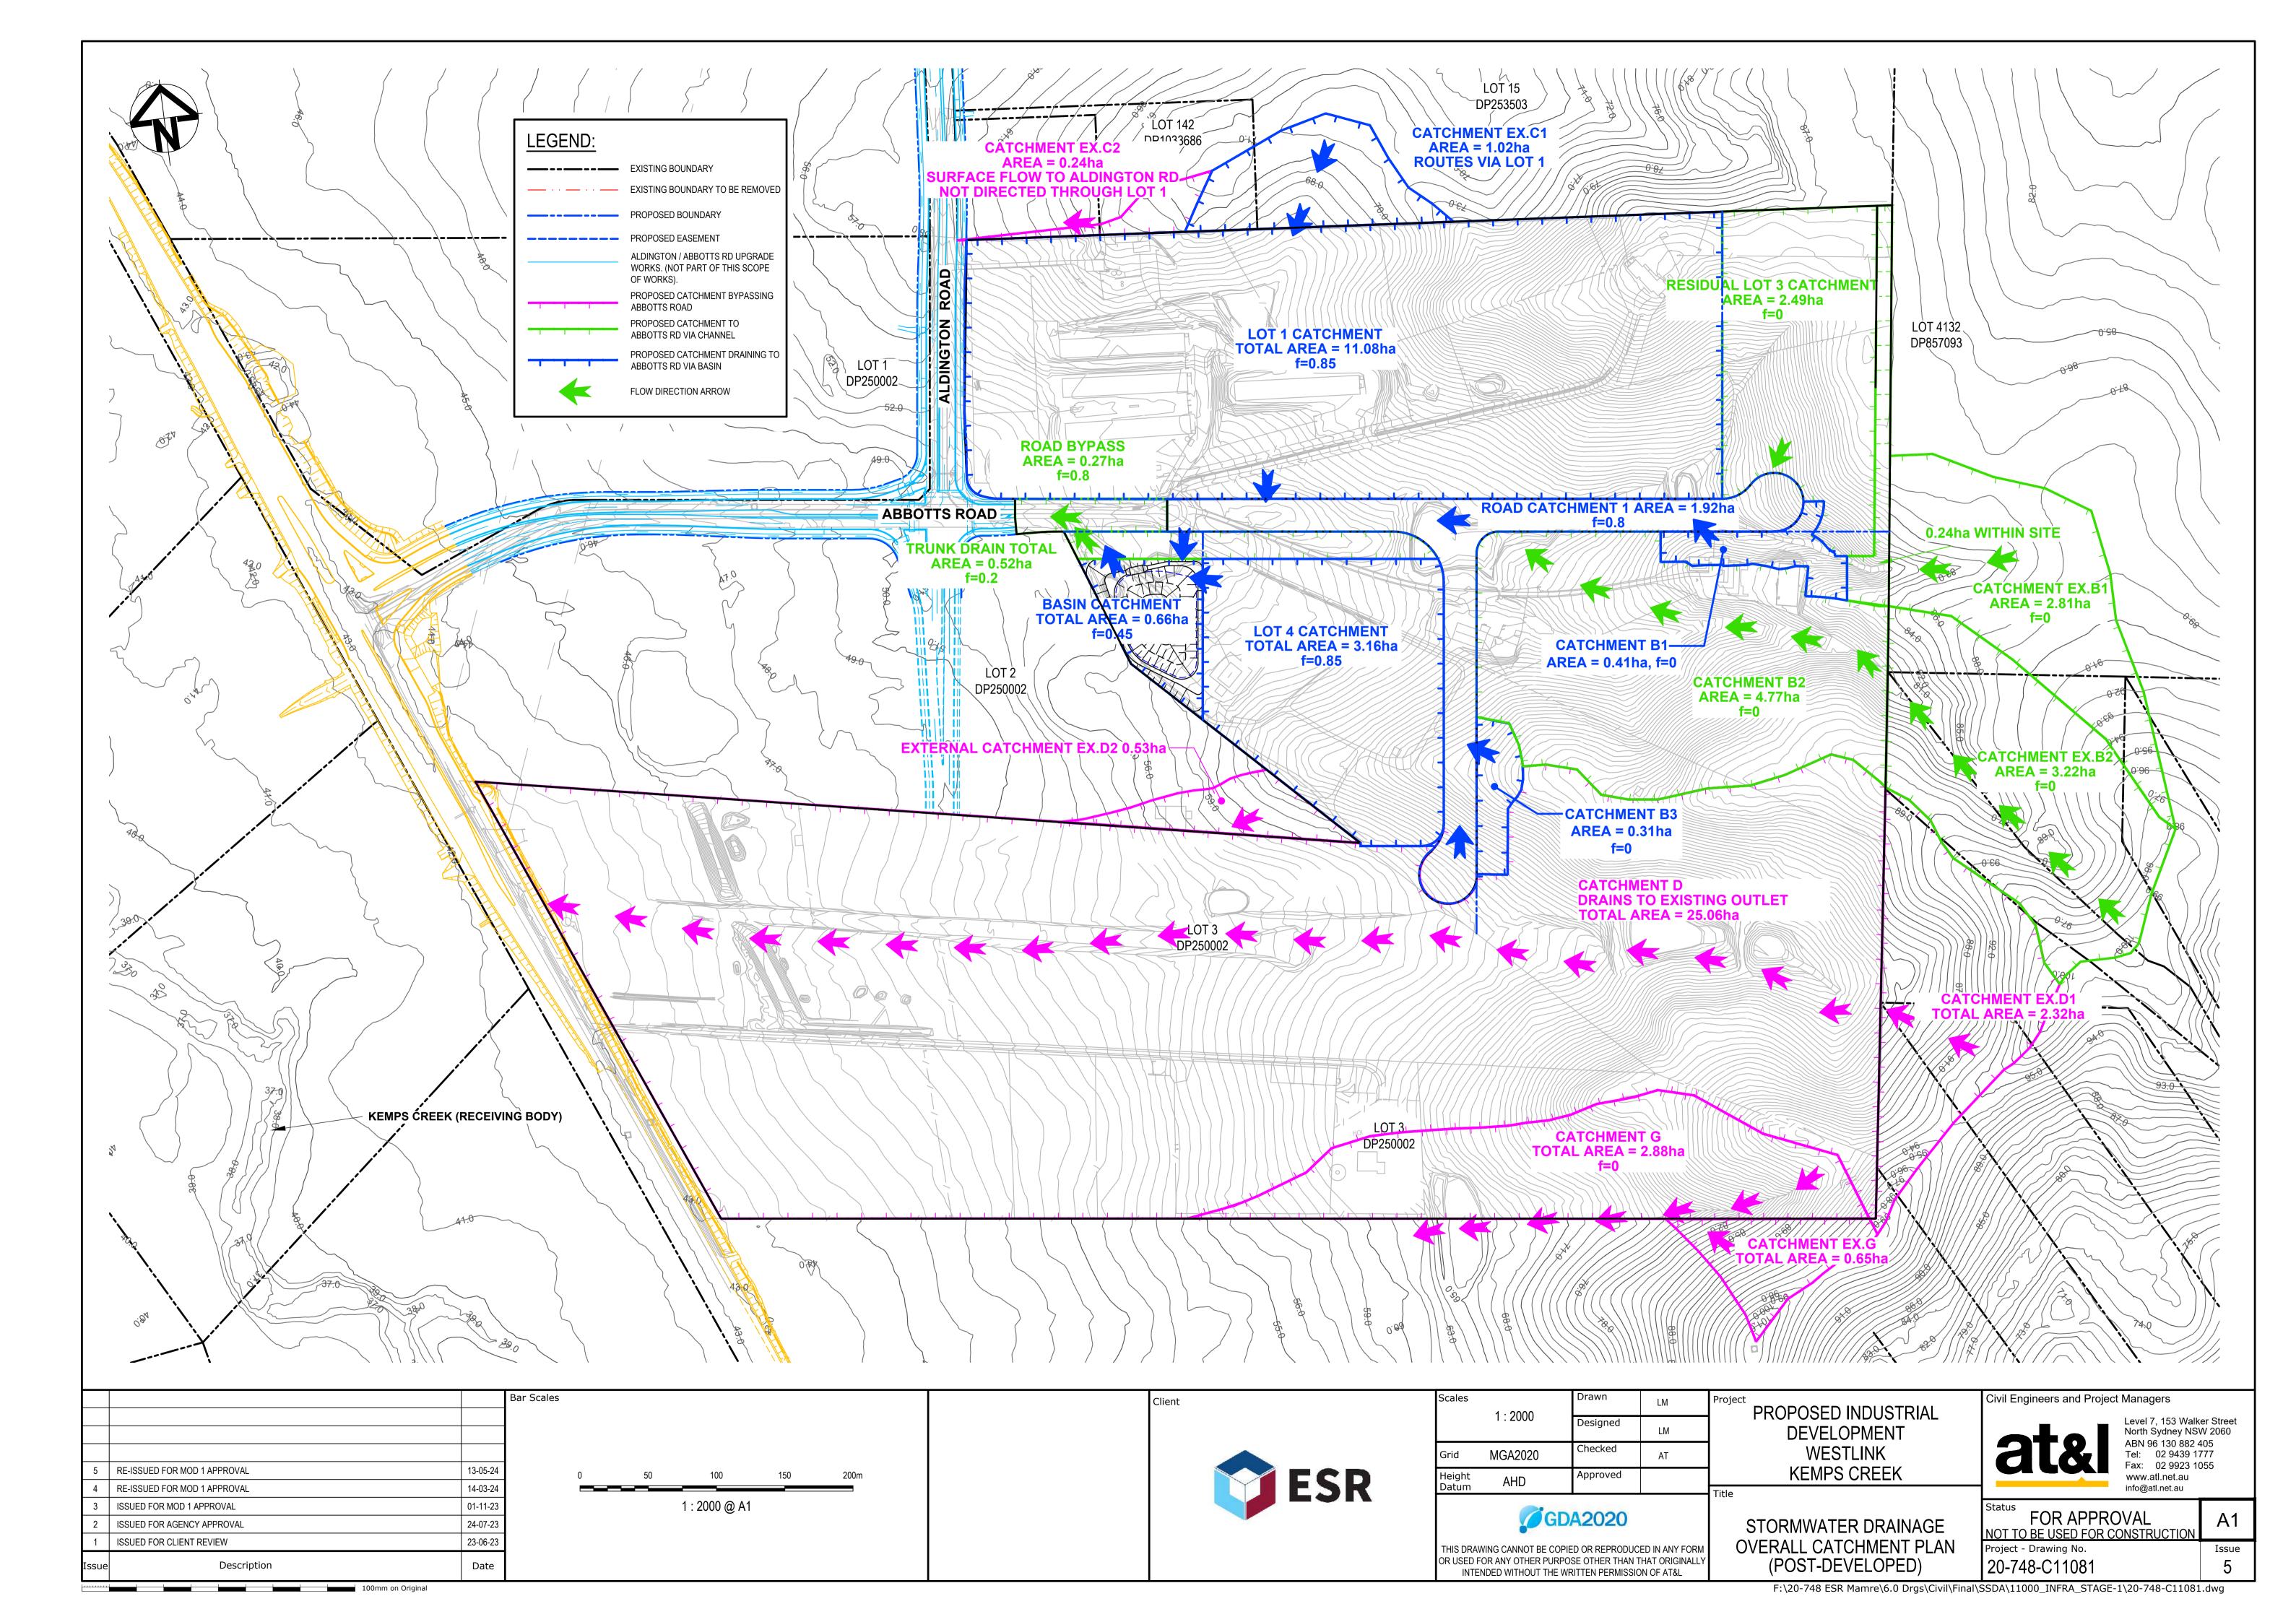


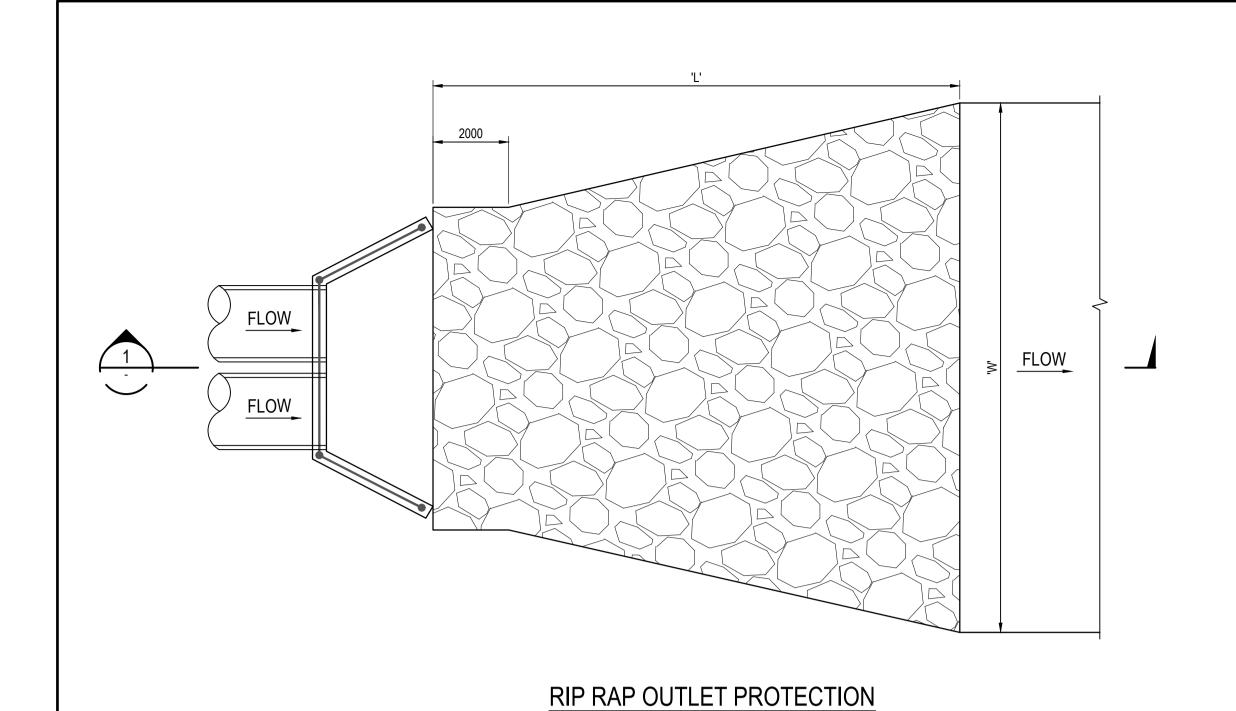

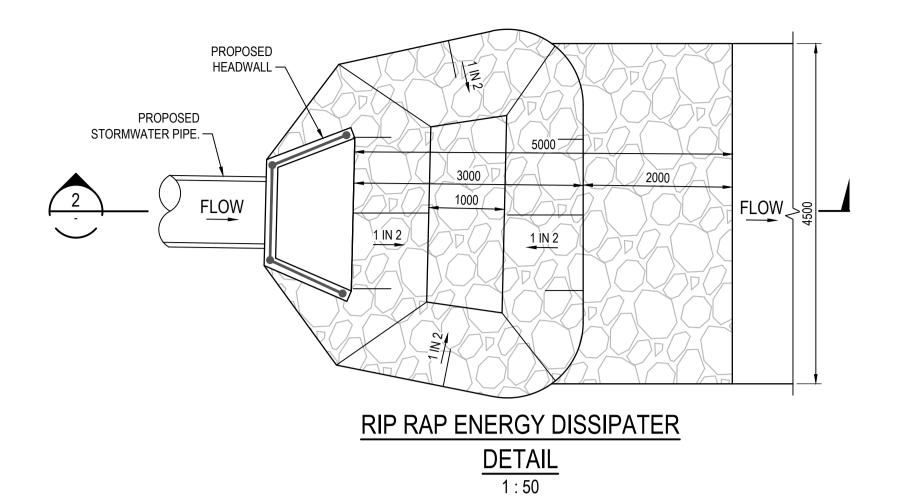


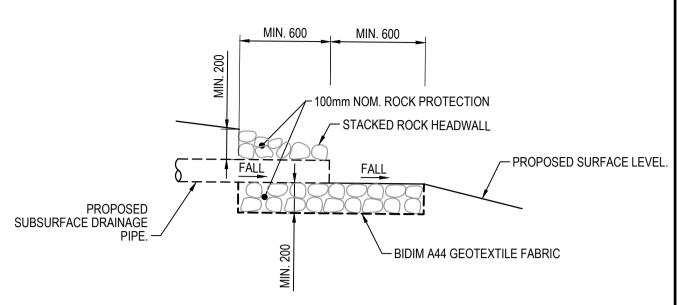

SUBSURFACE DRAINAGE TAILOUT DETAIL 1 : 25

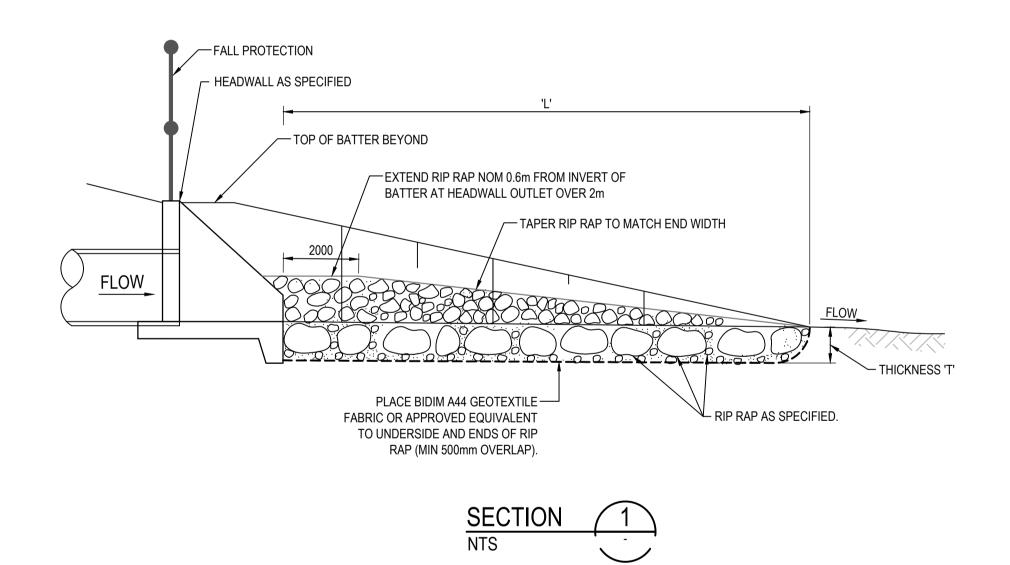

TYPE 1 DETAIL

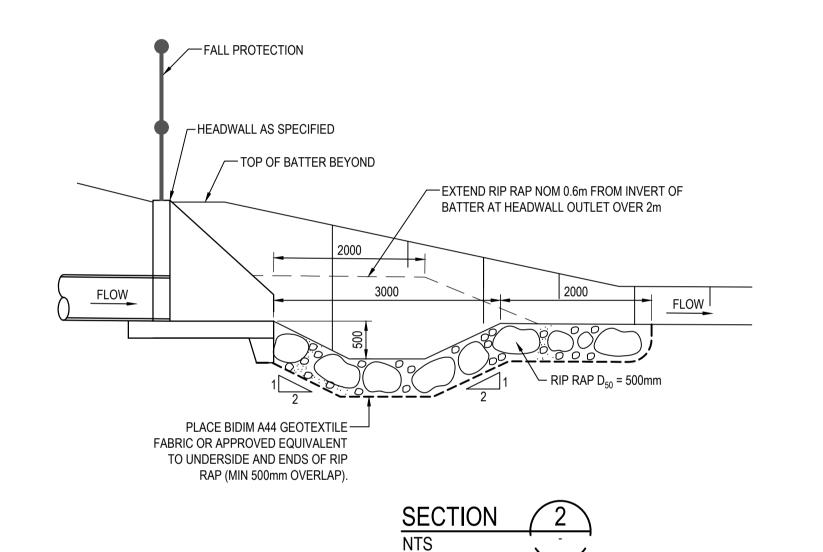

SCOUR PROTECTION SCHEDULE												
OUTLET HEADWALL No.	PIPE Ø (mm)	LENGTH OF PROTECTION (m)	WIDTH OF PROTECTION (m)	NOMINAL ROCK SIZE (mm)	THICKNESS OF PROTECTION (mm)							
	'D'	'L'	'W'	'd 50 '	'T'							
AA-13	2 x 1050	6.5	7.5	300	450							
BE-1	225	6	3.6	300	450							


MINIMUM NOMINAL ROCK SIZE 'd50' IS 300mm.
 THICKNESS 'T' IS 1.5 x NOMINAL ROCK SIZE
 ROCK IS NOT TO BE SITE WON SHALE OR OTHER WEATHERABLE ROCK


ROCK GRADATION TABLE

ROCK DISTRIBUTION BY % 200mm 300mm 400mm 500mm 600 400 750 850 15-25% **ROCK SIZE** 300 400 525 600 750 20% 300 500 50% 200 400 75 100 150 150 200 15-25%

5	RE-ISSUED FOR MOD 1 APPROVAL	13-05-24
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3	ISSUED FOR MOD 1 APPROVAL	01-11-23
2	ISSUED FOR AGENCY APPROVAL	24-07-23
1	ISSUED FOR CLIENT REVIEW	23-06-23
Issue	Description	Date

100mm on Original

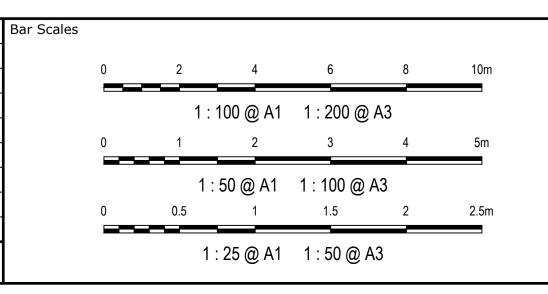

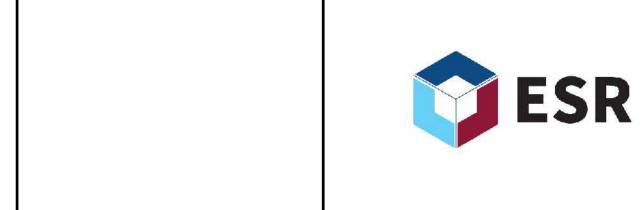

Client

Scales	AS SHOWN	Drawn	LM	Proje
	AS SHOWN	Designed	LM	
Grid	MGA2020	Checked	AT	
Height	AHD	Approved		
Datum	· ·· ·=			T:41 -

GDA2020

STORMWATER DRAINAGE **DETAILS** THIS DRAWING CANNOT BE COPIED OR REPRODUCED IN ANY FORM OR USED FOR ANY OTHER PURPOSE OTHER THAN THAT ORIGINALLY SHEET 1 INTENDED WITHOUT THE WRITTEN PERMISSION OF AT&L

PROPOSED INDUSTRIAL DEVELOPMENT WESTLINK KEMPS CREEK

Fax: 02 9923 1055 www.atl.net.au info@atl.net.au FOR APPROVAL


Civil Engineers and Project Managers

NOT TO BE USED FOR CONSTRUCTION Project - Drawing No. Issue 20-748-C11091

Level 7, 153 Walker Street North Sydney NSW 2060

ABN 96 130 882 405

Tel: 02 9439 1777

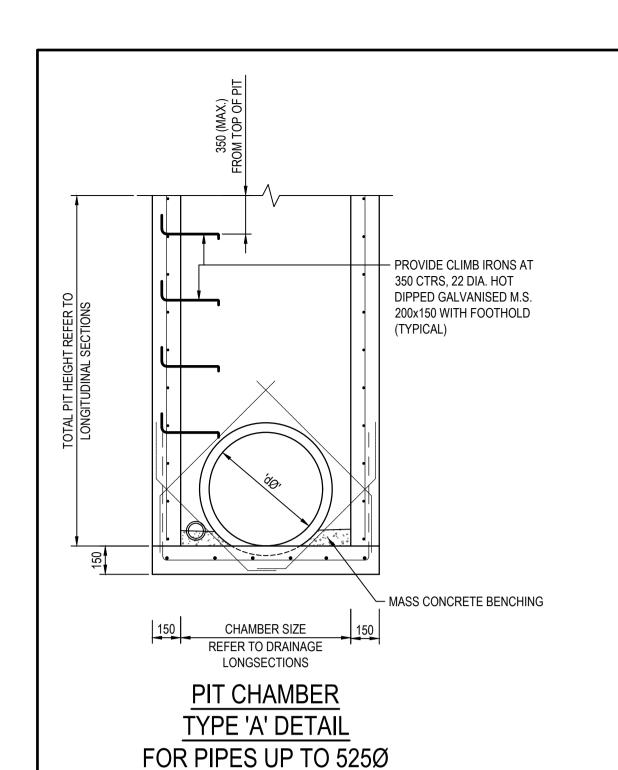

SCALE: 1:20

MIN

- RECESS TO SUIT

∕-R6-300 (40 COVER)

FRAME OR COVER

PAVEMENT AS

SPECIFIED

COVER OR GRATE

RECESS TO SUIT

COVER OR FRAME-

DETAIL "D"

AND FRAME AS


SPECIFIED

Date

GRATE AND FRAME OR ¬

LAP 300

COVER AS SPECIFIED

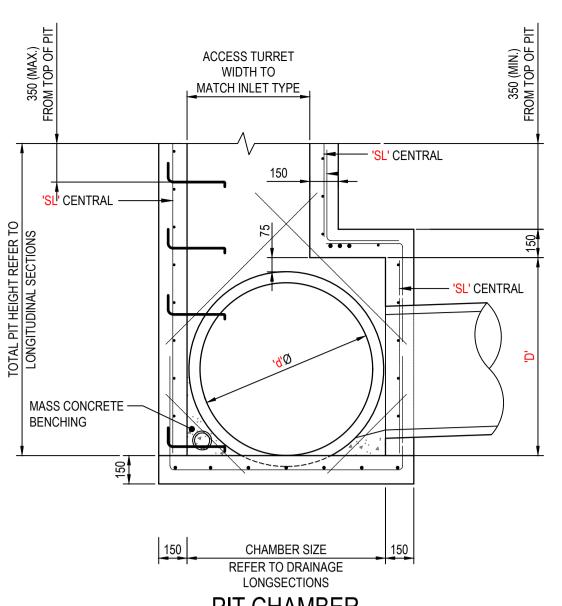


PIT CHAMBER TYPE 'B' DETAIL FOR PIPES FROM 600Ø TO 1200Ø (ENLARGED CHAMBER)

SCALE: 1:20


PIPE DIA.	WIDTH 'W'	DEPTH	FABRIC/COV
600 to 675	900	1200-2400	
750	1000	1200-2400	REINFORCEMENT TO
825	1150	1200-2400	BE CONFIRMED BY CONTRACTOR AND
900	1200	1200-2400	STRUCTURAL ENGINEER —
1050	1350	1300-2400	ENGINEER —
1200	1500	1500-2800	

CHAMBER DEPTH EXCEEDING 2m IN HEIGHT WILL BE DESIGNED AND APPROVED BY STRUCTURAL ENGINEER

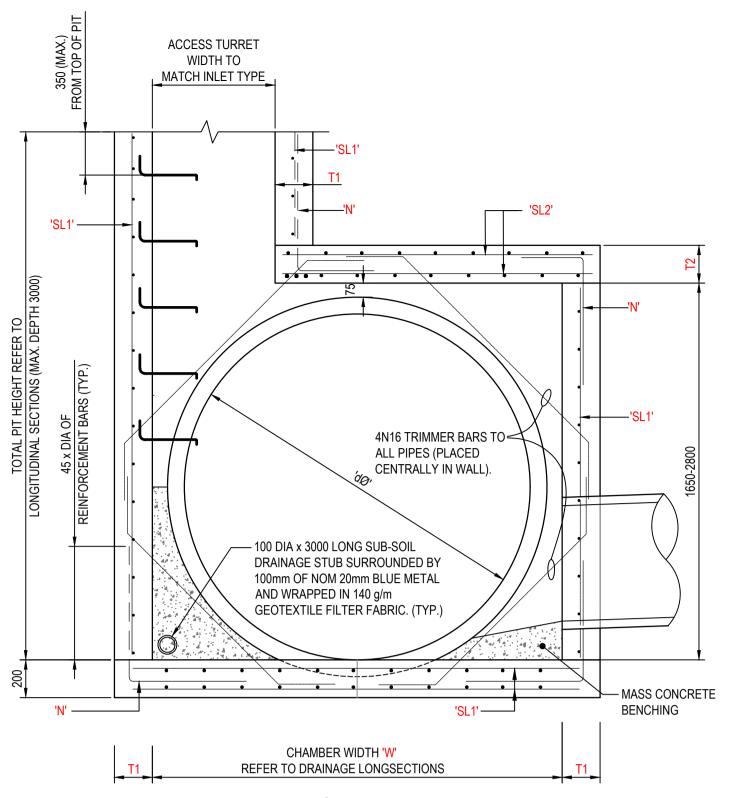

PIT CHAMBER TYPE 'C' DETAIL FOR PIPES FROM 1350Ø TO 2250Ø (ENLARGED CHAMBER) SCALE: 1:20

MAX. INNER WIDTH IN PLAN	WALL TH	ICKNESS	FABRIC /	LAP BAR	
'W' (mm)	'T1' (mm)	'T2' (mm)	'SL1'	'SL2'	'N'
1400	125	200			
1800	160	200		REINFORCEMENT TO BE CONFIRMED BY	
2250	200	235		+ CONTRACTOR AND - STRUCTURAL ENGINEER	
2450	200	250			

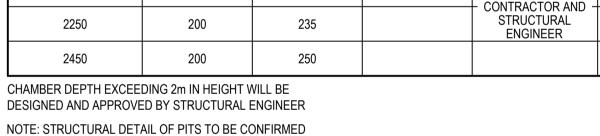

AT DETAILED DESIGN

X//XXX//

DETAIL "E"

- MORTAR BEDDING


FRAME GRATE & LEGS TO ¬ BE HOT DIP GALVANISED

HINGE.

DETAIL "F" SCALE 1:10


Client

AFTER FABRICATION.

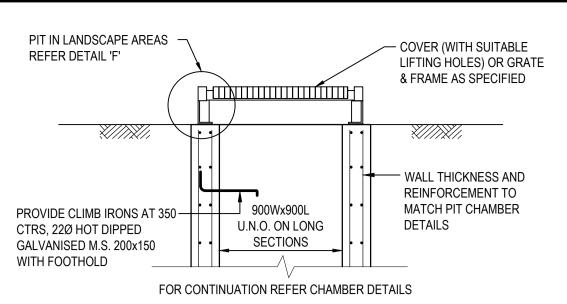


STANDARD SURCHARGE SURFACE INLET PIT

SCALE: 1:20

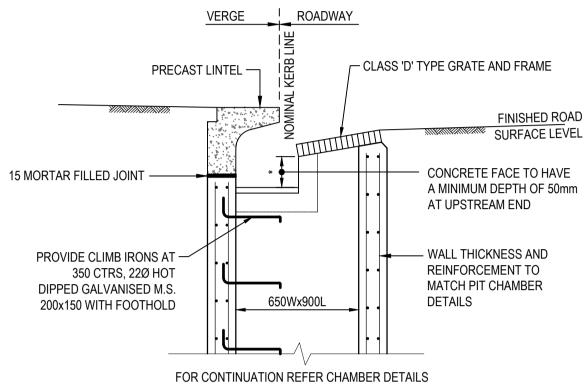



STANDARD GRATED KERB INLET PIT WITH LINTEL SCALE: 1:20

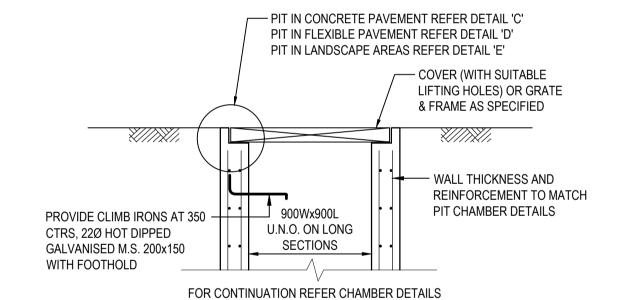


STANDARD SURFACE INLET


OR SEALED JUNCTION PIT SCALE: 1:20

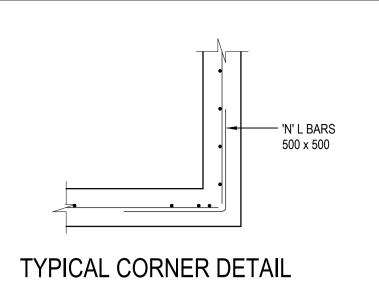

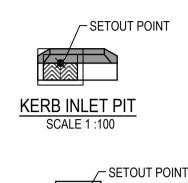



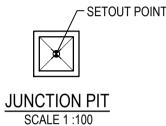

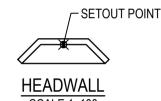



STORMWATER PIT SETOUT POINTS REFER PIT SETOUT PLANS FOR ENLARGED CHAMBERS

<u>NOTE</u>

- 1. STANDARD GULLY PITS REFER TO PENRITH CITY COUNCIL STANDARD DRAWING SD2001 FOR DETAILS
- 2. FOR INLET SIZE REFER TO STORMWATER LONGITUDINAL SECTIONS ON DRAWING C13101 - C13106.
- 3. FOR PIT CHAMBER SIZE REFER TO PIT SCHEDULE.
- 4. REINFORCING MESH IS TO BE BENT TO LAP 300 AROUND ALL VERTICAL BARS ARE NOT TO BE CUT. ALTERNATELY PROVIDE N12 "L" BARS (500x500) AT 400 VERTICAL CTS.
- 5. COMPRESSIVE STRENGTH (F'c) FOR CAST IN SITU CONCRETE SHALL BE CONFIRMED BY CONTRACTOR AND STRUCTURAL **ENGINEER**
- 6. TOP OF BENCHING SHALL BE $\frac{1}{2}$ OF OUTLET PIPE DIAMETER.
- 7. 100mm SUBSOIL DRAINAGE PIPE 3000 LONG WRAPPED IN FABRIC SOCK TO BE PROVIDED ADJACENT TO ALL INLET
- 8. ALL PITS SHALL BE PROVIDED WITH A LOCKING CLIP.
- 9. PIT GRATE TO BE 'WELDLOK' GULLY GRATE GG 78-50 OR APPROVED EQUIVALENT.
- 10. DURING INSTALLATION OF GRATE AND FRAME CONTRACTOR IS ENSURE CLEARANCE BETWEEN LINTEL AND OPENED GRATE (REFER TO INSTALLATION TOLERANCE).
- 11. PROVIDE STEP IRONS AS INDICATED FOR PITS DEEPER THAN
- 12. CHAMBER DEPTH EXCEEDING 2m IN HEIGHT WILL BE DESIGNED

Civil Engineers and Project Managers

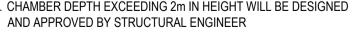


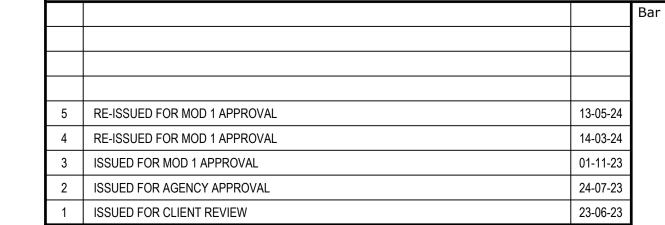

100mm on Original

Description

DETAIL "C"

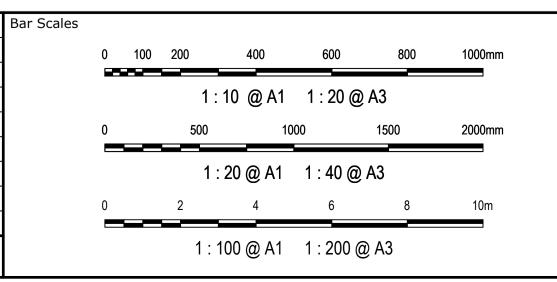

-MORTAR BEDDING

COVER OR GRATE

RECESS TO SUIT

COVER OR FRAME~

AND FRAME AS

SPECIFIED



- 51 x 51 x 8 ANGLE LEGS

TO FRAME & BASEPLATE.

1 - 16 DIA HOLE CENTRAL

1 - M12 GALV. HOLDING

DOWN BOLT PER LEG. **BOLTS 150 LONG WITH** 35 PROJECTION.

6 MM FILLET WELD

-75 SQ x 8 PL. WITH

Scales AS SHC		Drawn	LM Project PRO	Project PROPOSED INDUSTRIAL
AS SHO	D	Designed	LM	DEVELOPMENT
Grid MGA20)20	Checked	AT	WESTLINK
Height AHD	A	Approved		KEMPS CREEK

GDA2020


STORMWATER DRAINAGE **DETAILS** THIS DRAWING CANNOT BE COPIED OR REPRODUCED IN ANY FORM OR USED FOR ANY OTHER PURPOSE OTHER THAN THAT ORIGINALL' SHEET 2 INTENDED WITHOUT THE WRITTEN PERMISSION OF AT&L




Level 7, 153 Walker Street North Sydney NSW 2060 ABN 96 130 882 405 Tel: 02 9439 1777 Fax: 02 9923 1055 www.atl.net.au info@atl.net.au


Issue


FOR APPROVAL NOT TO BE USED FOR CONSTRUCTION Project - Drawing No. 20-748-C11092

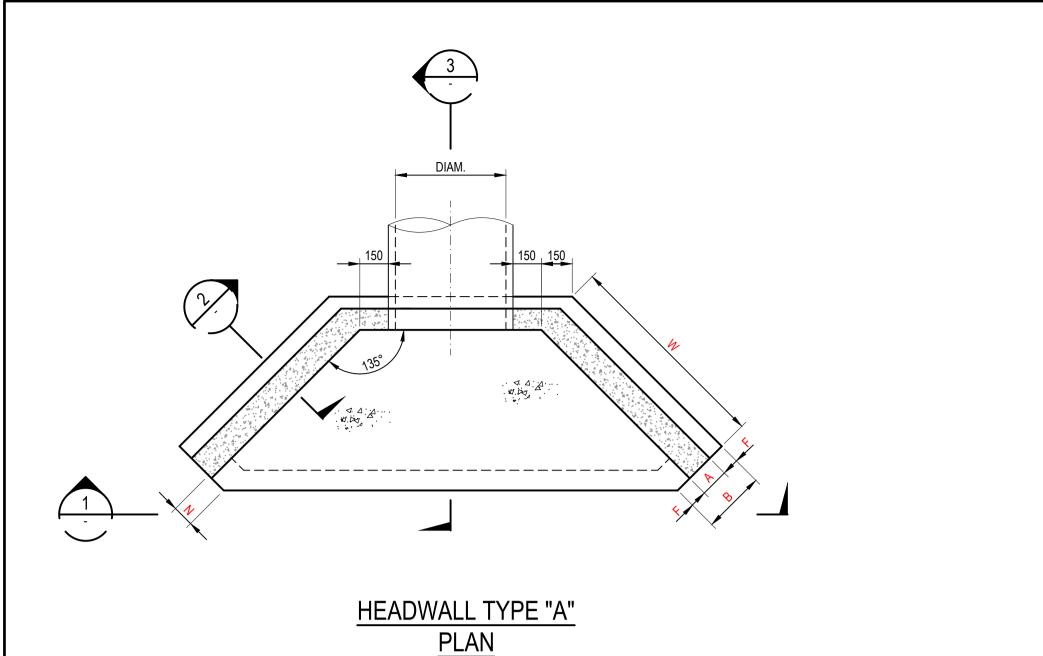

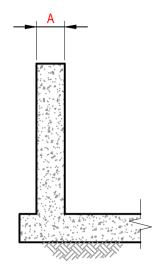



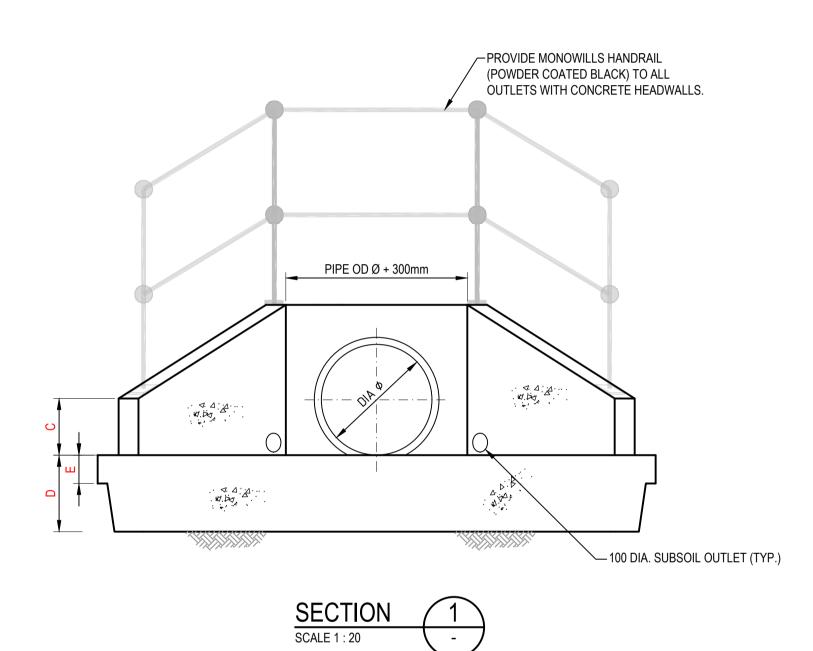

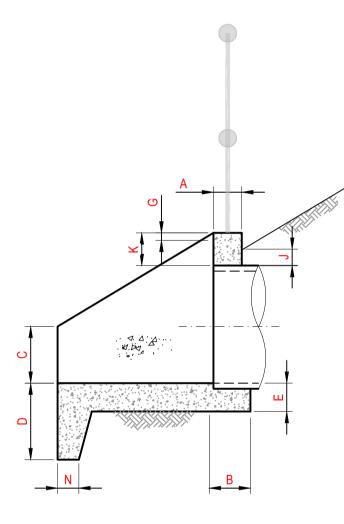

SECTION	3
SCALE 1 : 20	<u> </u>


HEADWALL TYPE "A" - SINGLE PIPE															
PIPE DIAMETER	225-300	0	75	150	225	300	375	450	525	675	825	975	1125	1275	1425
А	150	150	150	175	175	175	200	200	225	225	225	250	250	250	250
В	300	300	300	375	375	375	450	450	525	525	525	550	550	550	550
С	300	300	300	300	350	350	350	350	350	350	350	350	350	350	350
D	375	375	375	375	530	530	530	530	530	530	530	530	530	530	530
E	150	150	150	150	175	175	200	200	225	225	225	225	225	225	225
F	75	75	75	100	100	100	125	125	150	150	150	150	150	150	150
G	40	40	40	40	50	50	50	50	50	50	50	50	50	50	50
J	100	100	100	100	100	100	100	100	100	100	100	100	100	100	100
К	200	200	200	200	300	300	300	300	300	300	300	300	300	300	300
N	150	150	150	150	150	150	150	150	150	150	150	150	150	150	150
W	700	700	850	1000	1100	1300	1450	1600	1750	1950	2200	2500	2700	2800	2900

<u>NOTES</u>

- 1. COMPRESSIVE STRENGTH (F'c) FOR CAST-IN-SITU CONCRETE TO BE A MINIMUM OF 32MPa AT 28 DAYS.
- 2. 25mm CHAMFER ON ALL EXPOSED SURFACES.
- 3. CONTRACTOR TO DESIGN AND PROVIDE STRUCTURAL CERTIFICATE FOR ALL PITS / END STRUCTURES
- UNLESS ADAPTING PENRITH CITY COUNCIL STANDARD DETAILS WHERE APPLICABLE.
- 4. ANTI GRAFFITI PAINT TO BE APPLIED TO FACE OF ALL HEADWALLS.
- 5. REFER TO STRUCTURAL DRAWINGS FOR DETAILS OF BASE SLAB DESIGN.

5	RE-ISSUED FOR MOD 1 APPROVAL	13-05-24
4	RE-ISSUED FOR MOD 1 APPROVAL	14-03-24
3	ISSUED FOR MOD 1 APPROVAL	01-11-23
2	ISSUED FOR AGENCY APPROVAL	24-07-23
1	ISSUED FOR CLIENT REVIEW	23-06-23
Issu	e Description	Date

100mm on Original

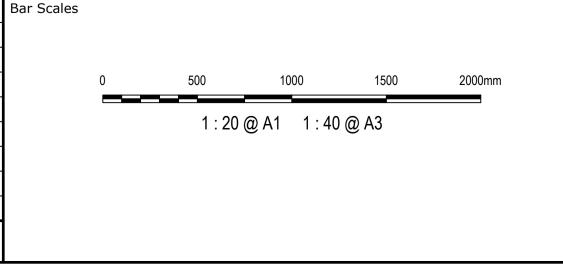



Client

Scales	AS SHOWN	Drawn	LM	Pro
	AS SHOWN	Designed	LM	
Grid	MGA2020	Checked	AT	
Height	AHD	Approved		

GDA2020

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Project PROPOSED INDUSTRIAL DEVELOPMENT WESTLINK KEMPS CREEK

STORMWATER DRAINAGE


DETAILS


SHEET 3


Level 7, 153 Walker Street North Sydney NSW 2060 ABN 96 130 882 405 Tel: 02 9439 1777 Fax: 02 9923 1055 www.atl.net.au info@atl.net.au

Civil Engineers and Project Managers


FOR APPROVAL NOT TO BE USED FOR CONSTRUCTION Project - Drawing No. 20-748-C11093

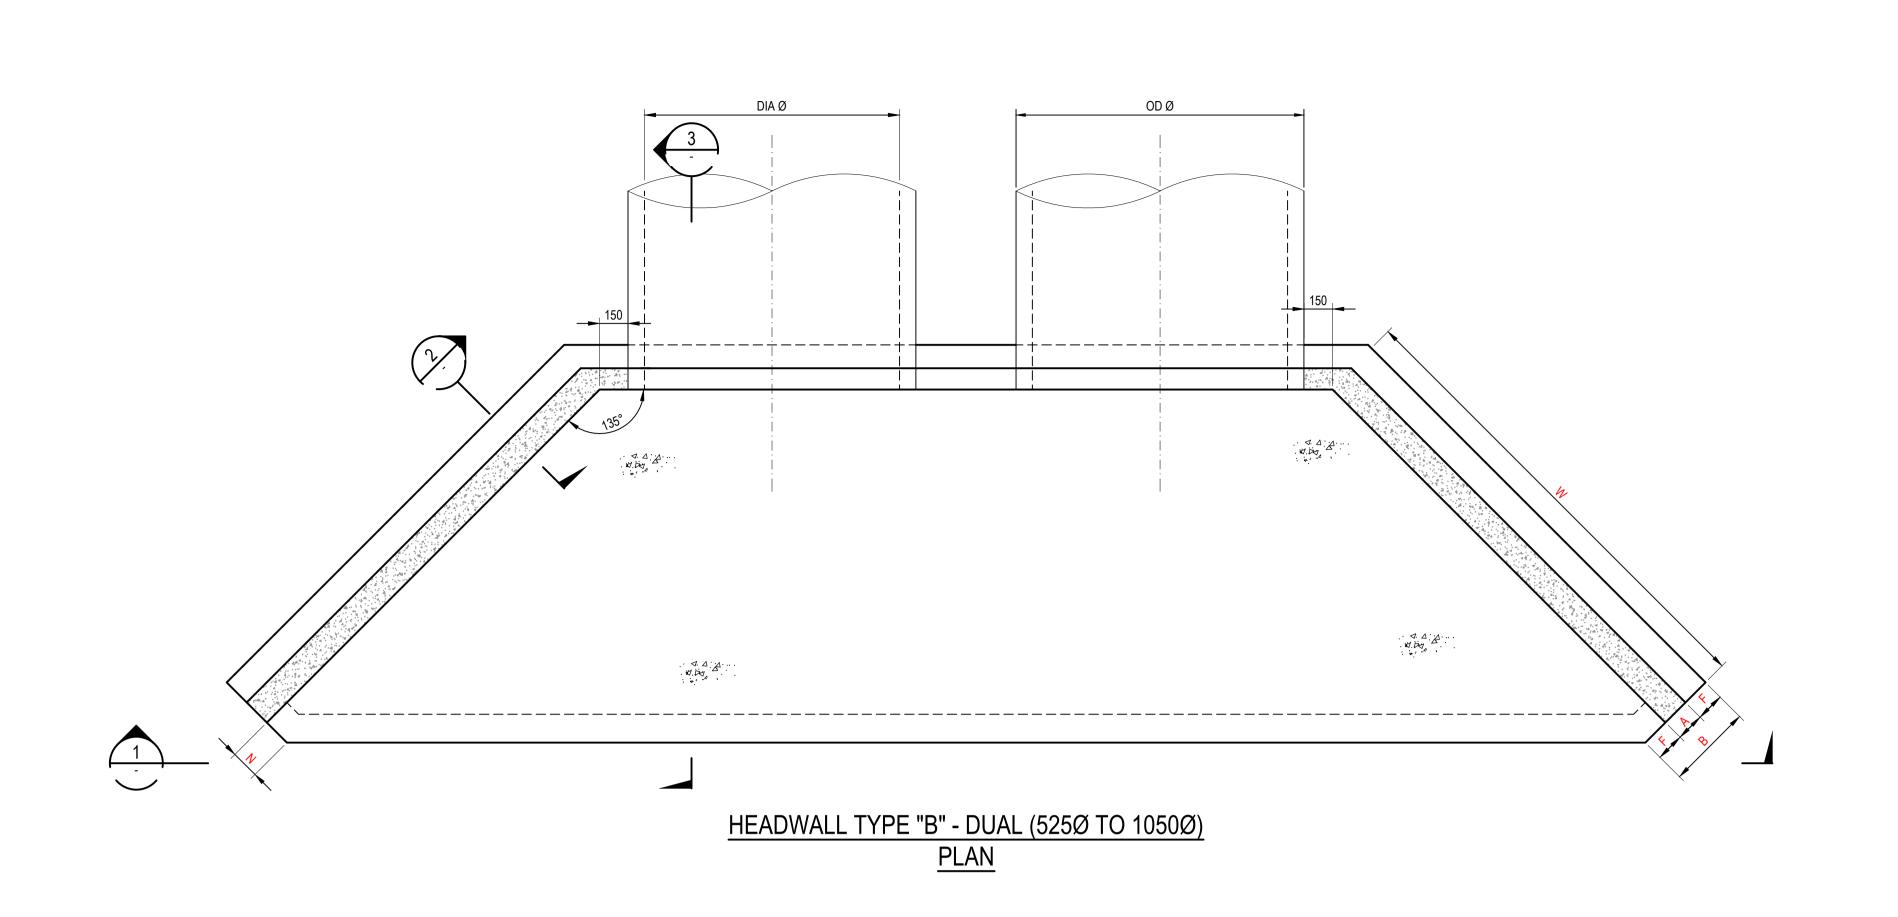

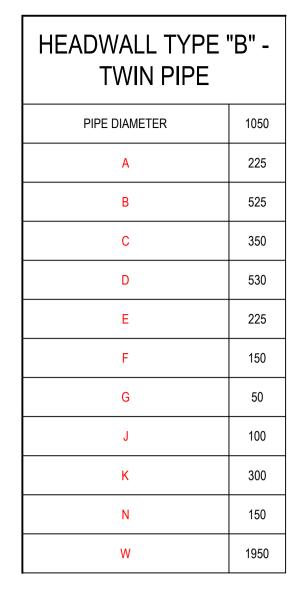


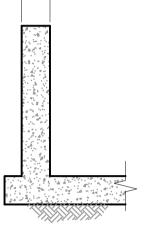


- 1. COMPRESSIVE STRENGTH (F'c) FOR CAST-IN-SITU CONCRETE TO BE A
- MINIMUM OF 32MPa AT 28 DAYS.
- 2. 25mm CHAMFER ON ALL EXPOSED SURFACES.
- 3. CONTRACTOR TO DESIGN AND PROVIDE STRUCTURAL CERTIFICATE FOR ALL PITS / END STRUCTURES UNLESS ADAPTING PENRITH CITY COUNCIL STANDARD DETAILS WHERE APPLICABLE.
- 4. ANTI GRAFFITI PAINT TO BE APPLIED TO FACE OF ALL HEADWALLS
- 5. REFER TO STRUCTURAL DRAWINGS FOR DETAILS OF BASE SLAB DESIGN.

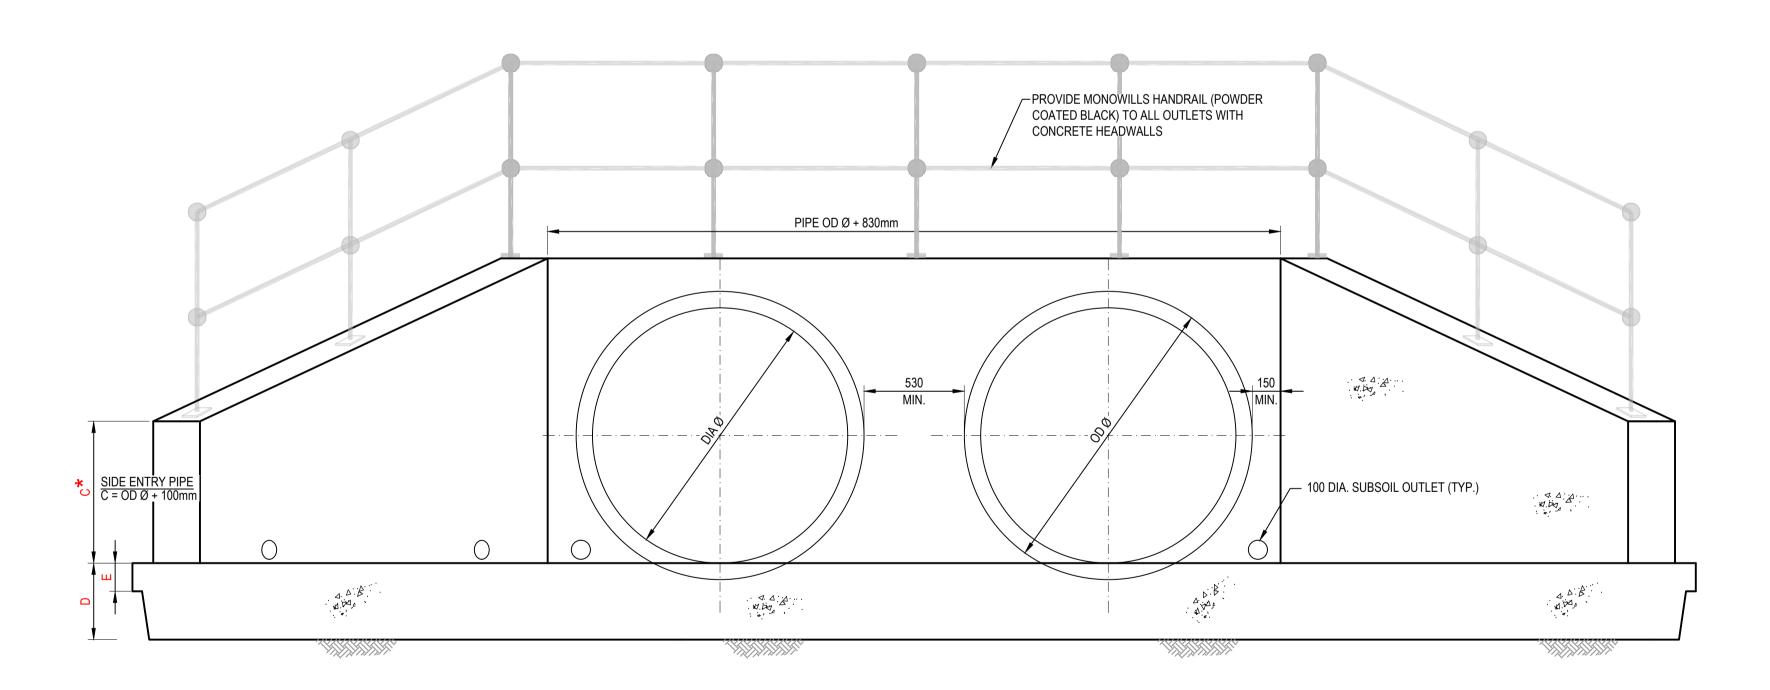

ELEVATION

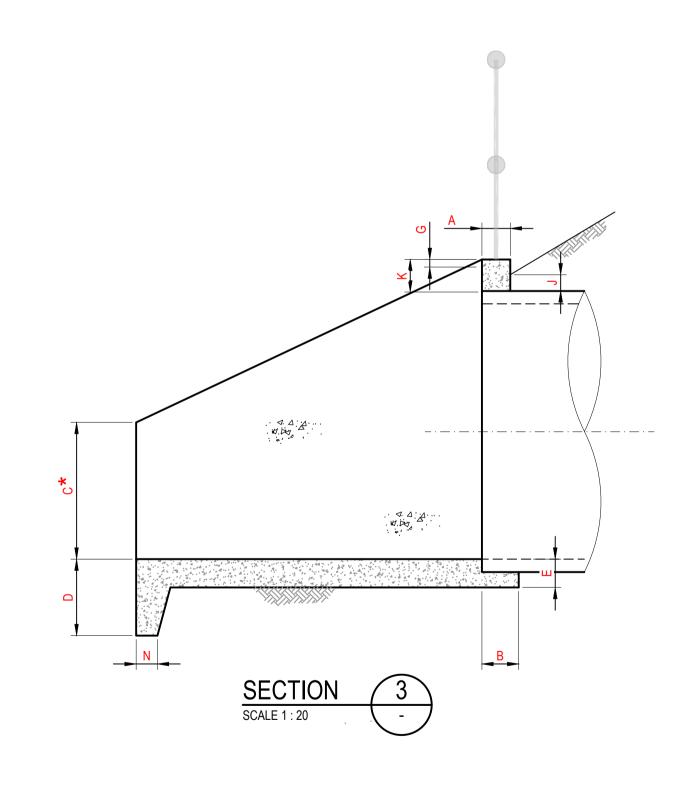

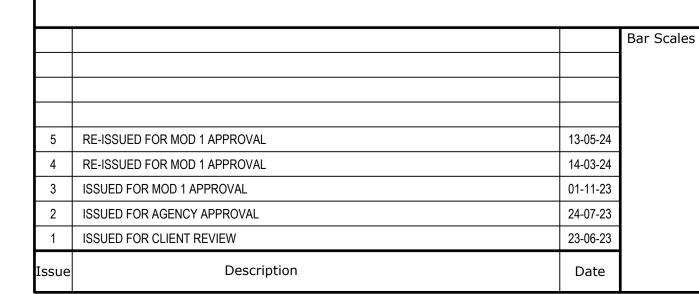

1:10 @ A1 1:20 @ A3 1 : 20 @ A1 1 : 40 @ A3

Client

LM AS SHOWN Designed LM Checked MGA2020 Height Datum

GDA2020

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Project PROPOSED INDUSTRIAL DEVELOPMENT WESTLINK KEMPS CREEK

Title


STORMWATER DRAINAGE **DETAILS** SHEET 4


Civil Engineers and Project Managers


Level 7, 153 Walker Street North Sydney NSW 2060 ABN 96 130 882 405 Tel: 02 9439 1777 Fax: 02 9923 1055 www.atl.net.au info@atl.net.au


FOR APPROVAL NOT TO BE USED FOR CONSTRUCTION Project - Drawing No.


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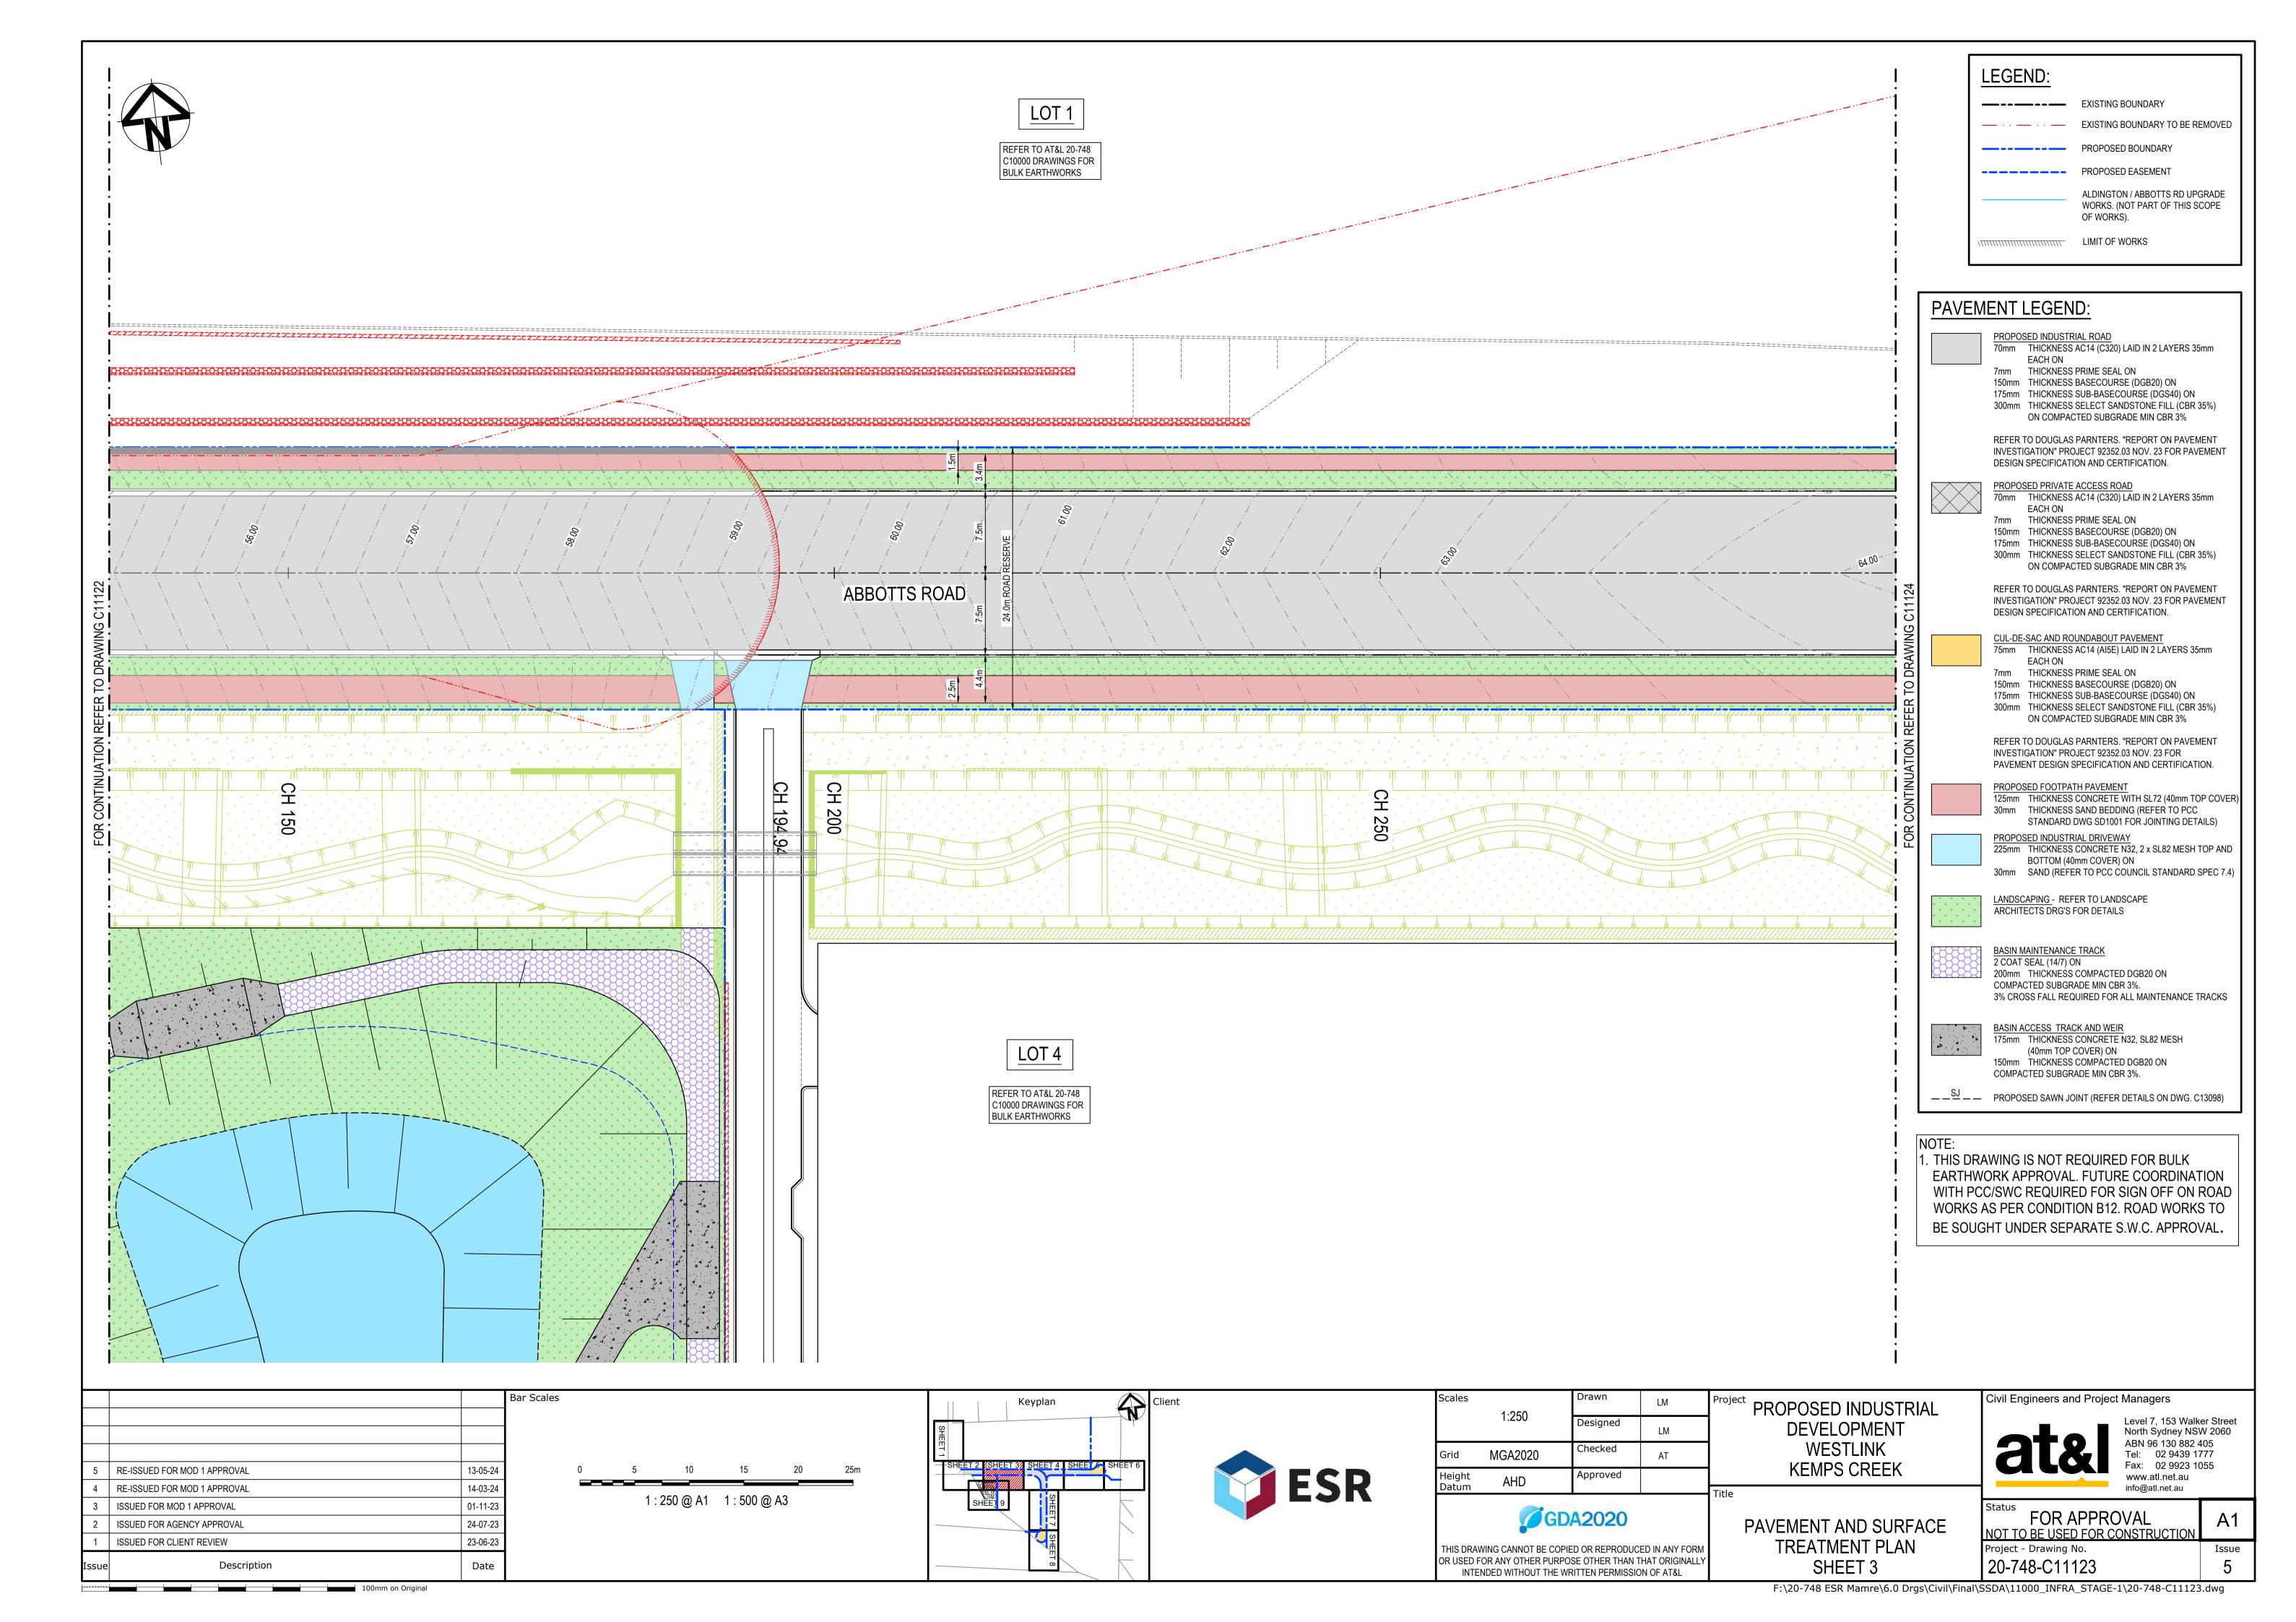


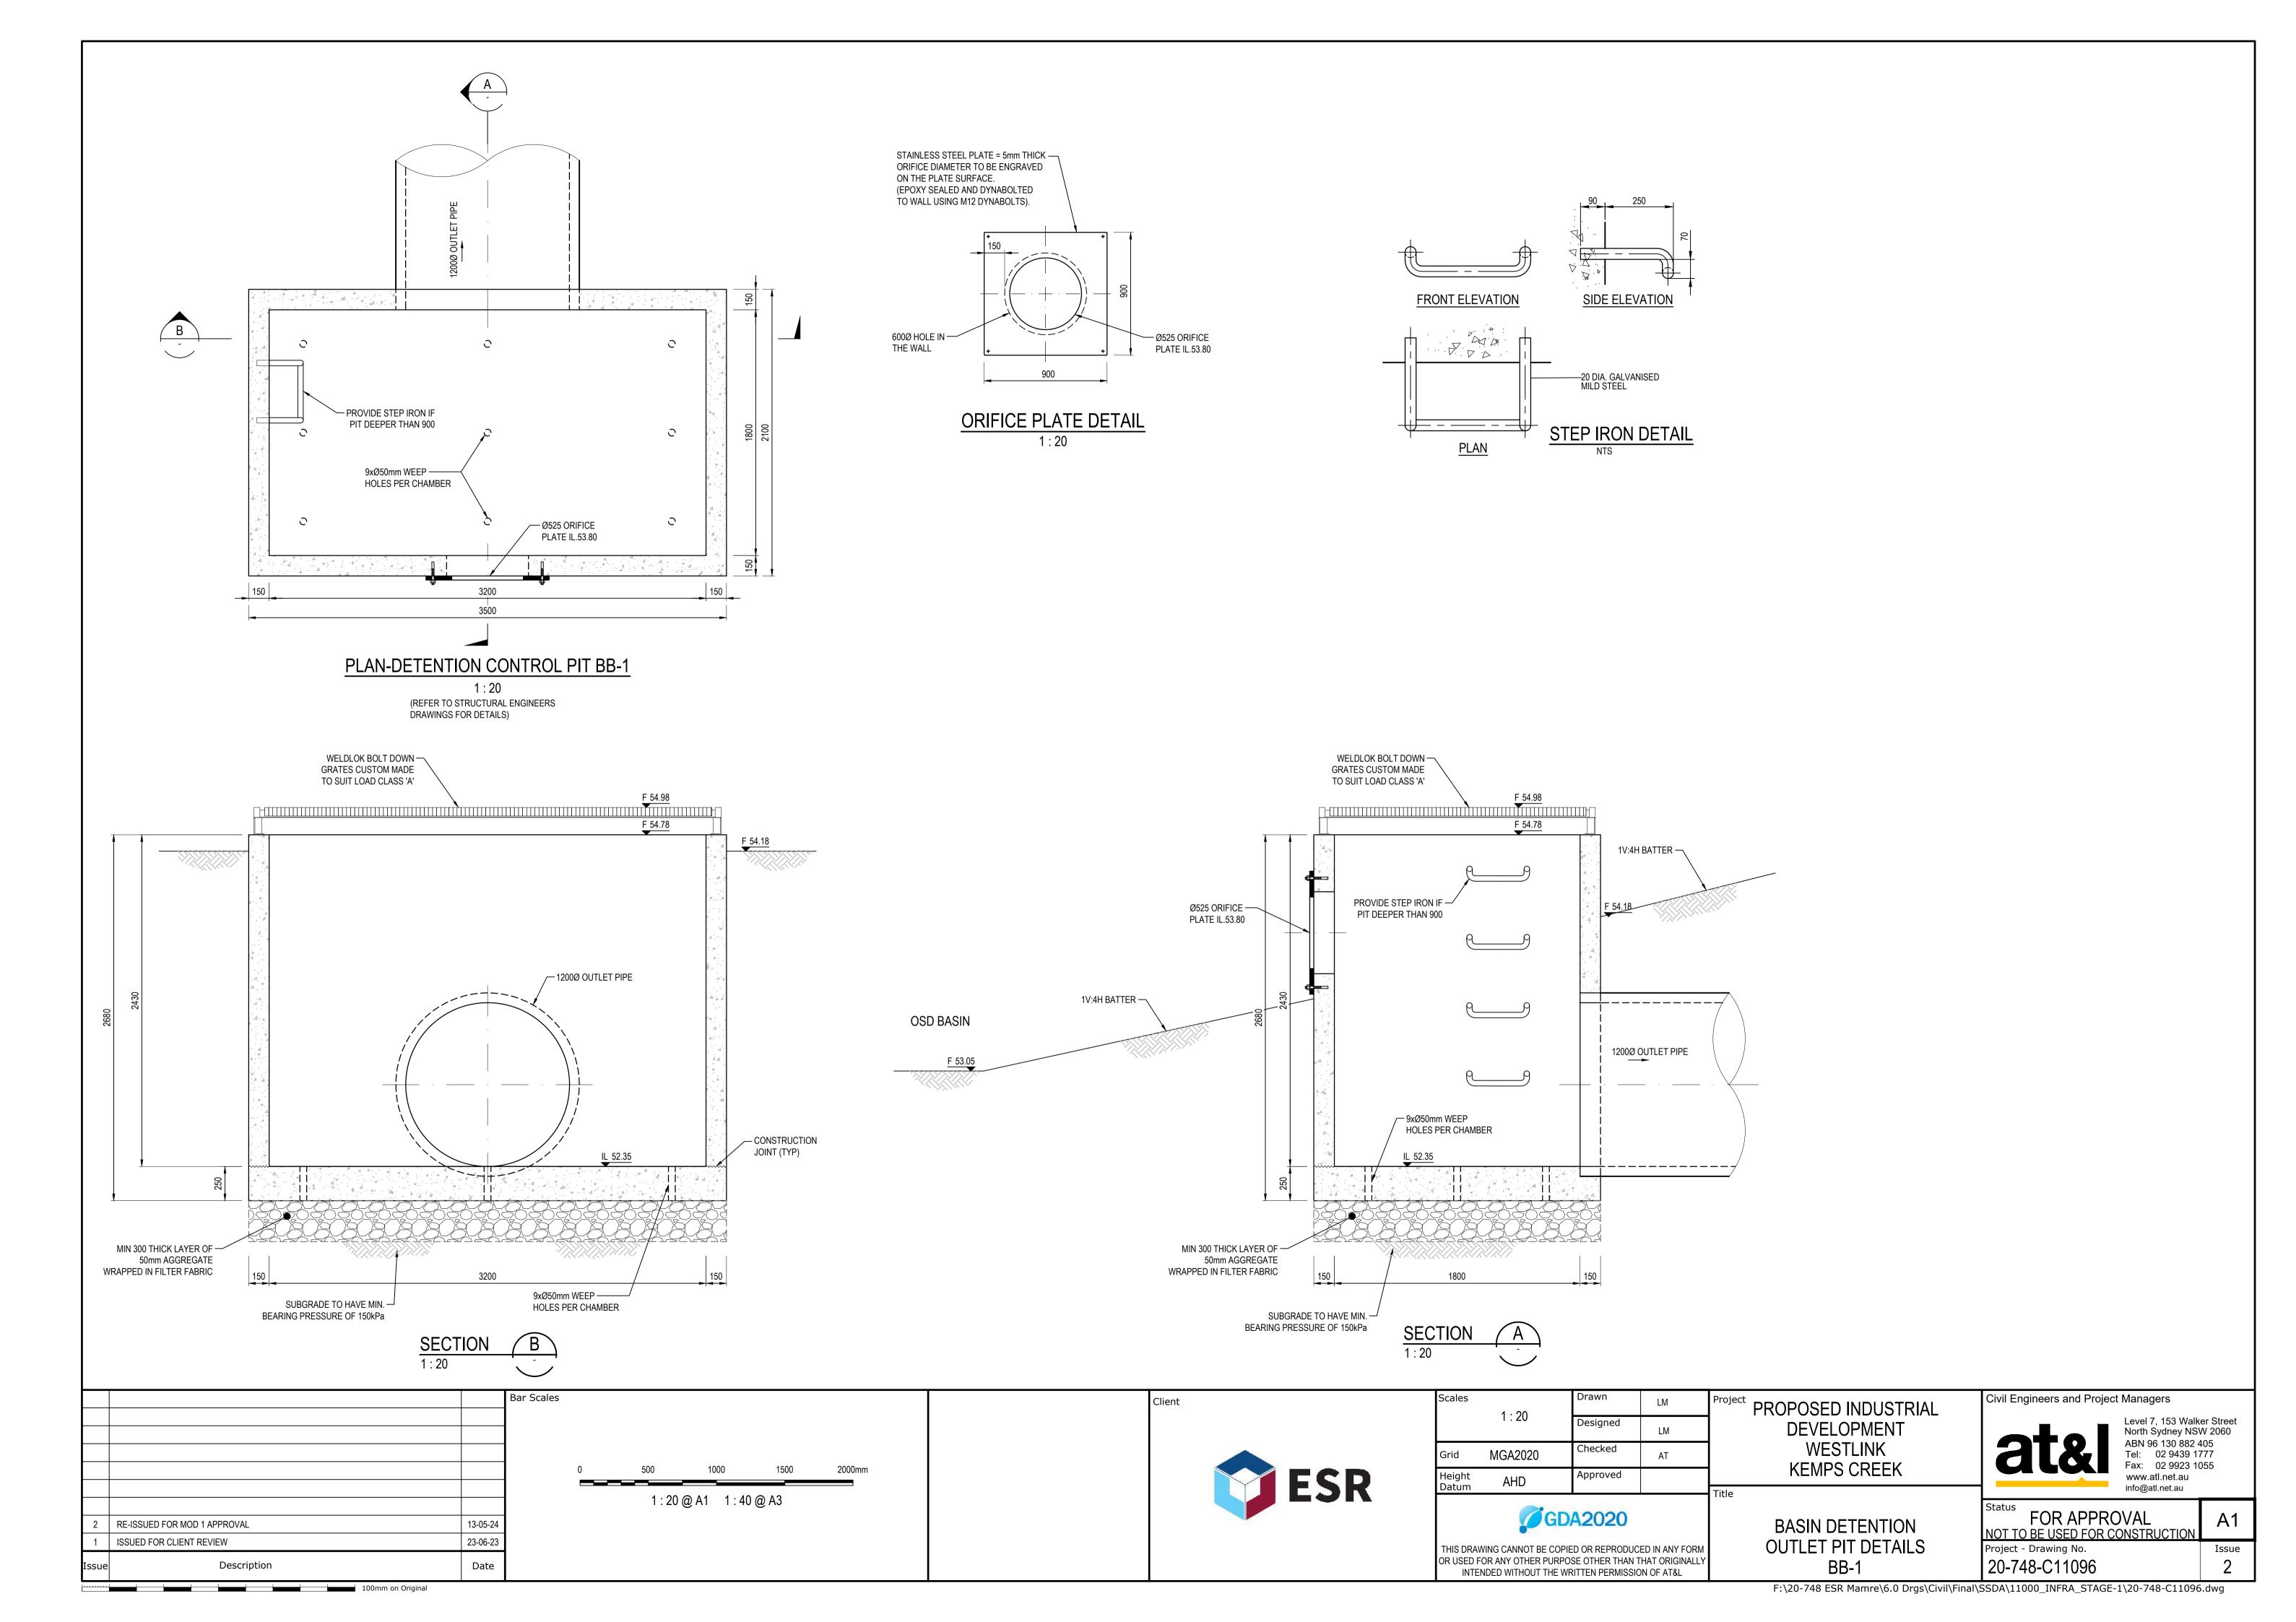


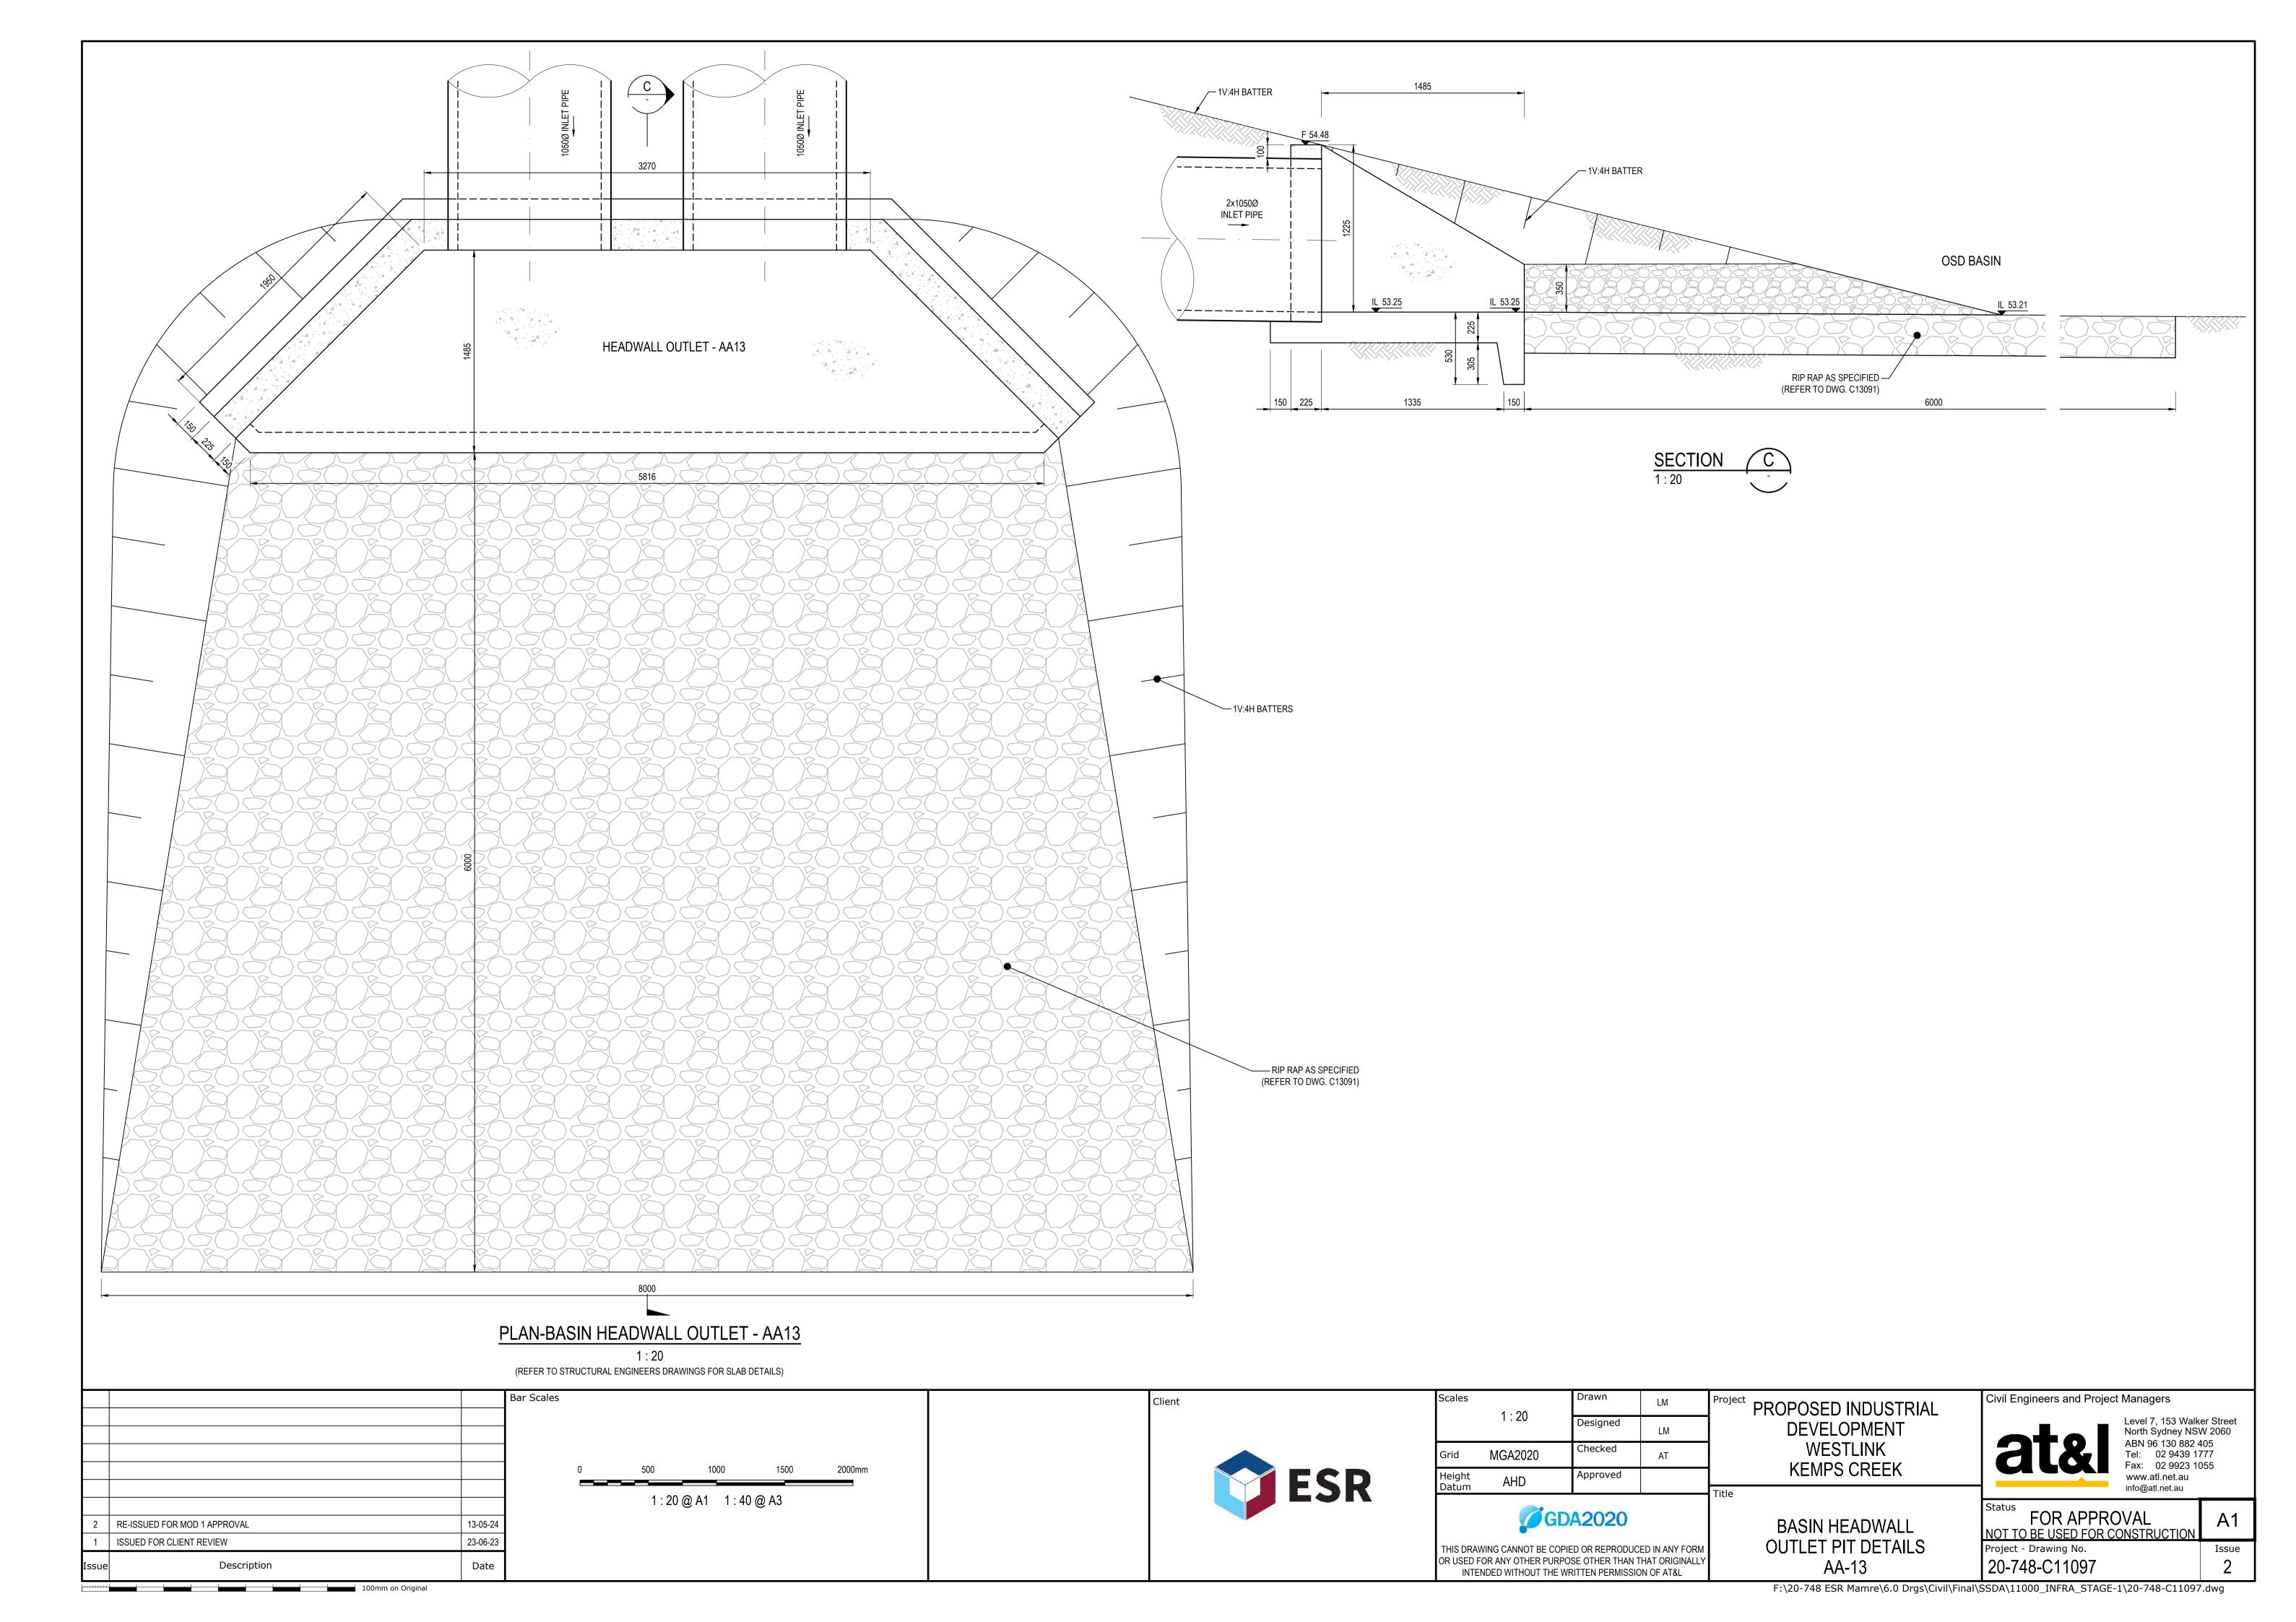


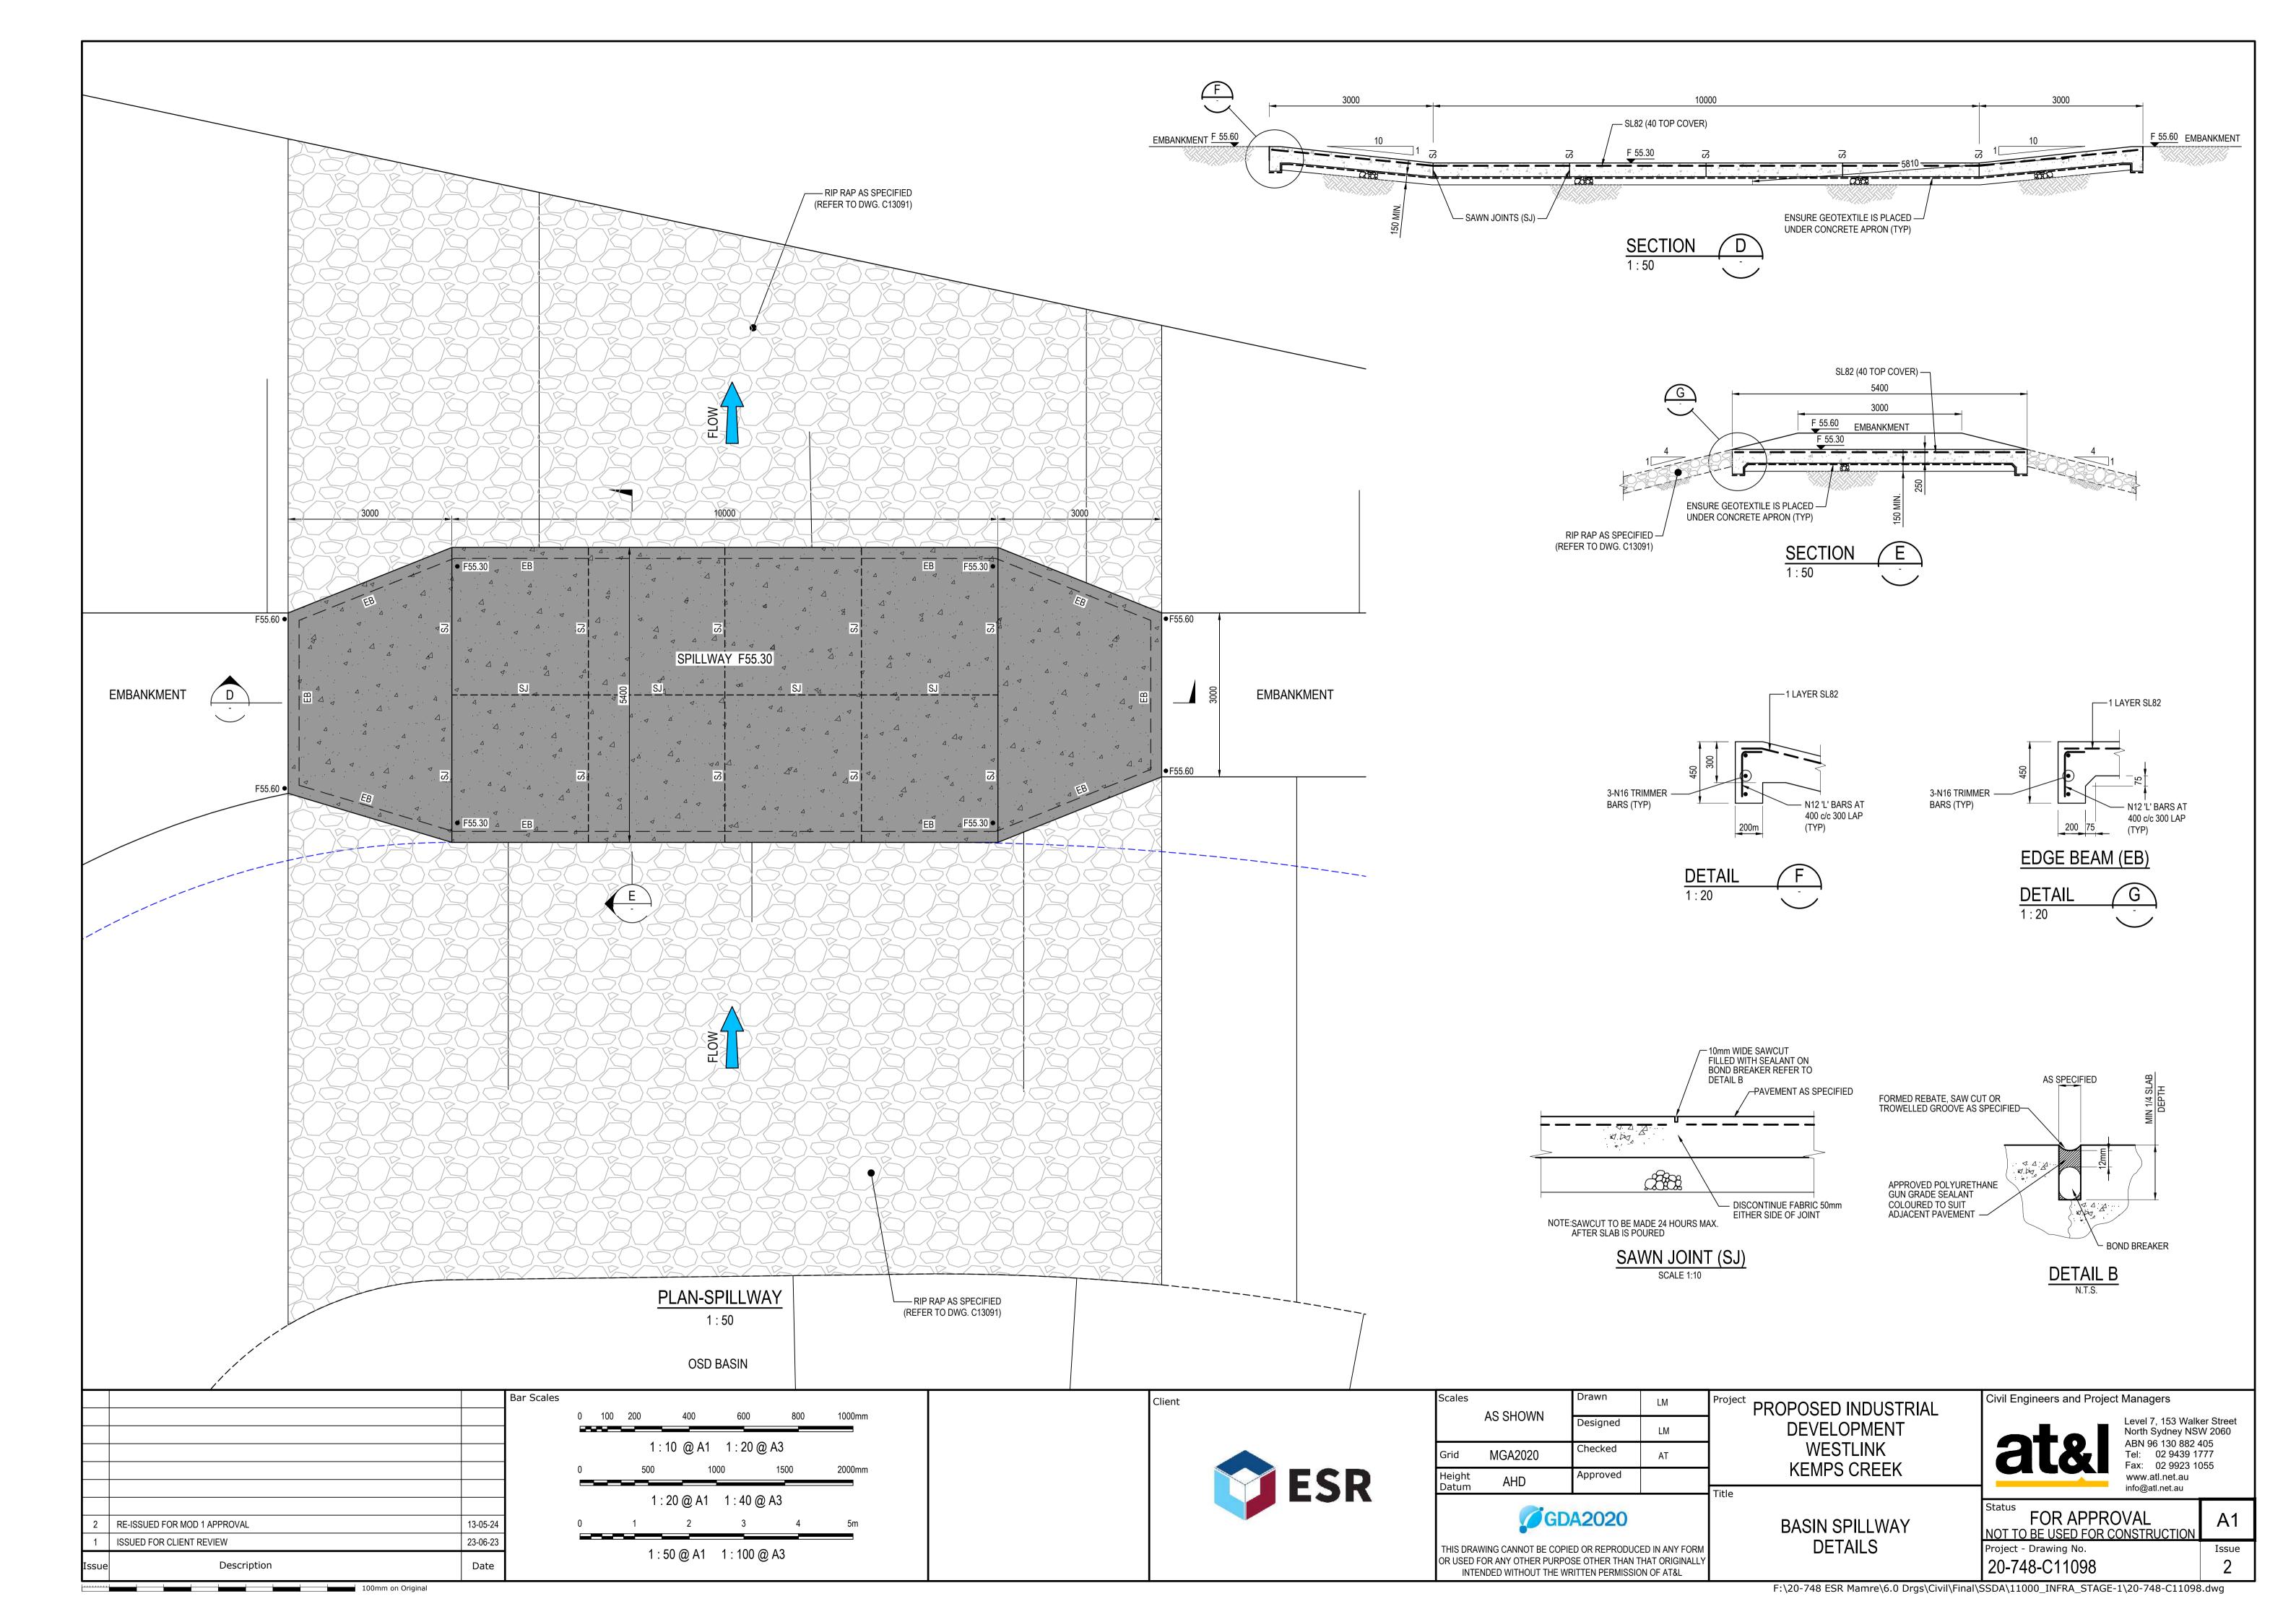


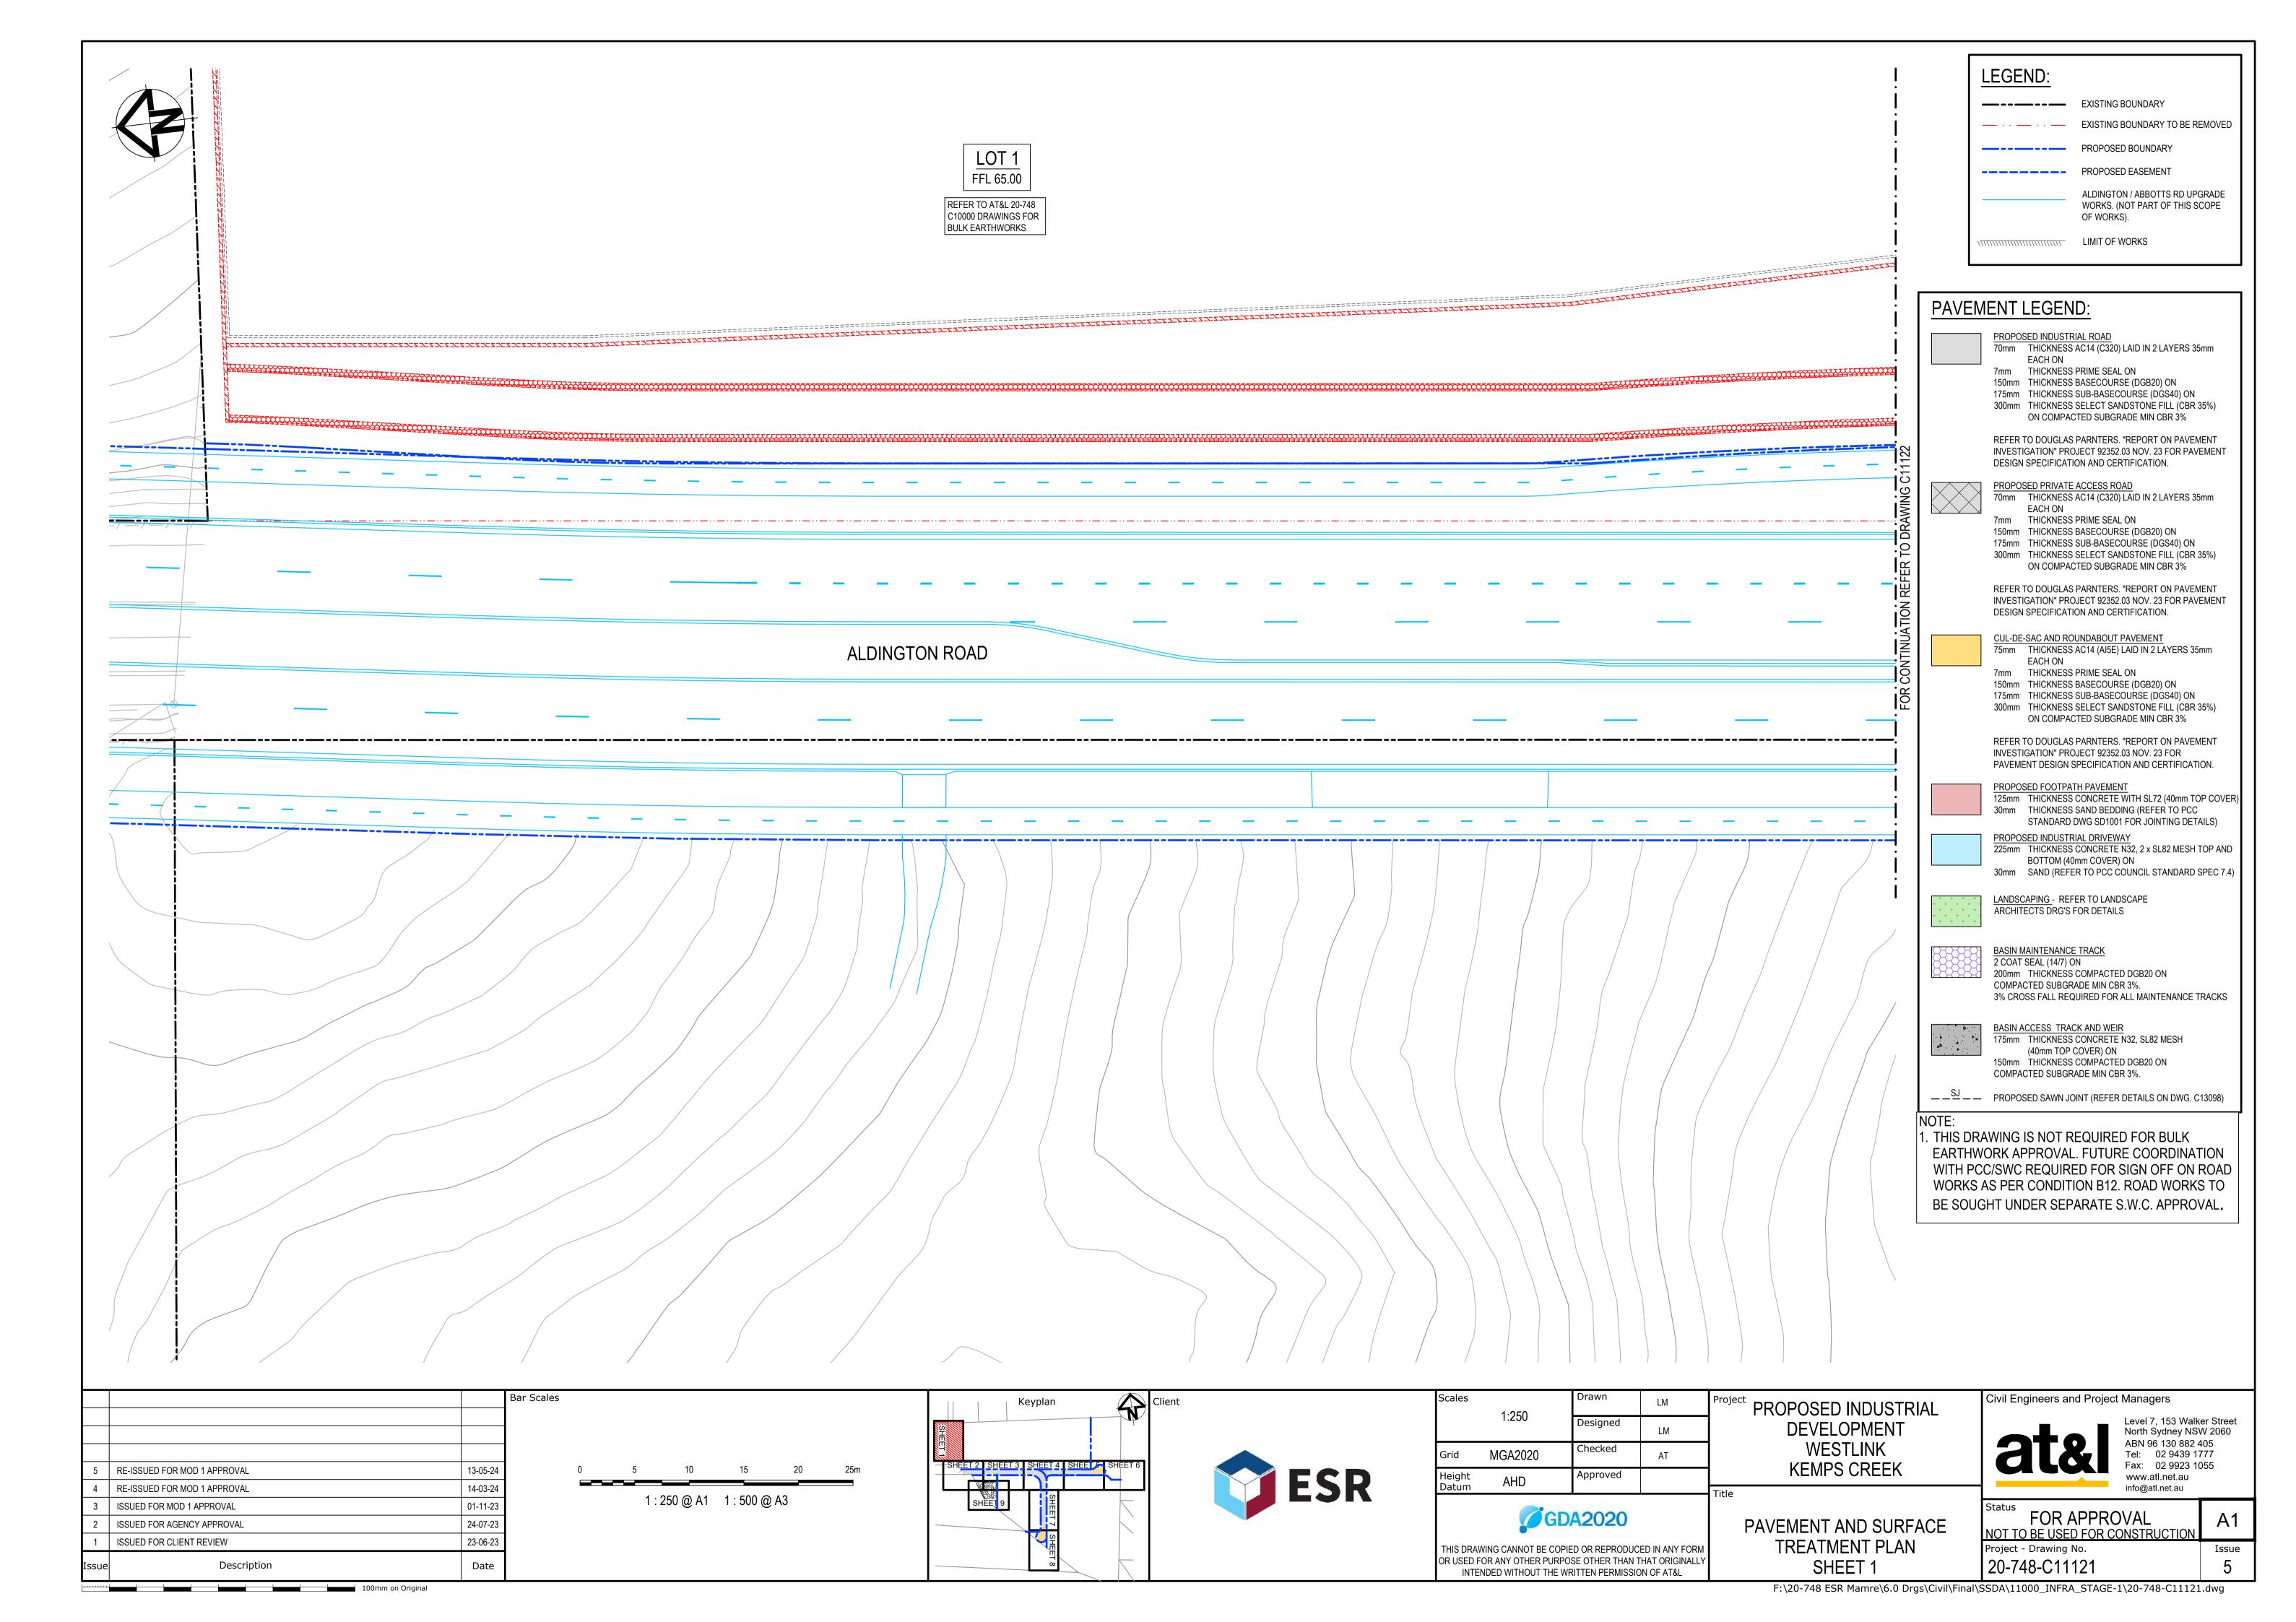


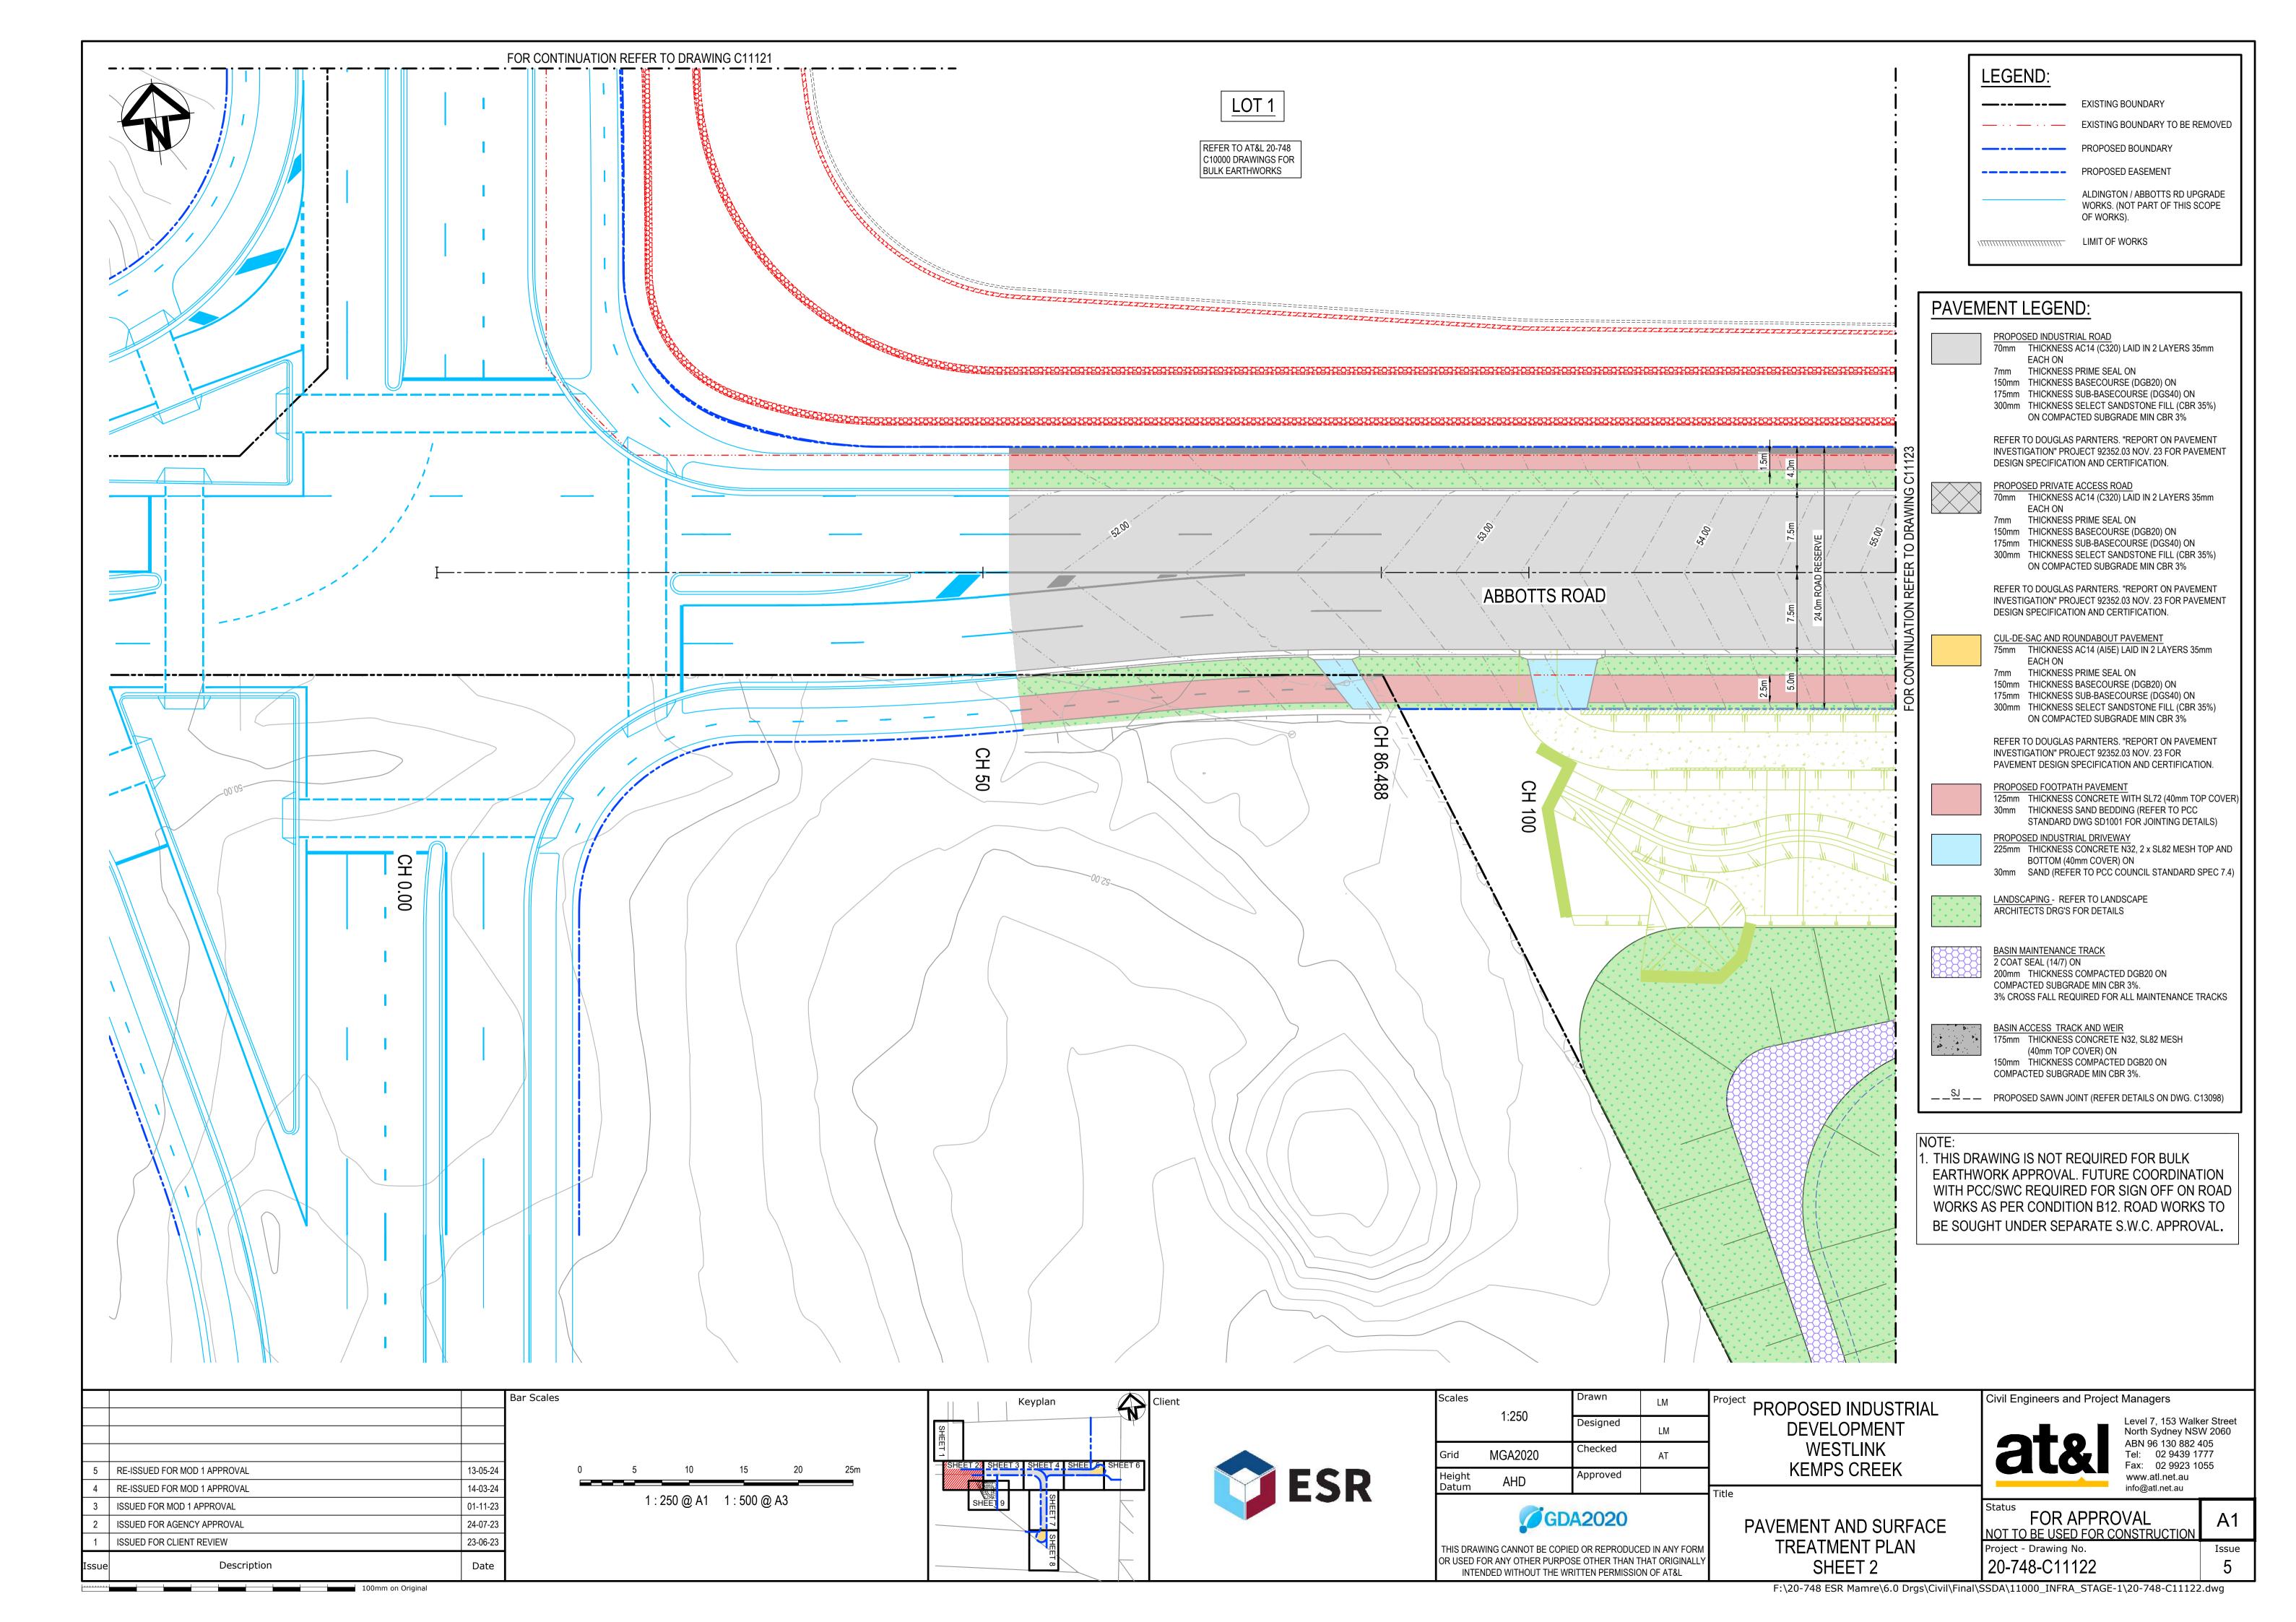


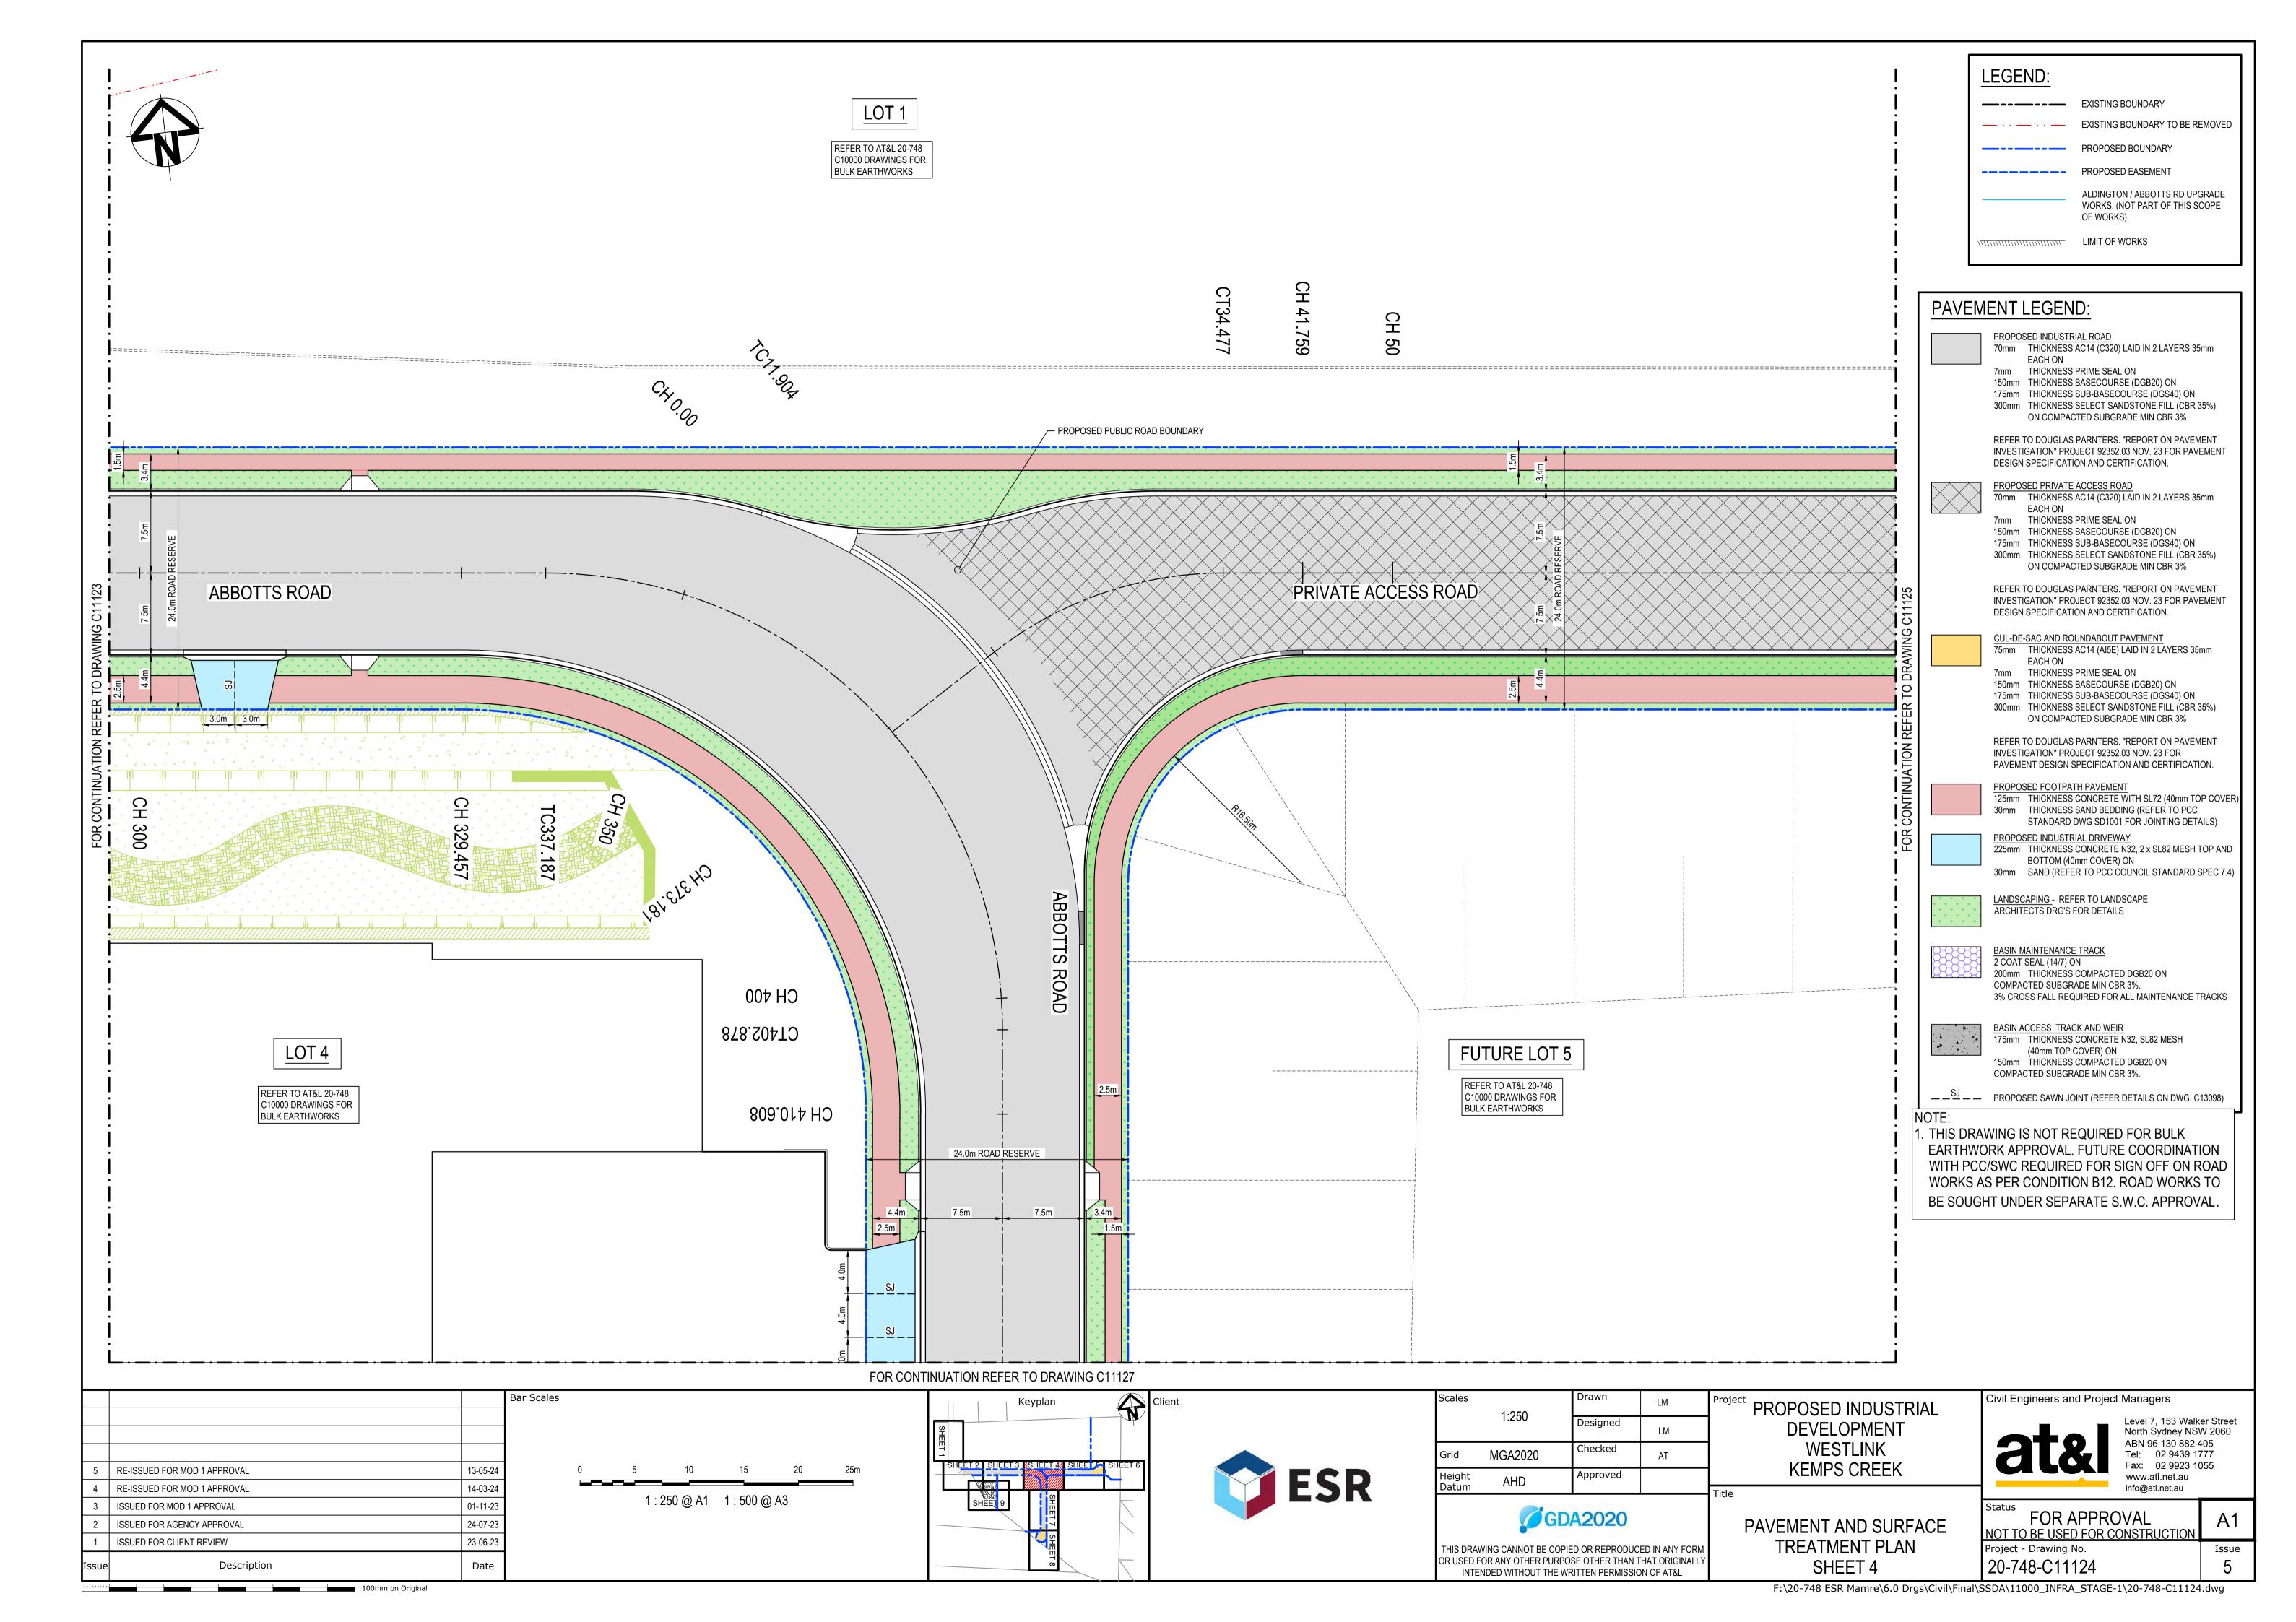


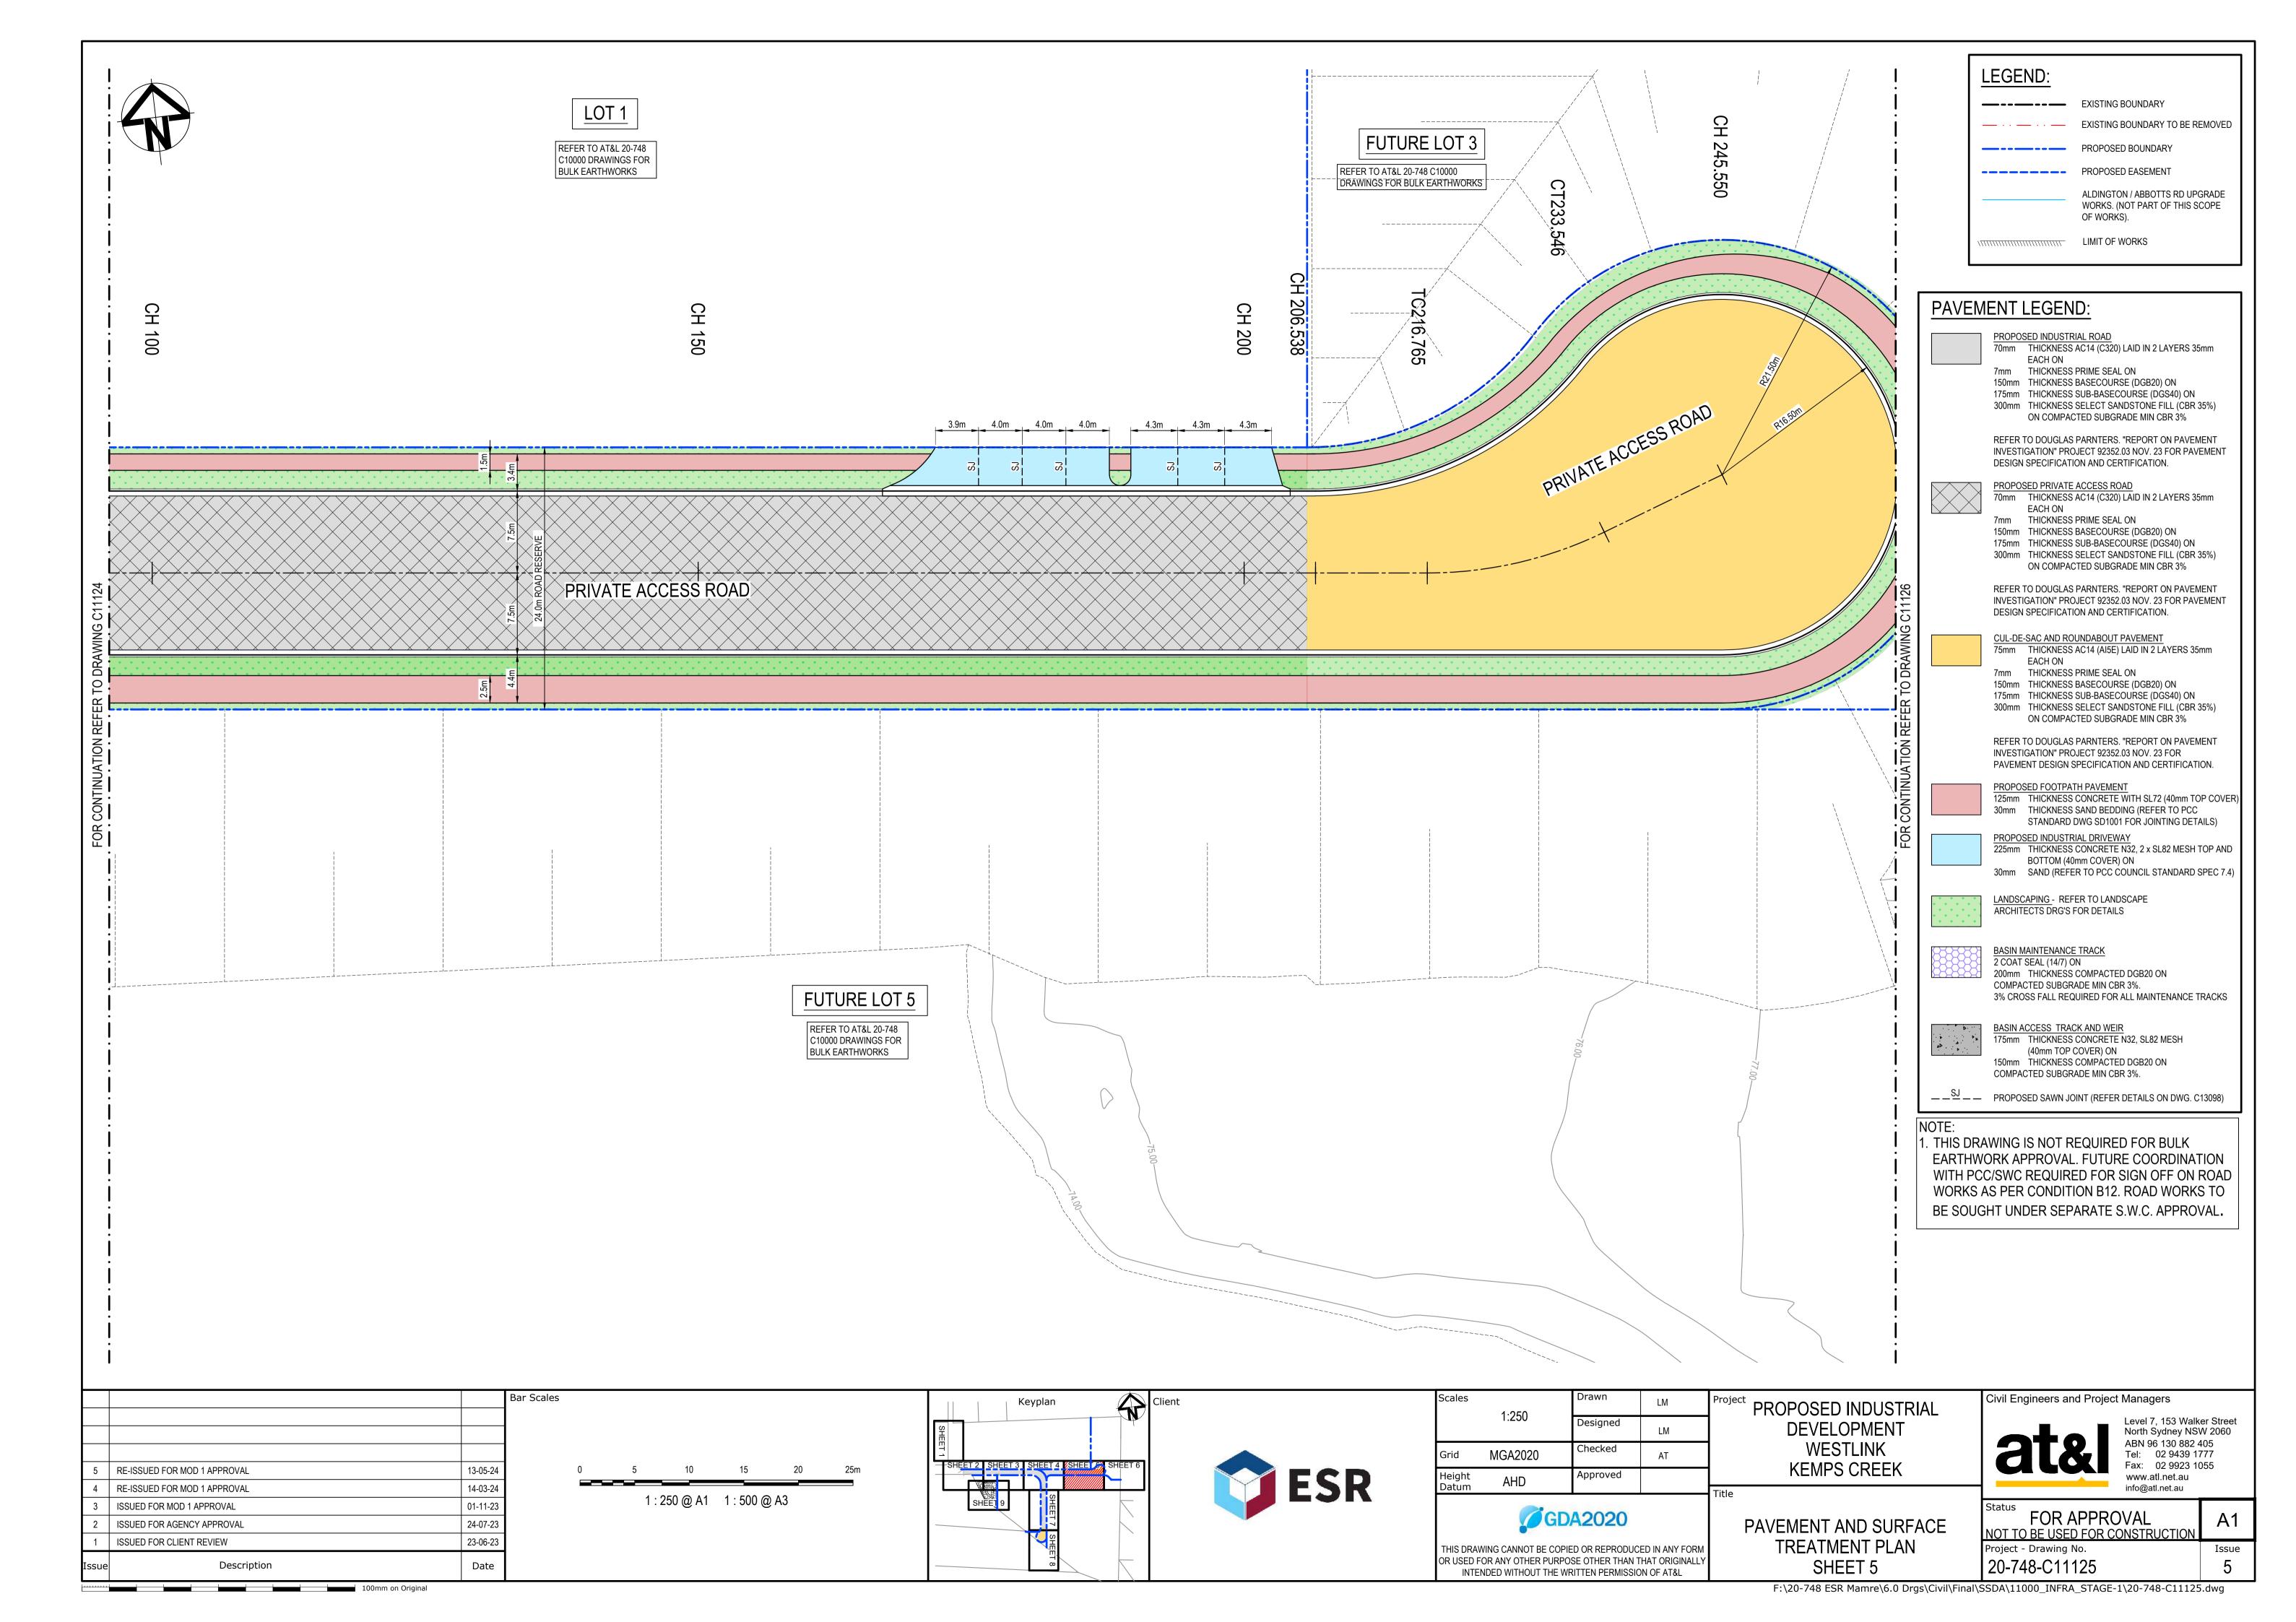


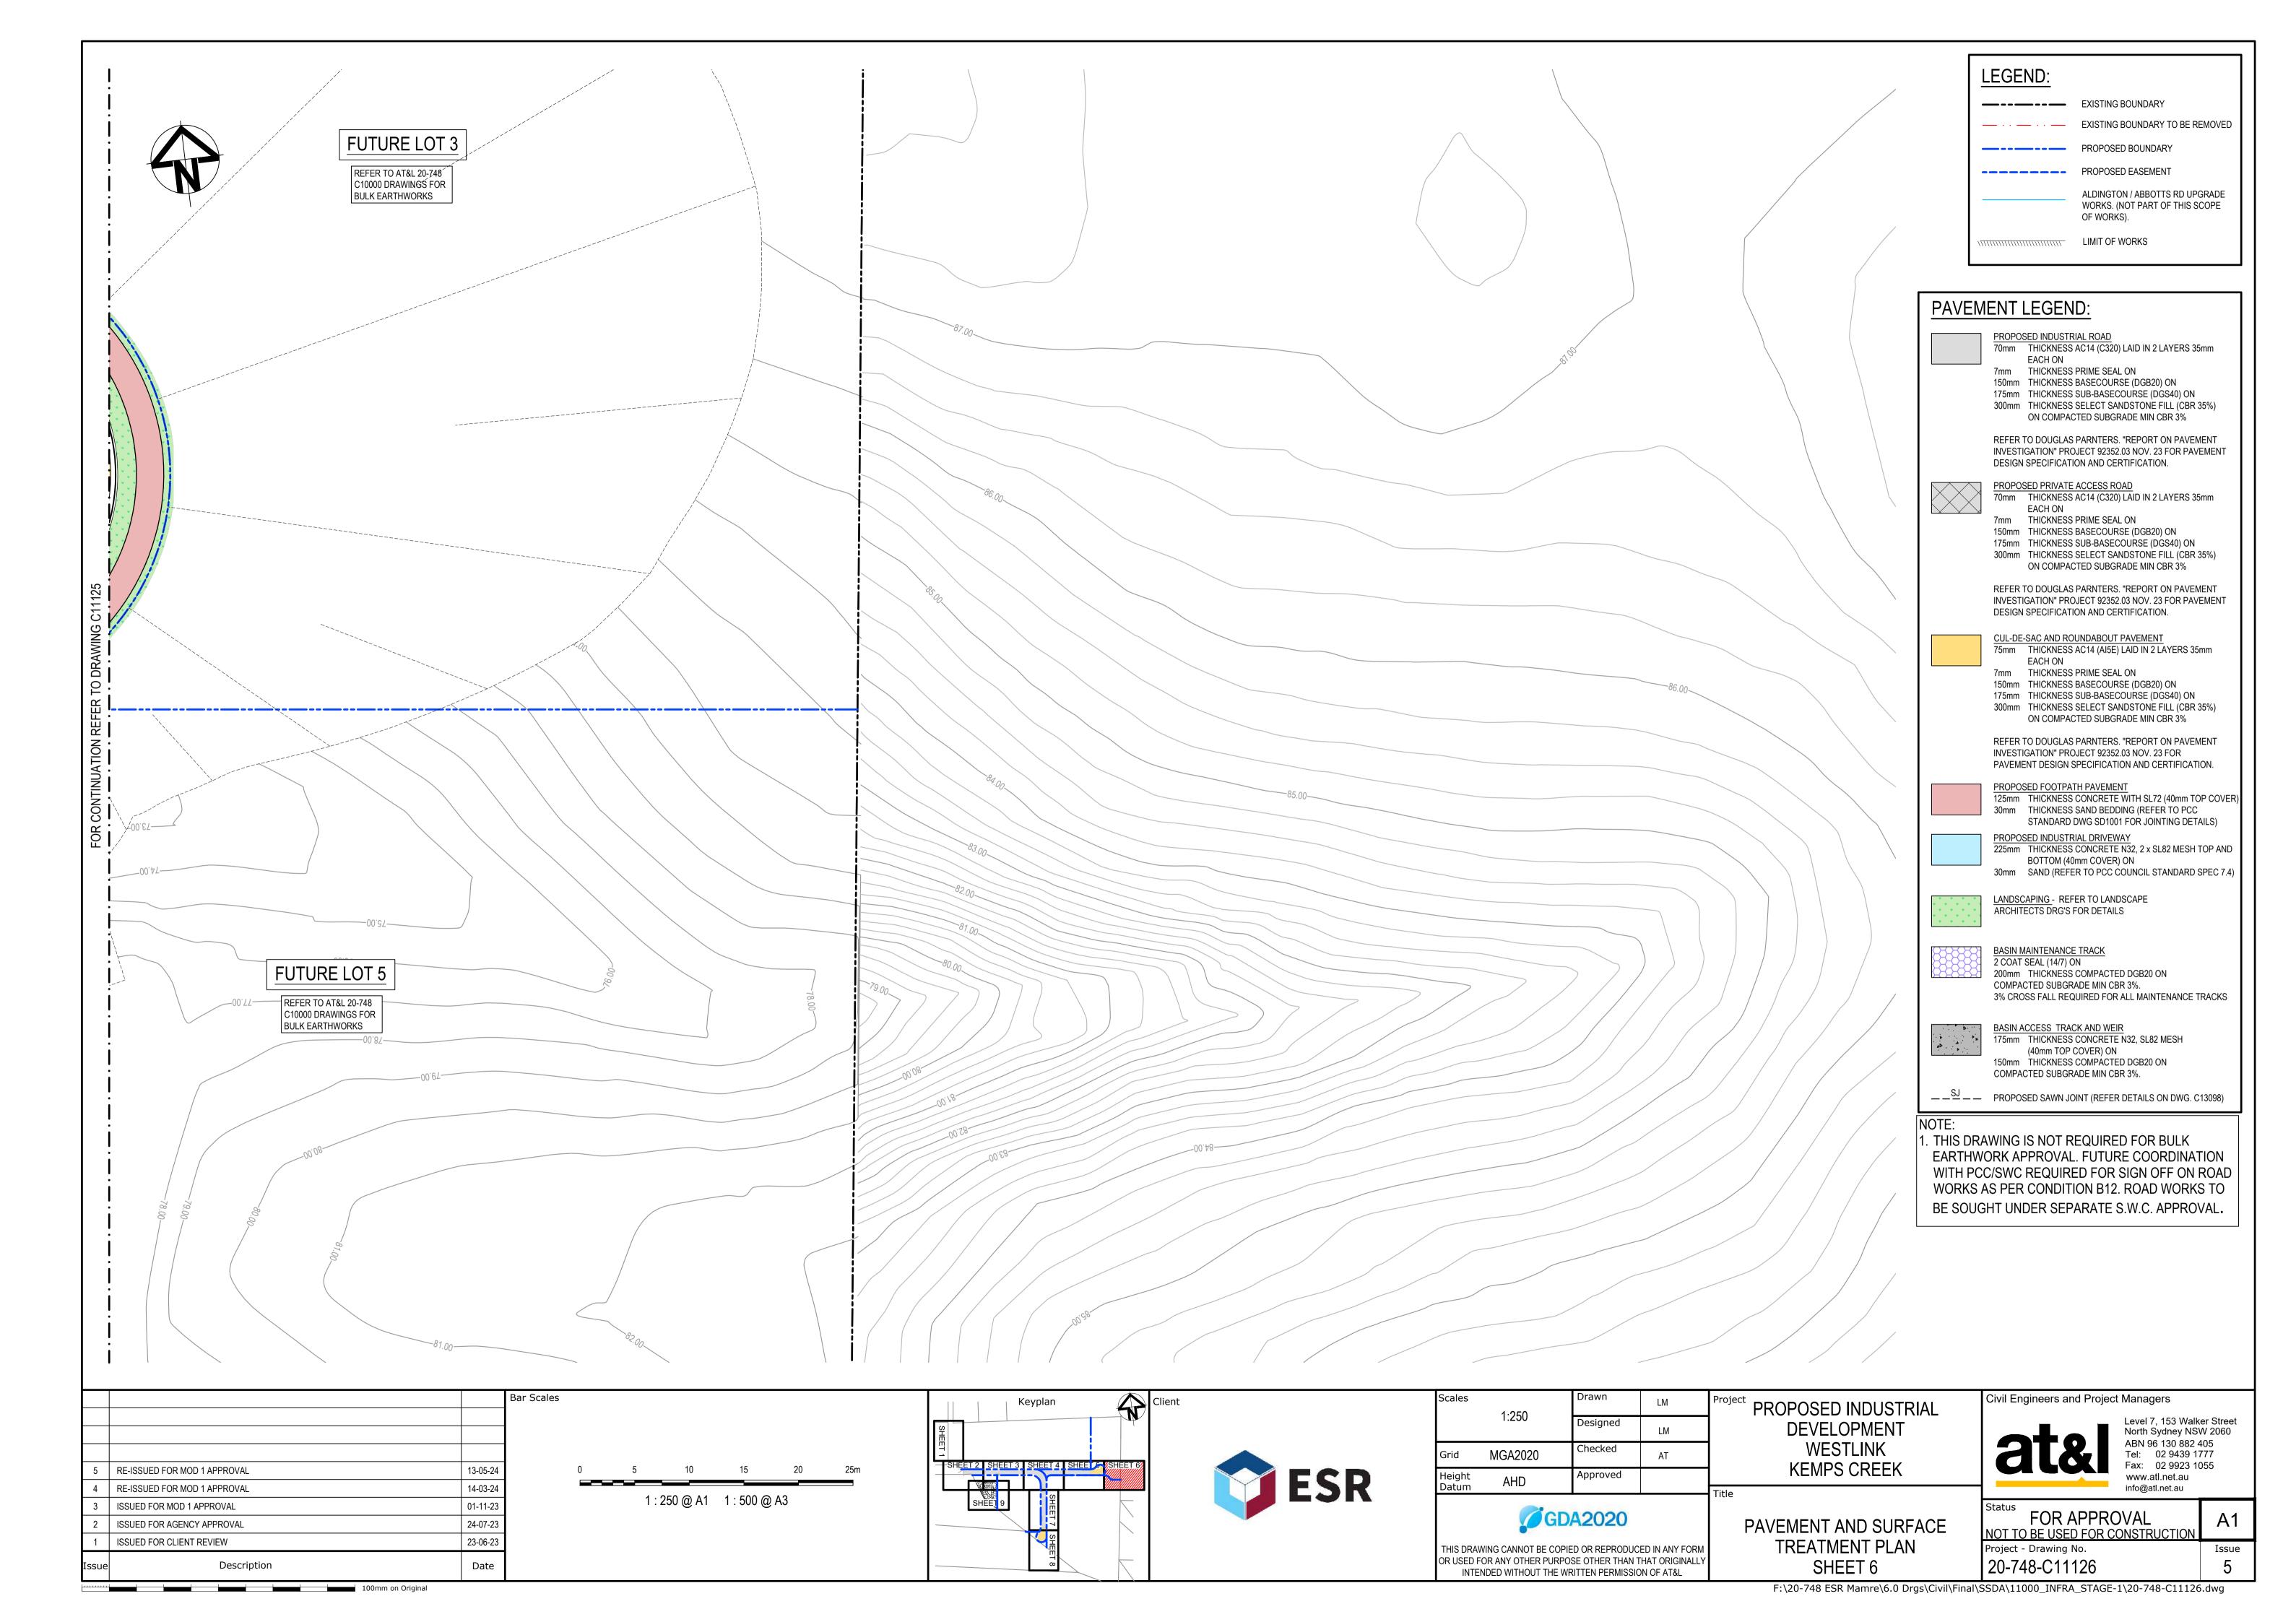


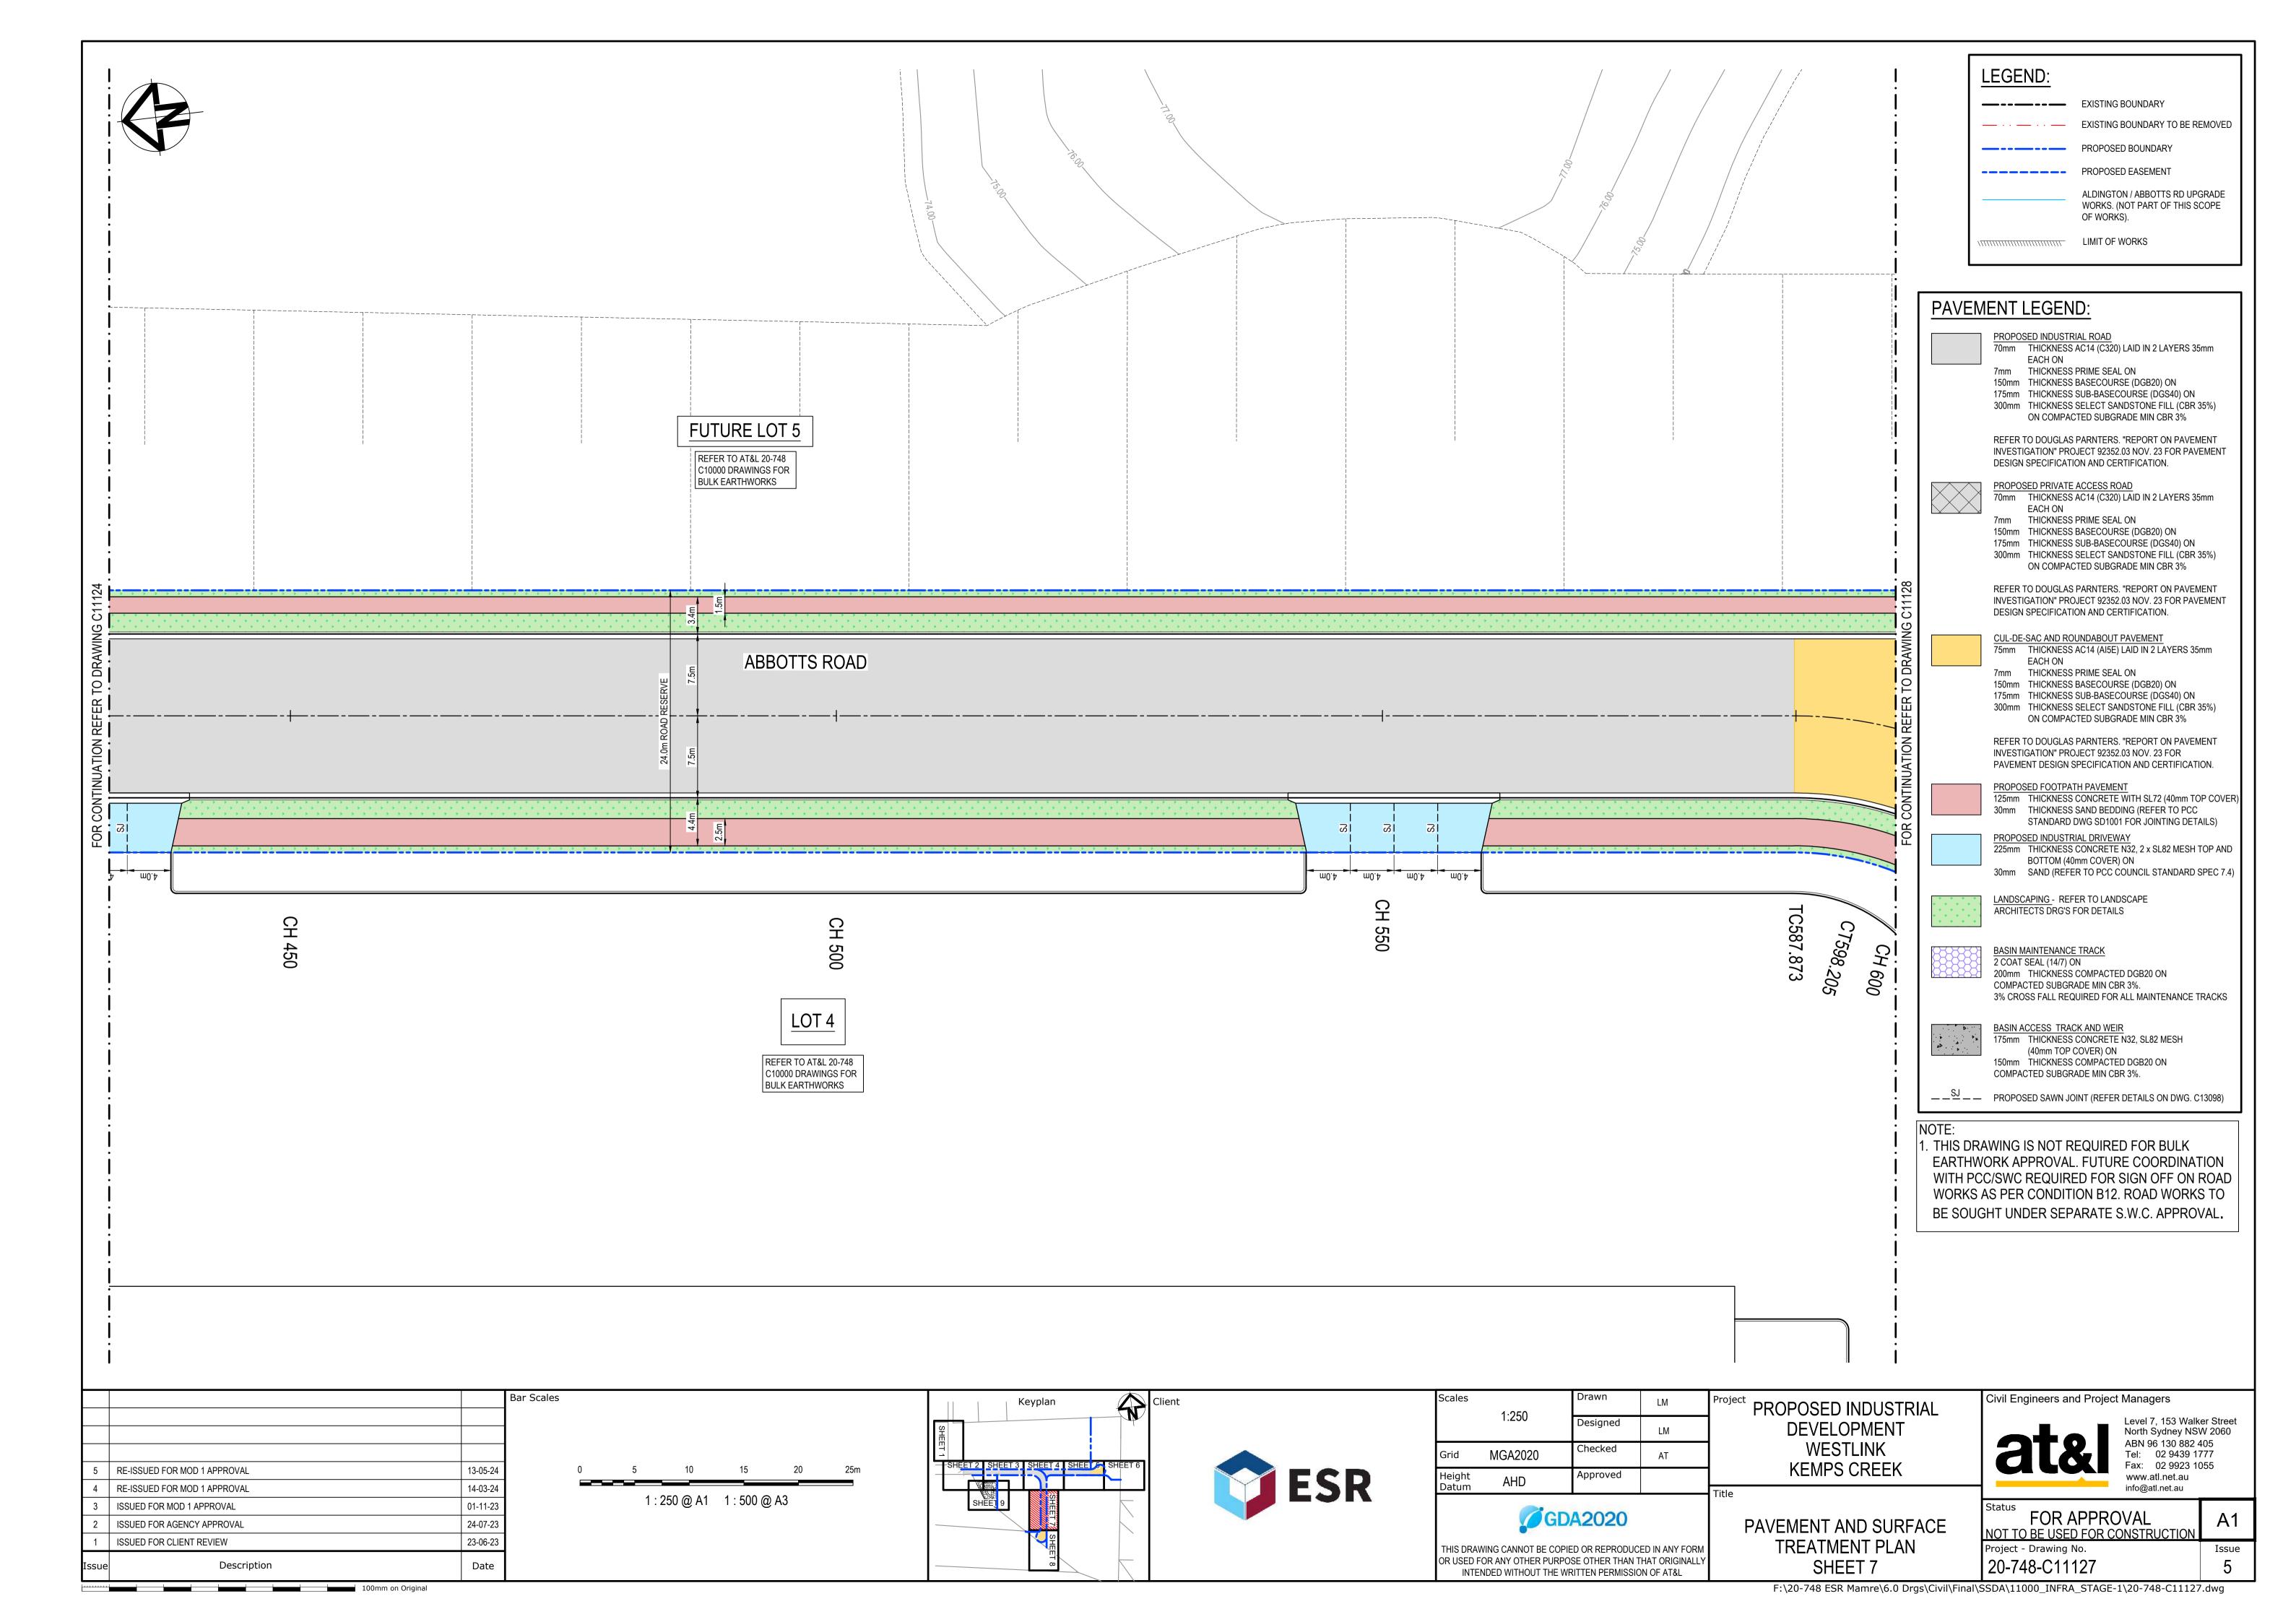


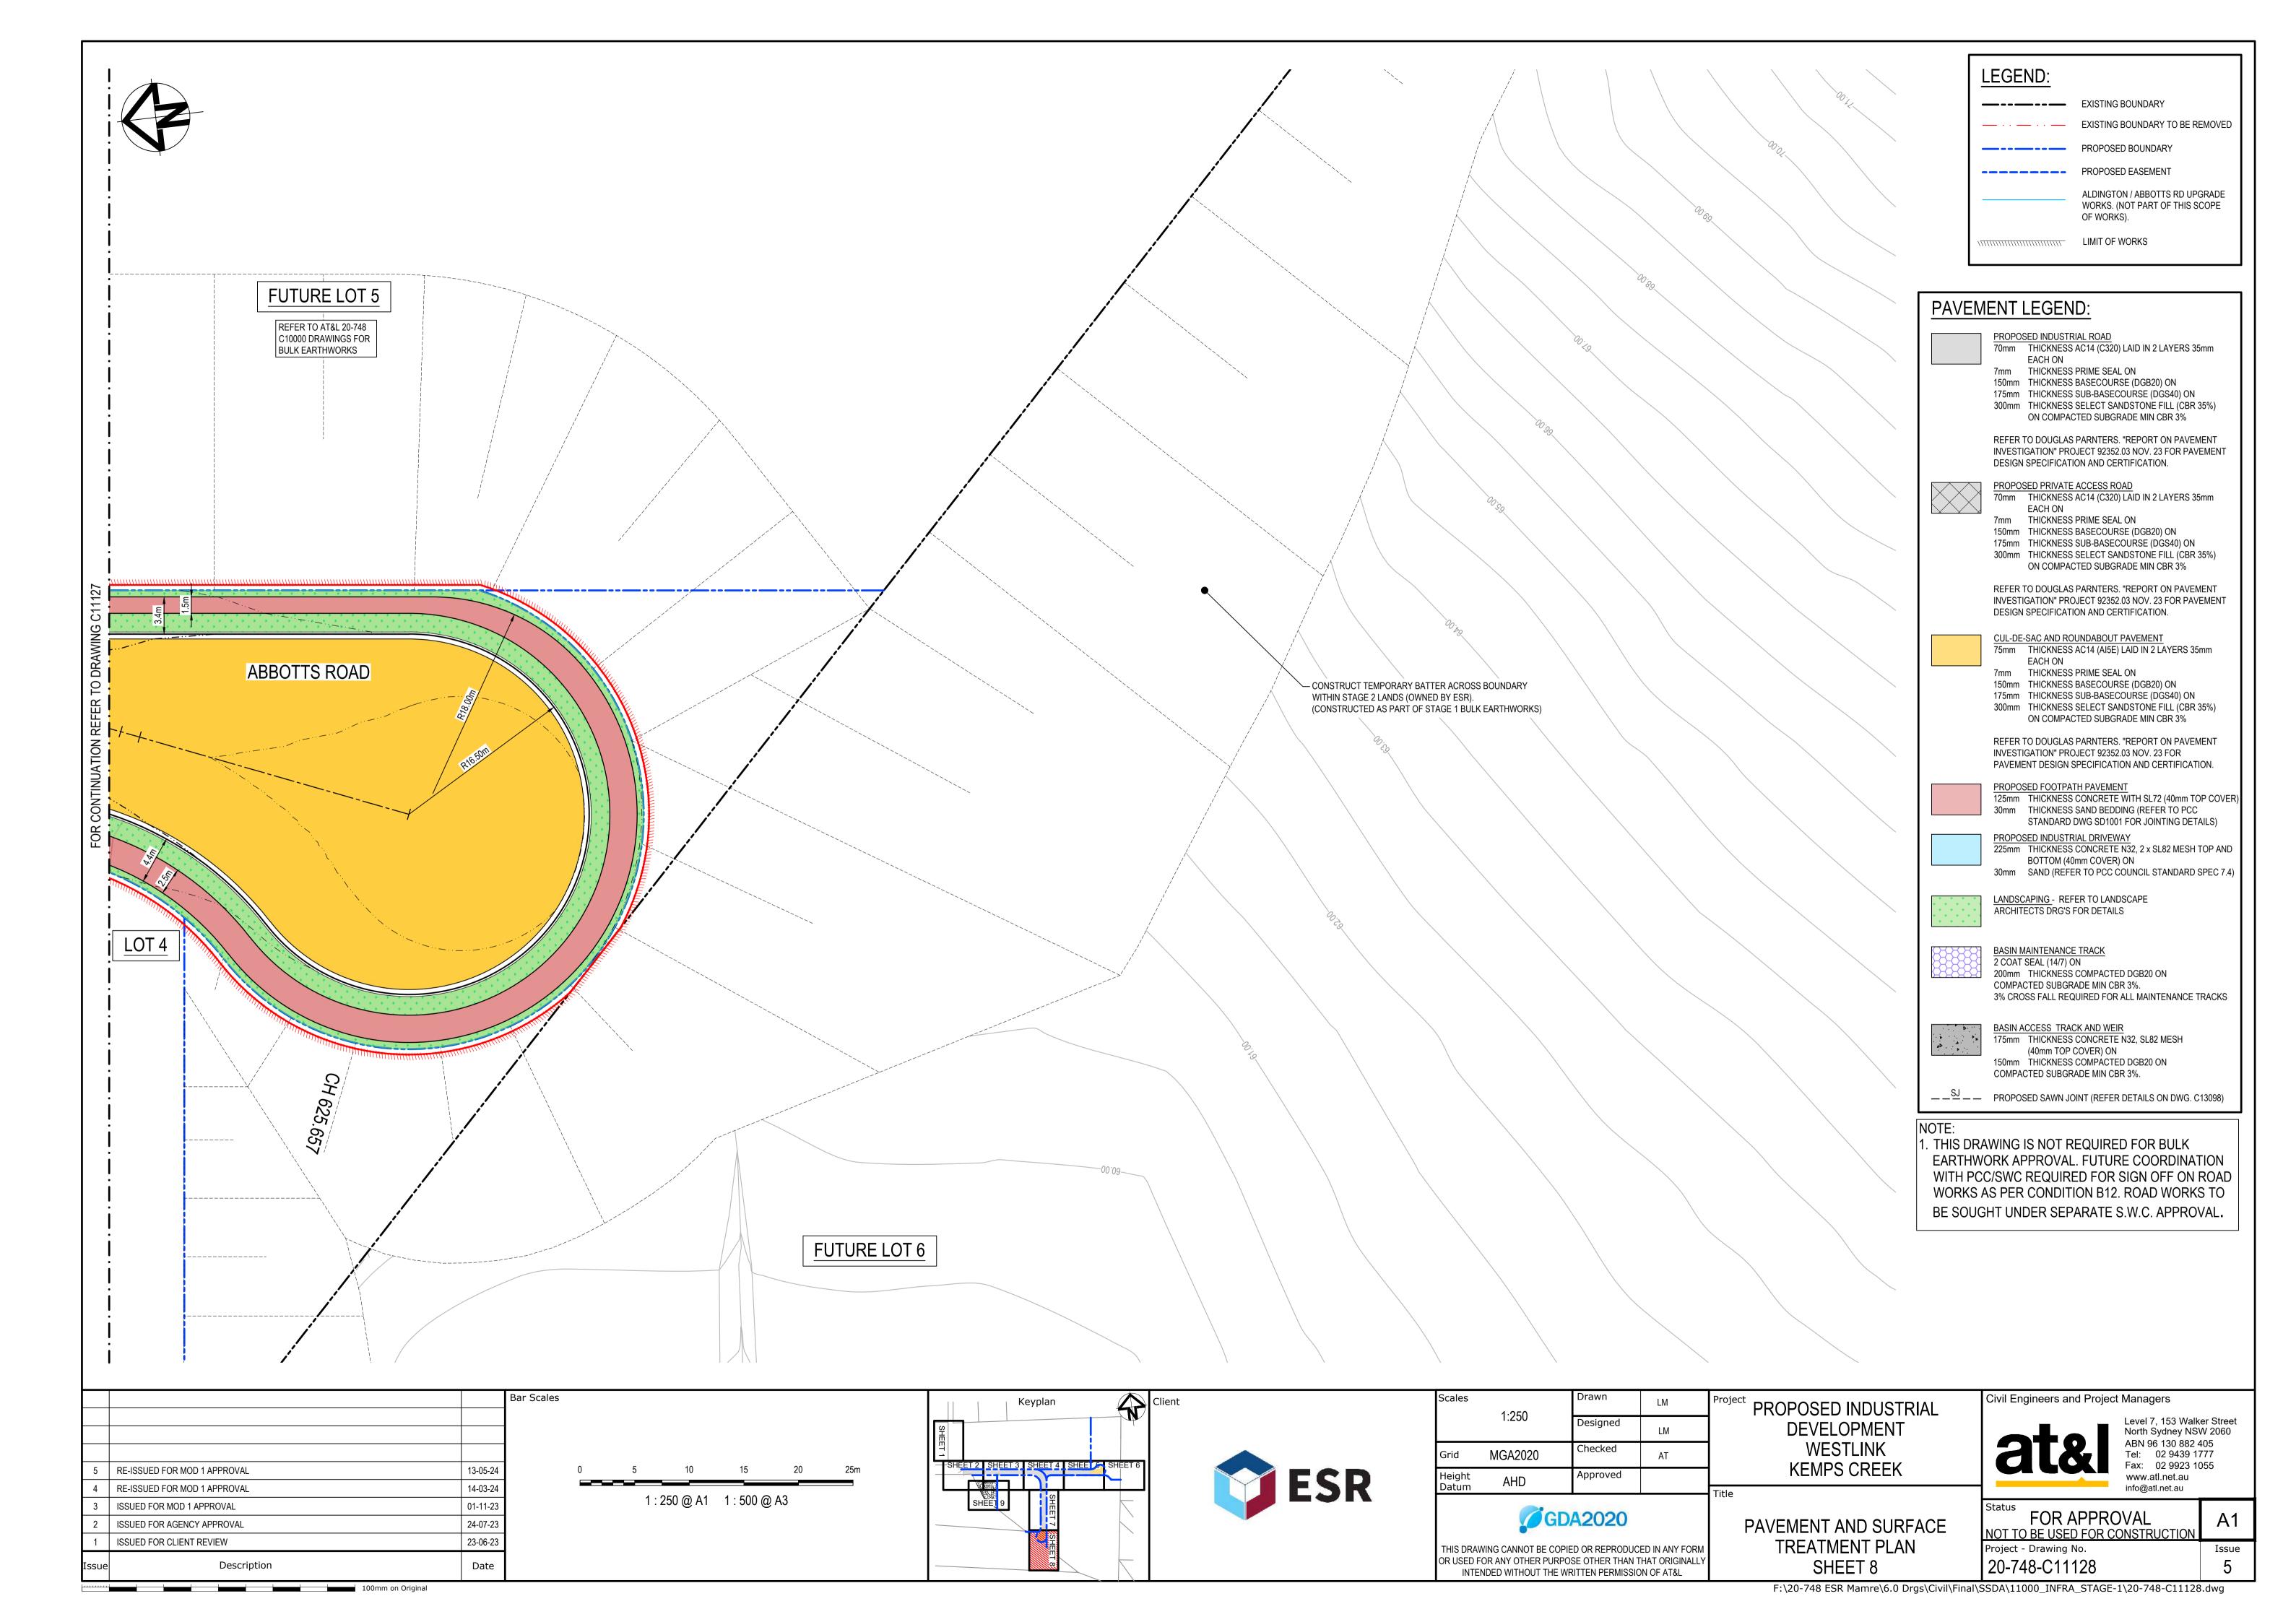


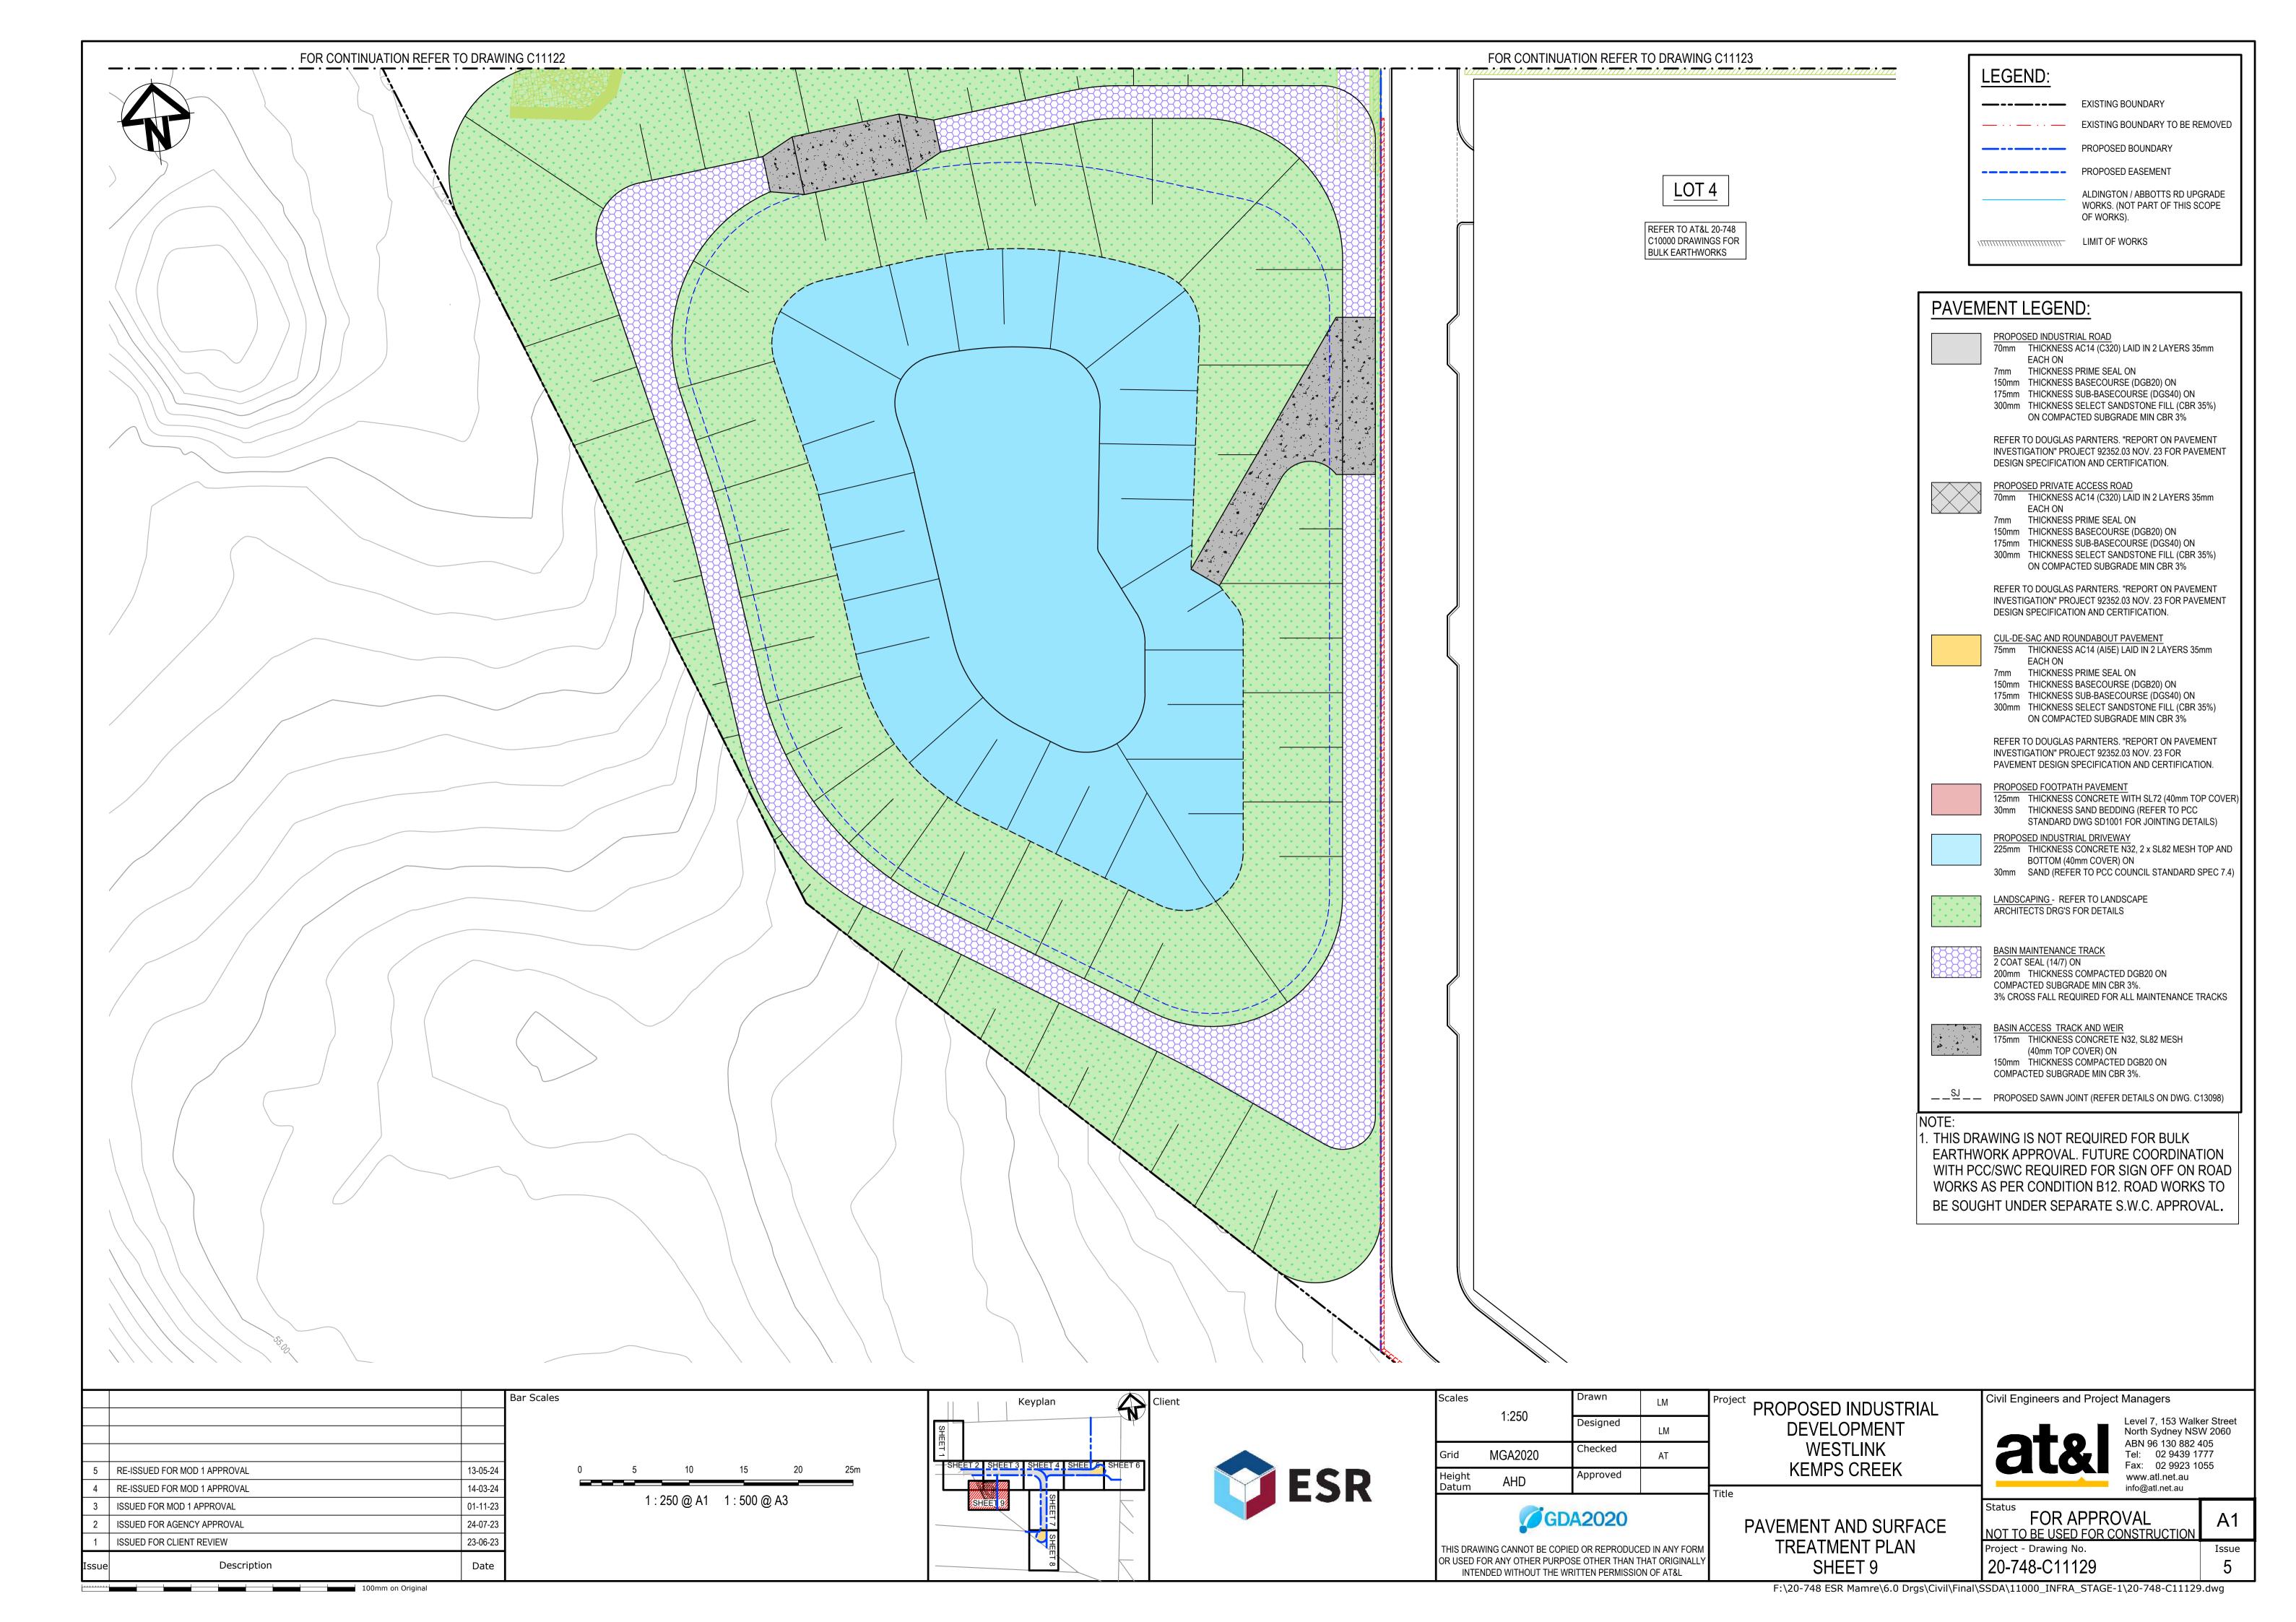


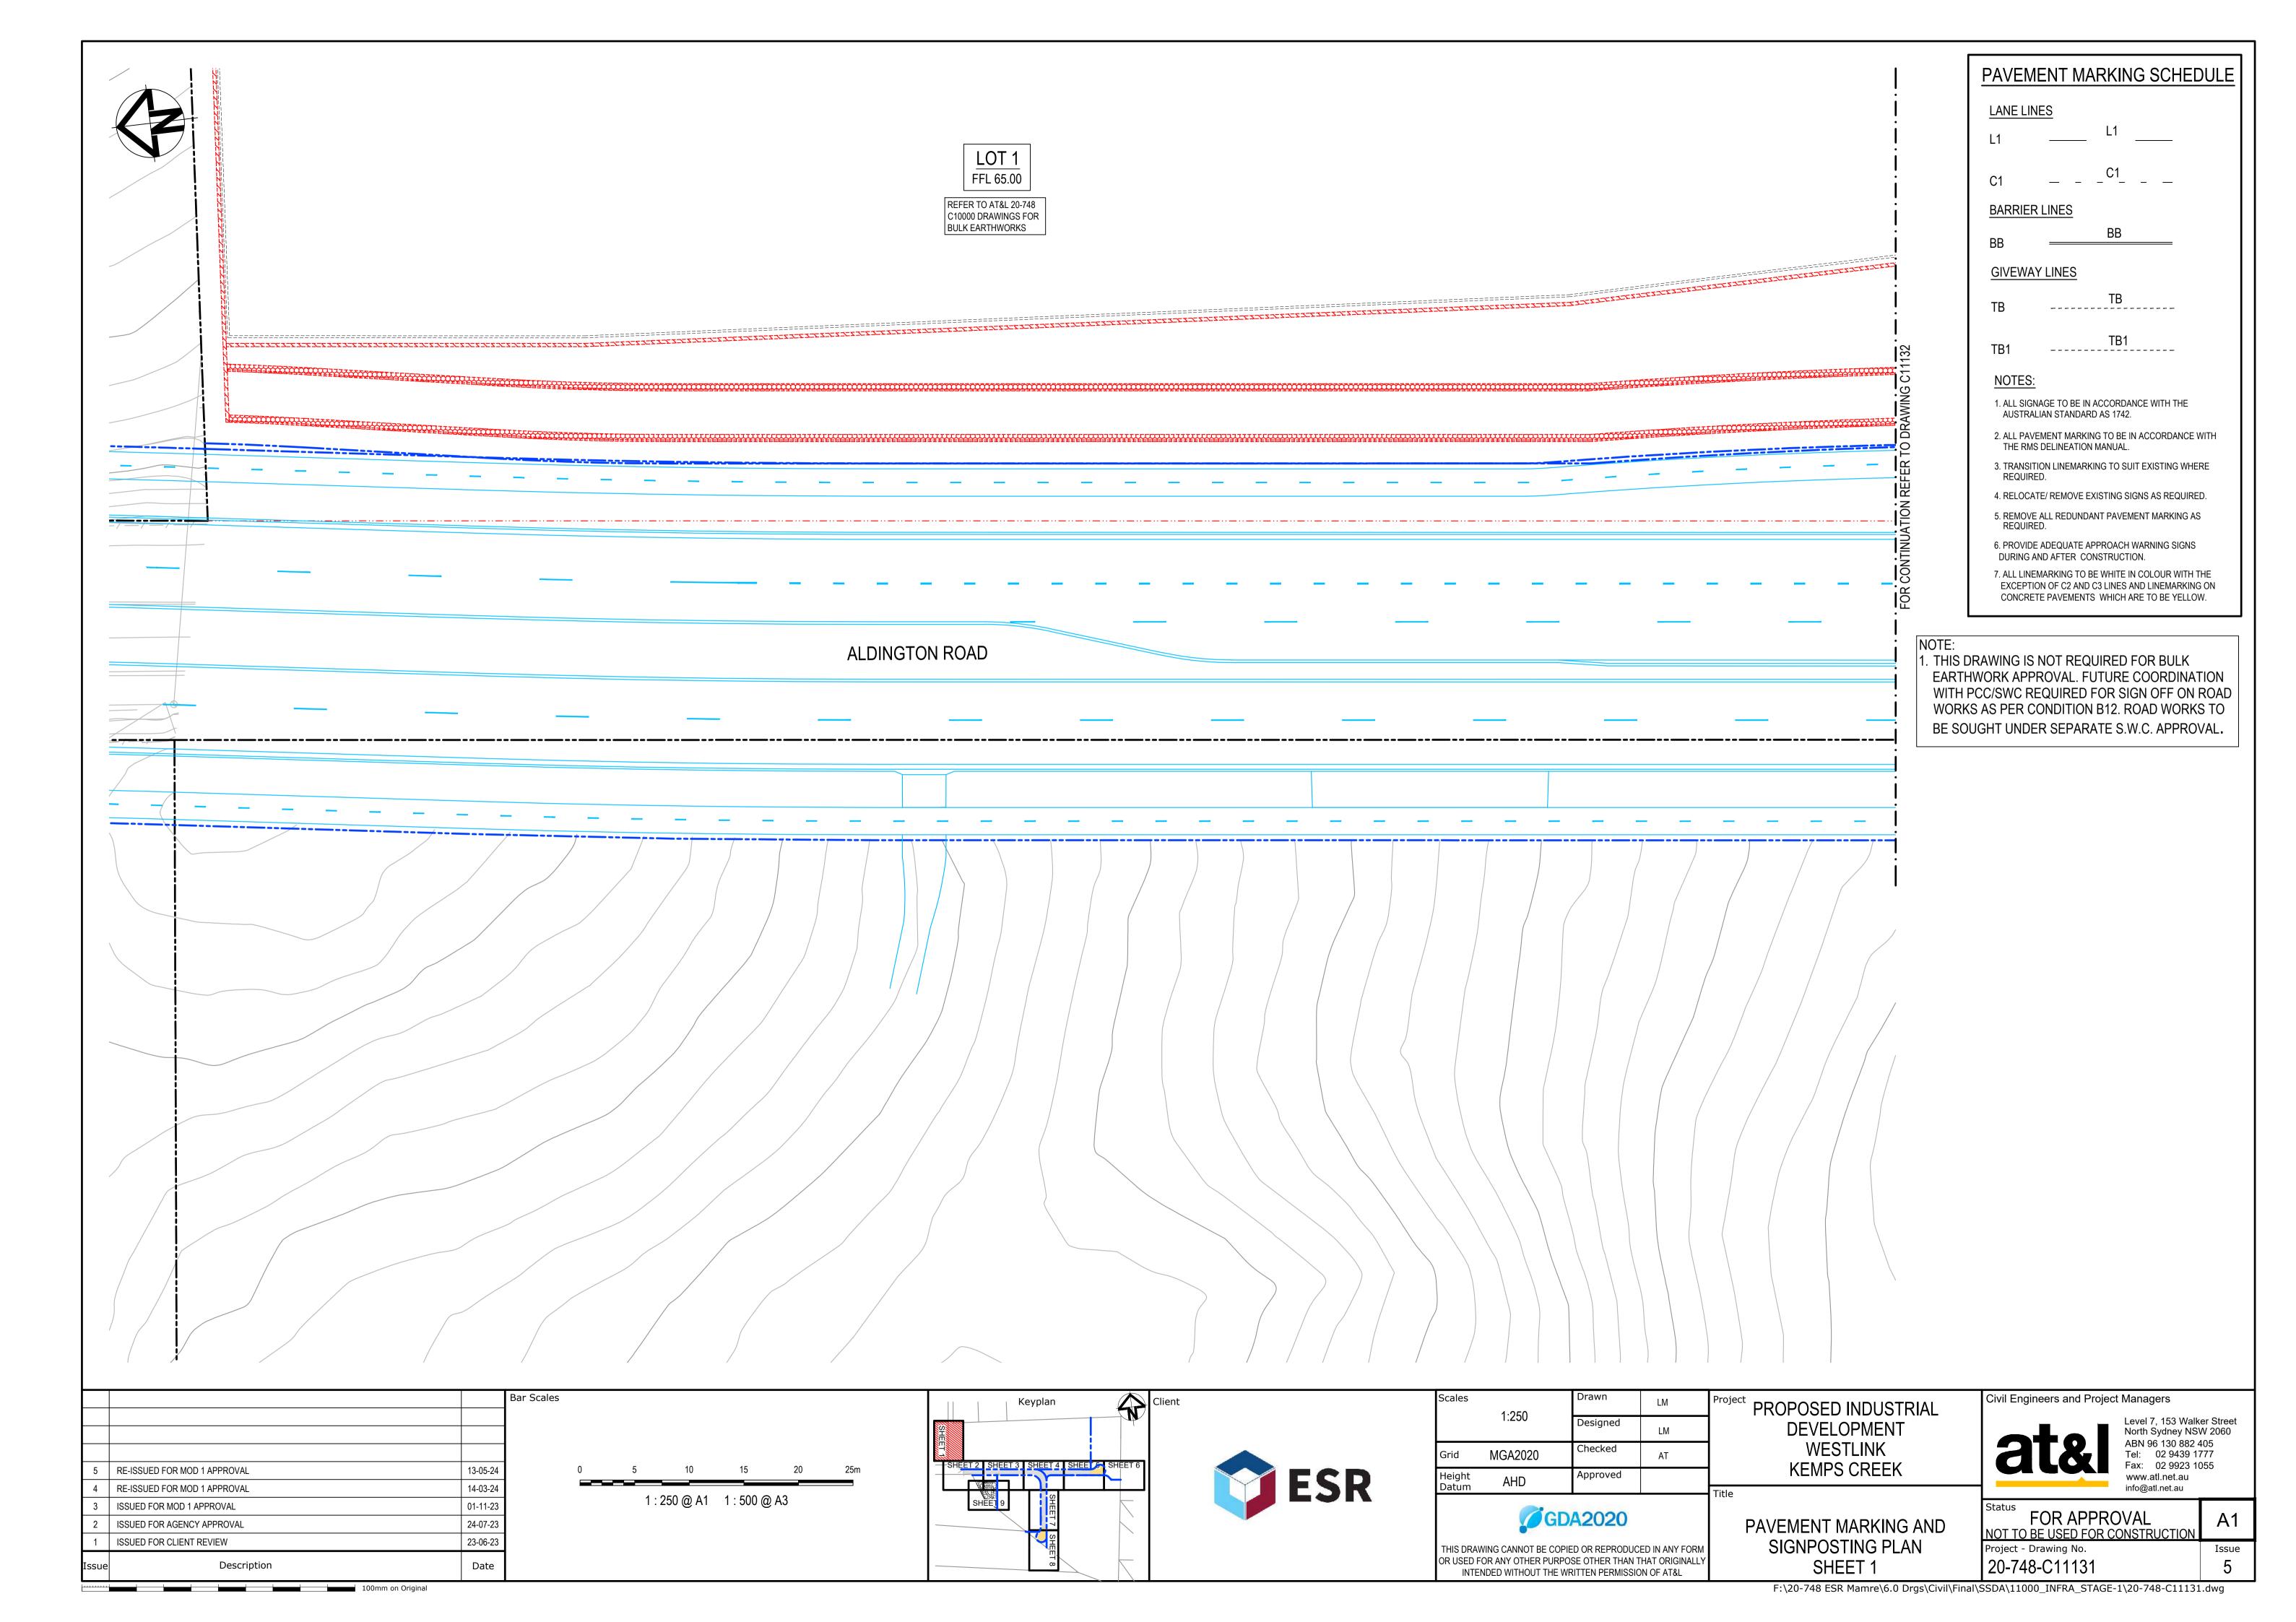


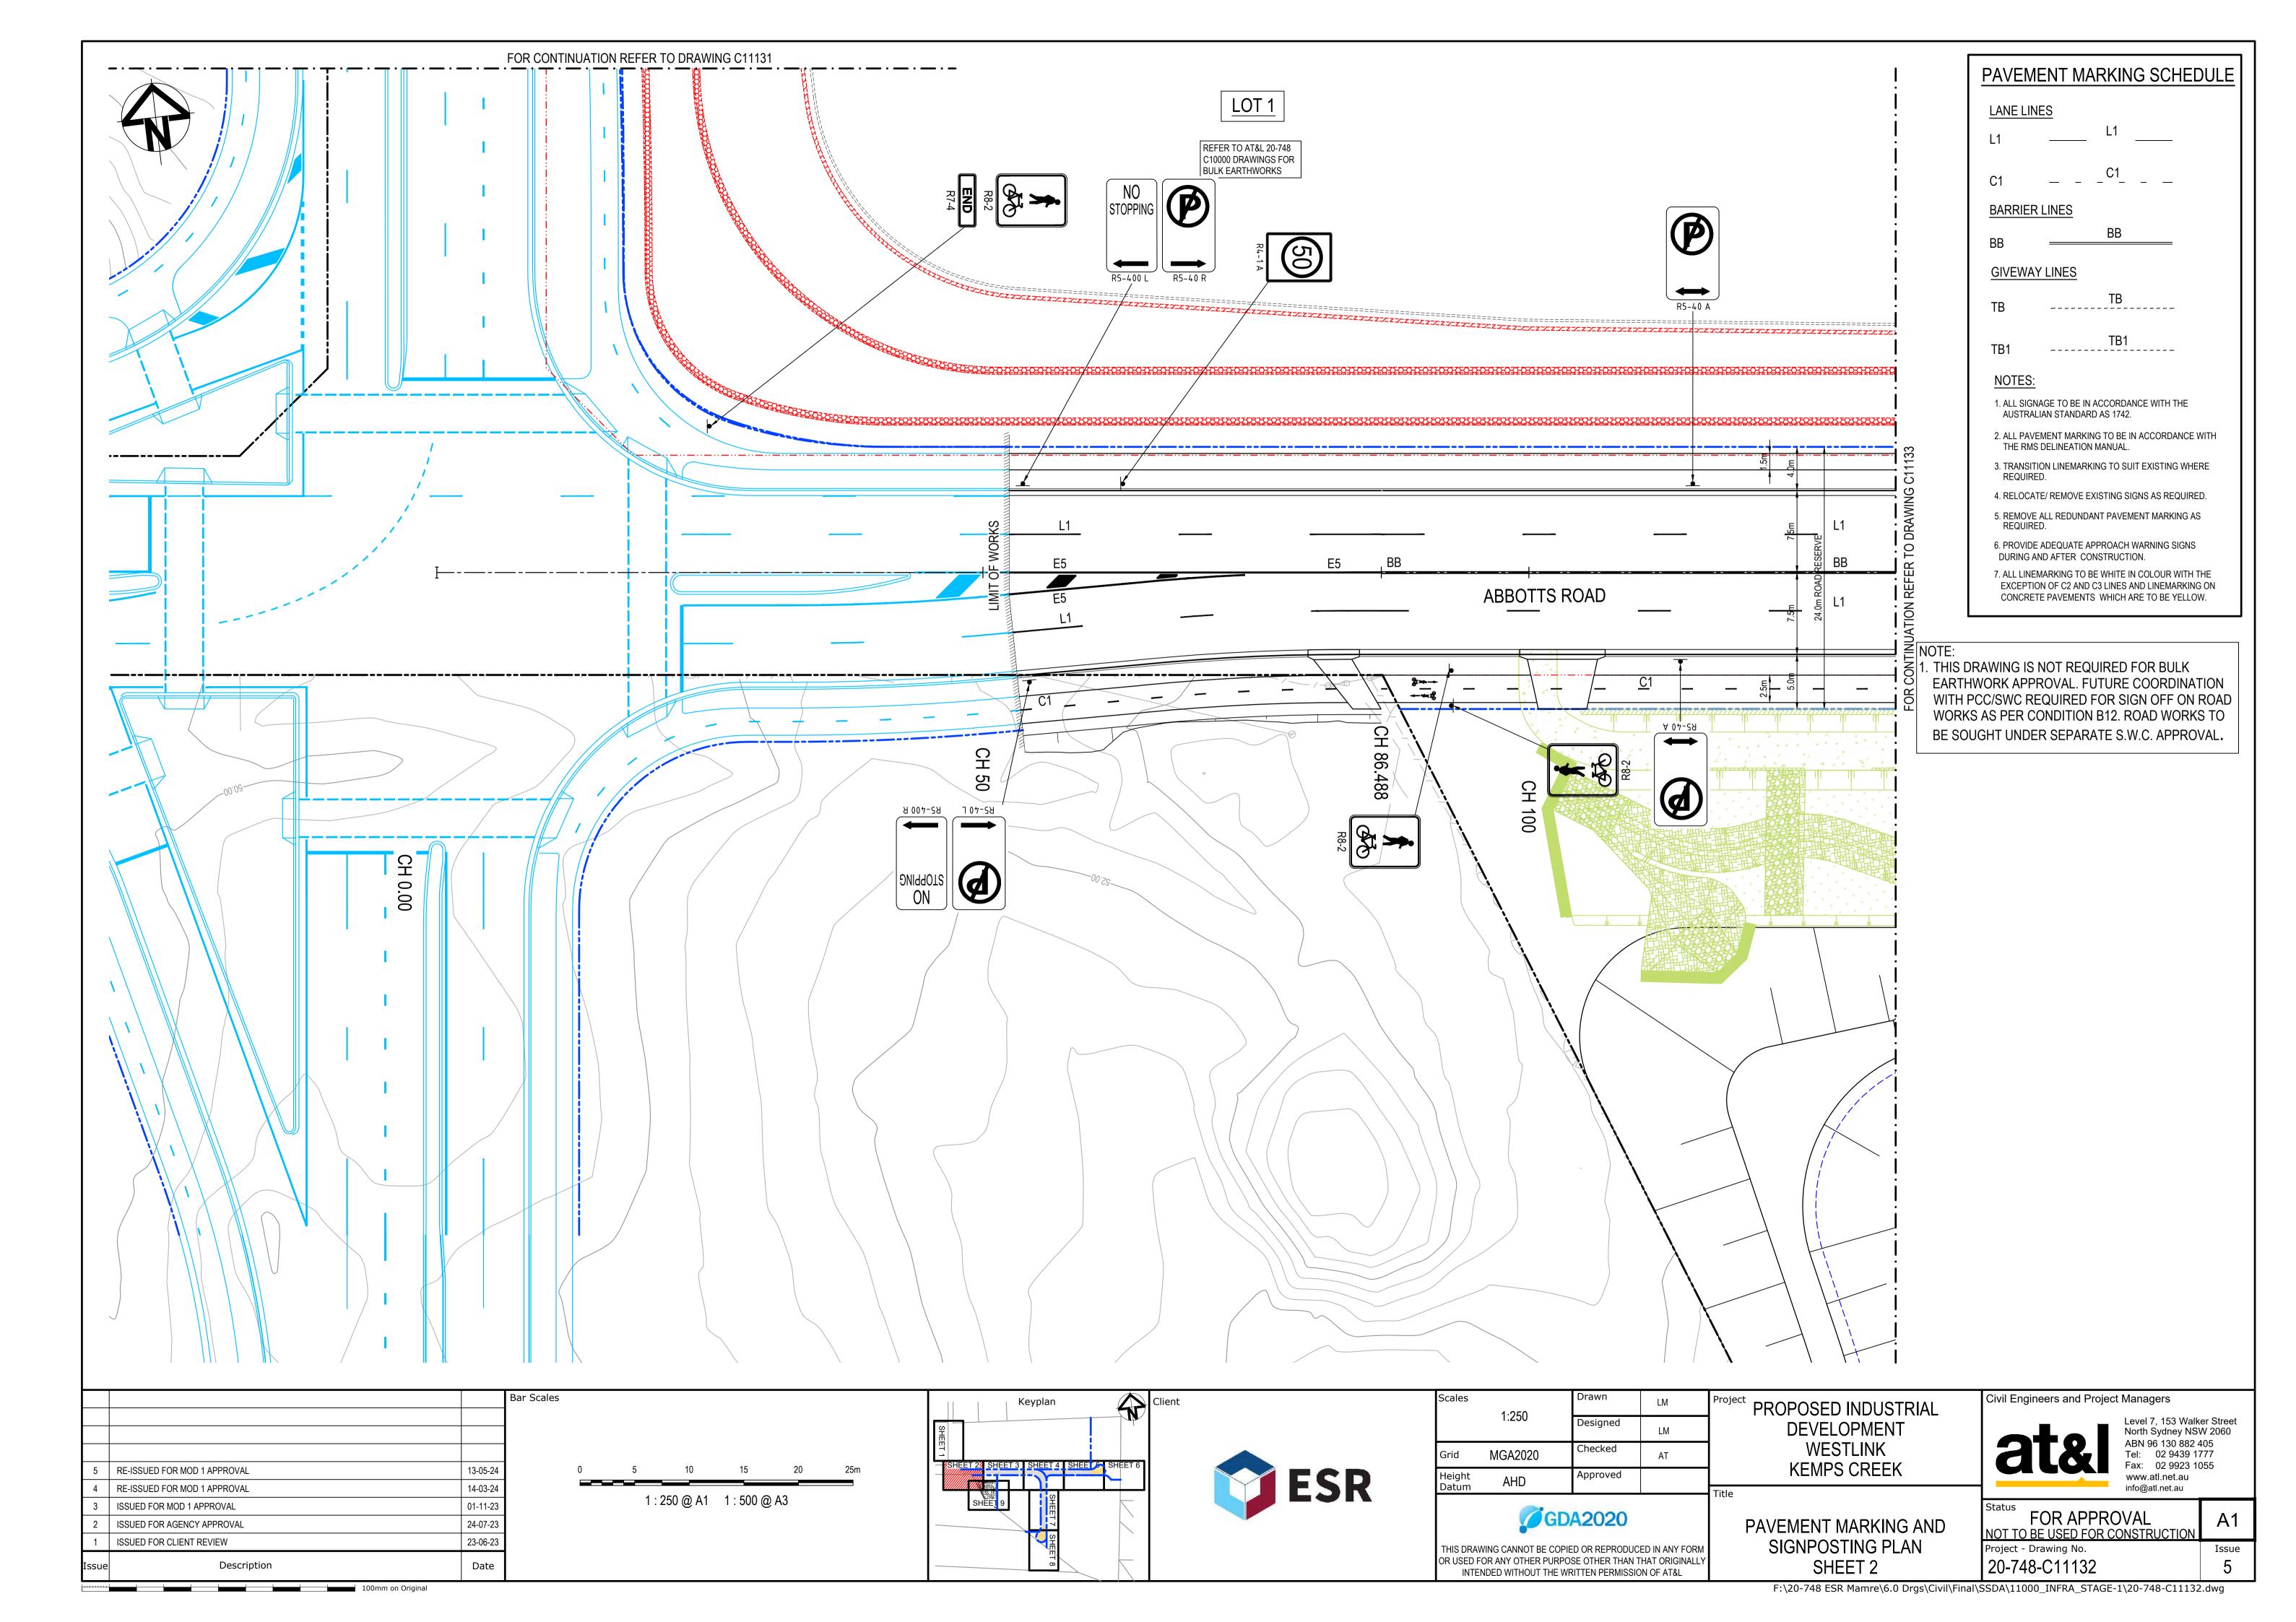


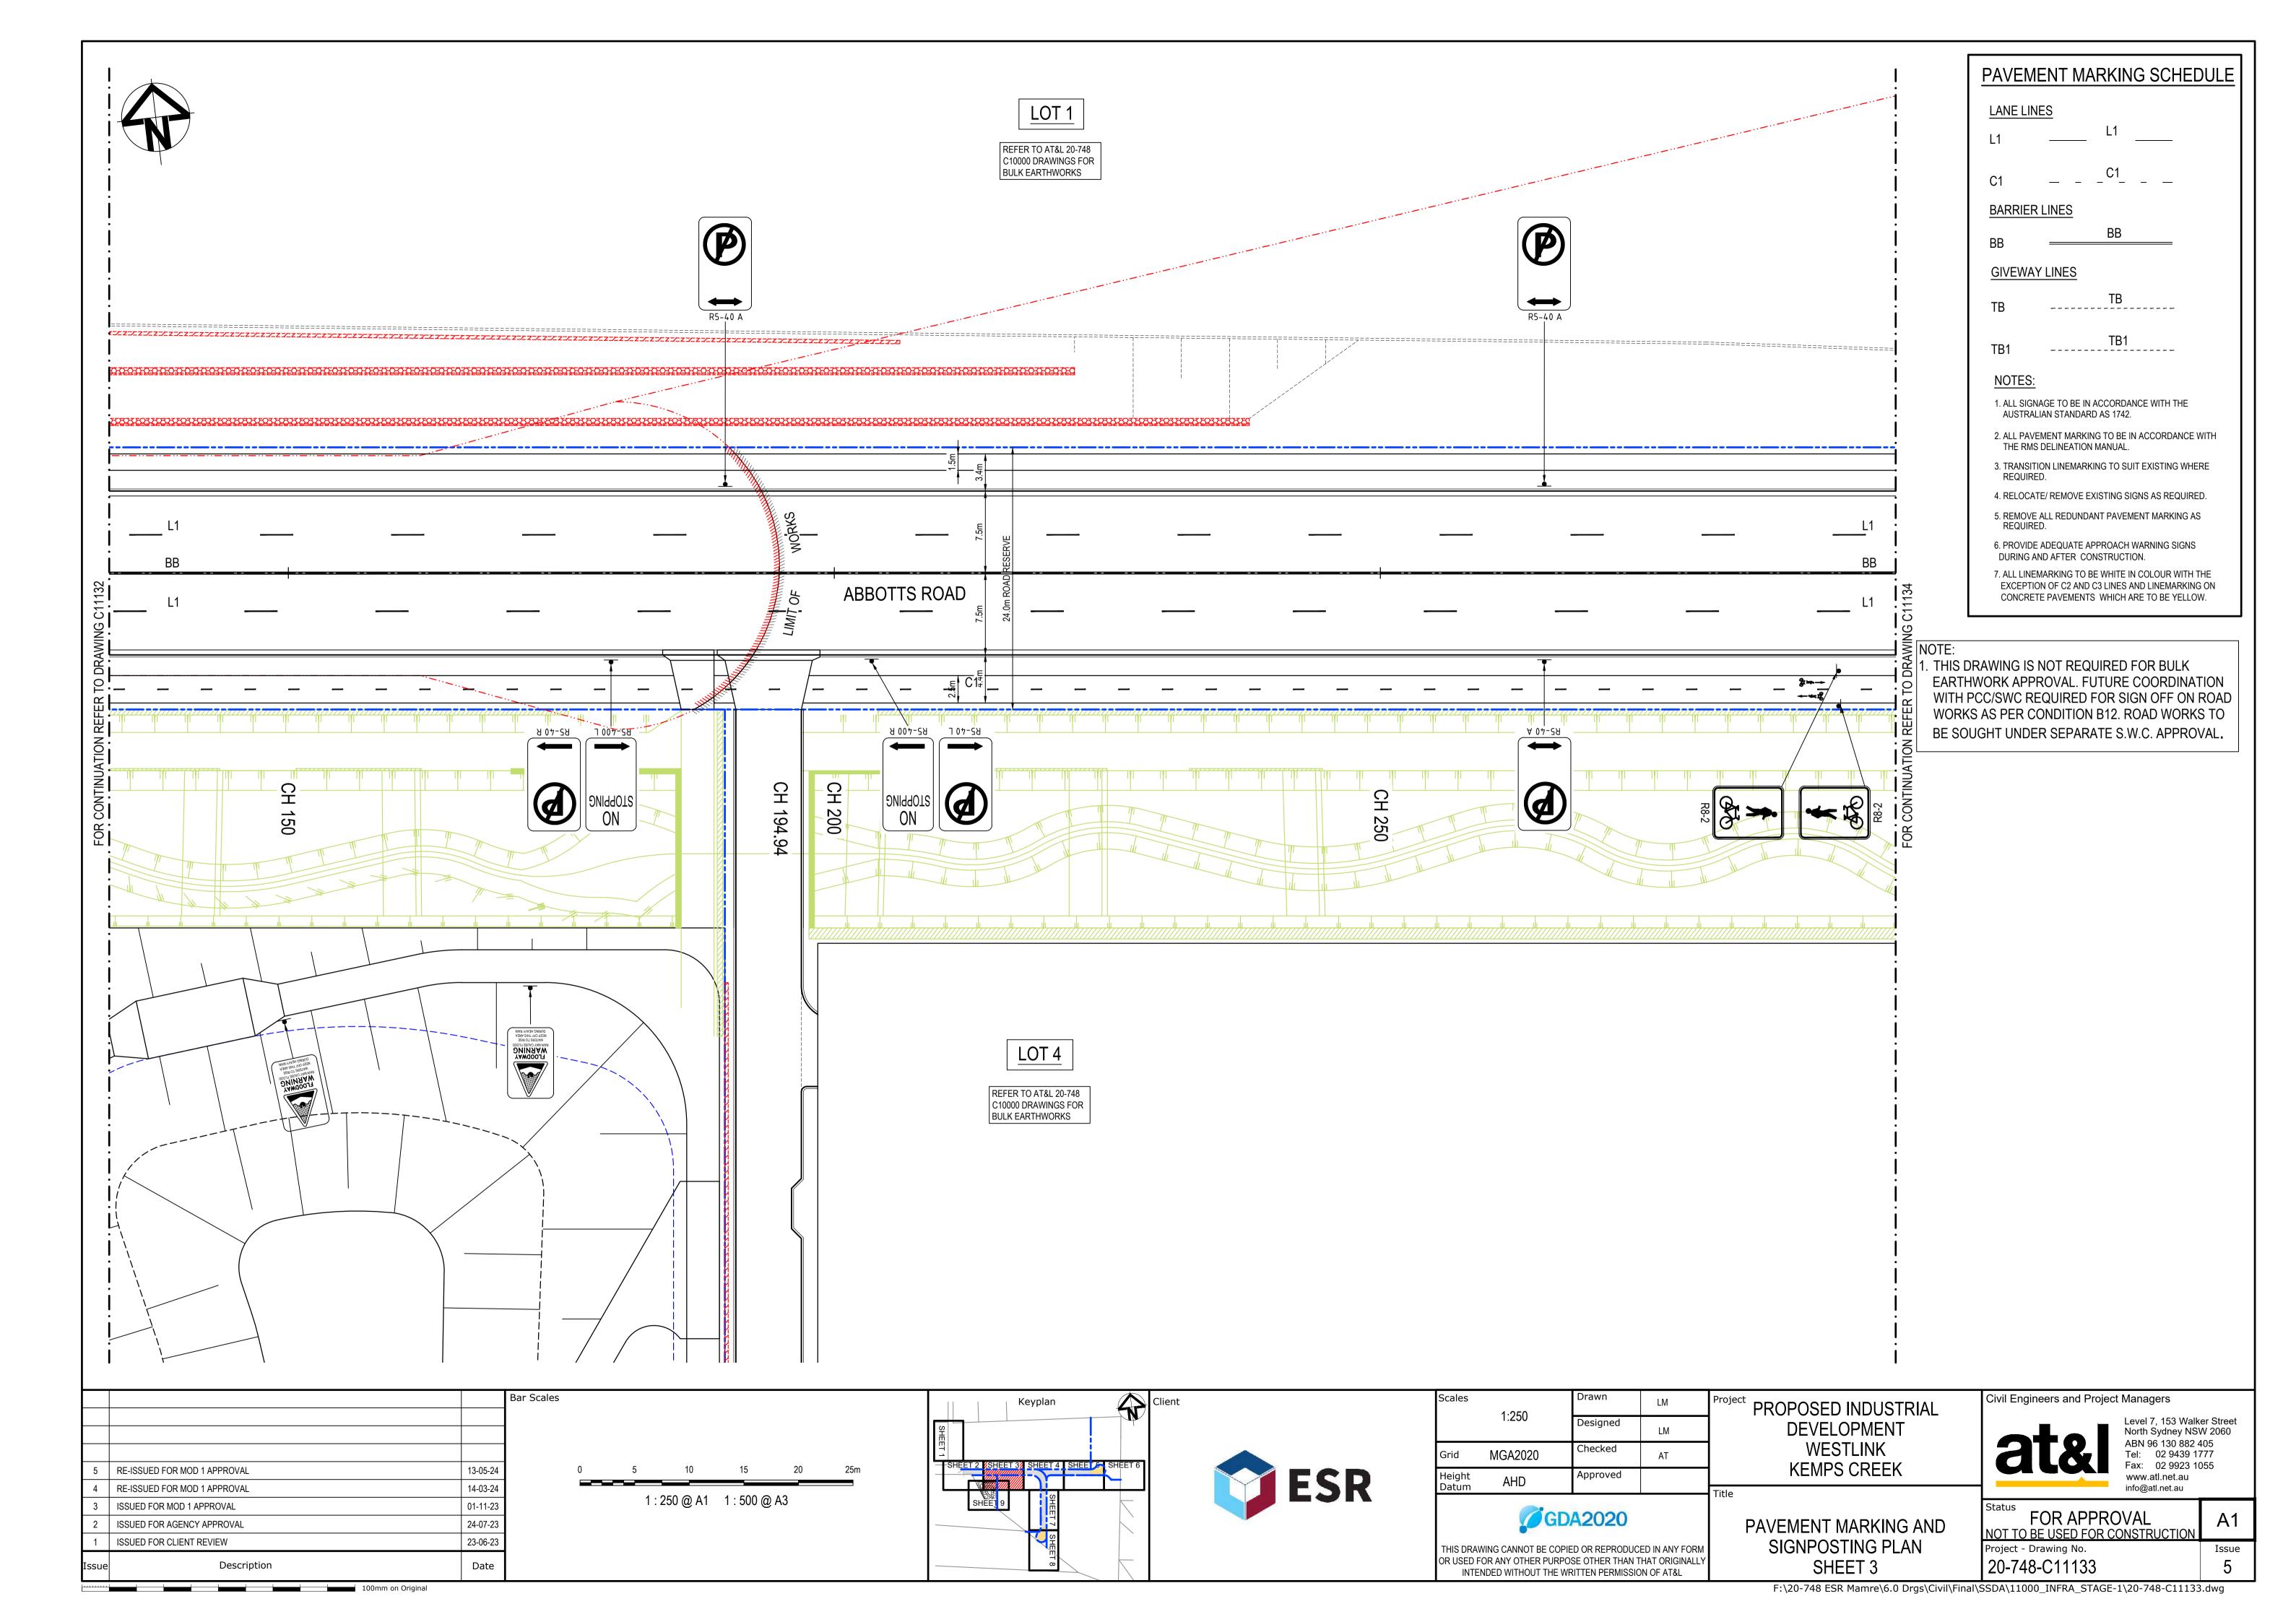


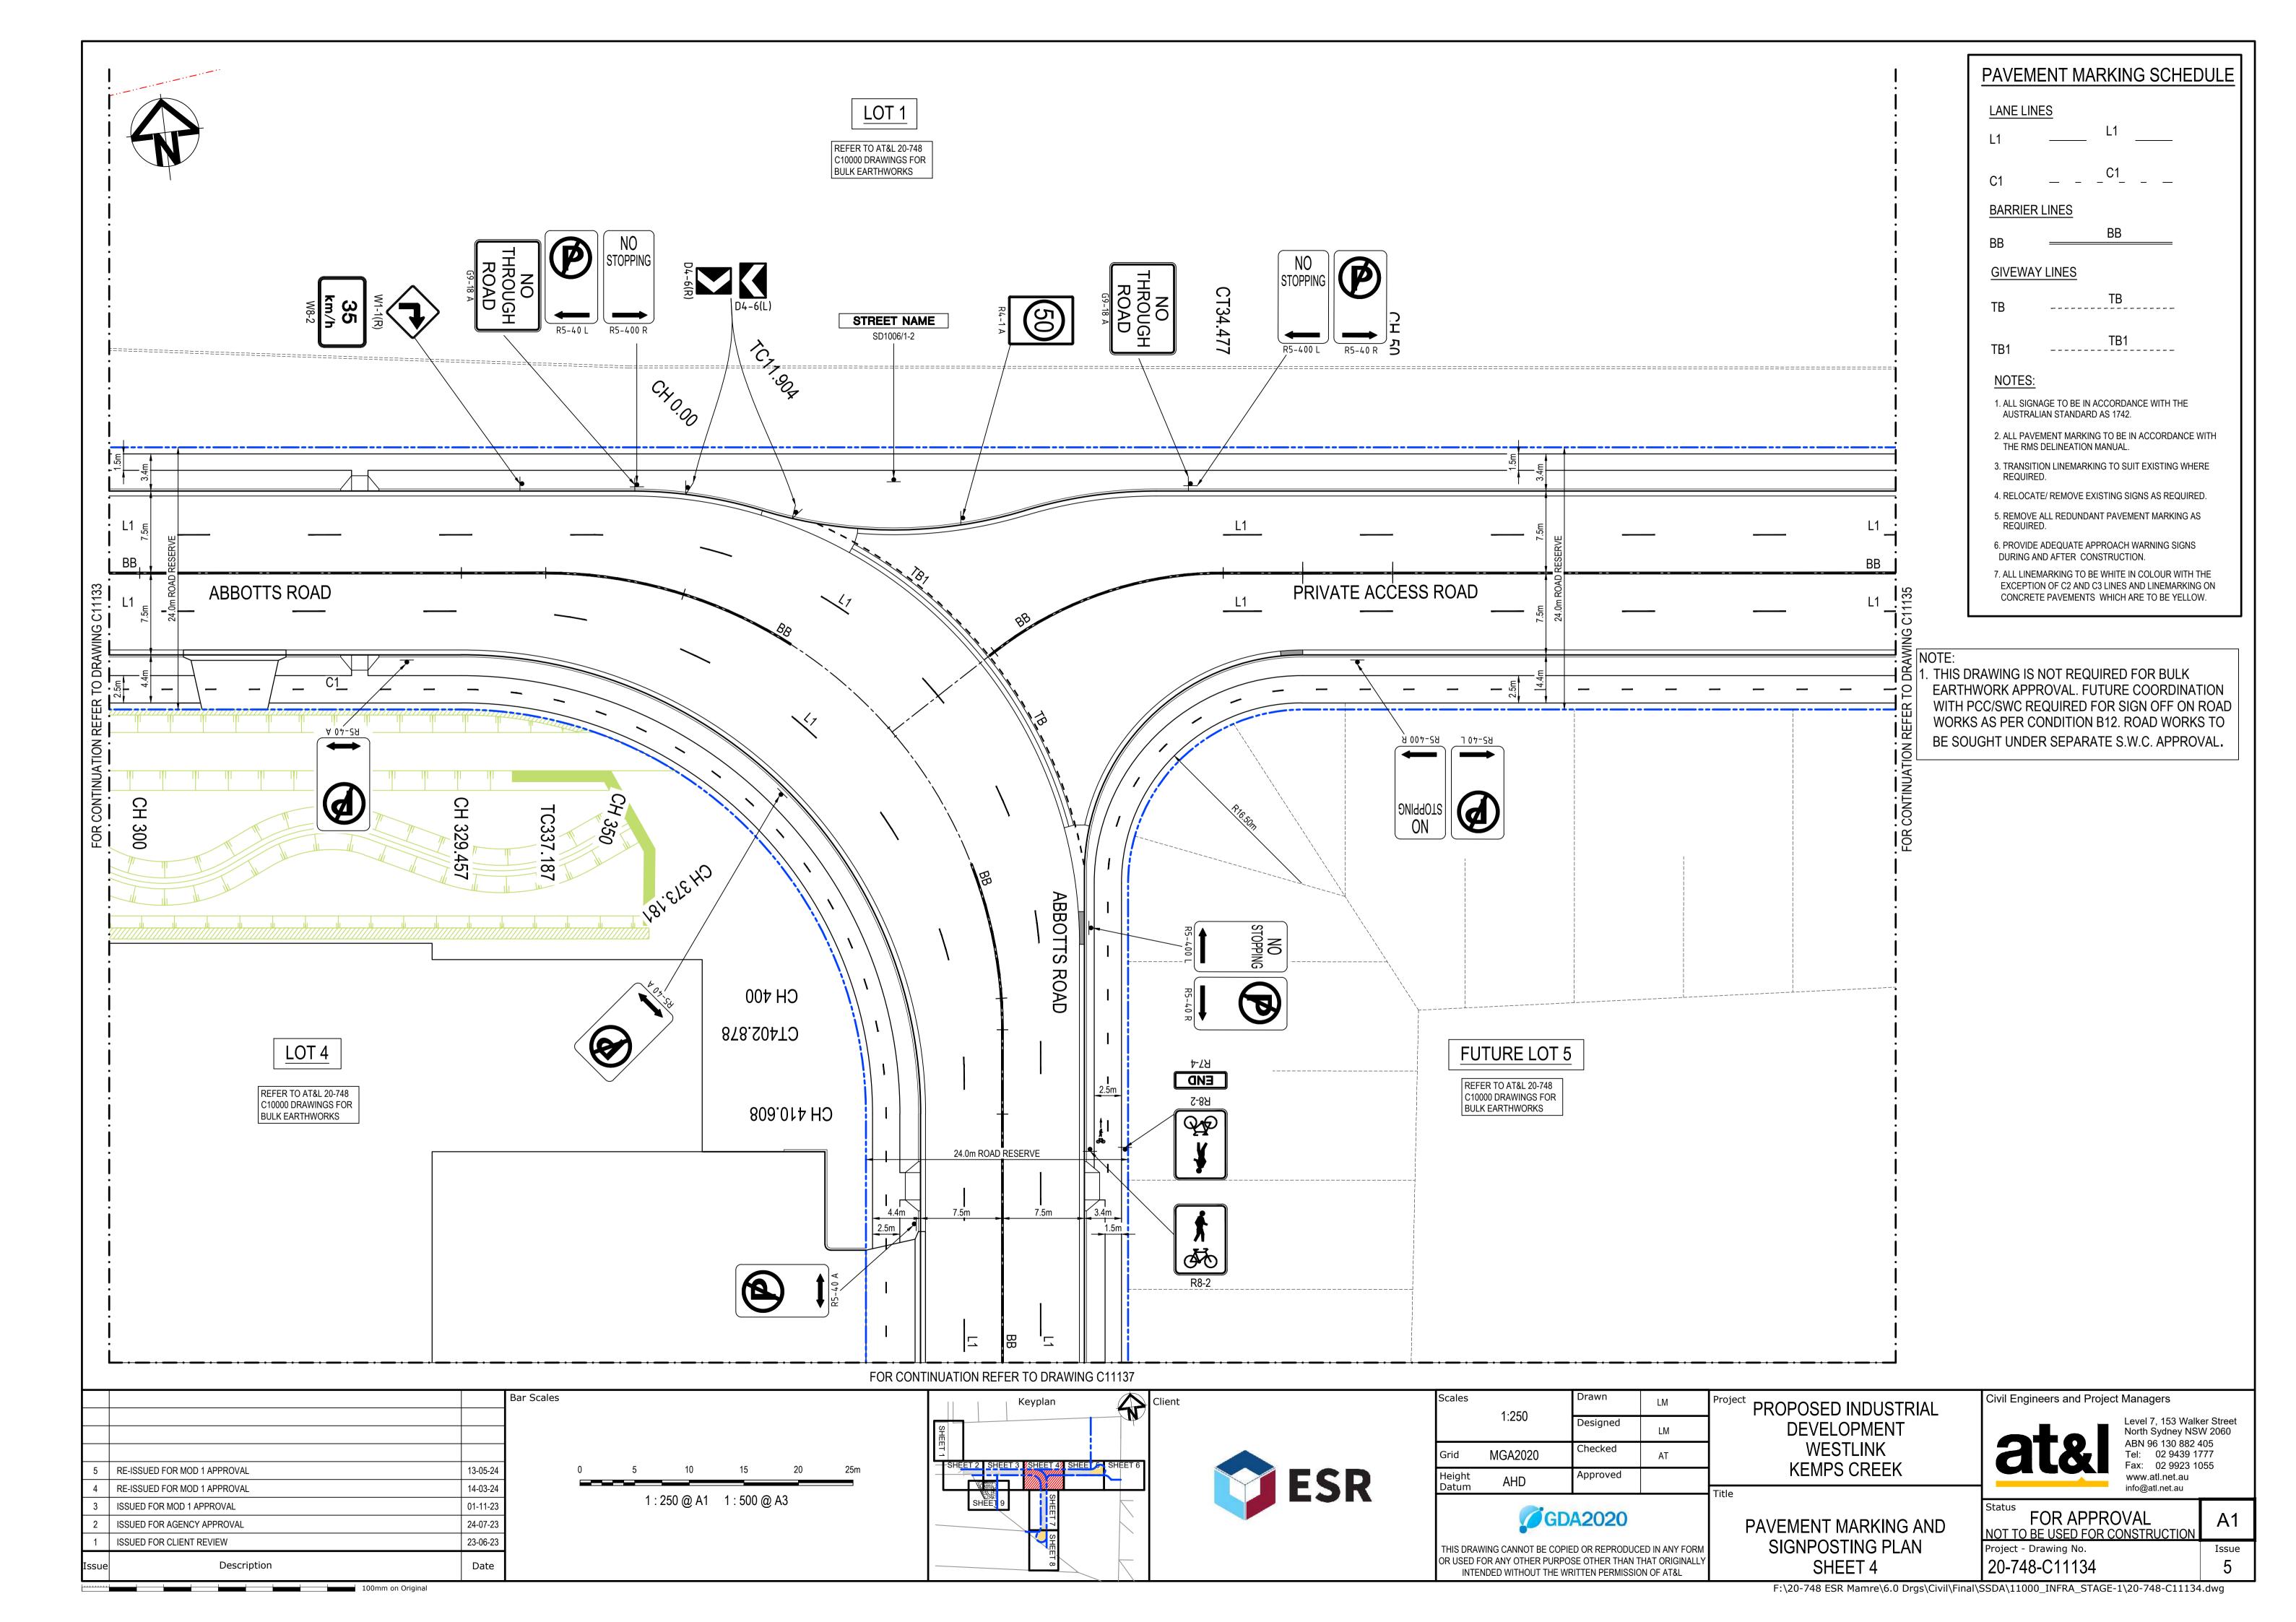


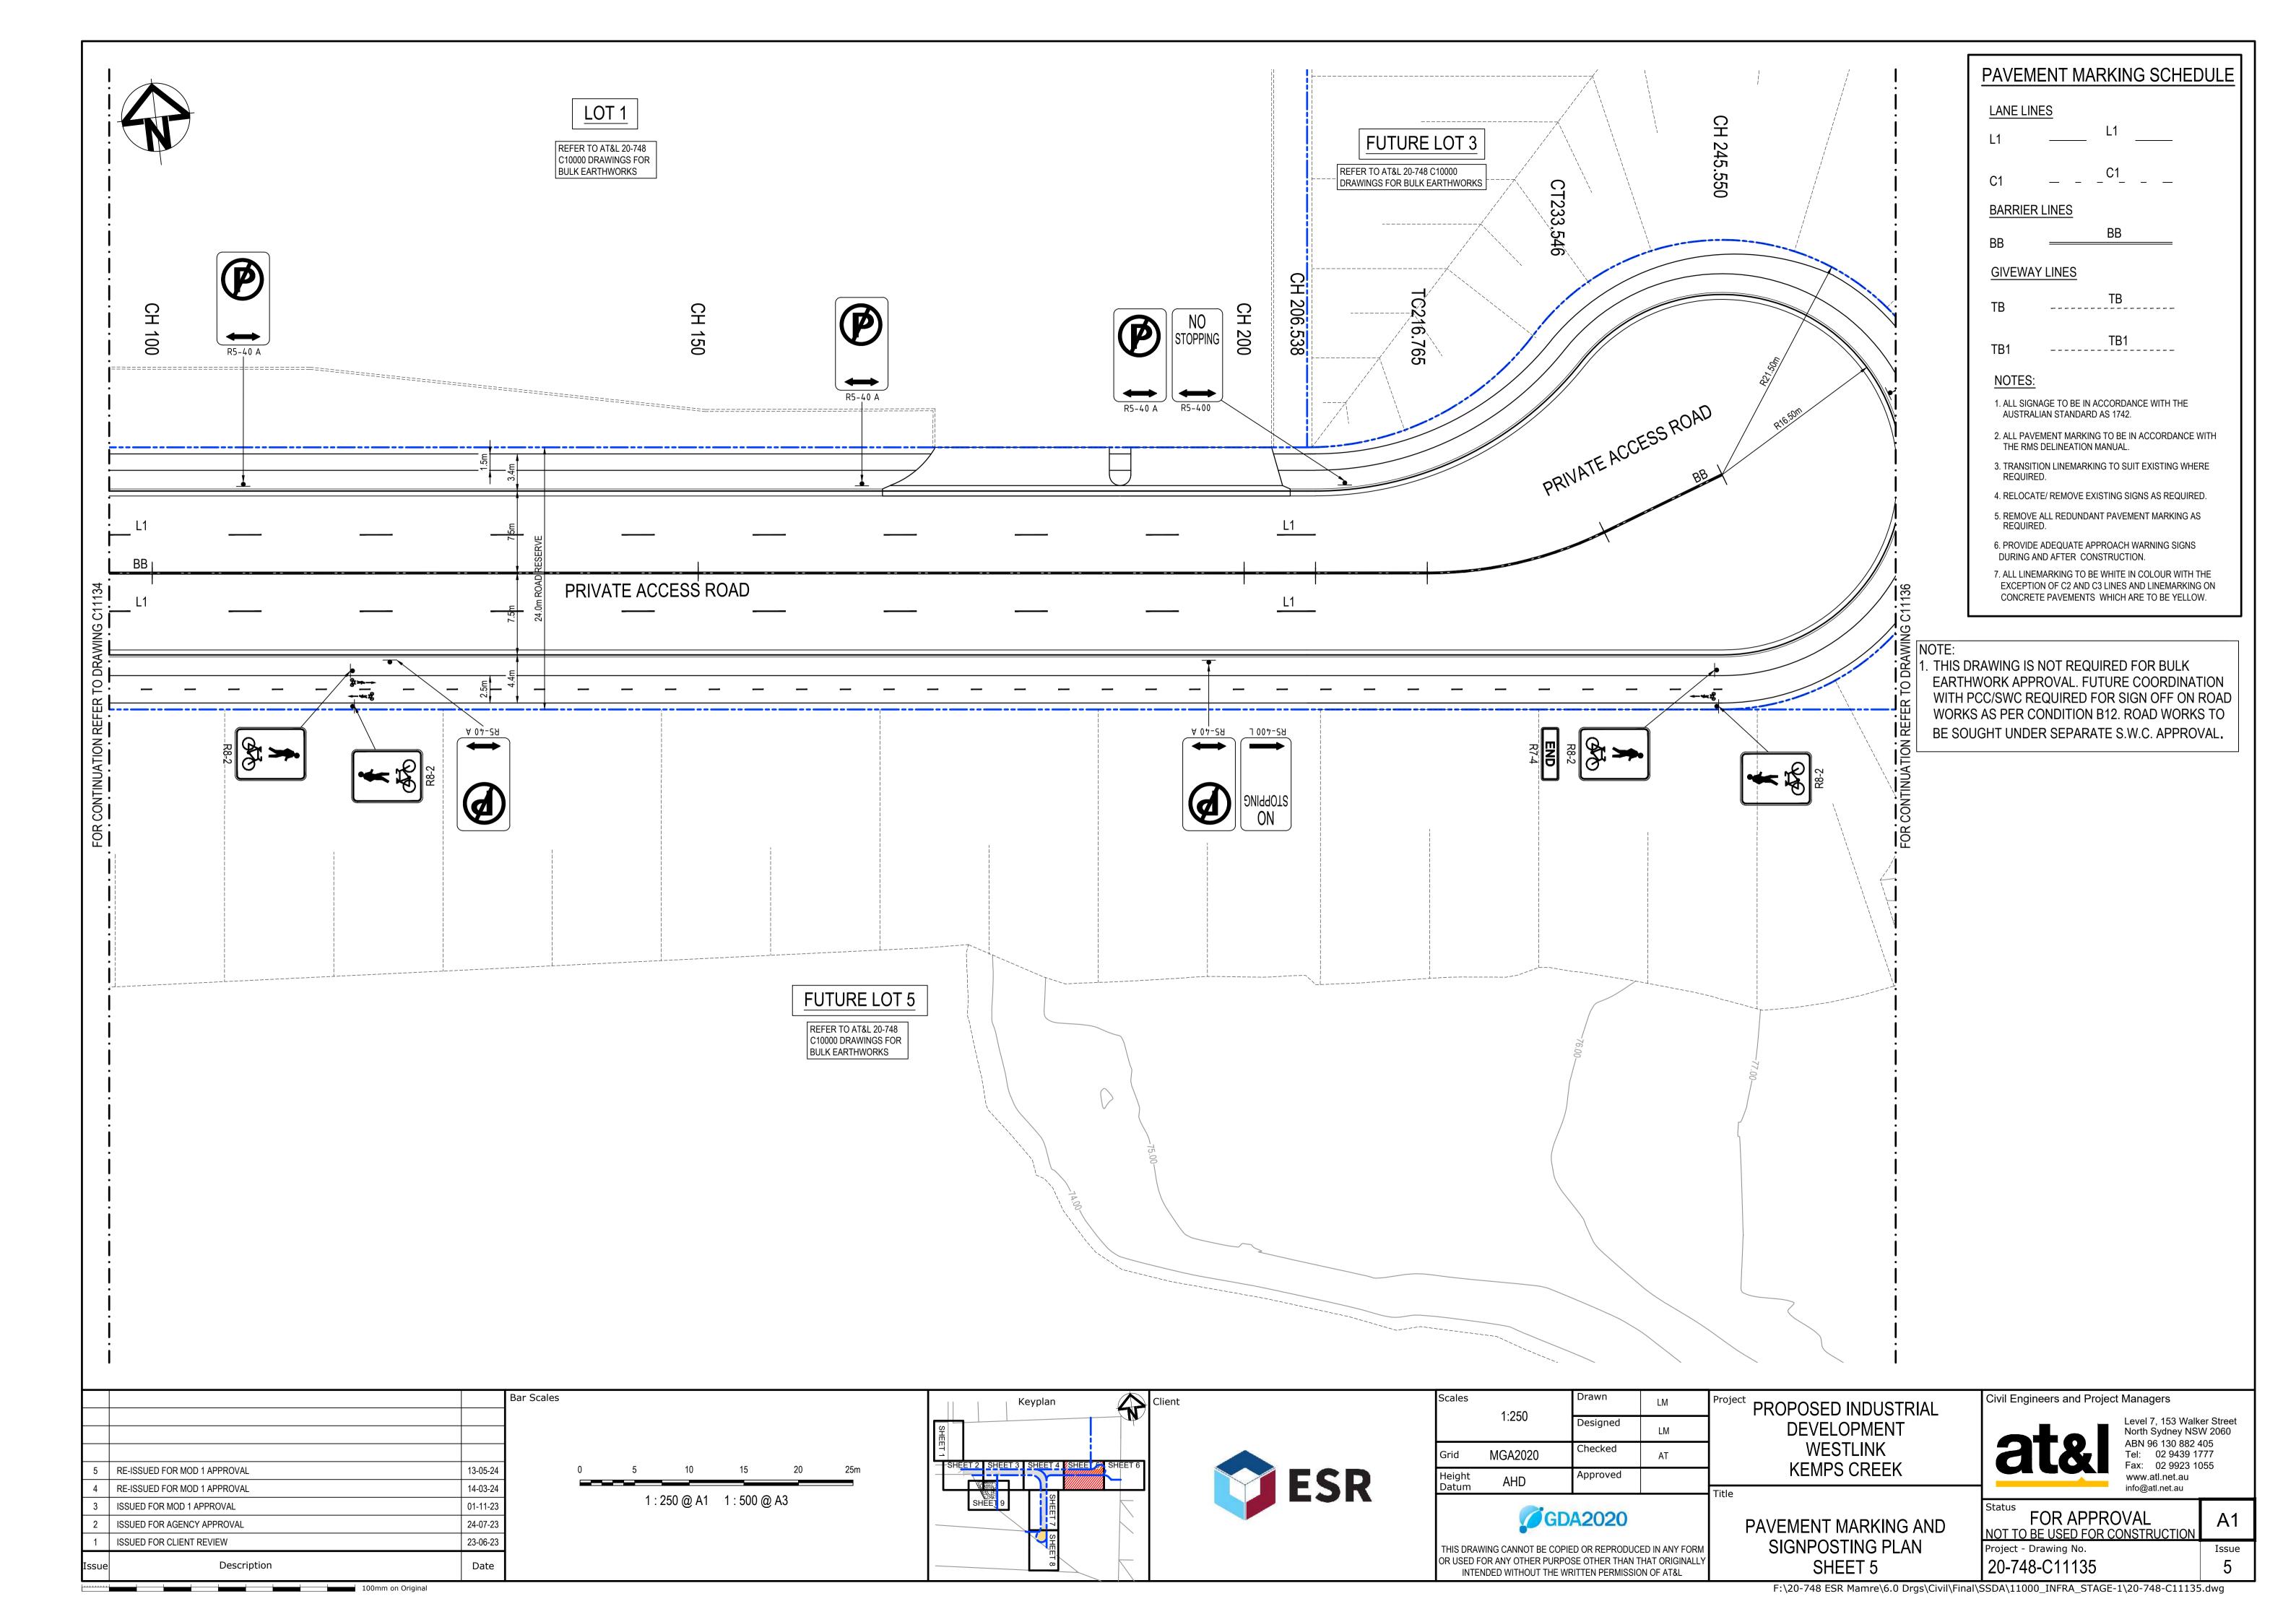


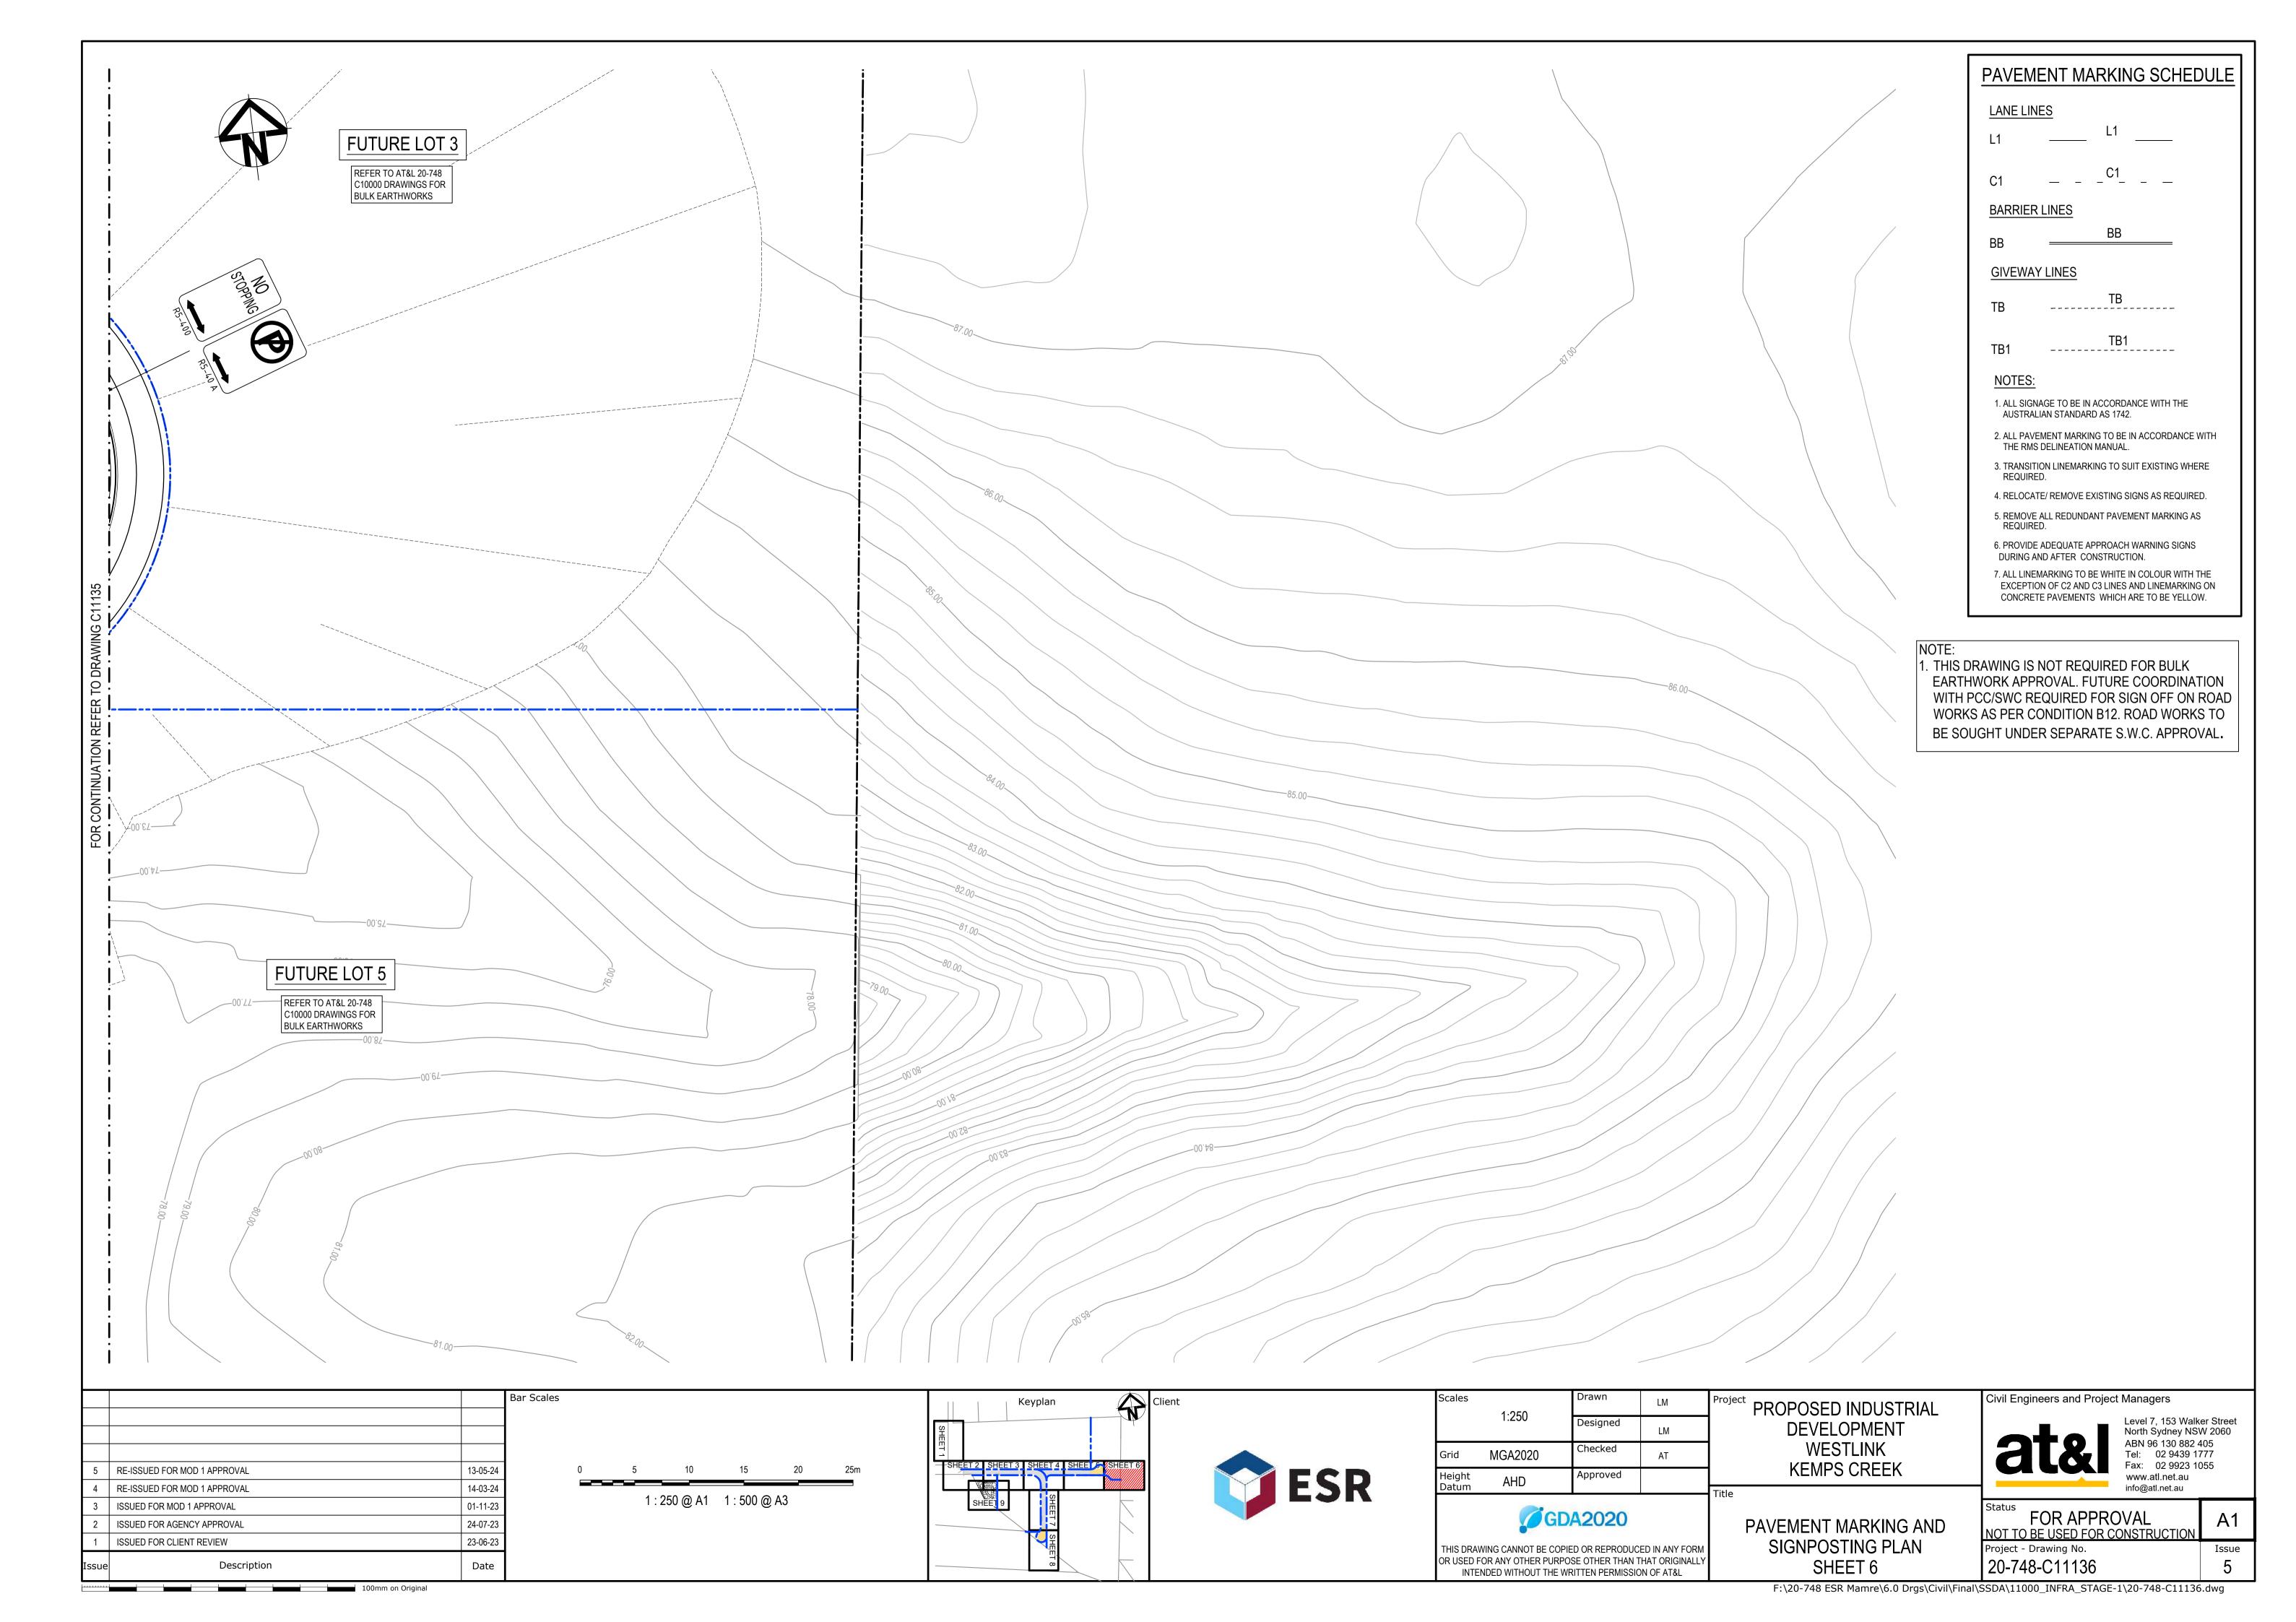


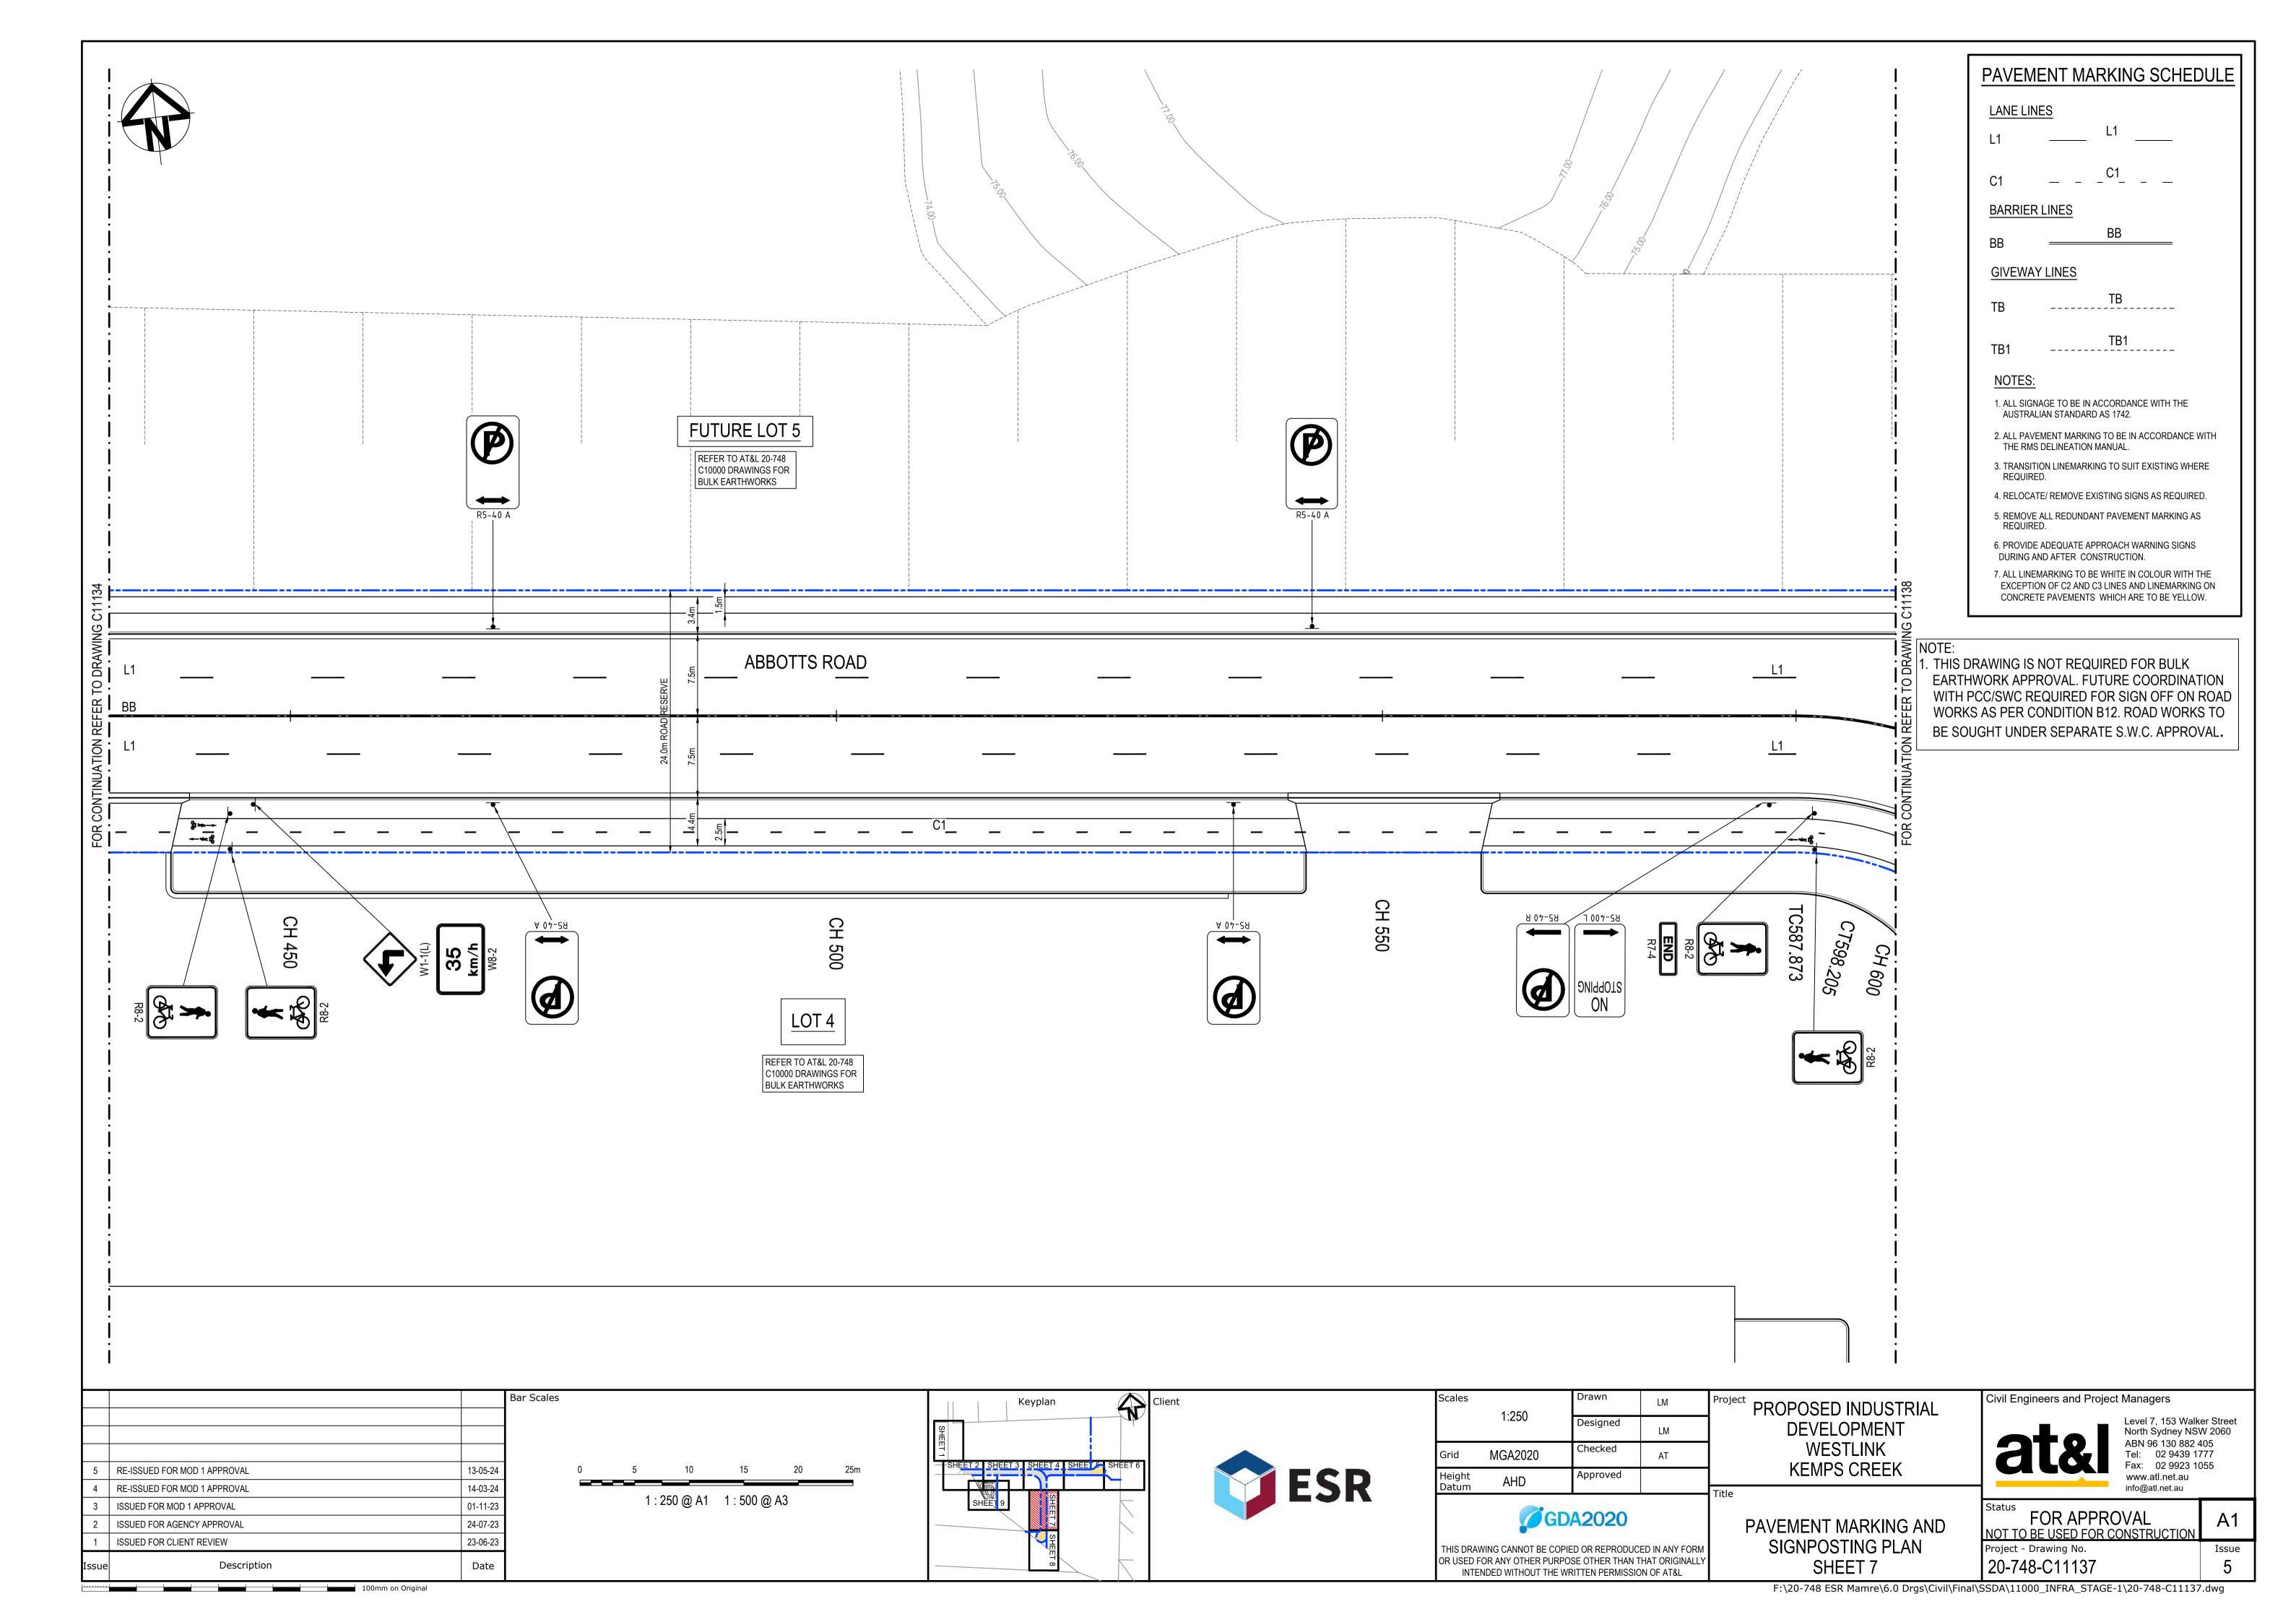


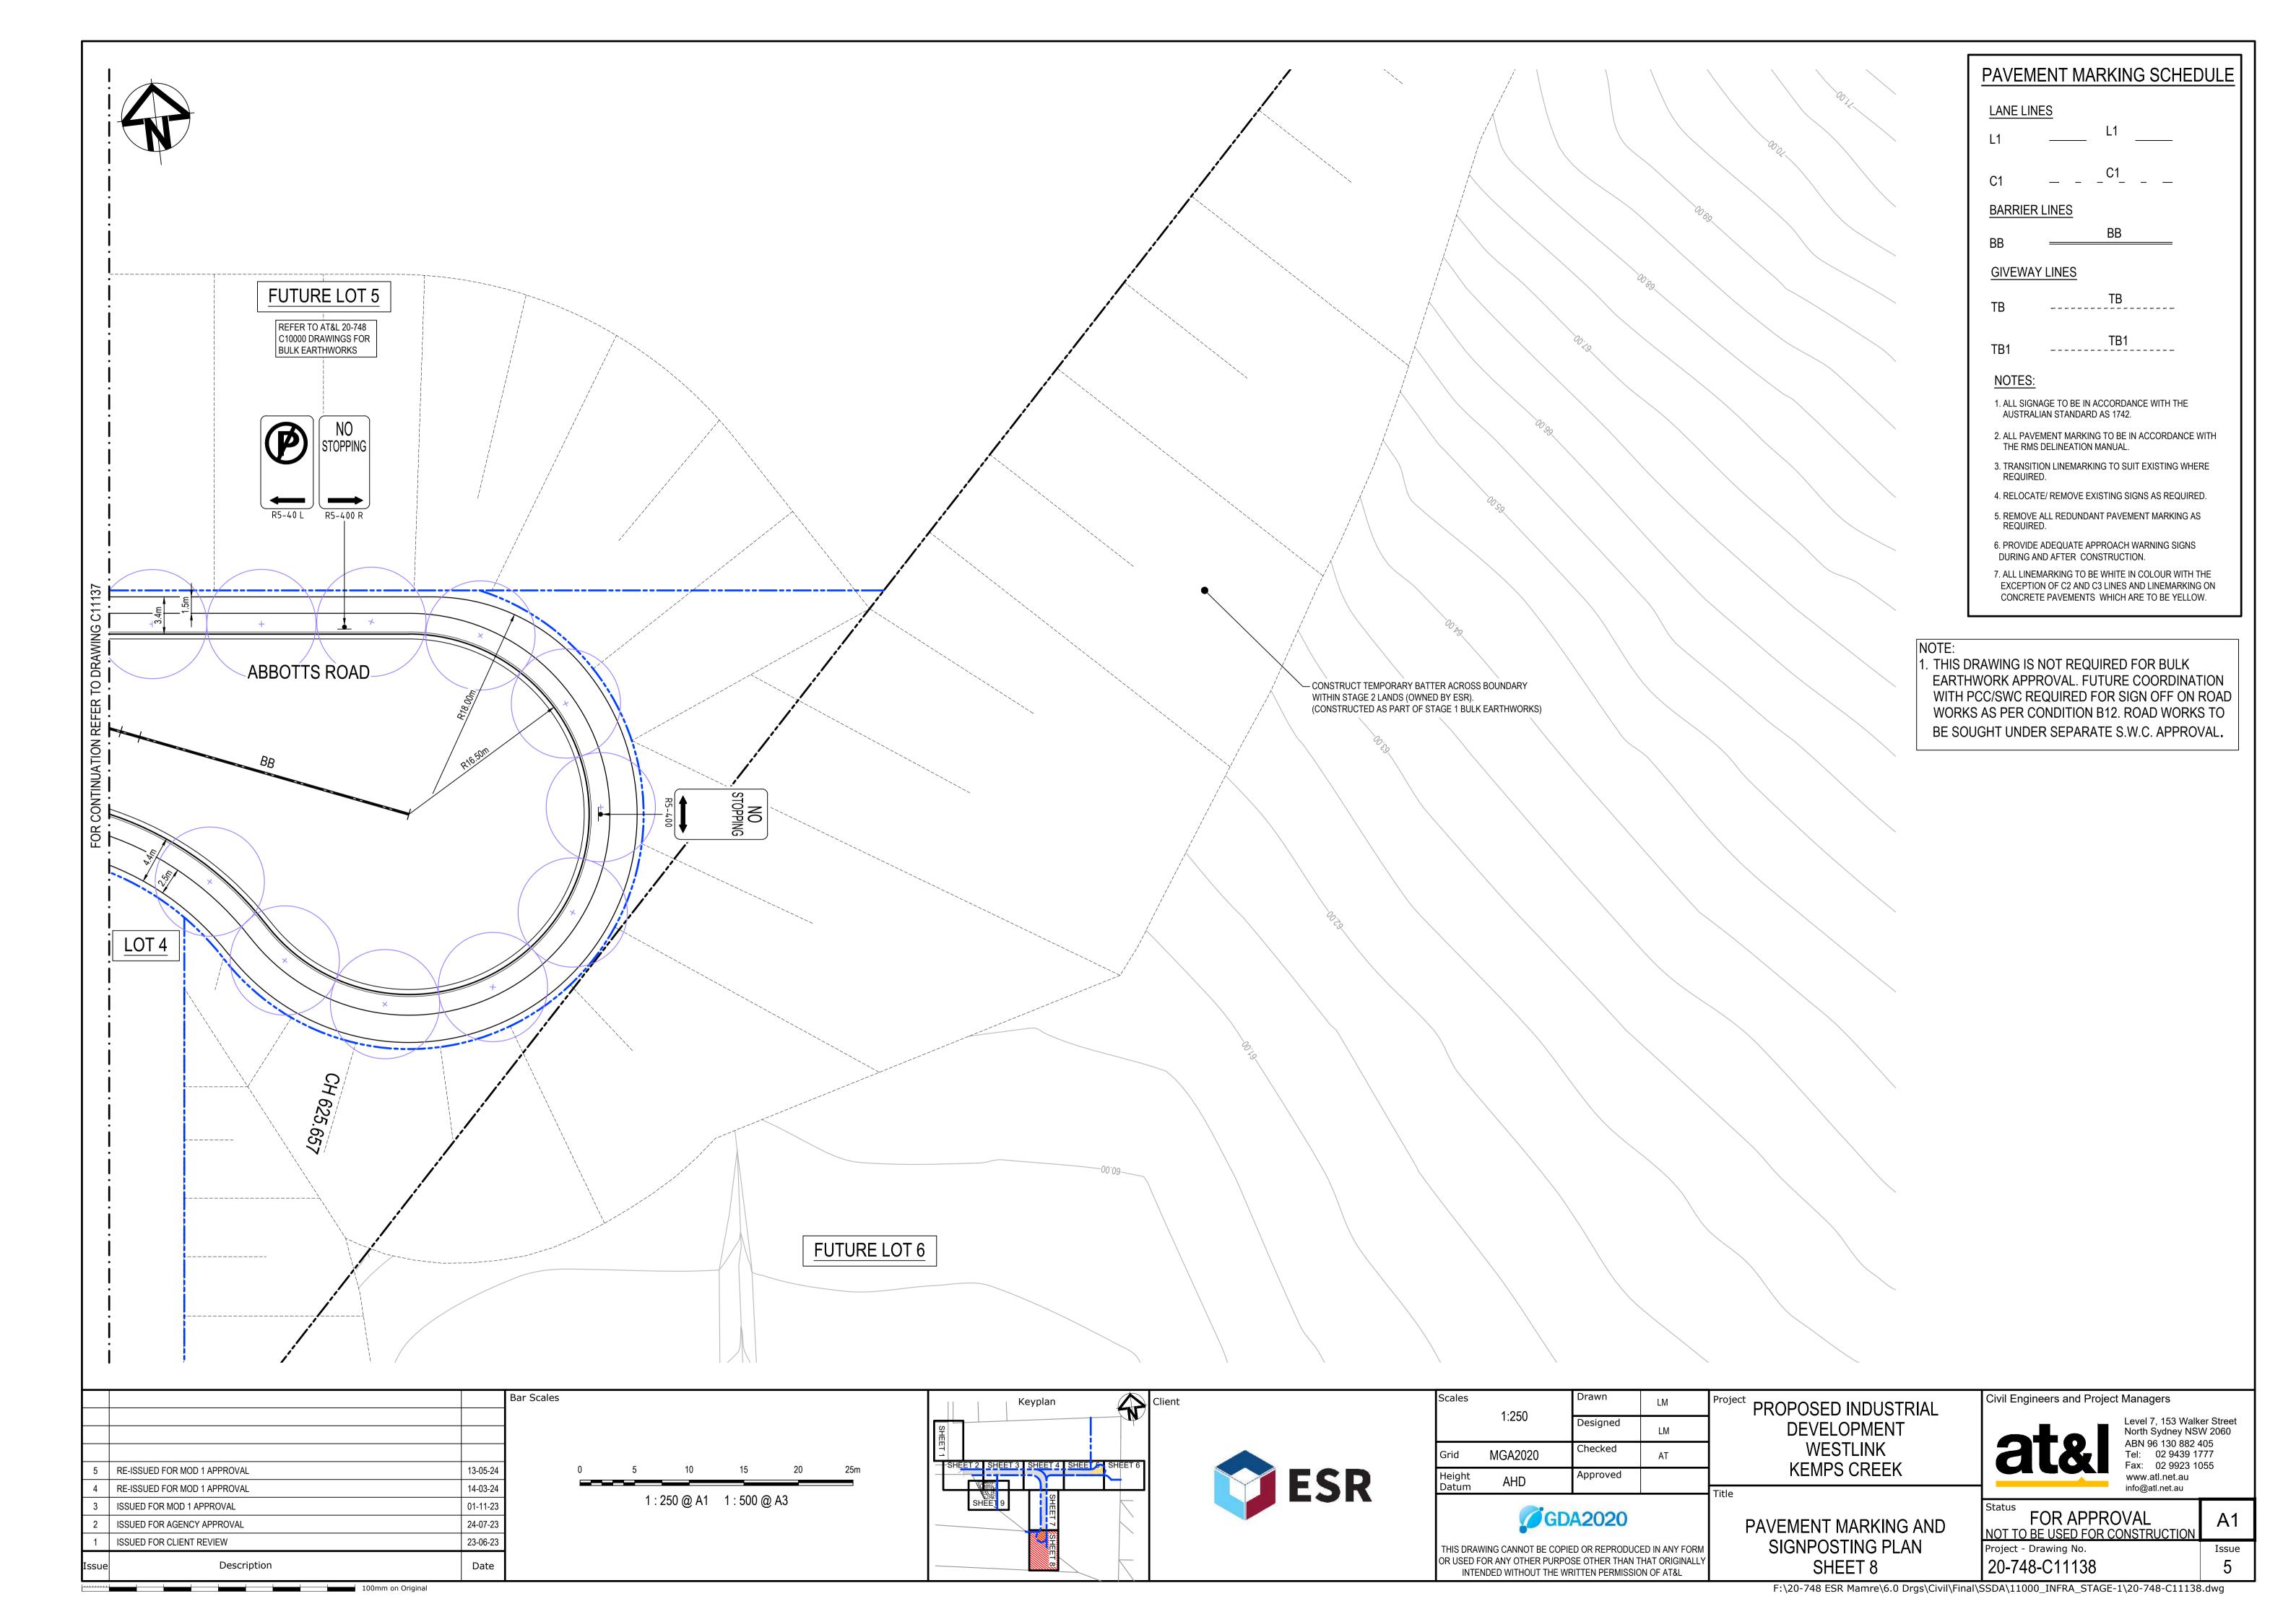


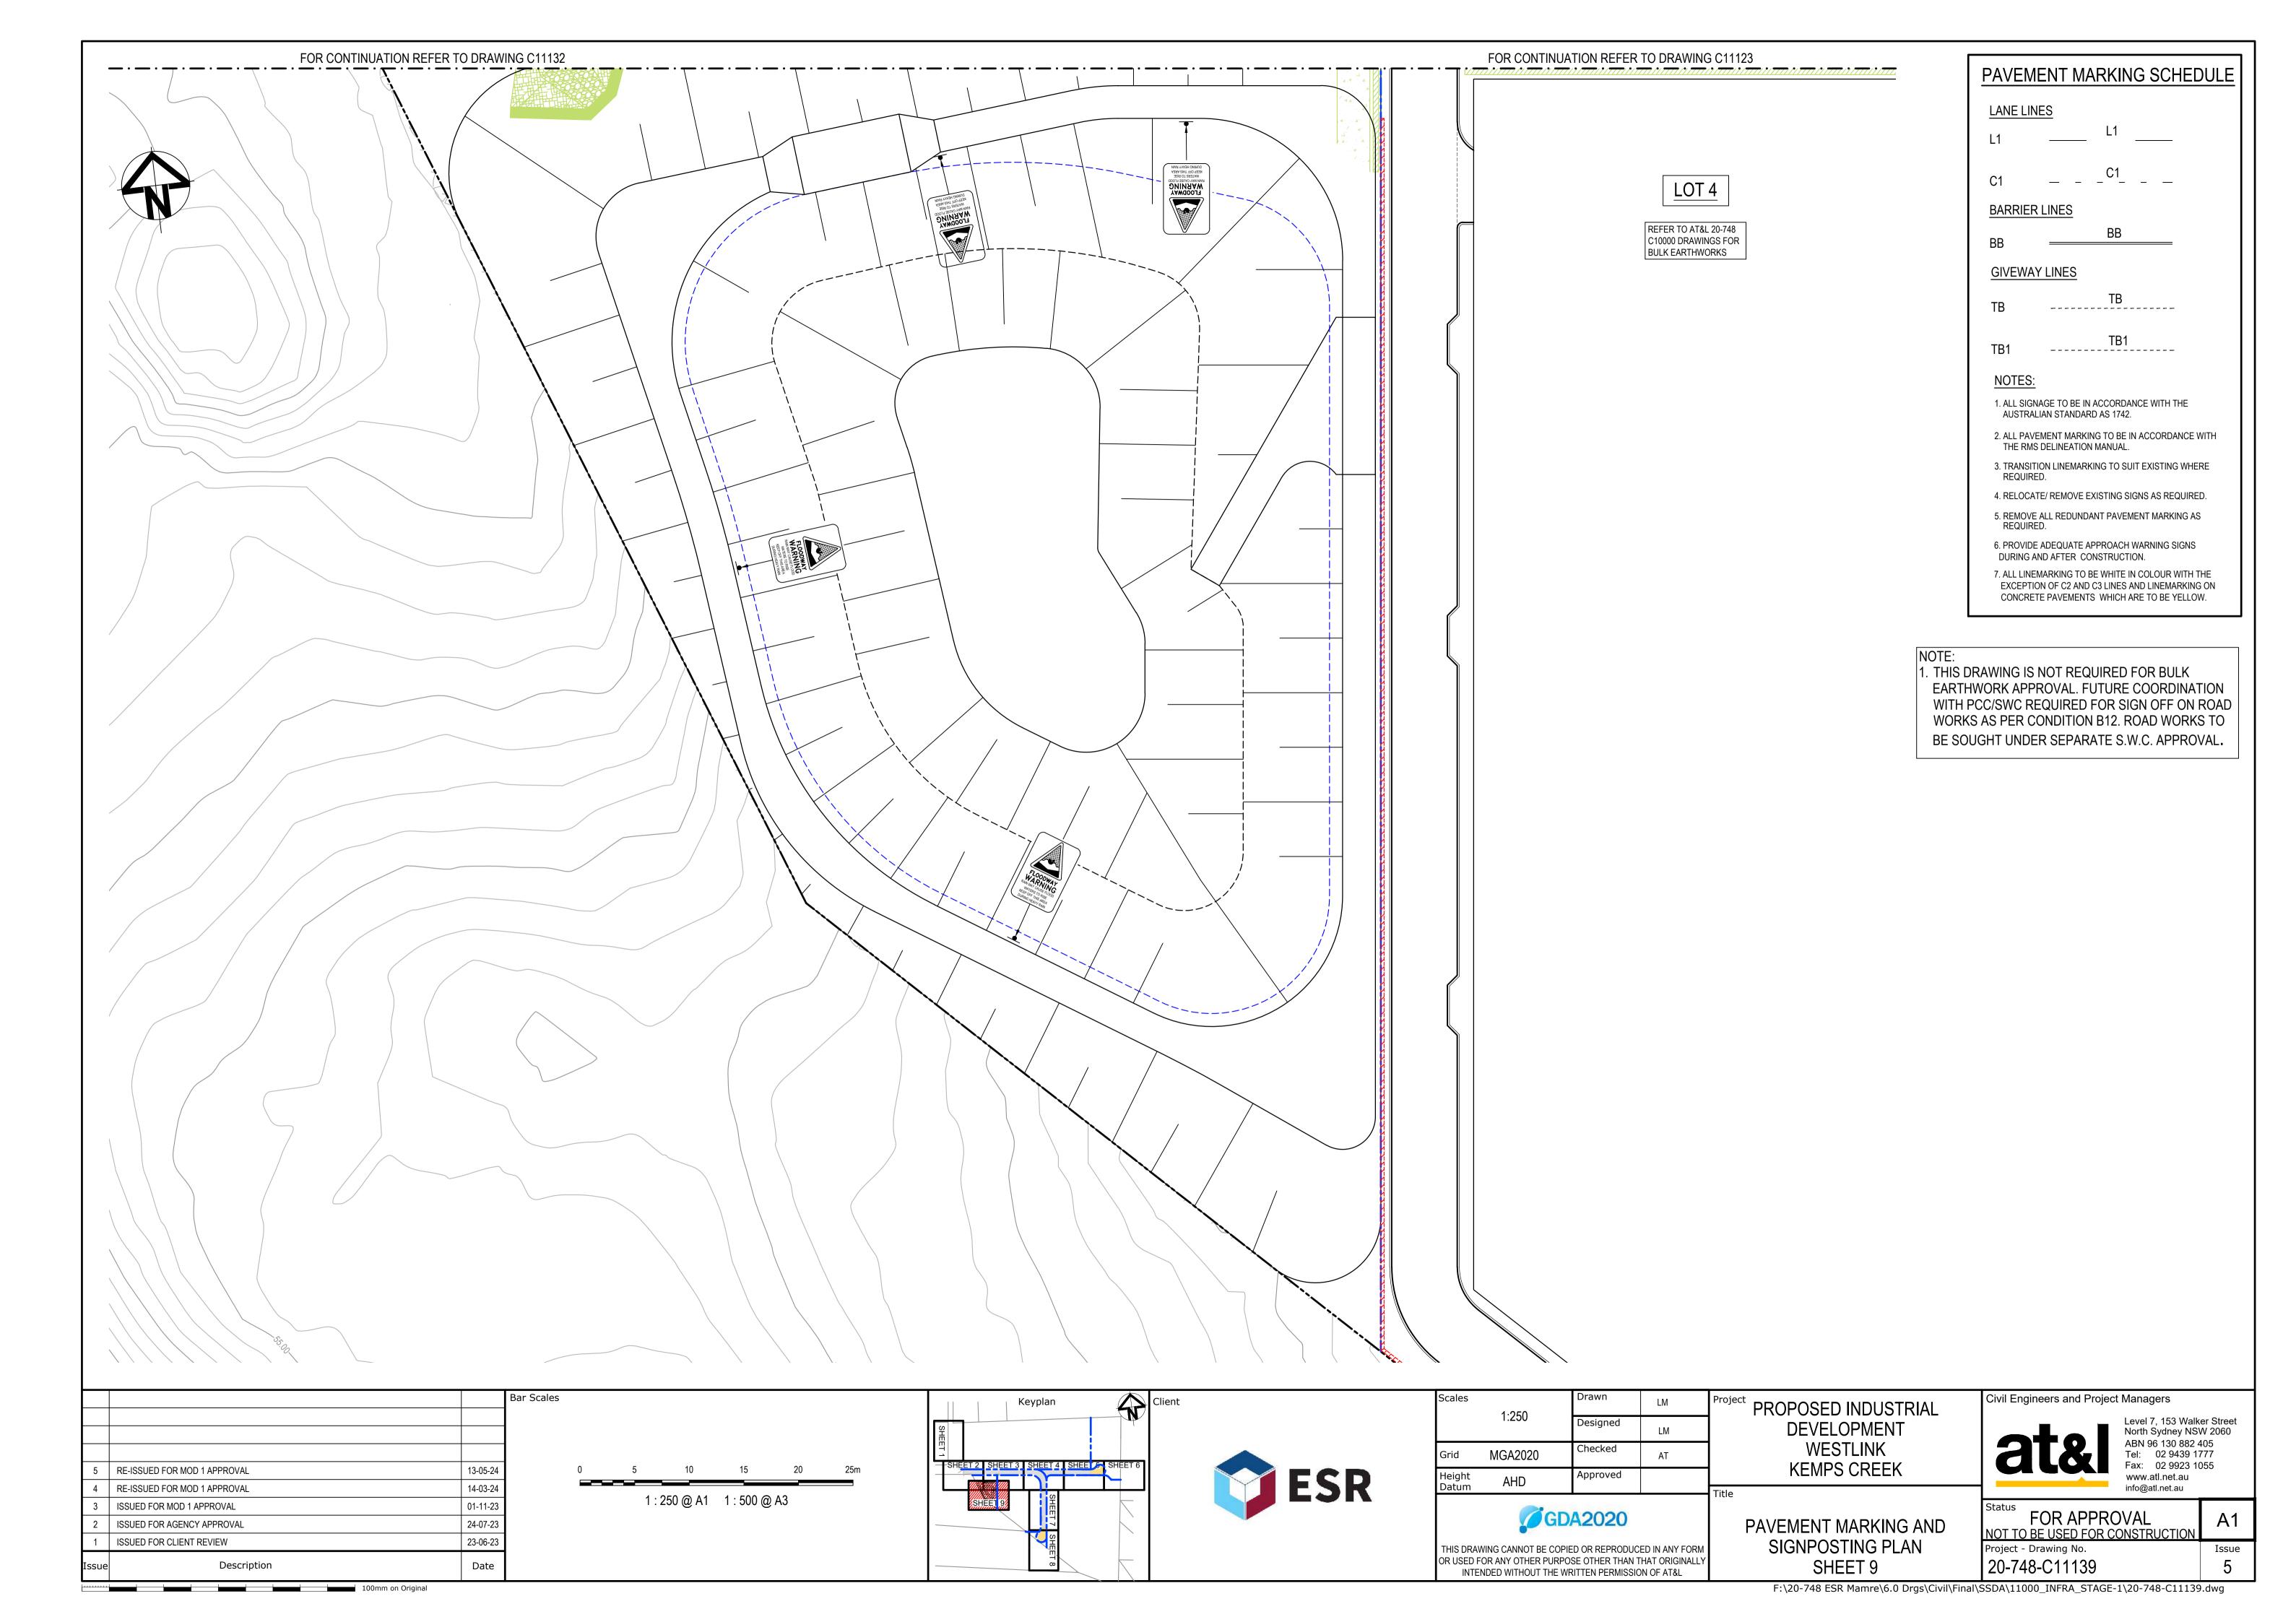


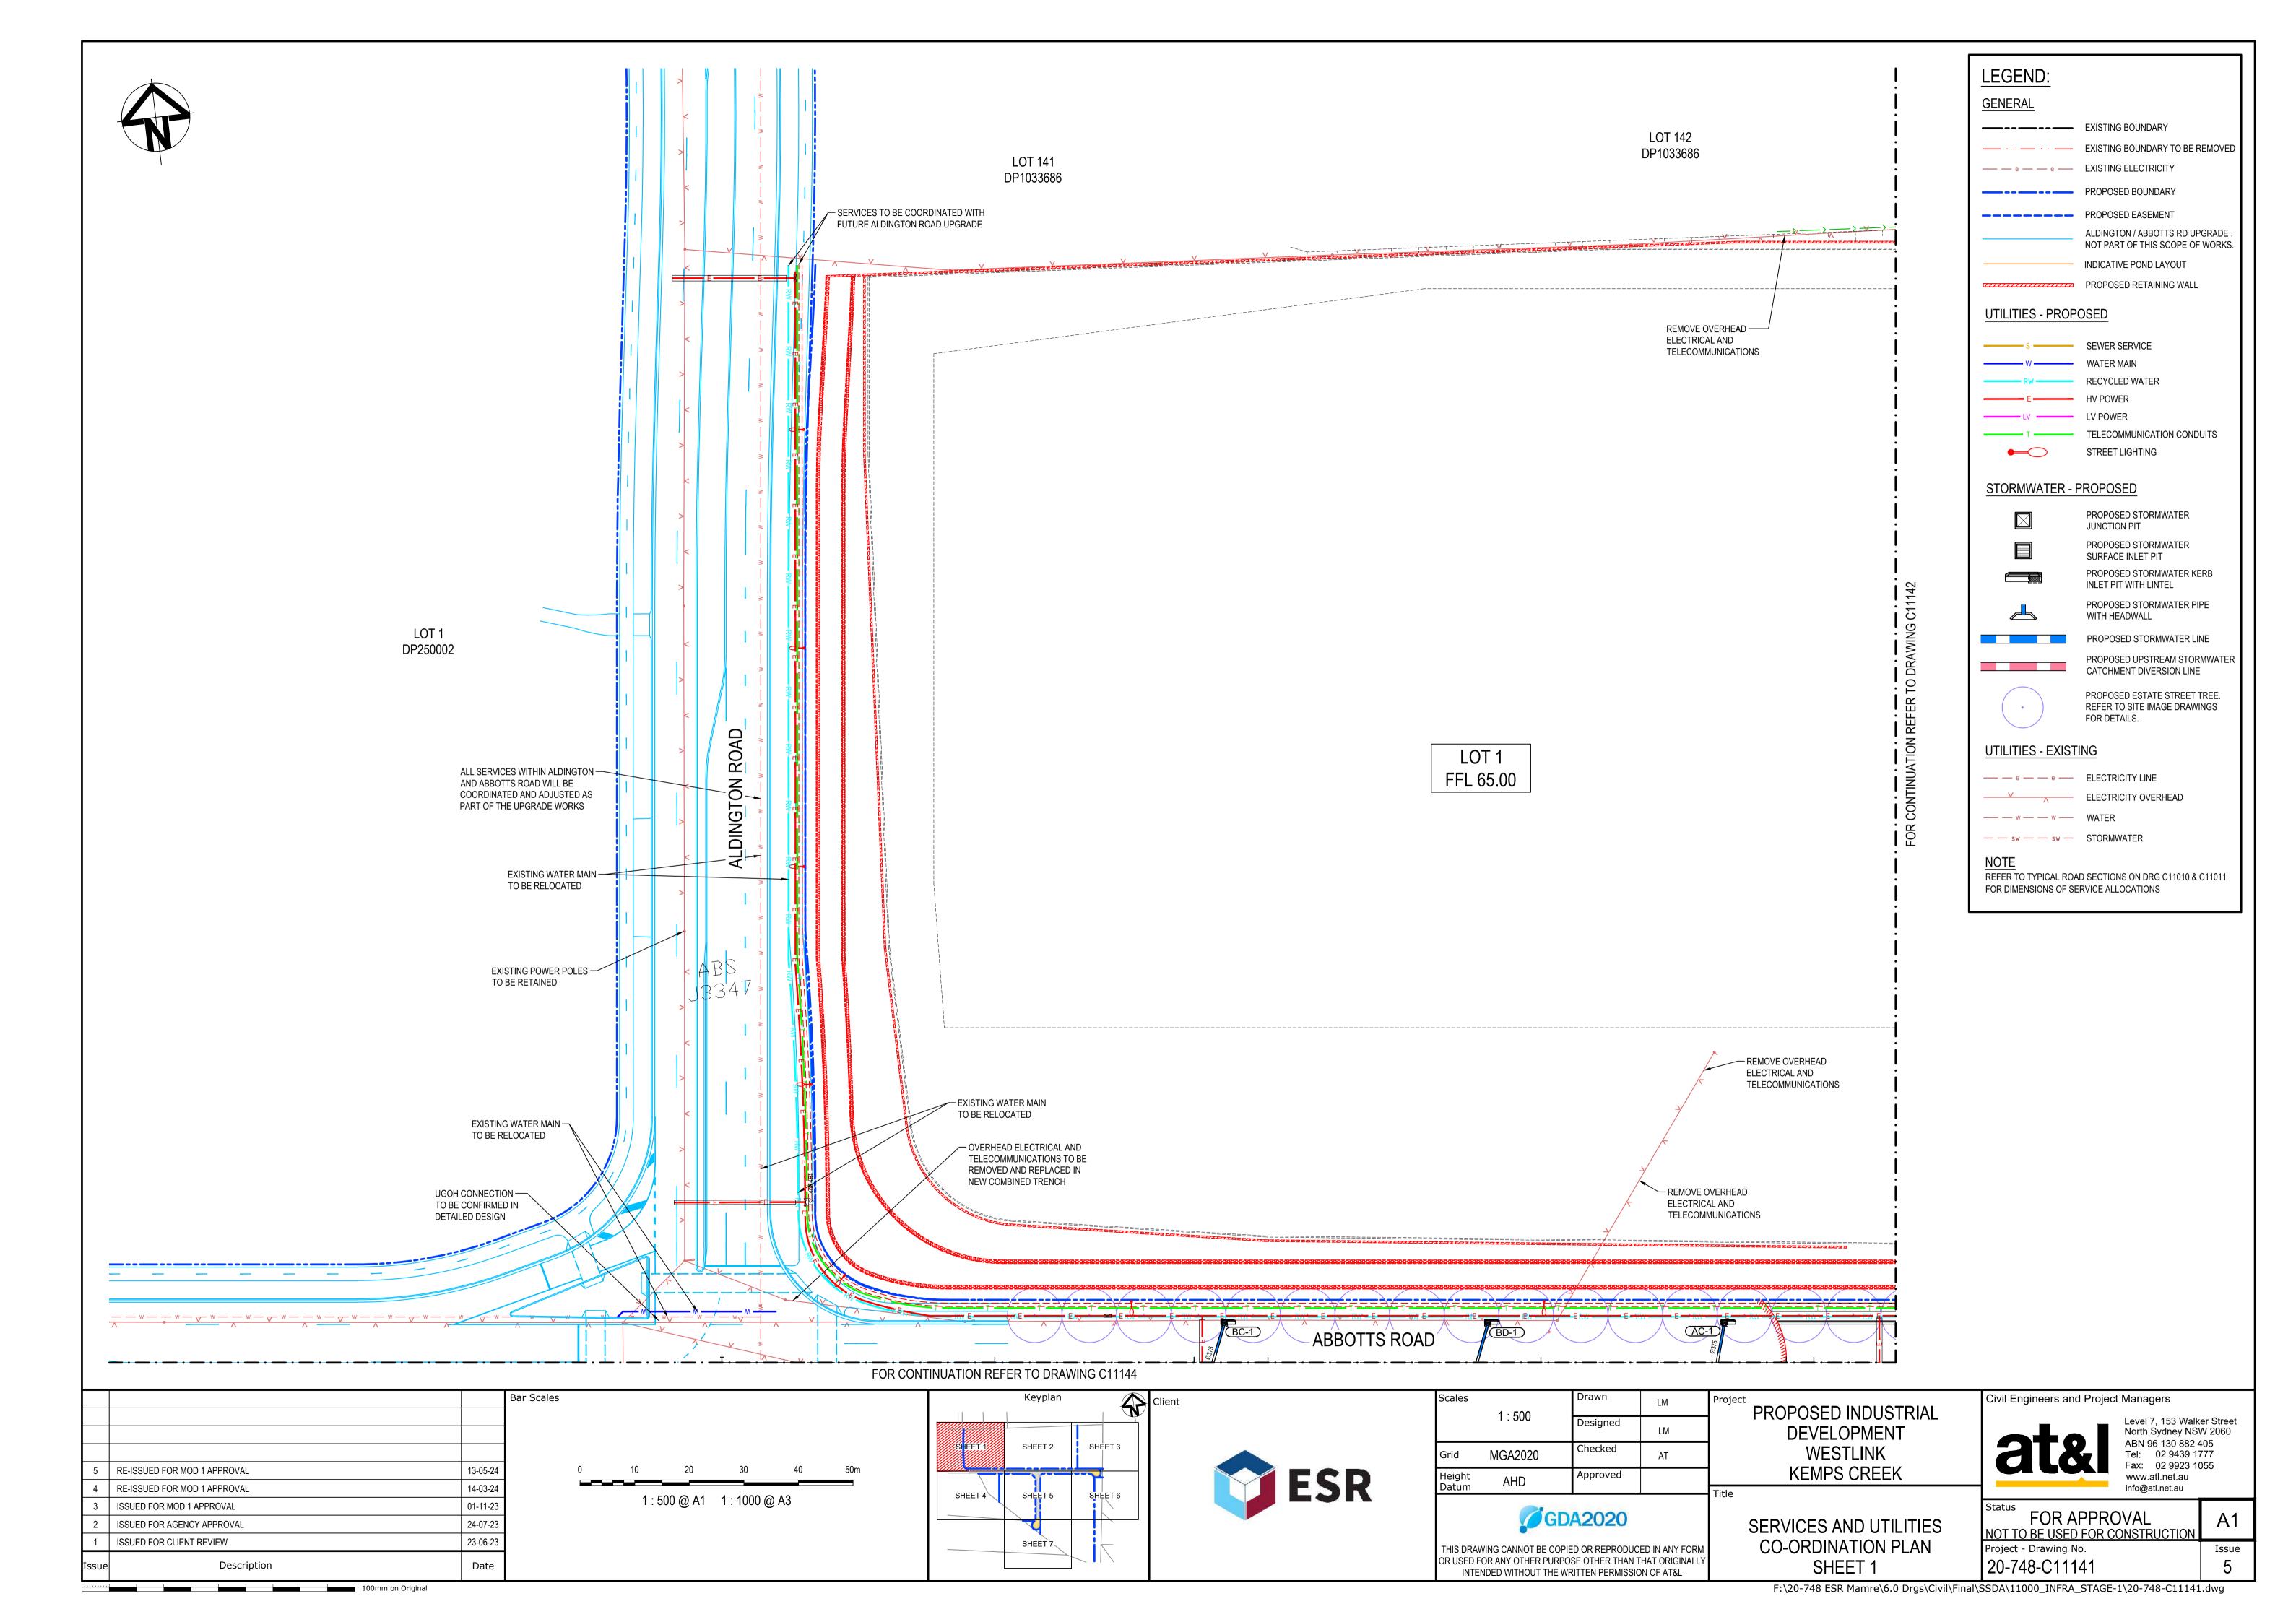


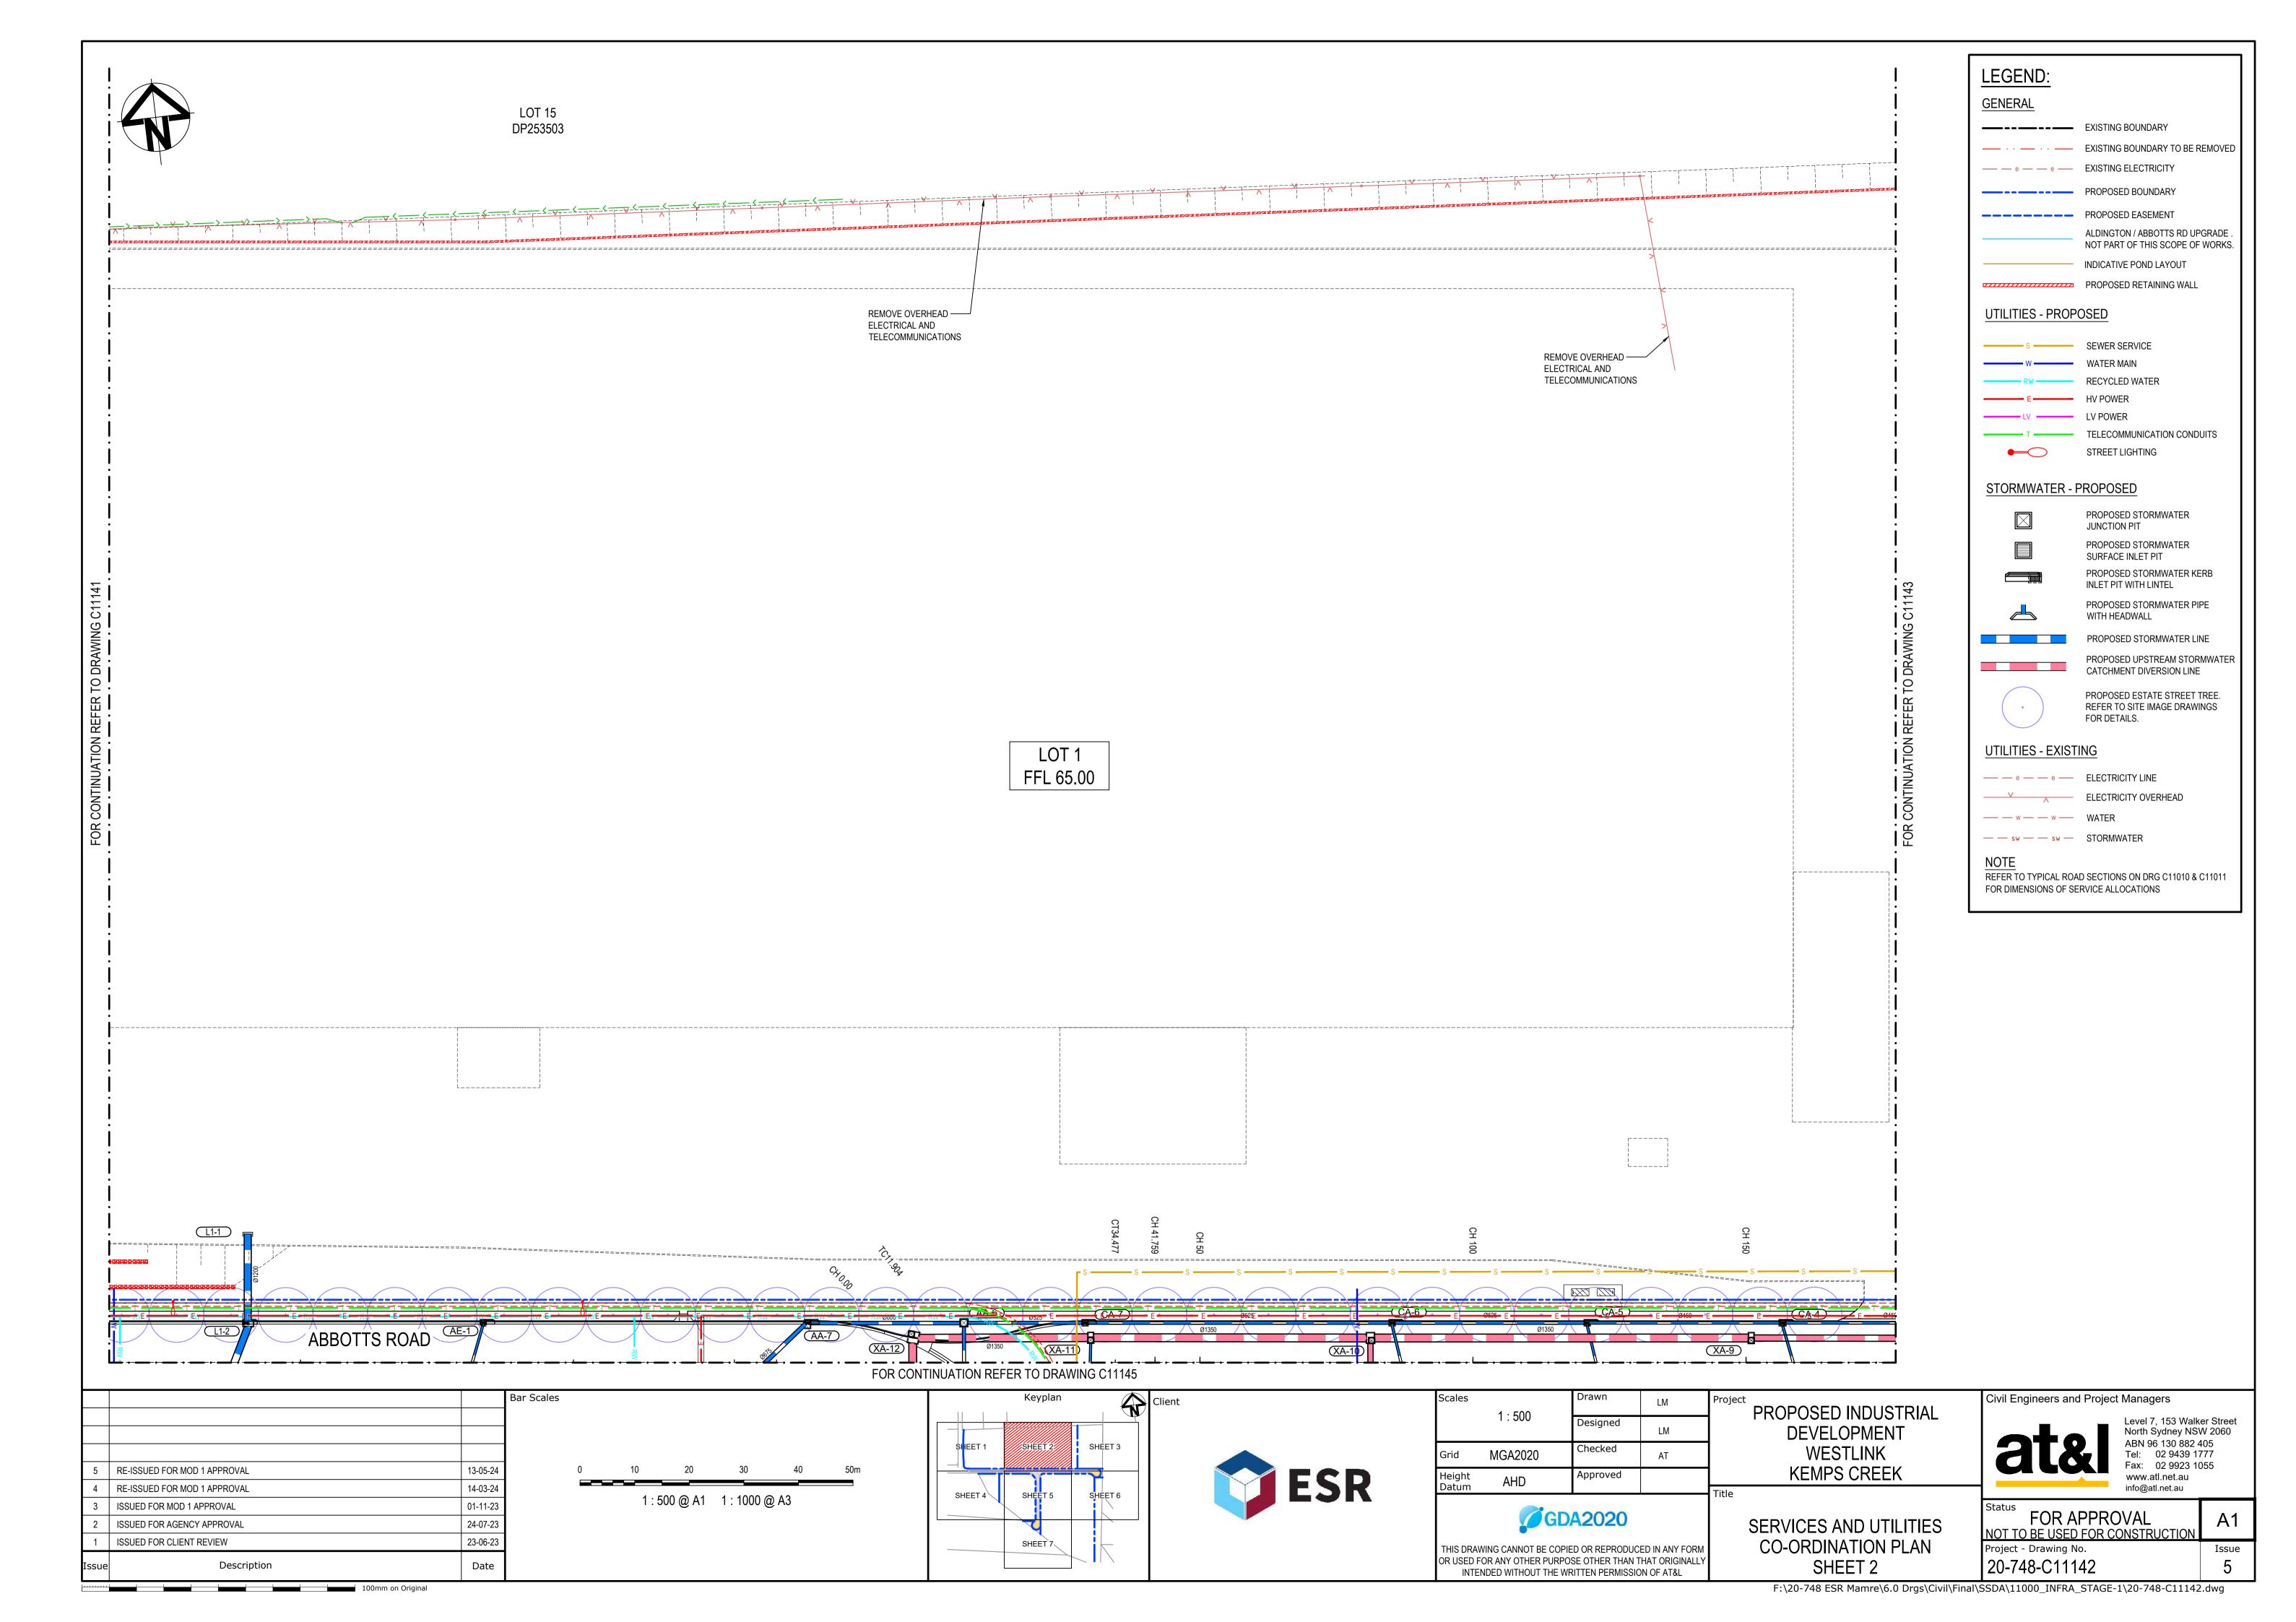


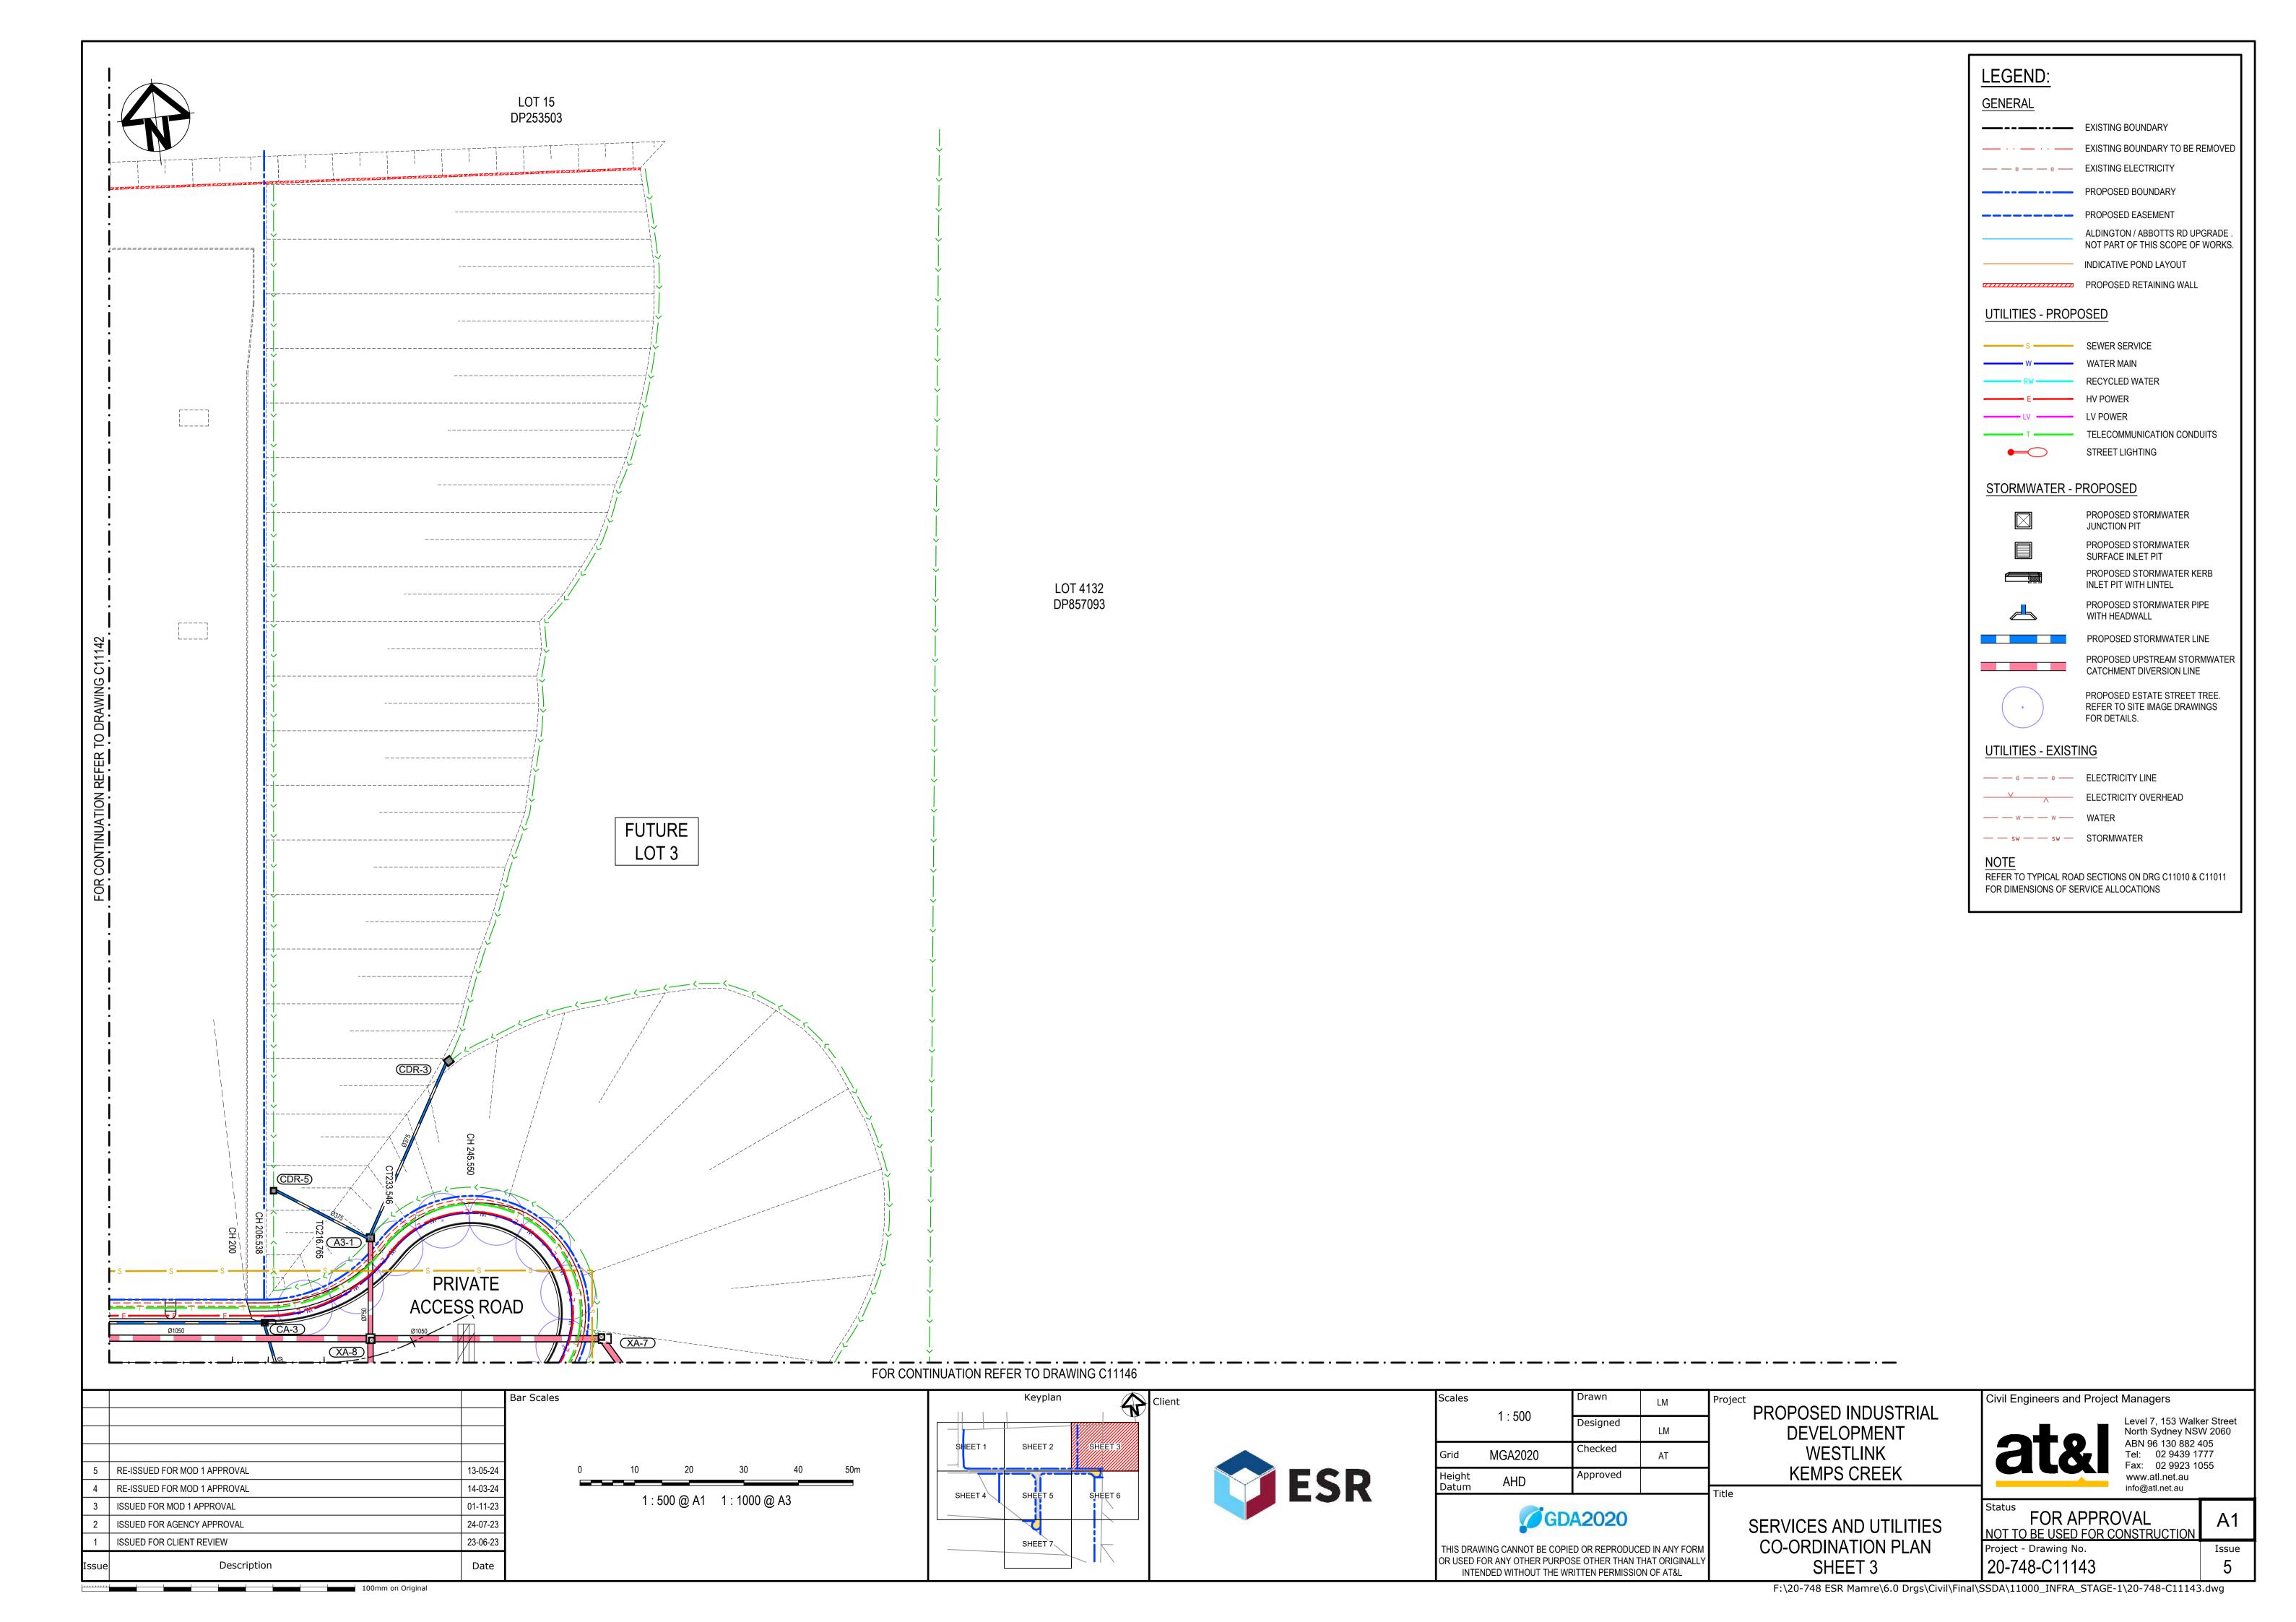


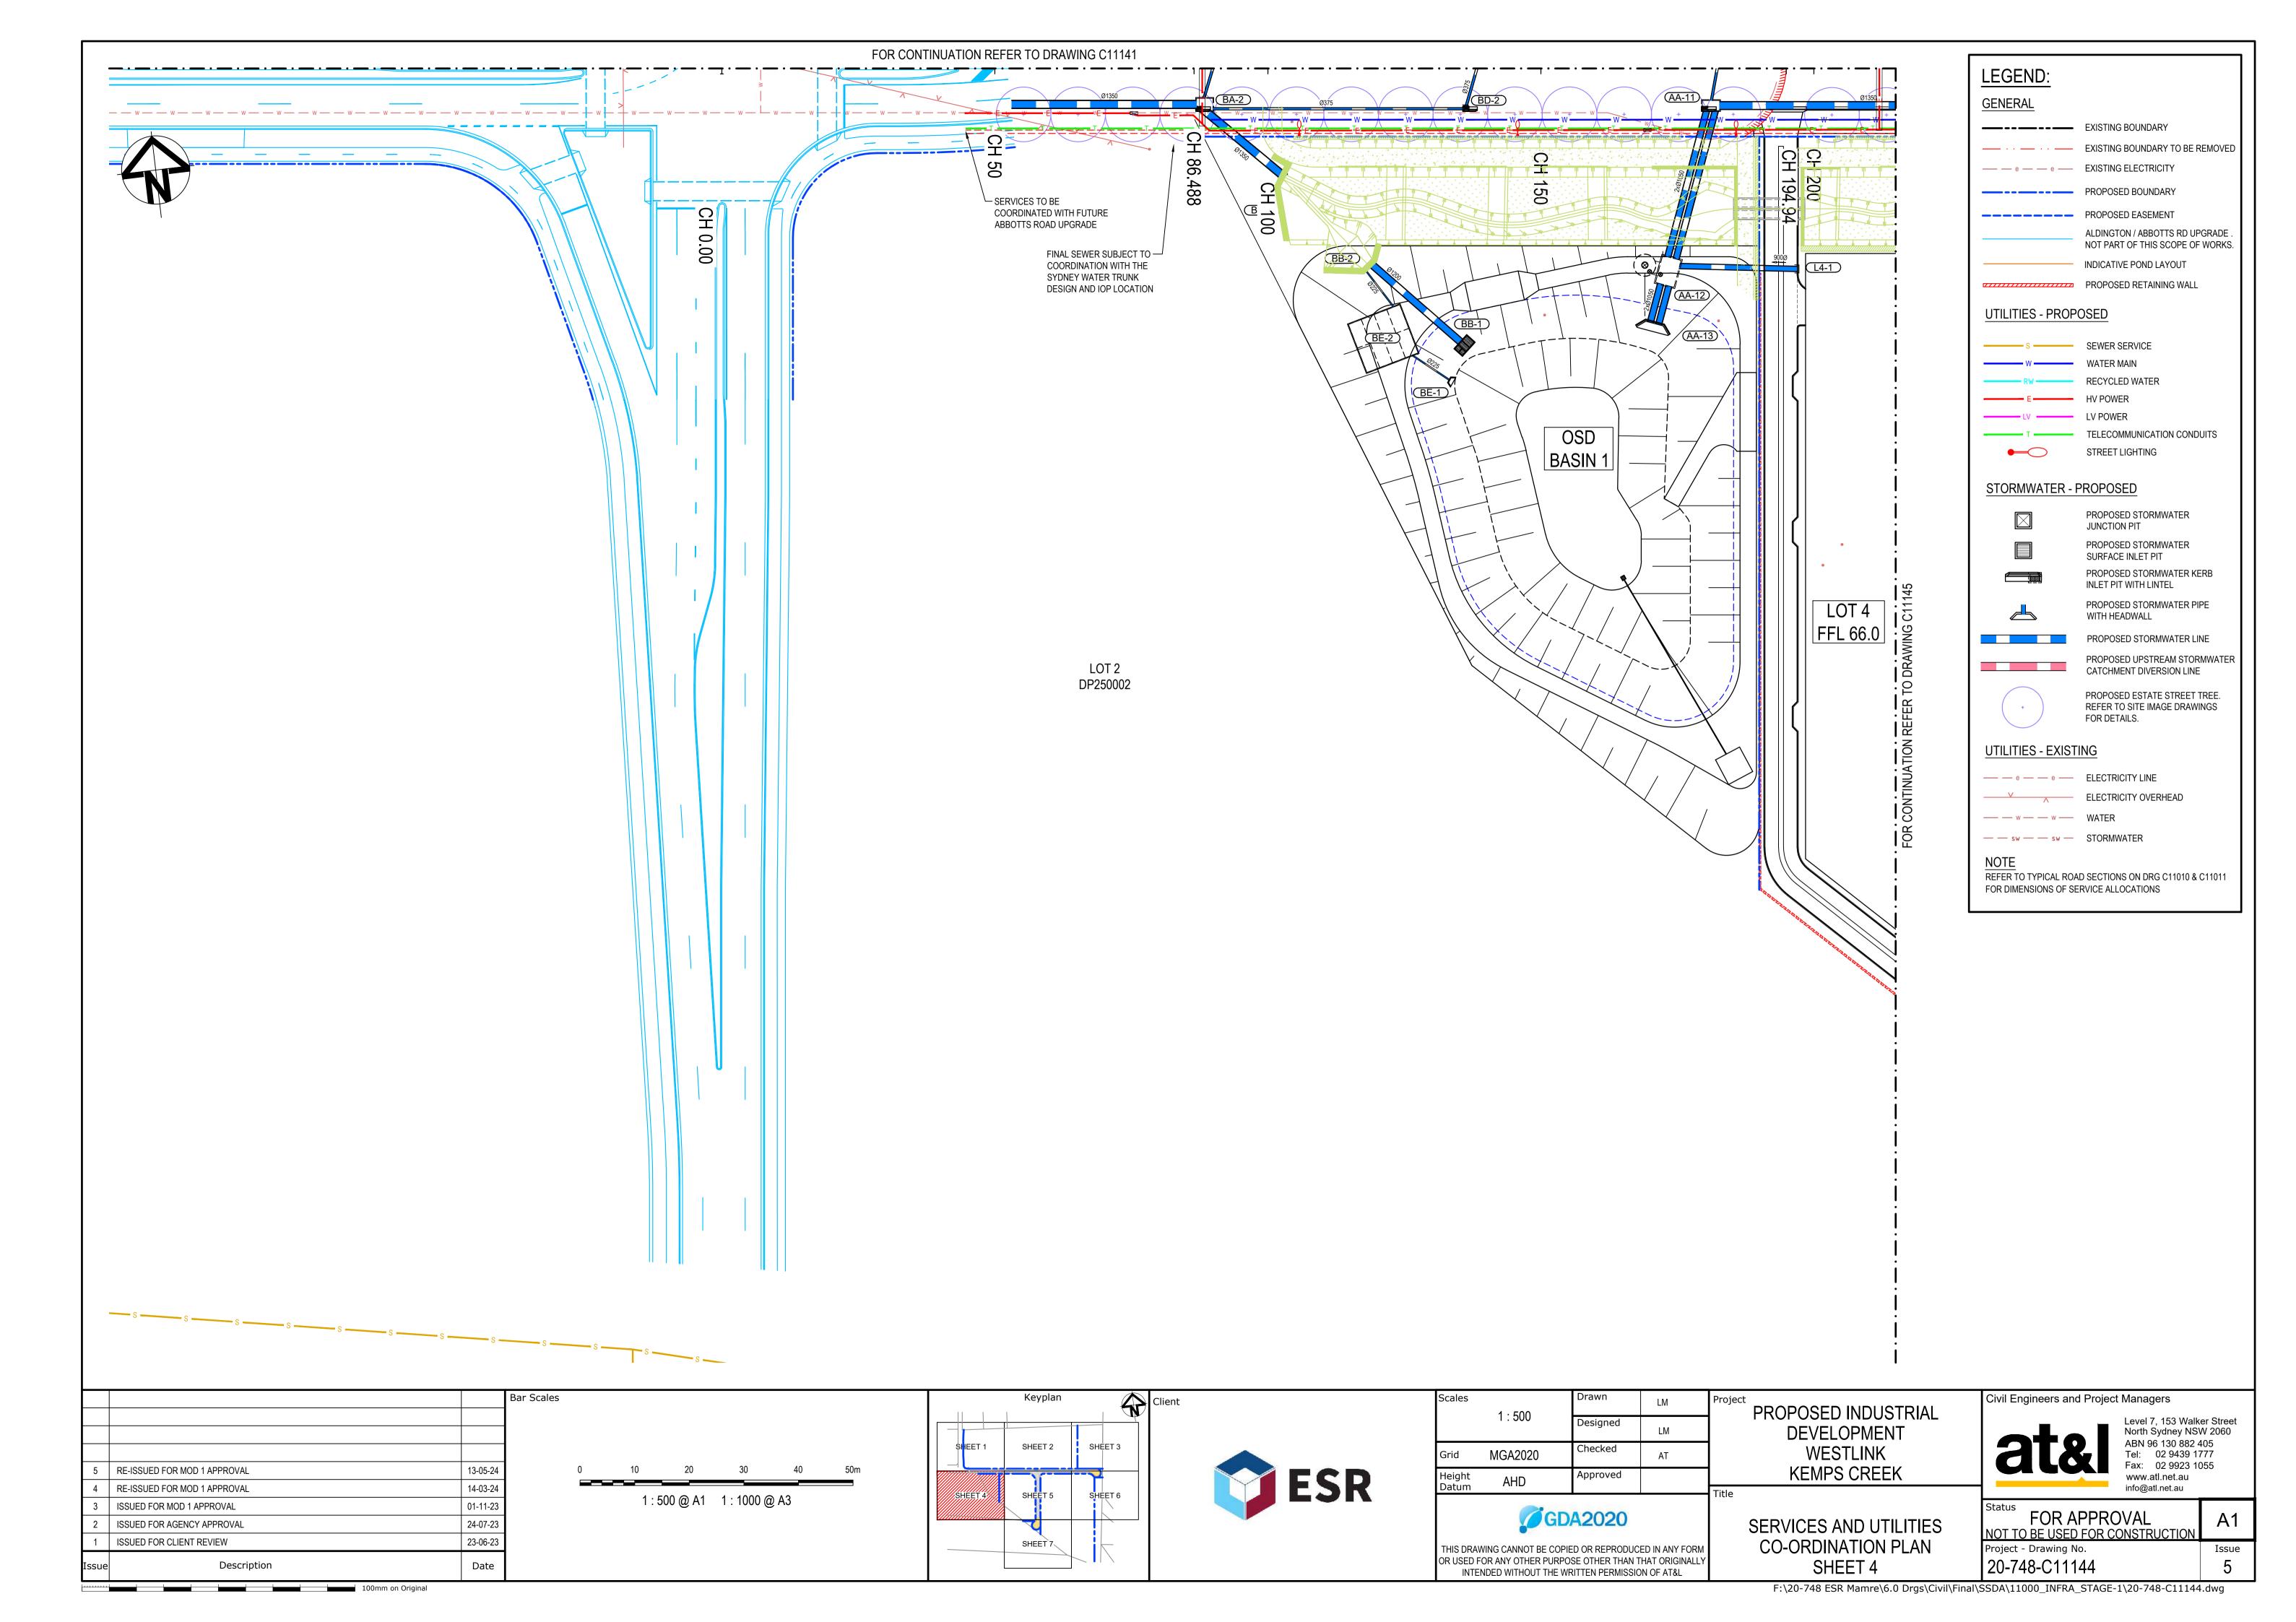


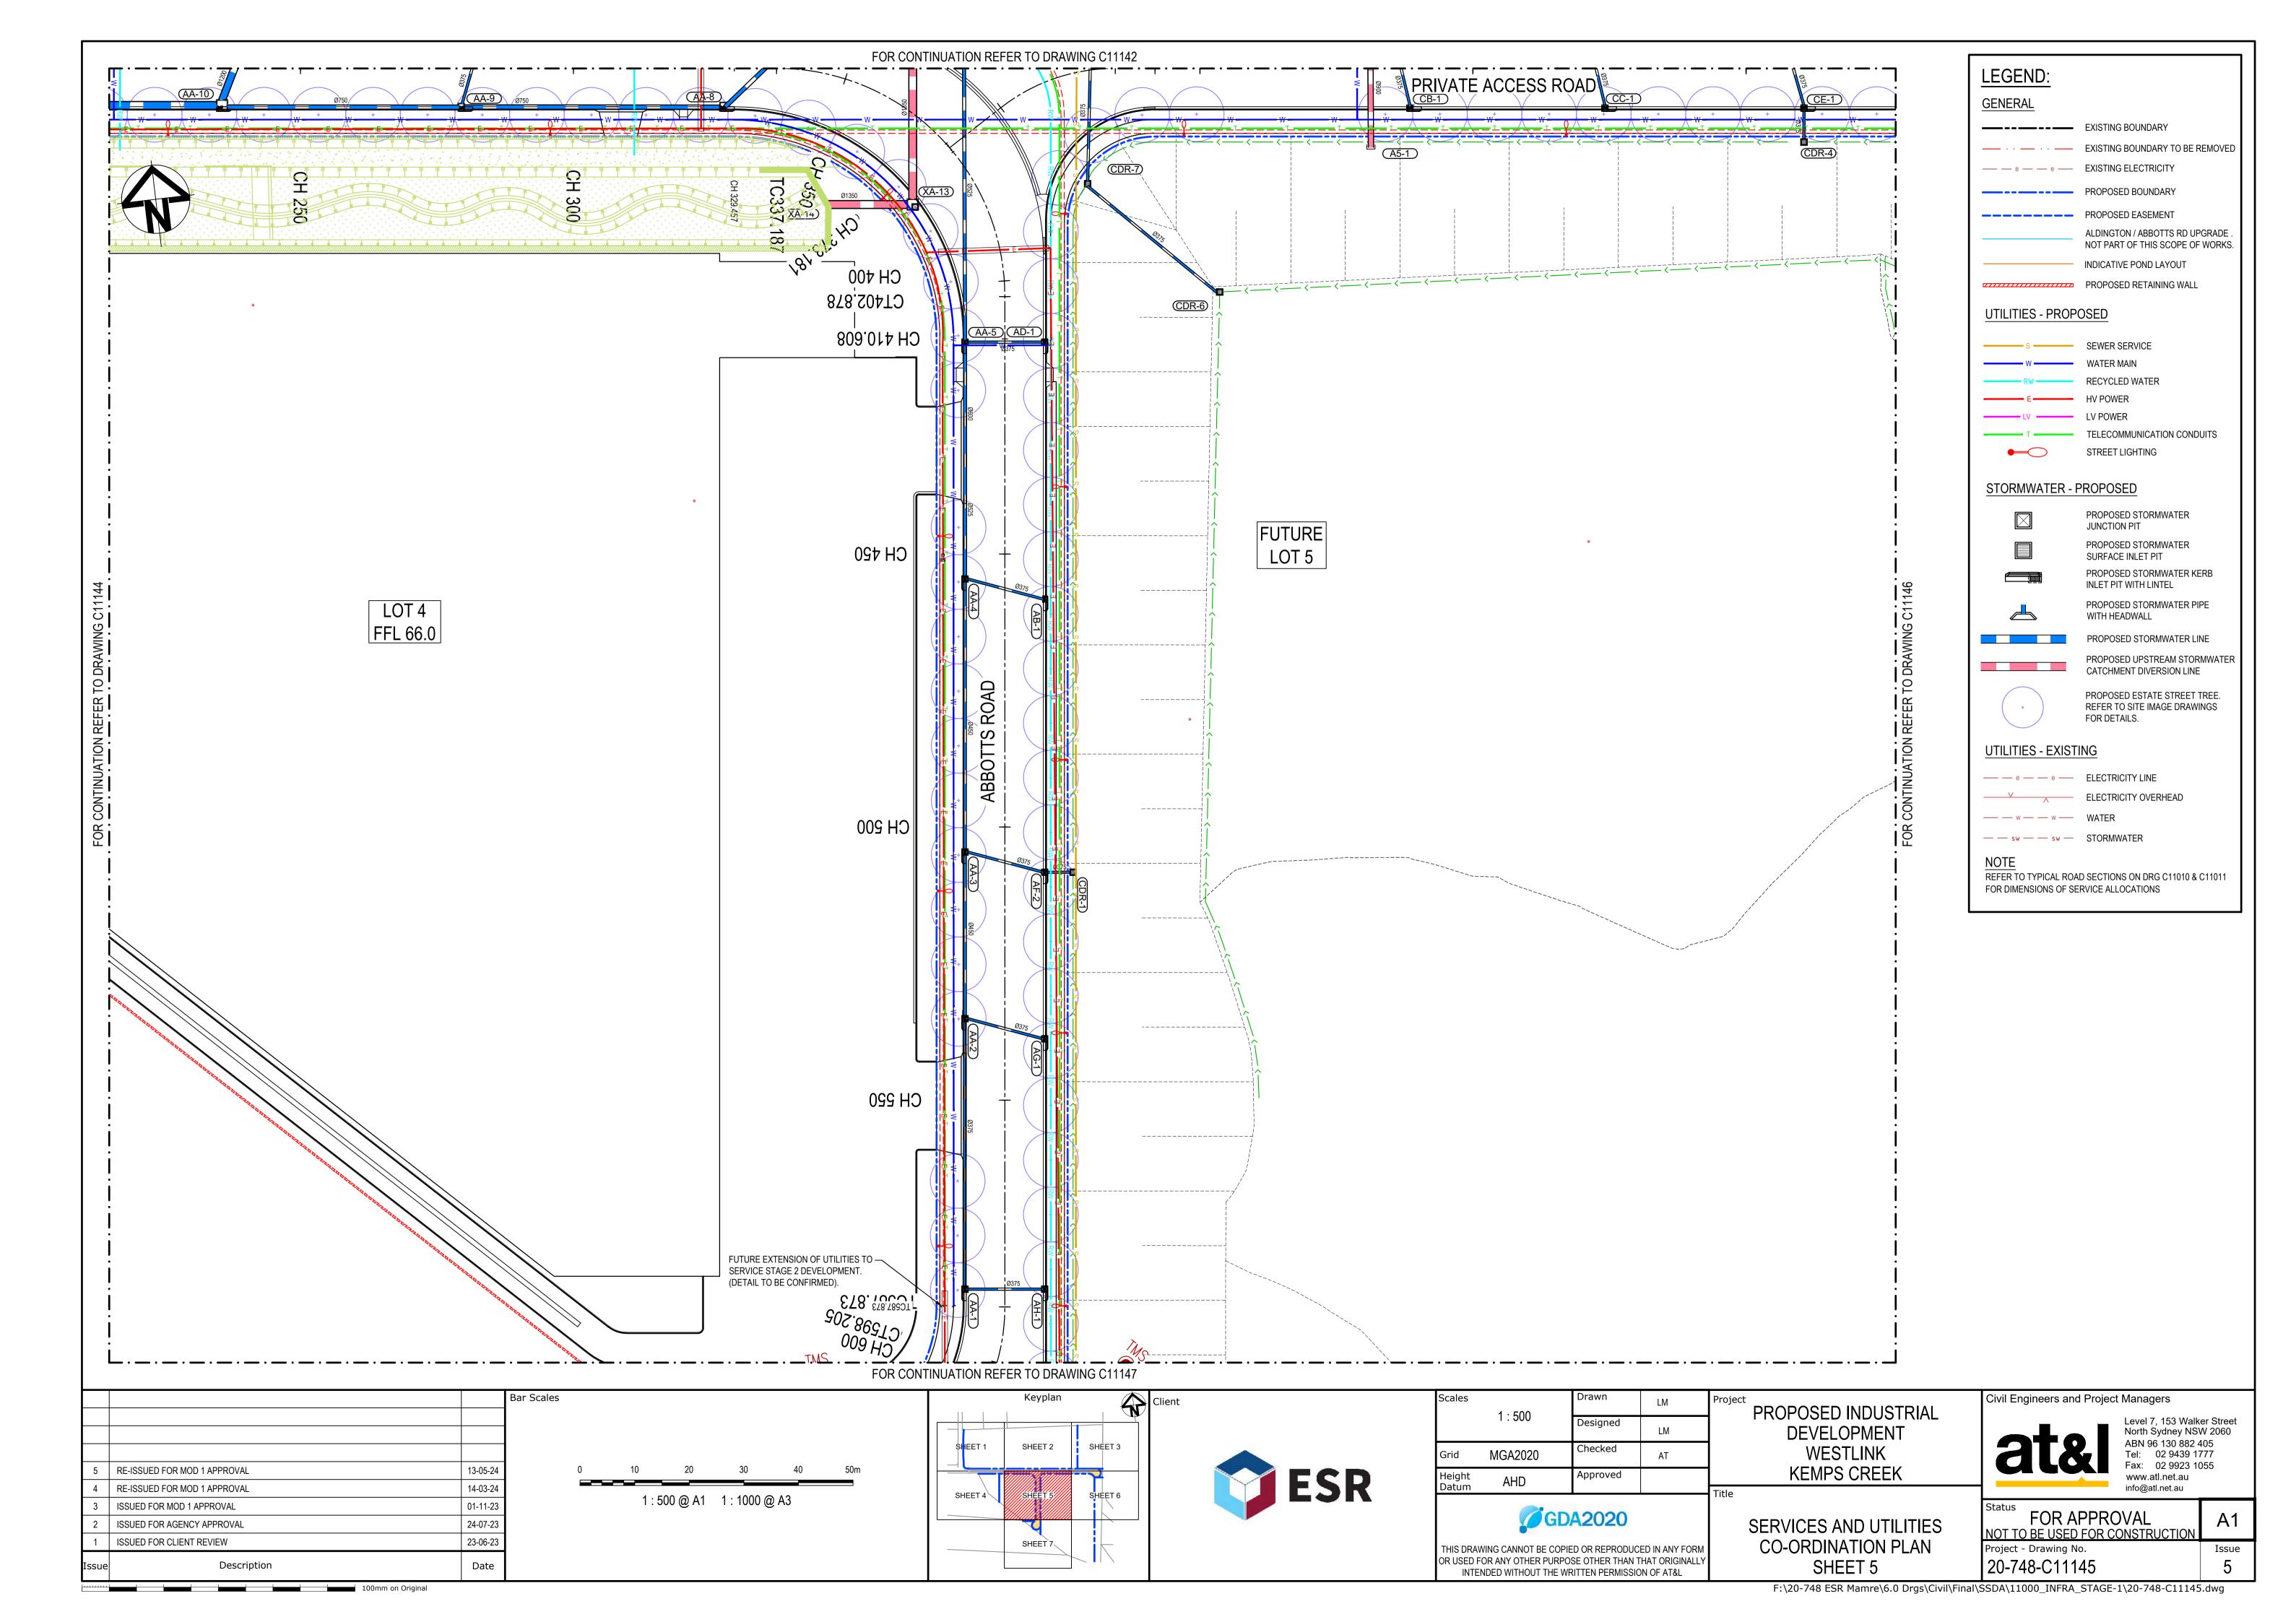


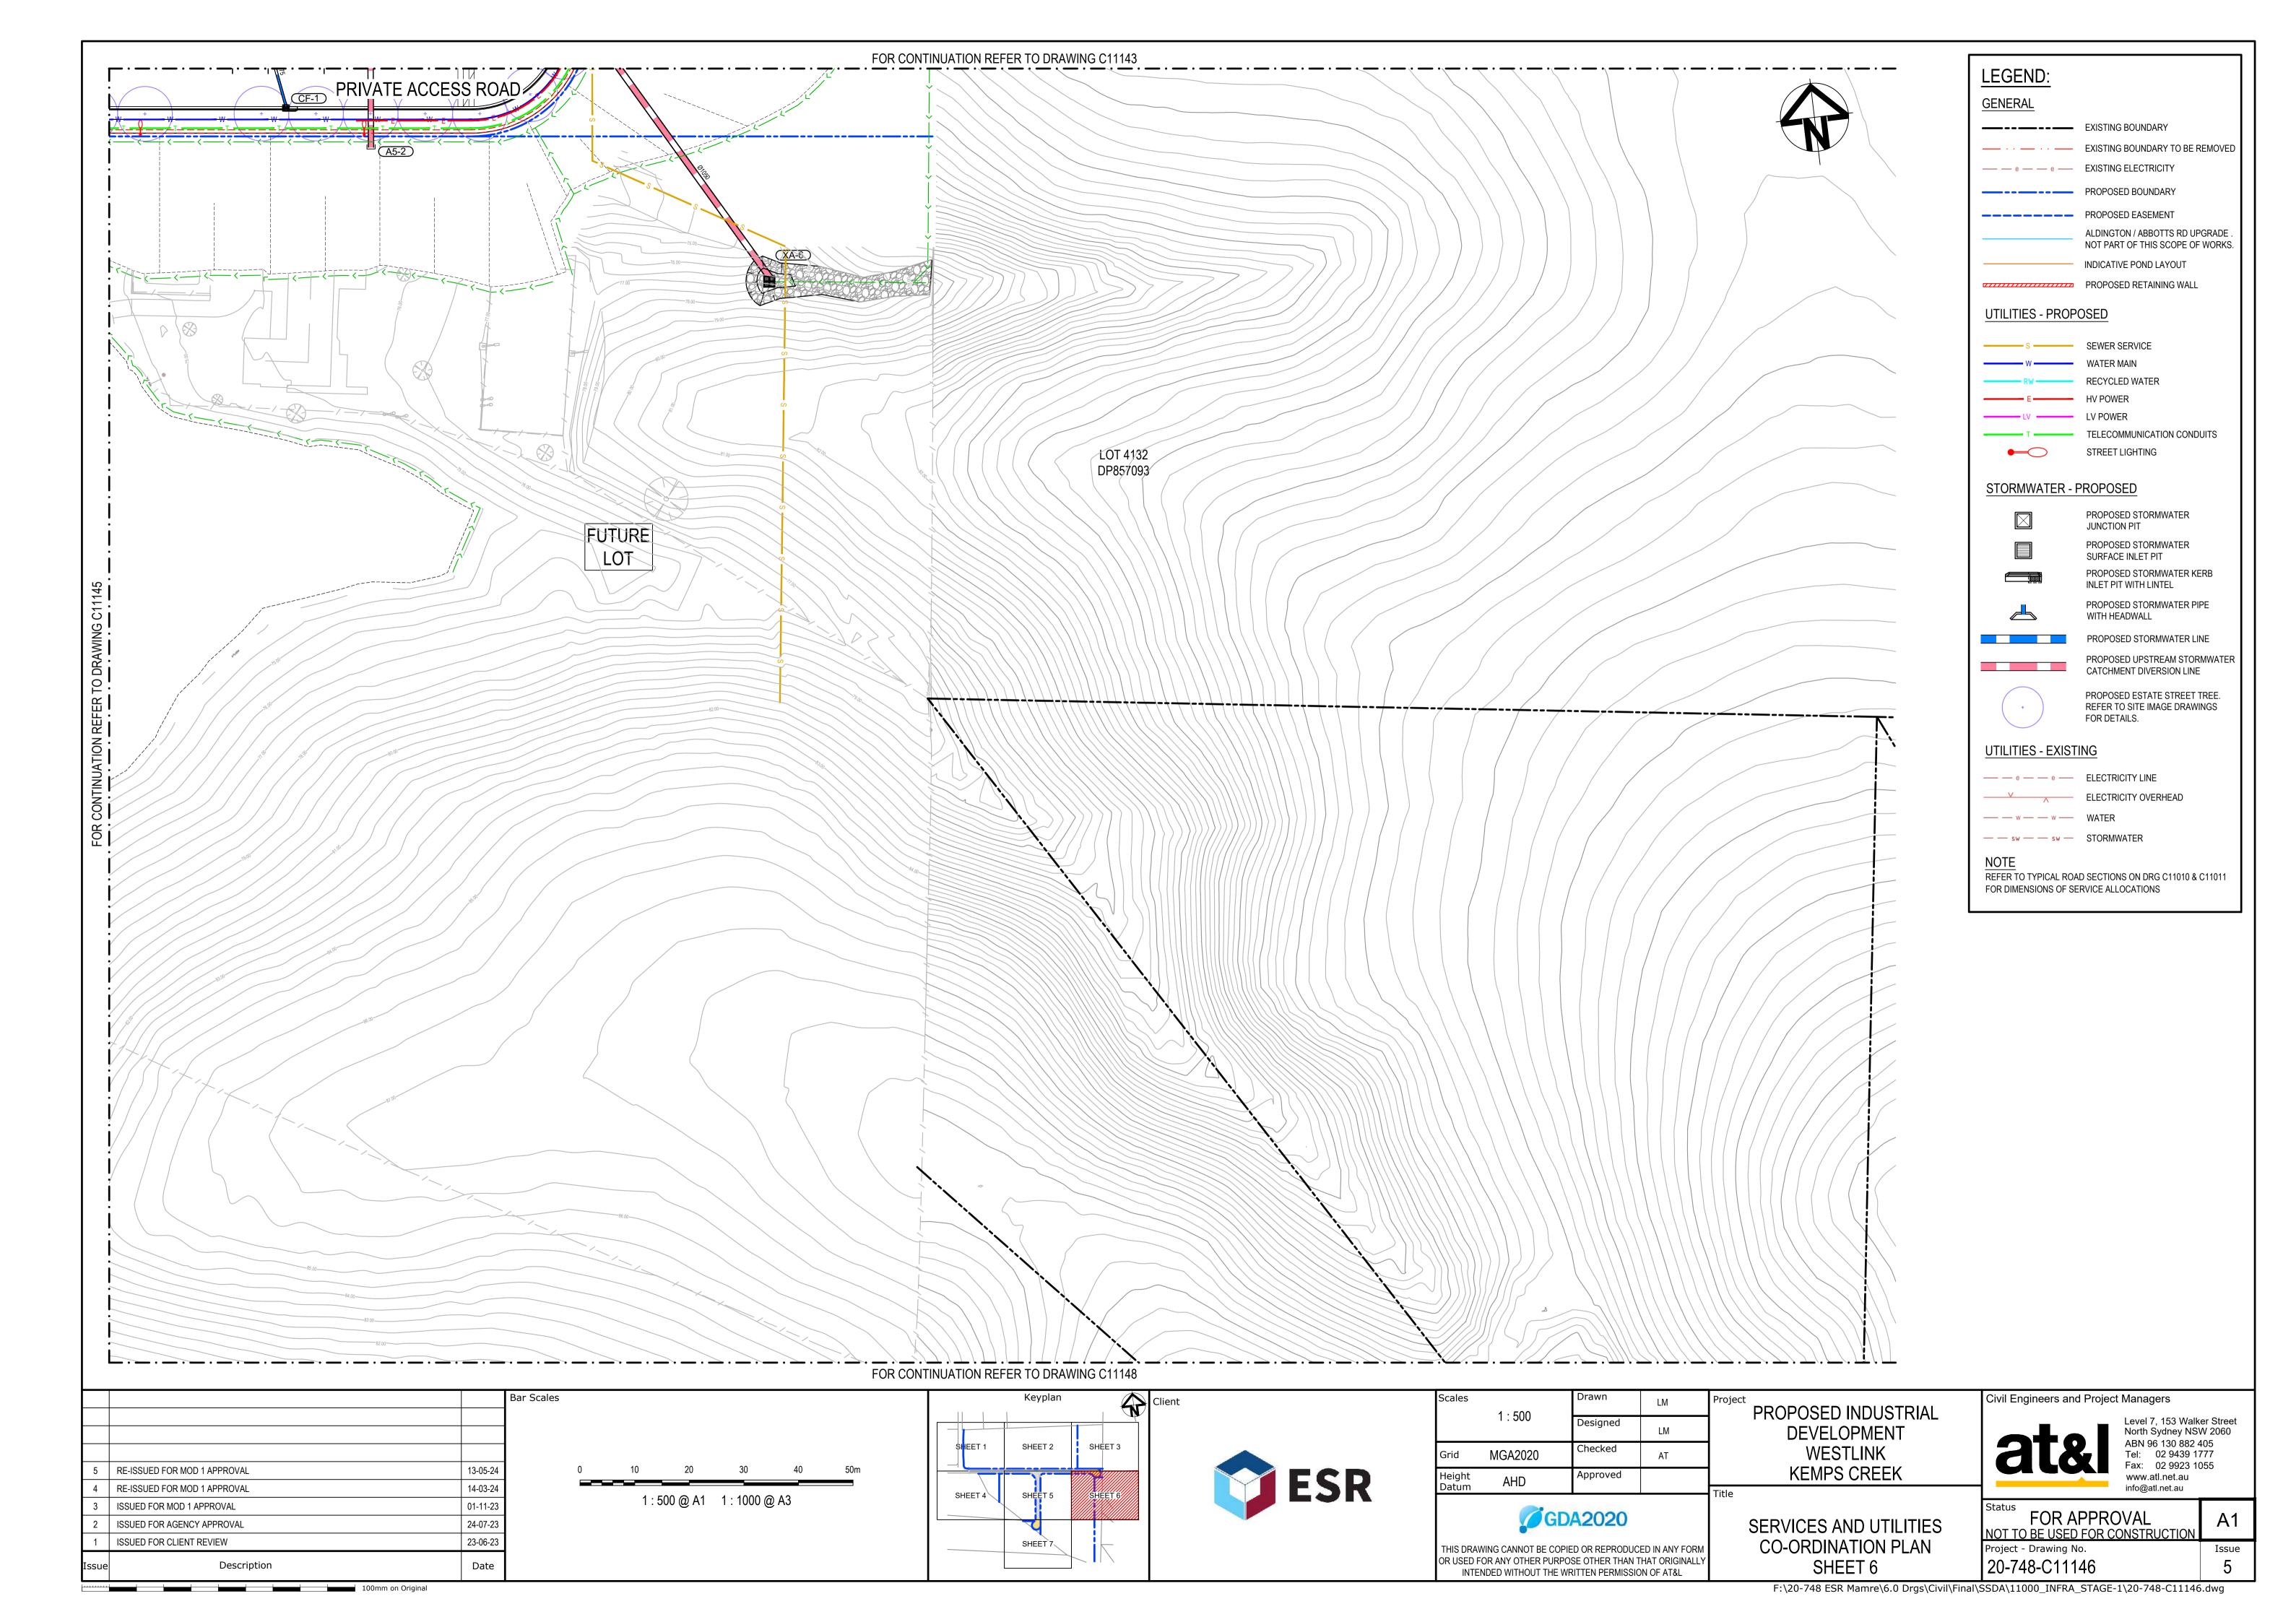


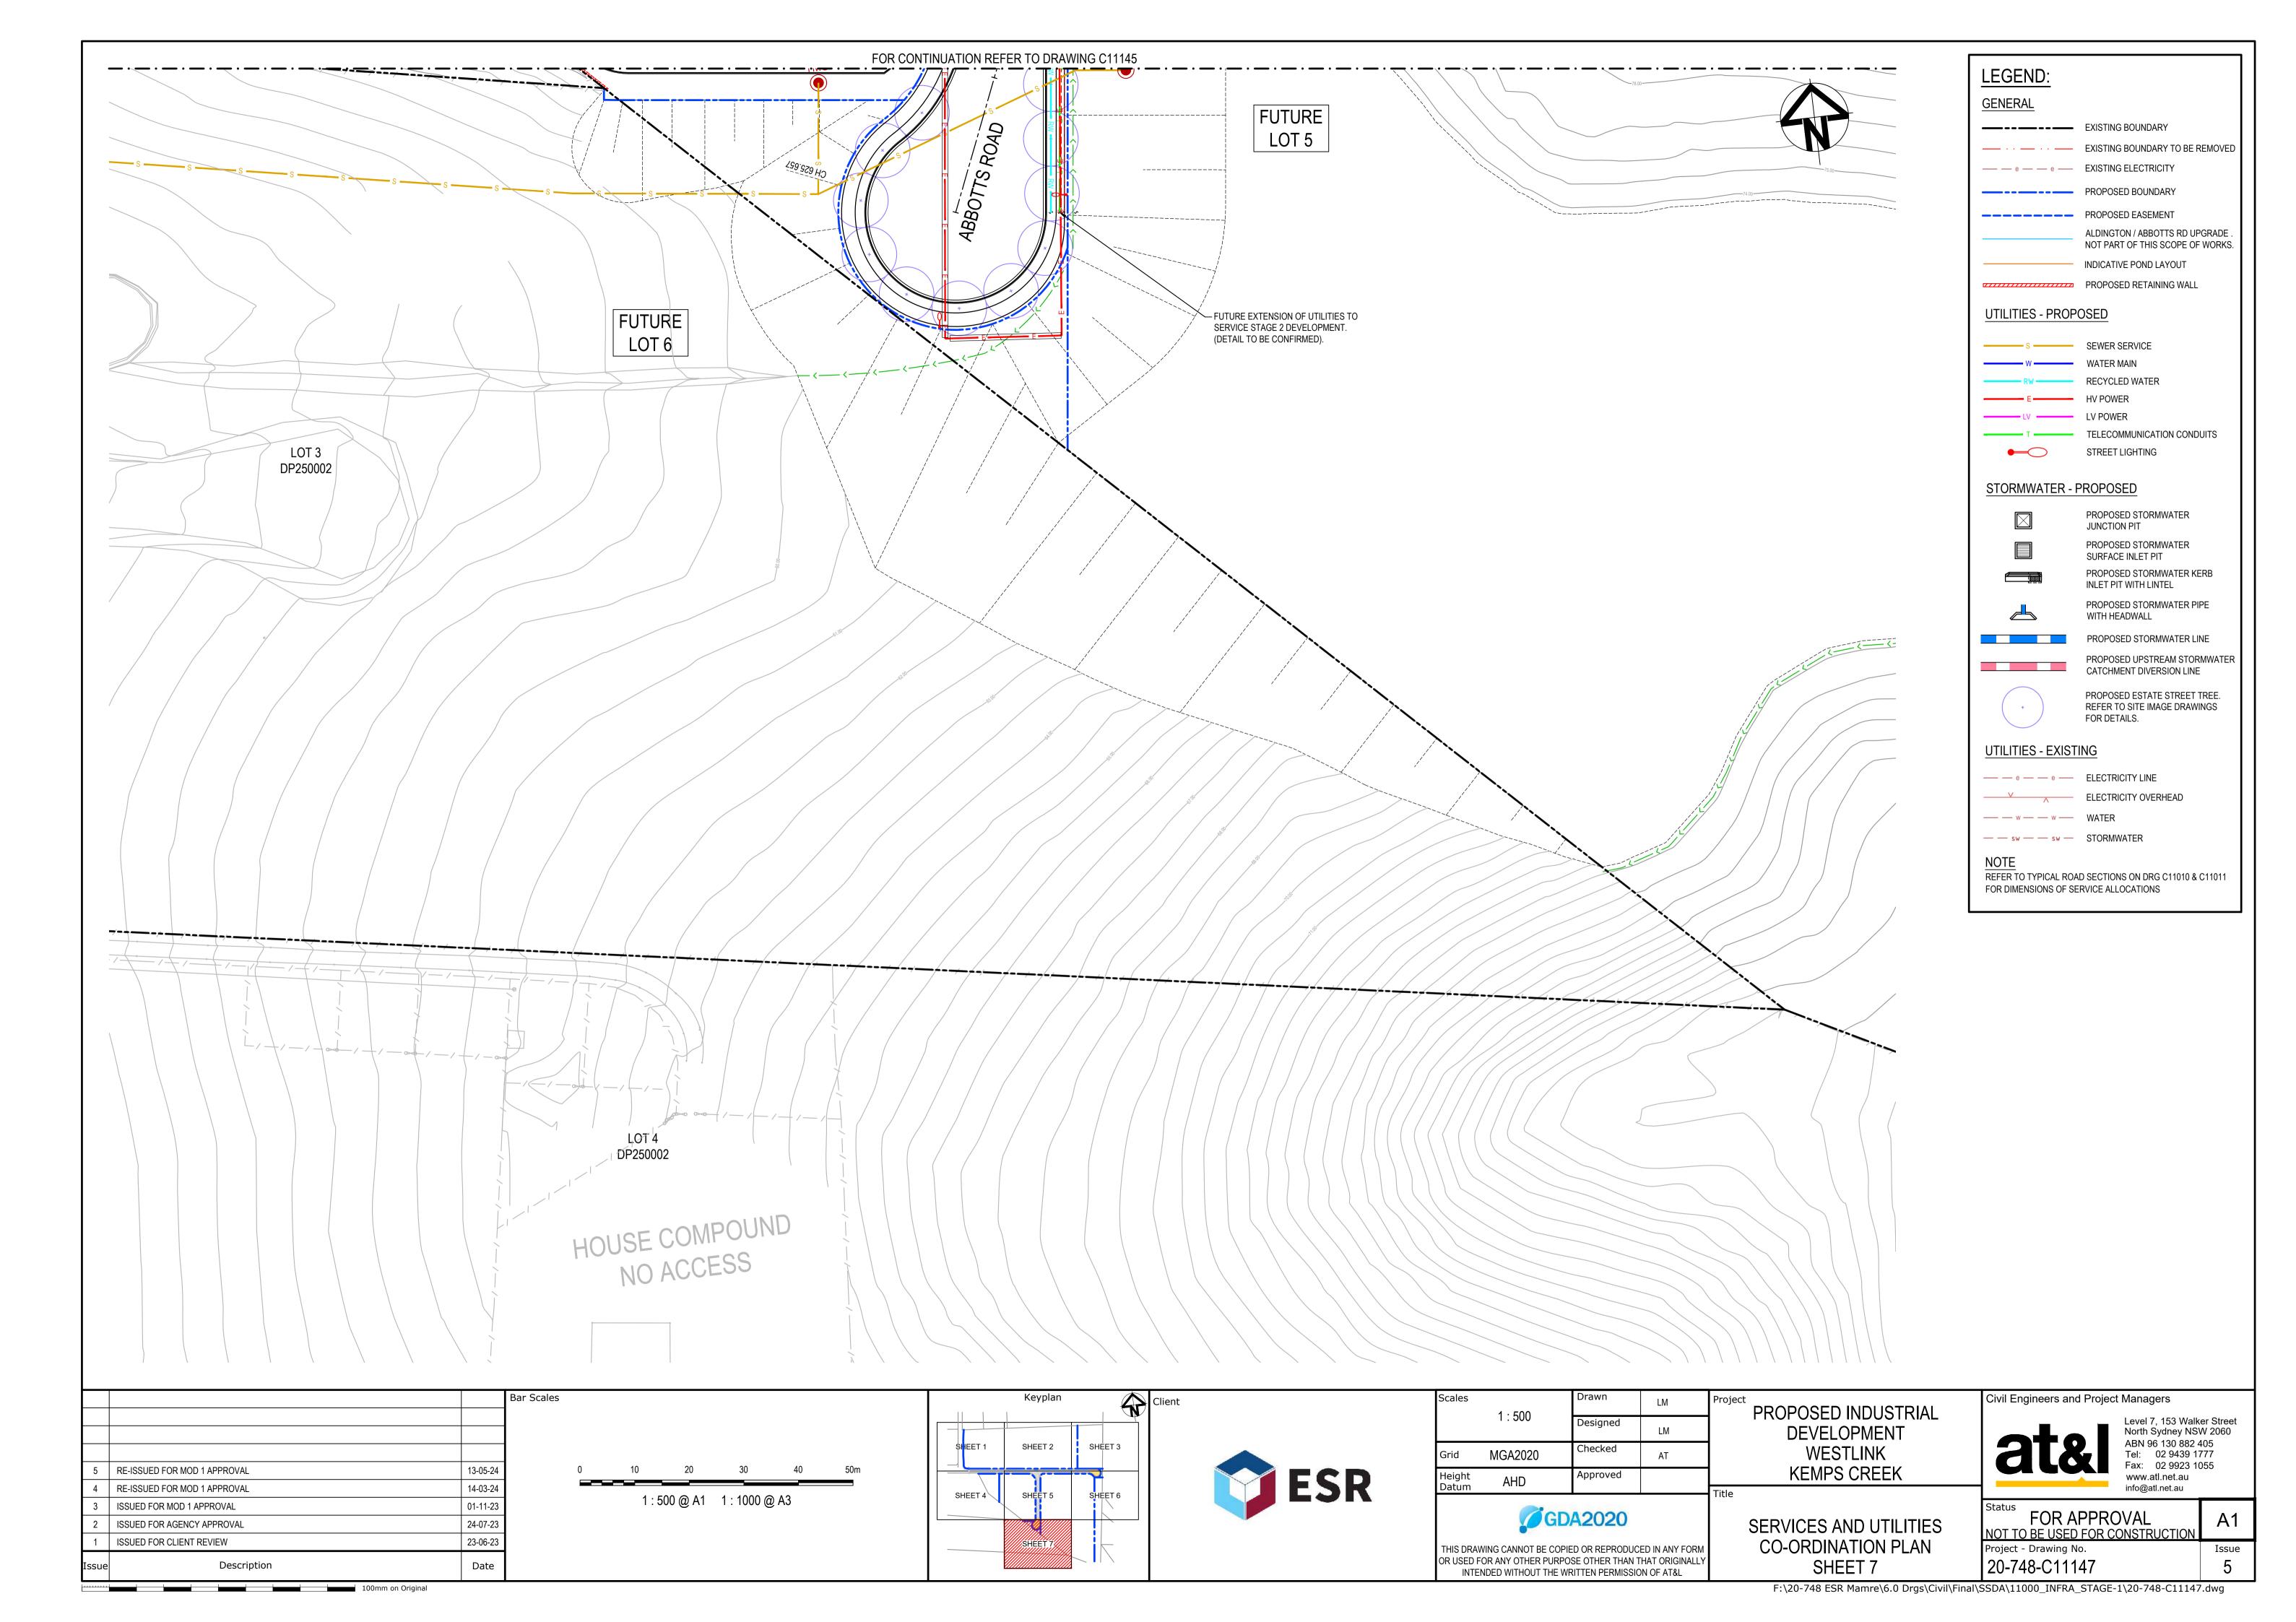


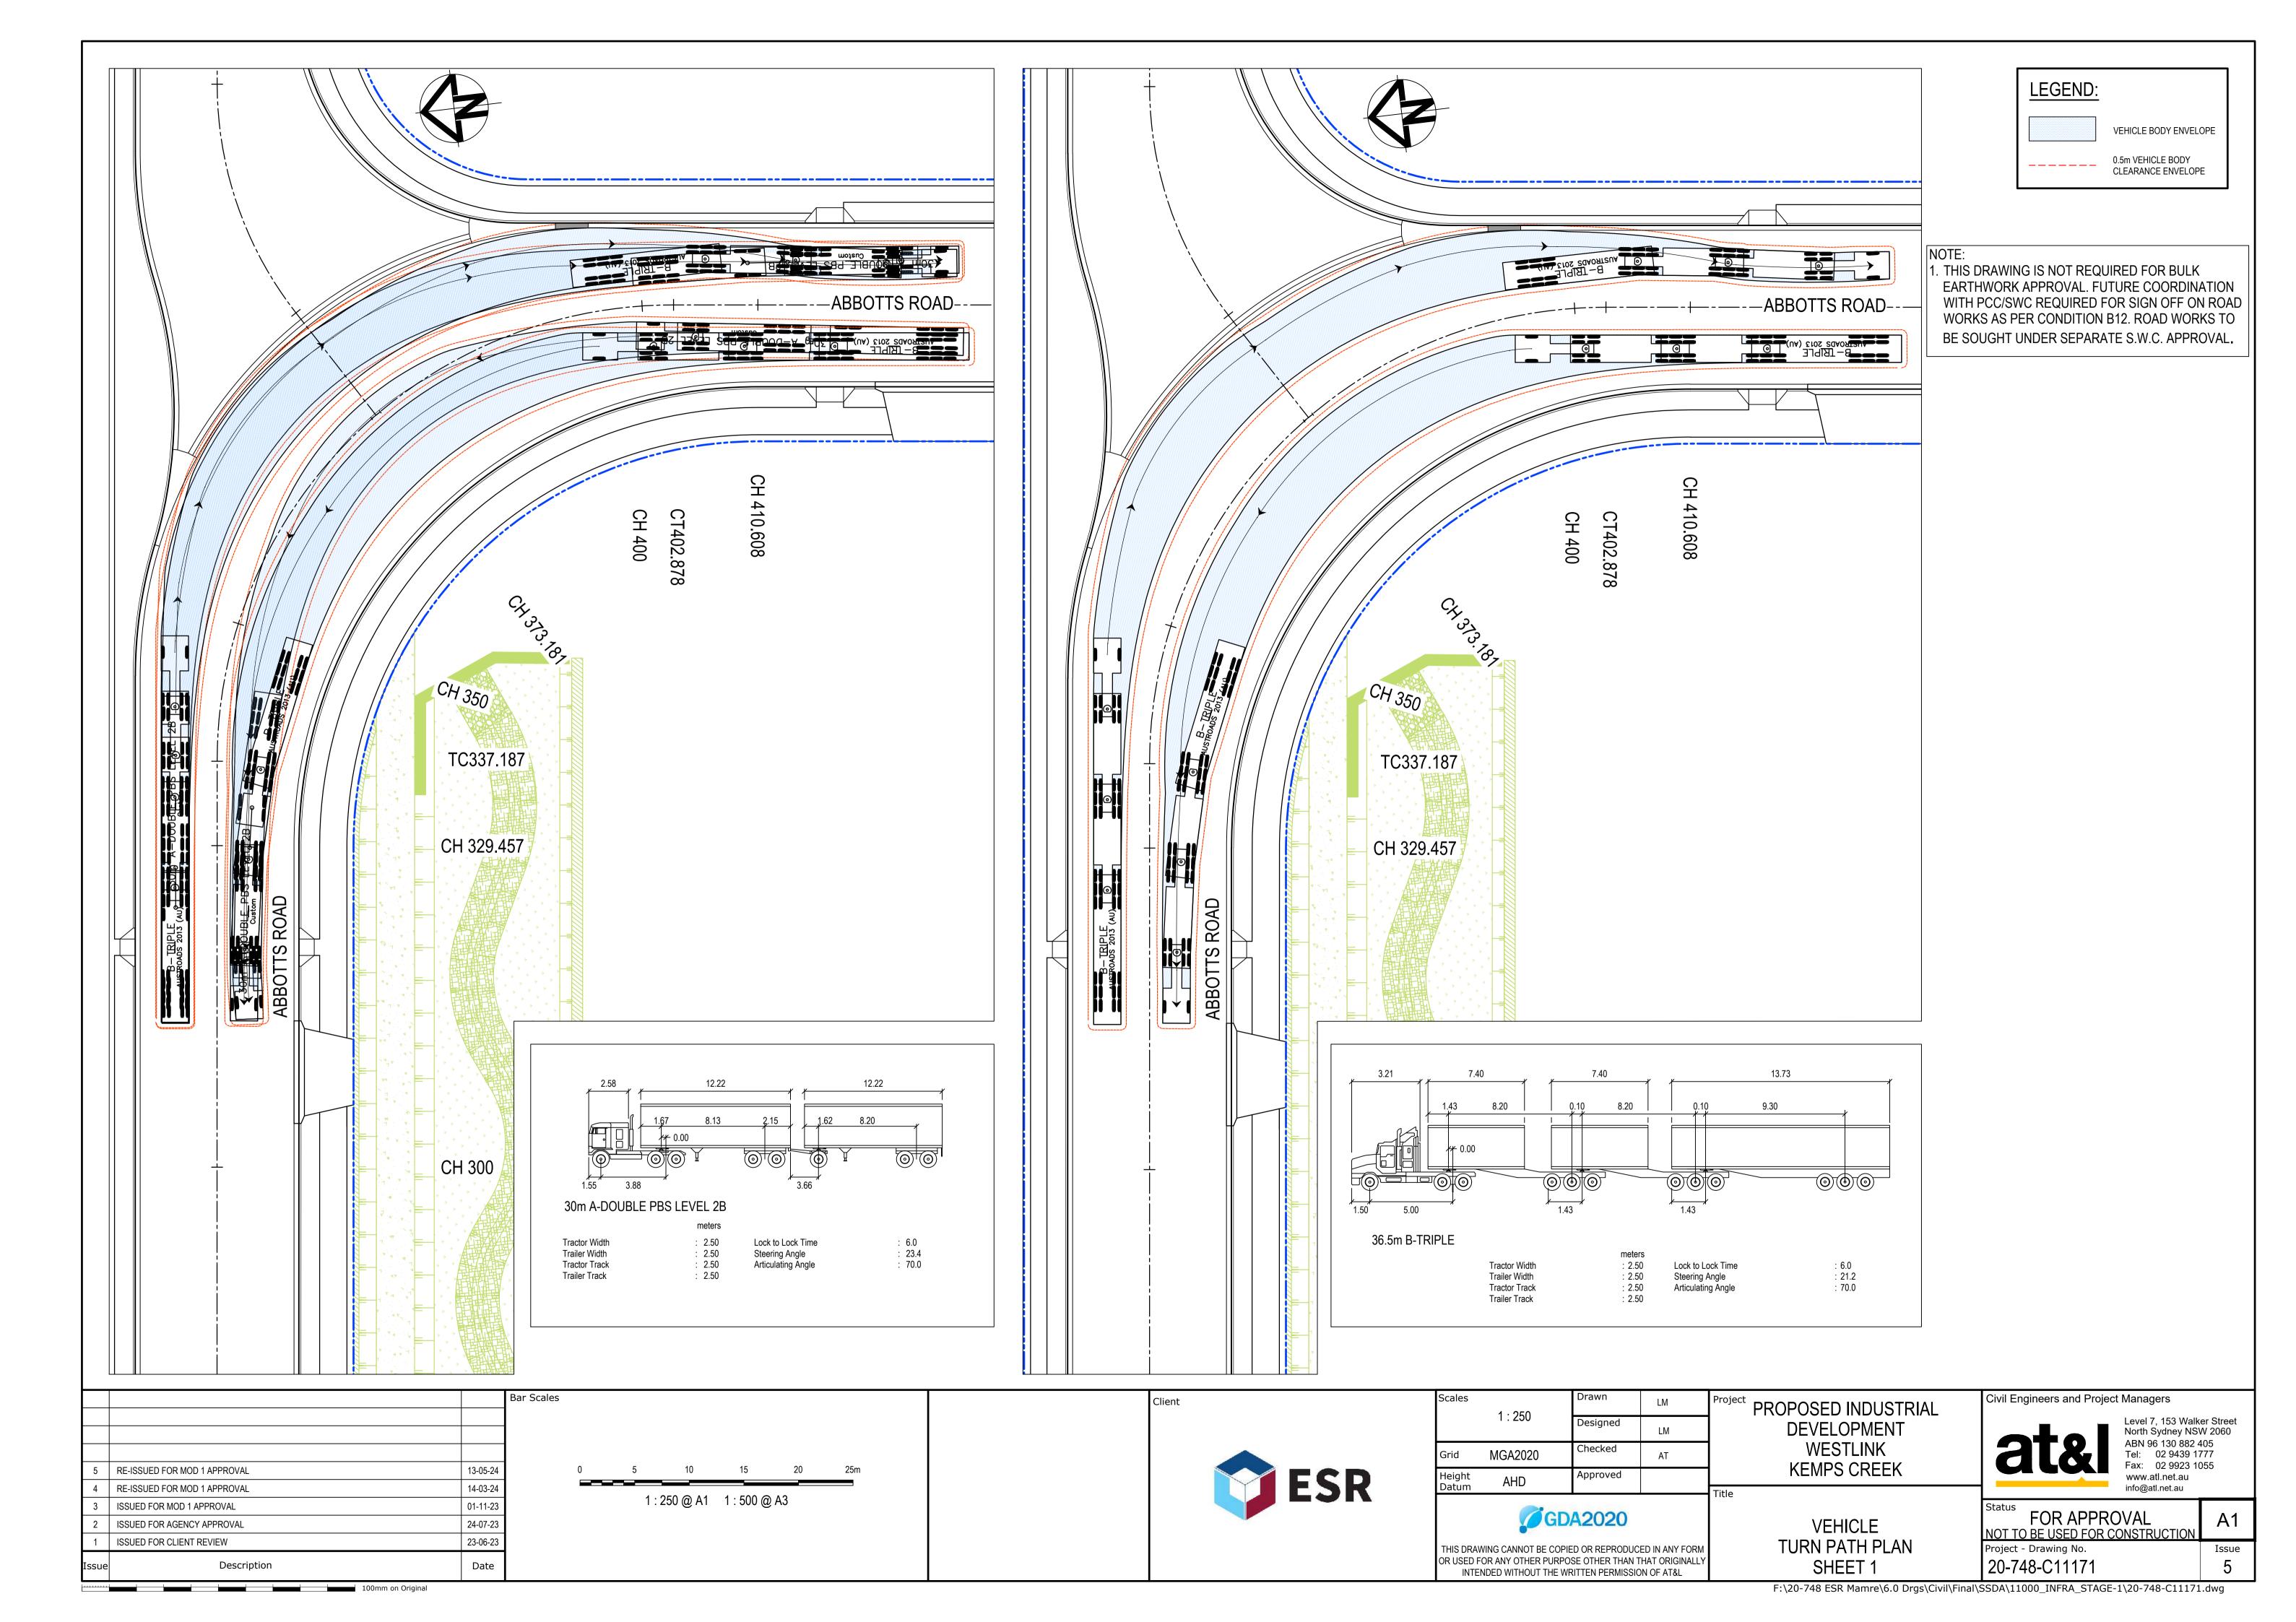


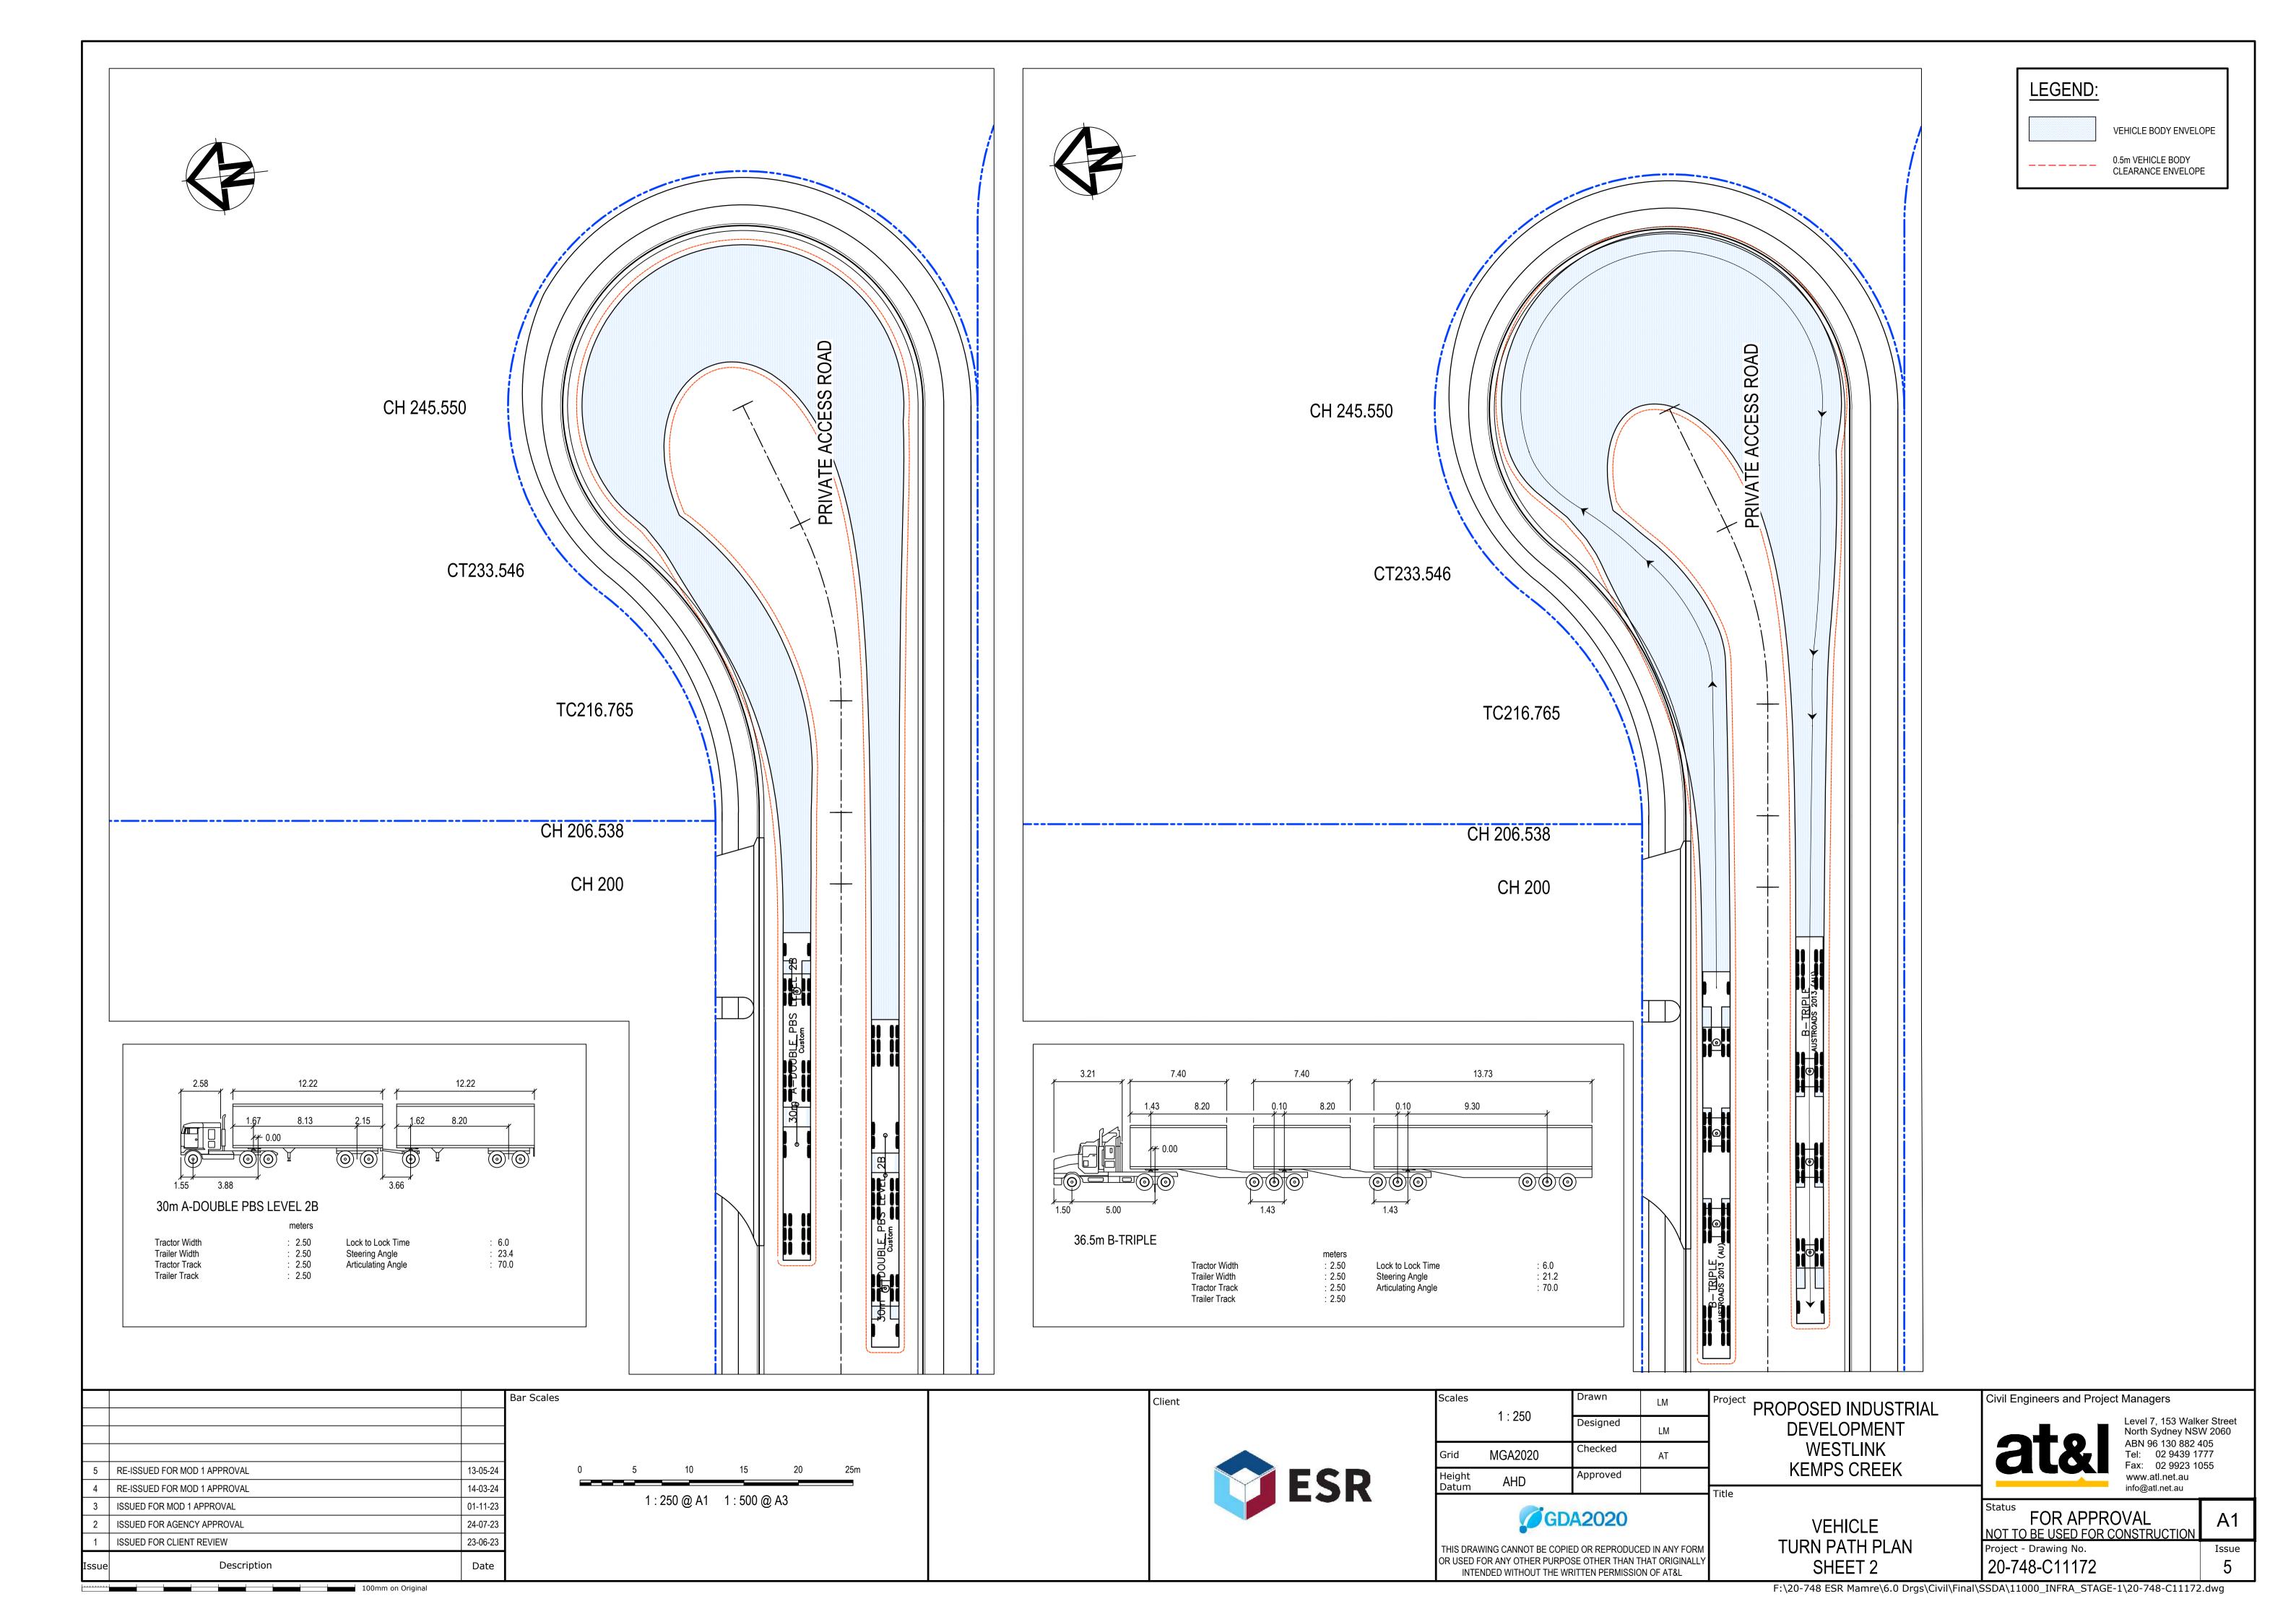


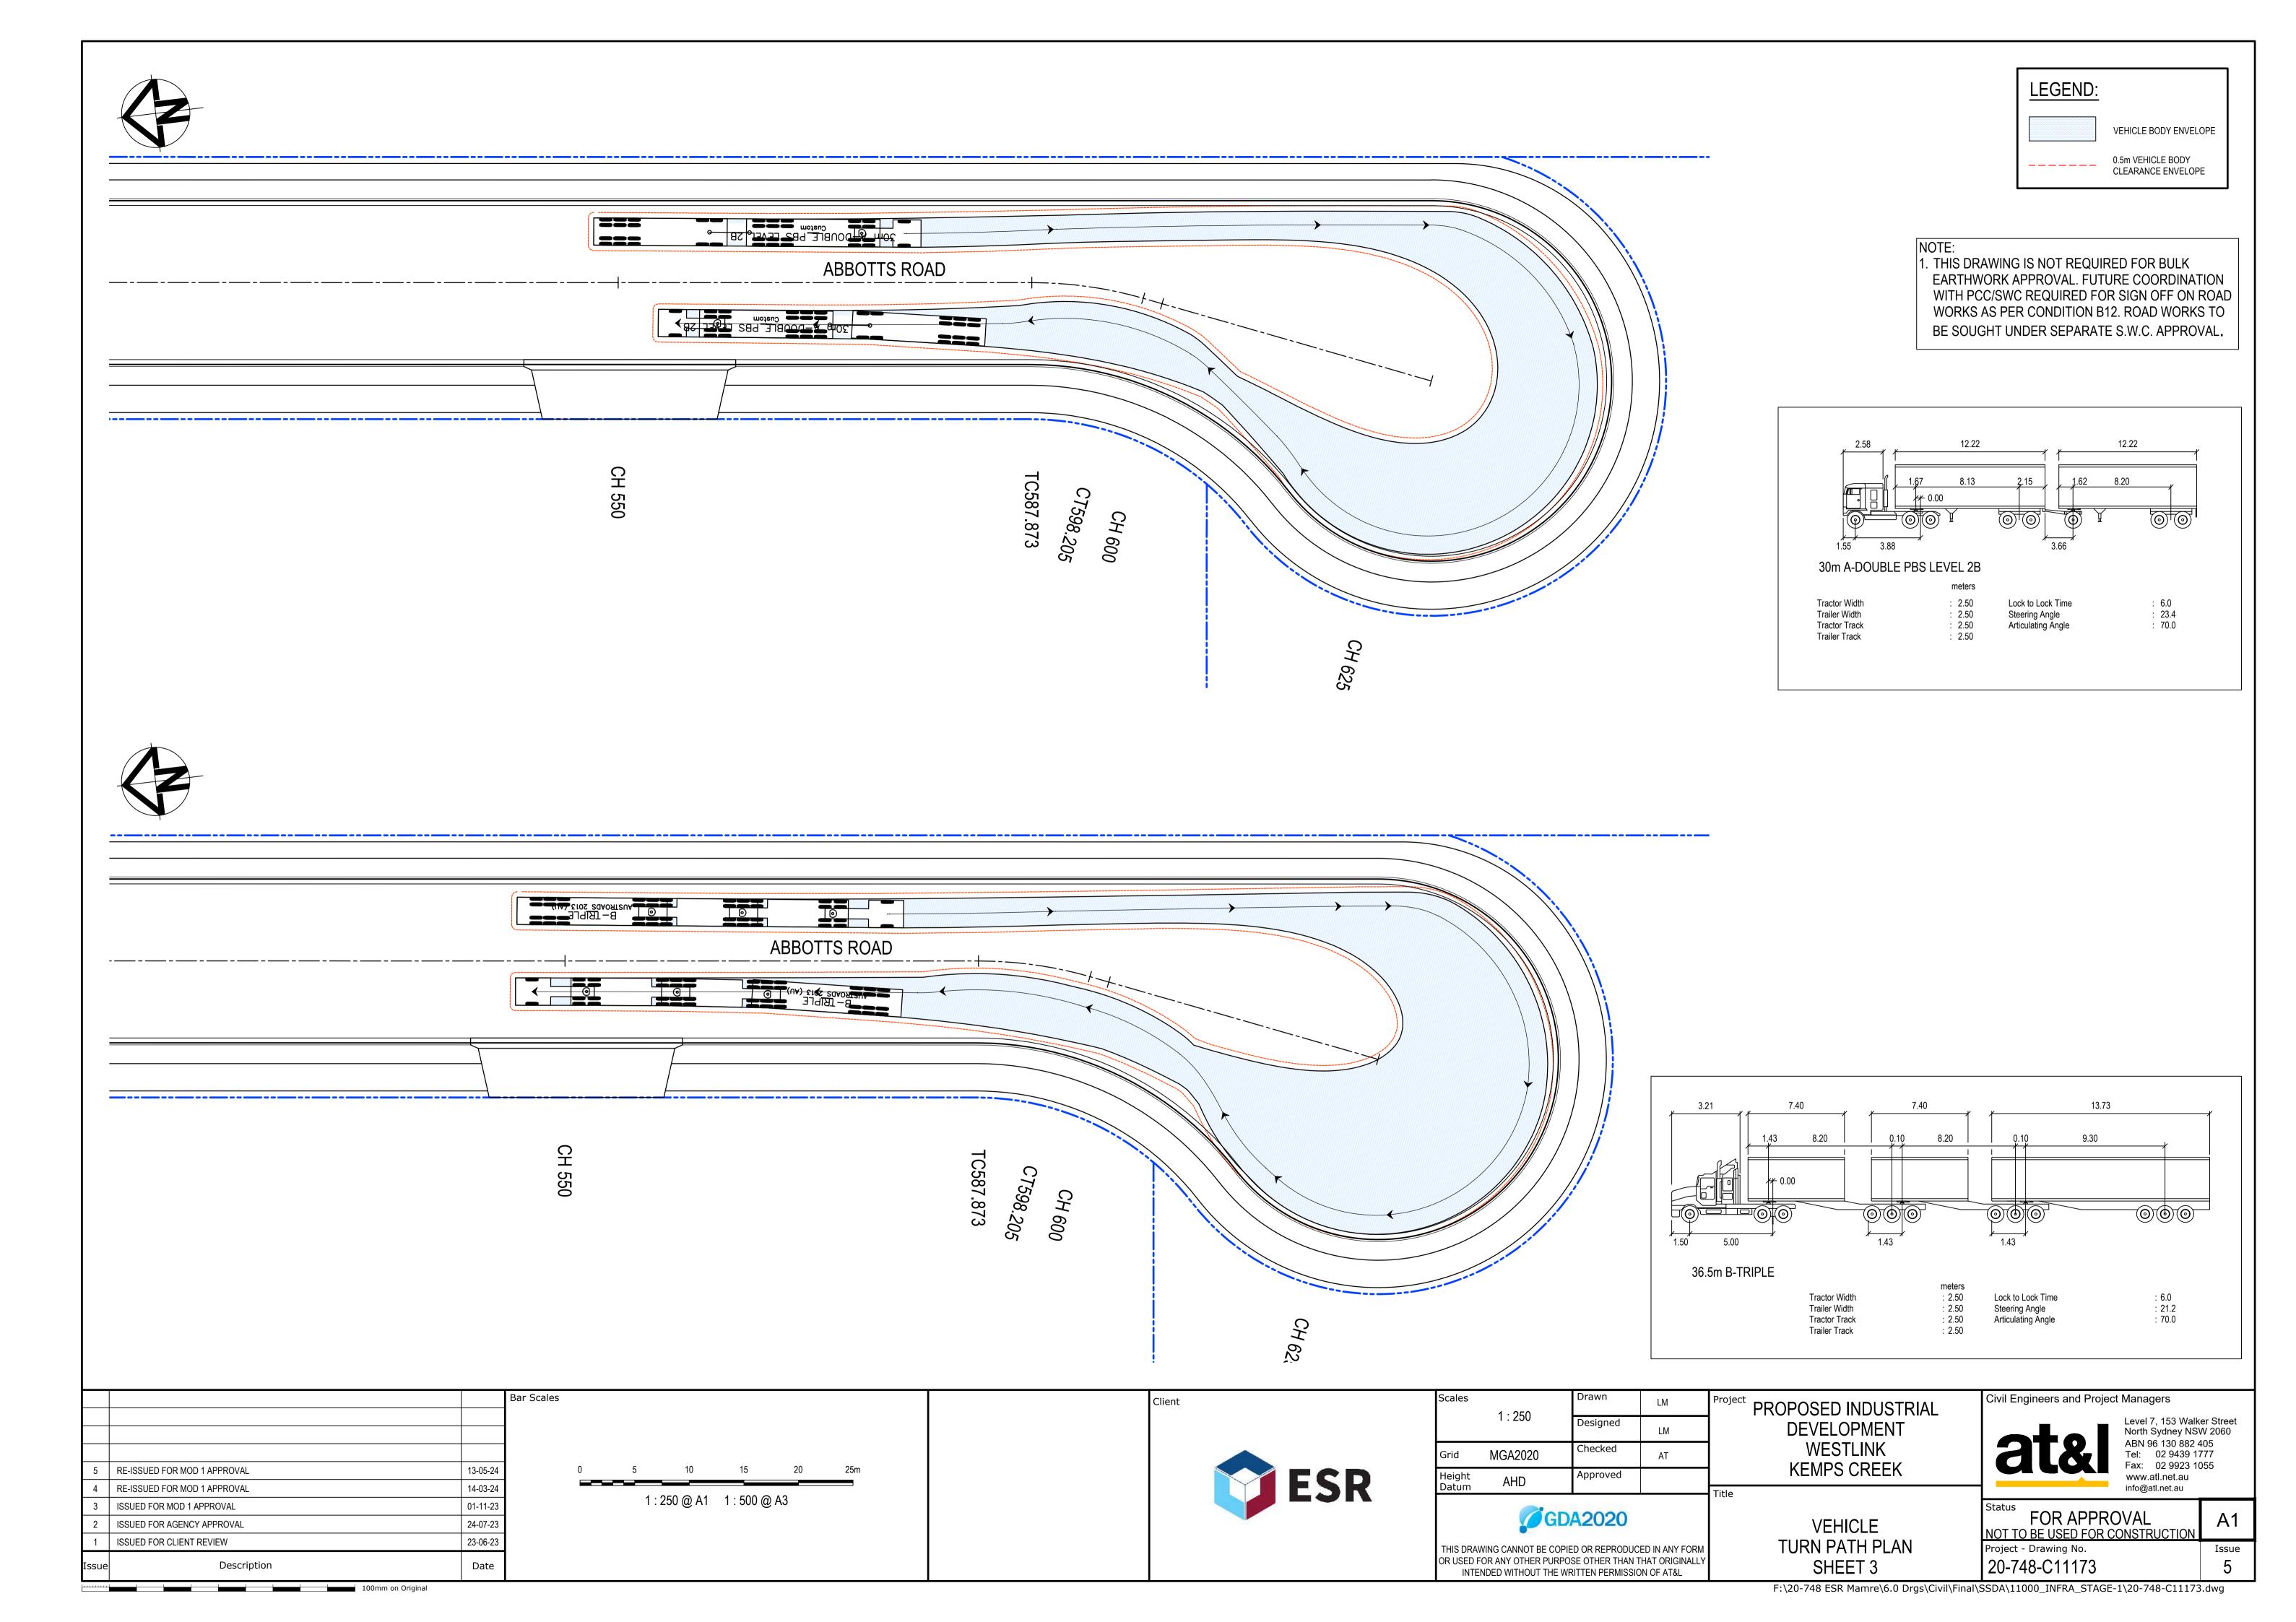


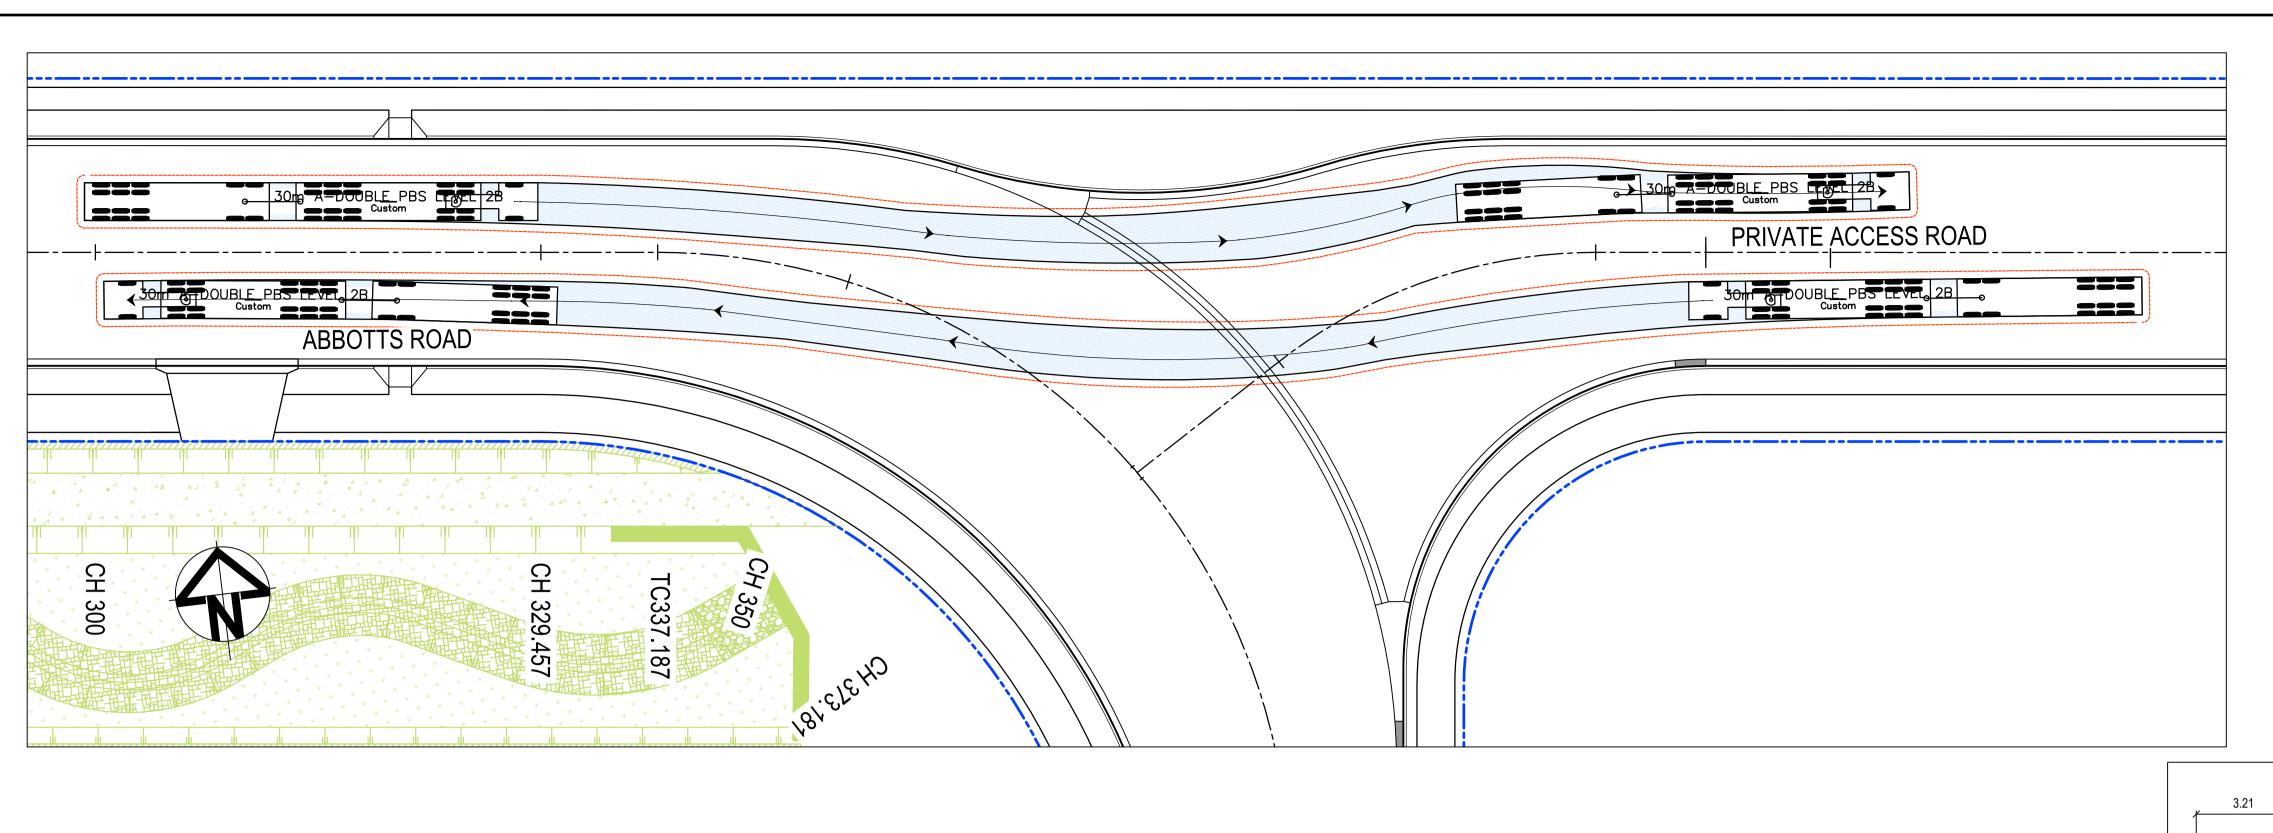

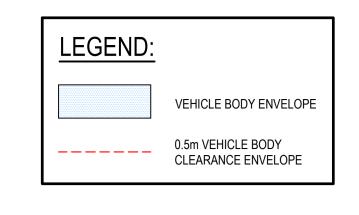

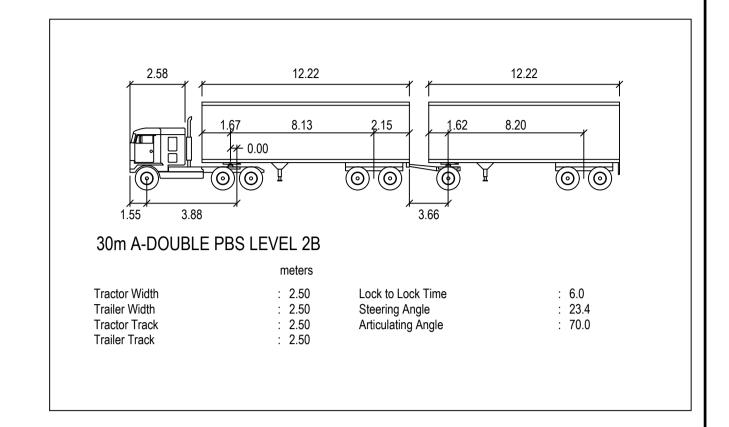

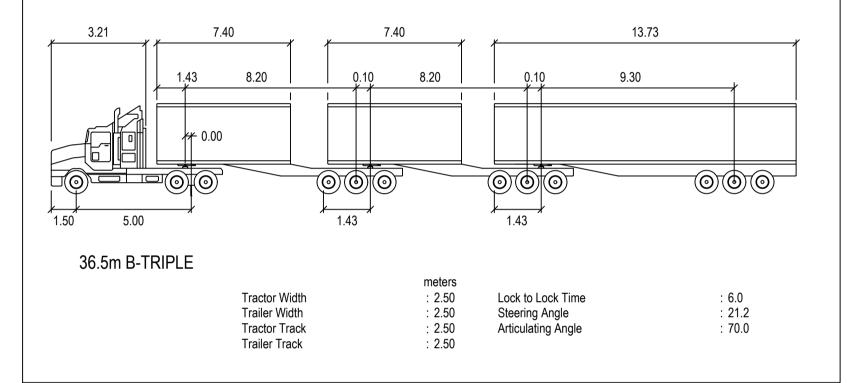

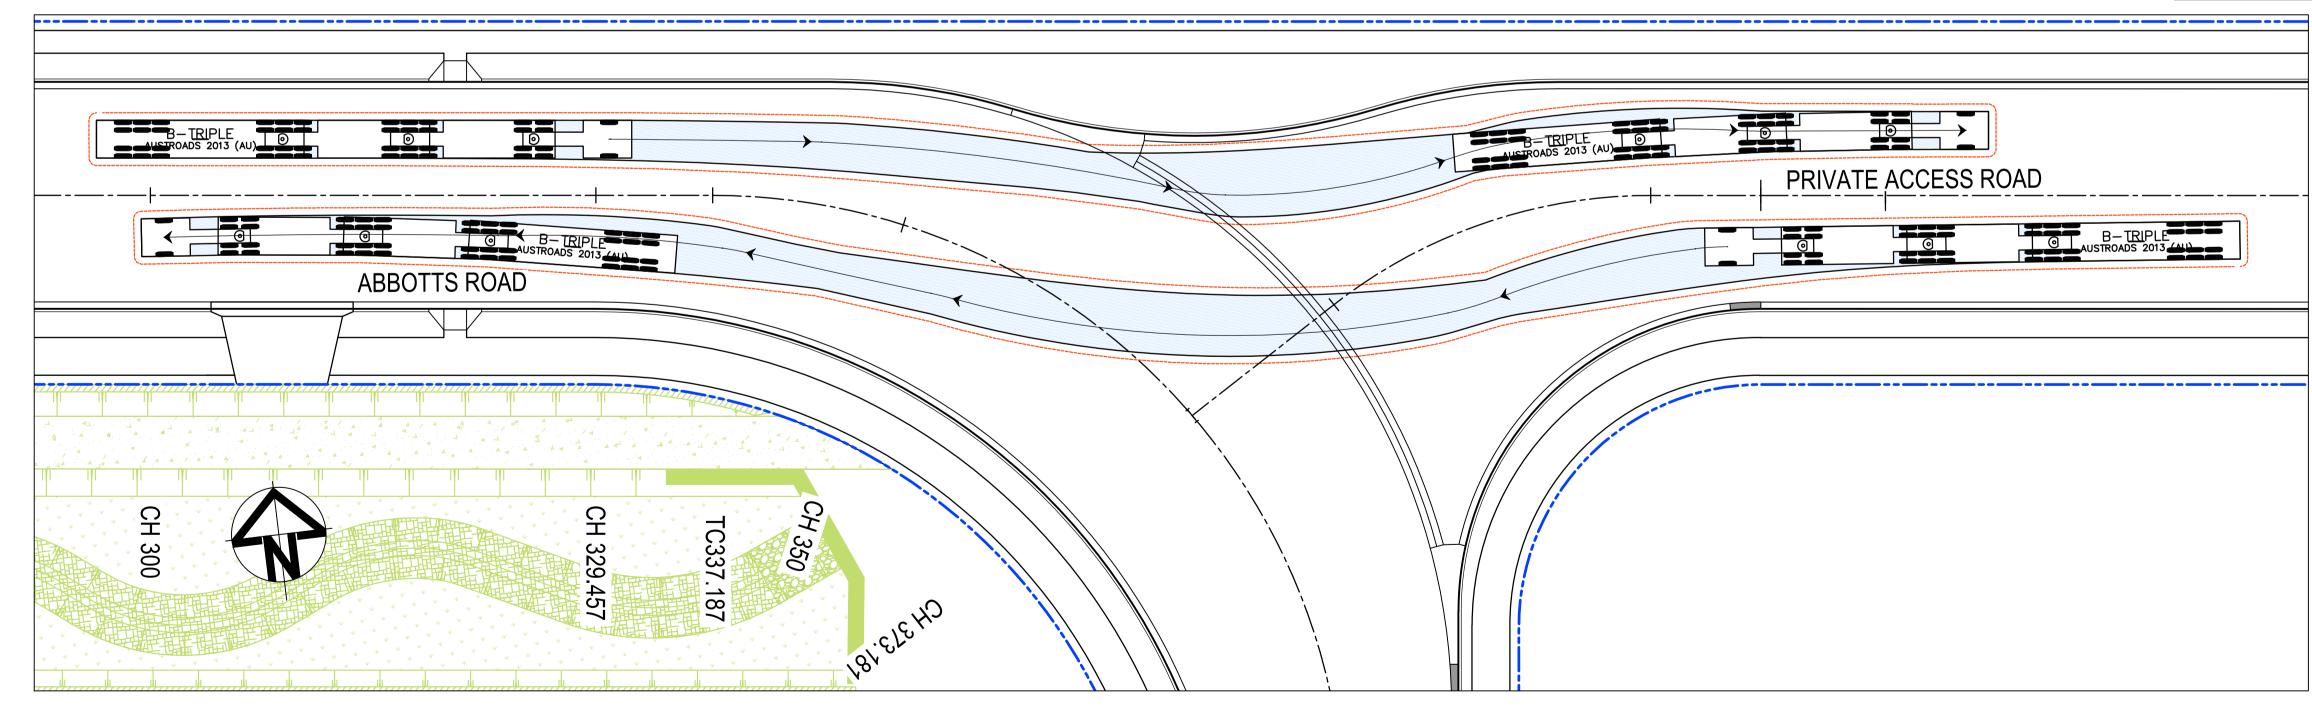

Client

NOTE:

1. THIS DRAWING IS NOT REQUIRED FOR BULK
EARTHWORK APPROVAL. FUTURE COORDINATION
WITH PCC/SWC REQUIRED FOR SIGN OFF ON ROAD
WORKS AS PER CONDITION B12. ROAD WORKS TO

BE SOUGHT UNDER SEPARATE S.W.C. APPROVAL.

RE-ISSUED FOR MOD 1 APPROVAL

RE-ISSUED FOR MOD 1 APPROVAL

ISSUED FOR MOD 1 APPROVAL

ISSUED FOR AGENCY APPROVAL

ISSUED FOR AGENCY APPROVAL

ISSUED FOR CLIENT REVIEW

23-06-23

Bar Scales

Date

Description

	Scales	1 : 250	Diawii	LM	ľ
	1 . 200		Designed	LM	
NAME OF THE PROPERTY OF THE PR	Grid	MGA2020	Checked	AT	
FSR	Height Datum	AHD	Approved		Ļ

GDA2020

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PROPOSED INDUSTRIAL
DEVELOPMENT
WESTLINK
KEMPS CREEK

VEHICLE TURN PATH PLAN SHEET 4 Civil Engineers and Project Managers


Level 7, 153
North Sydne
ABN 96 130
Tel: 02 94
Fax: 02 98
www.atl.net.


ABN 96 130 882 405
Tel: 02 9439 1777
Fax: 02 9923 1055
www.atl.net.au
info@atl.net.au


Level 7, 153 Walker Street North Sydney NSW 2060

FOR APPROVAL A1
NOT TO BE USED FOR CONSTRUCTION


Project - Drawing No. Issue
20-748-C11174 5

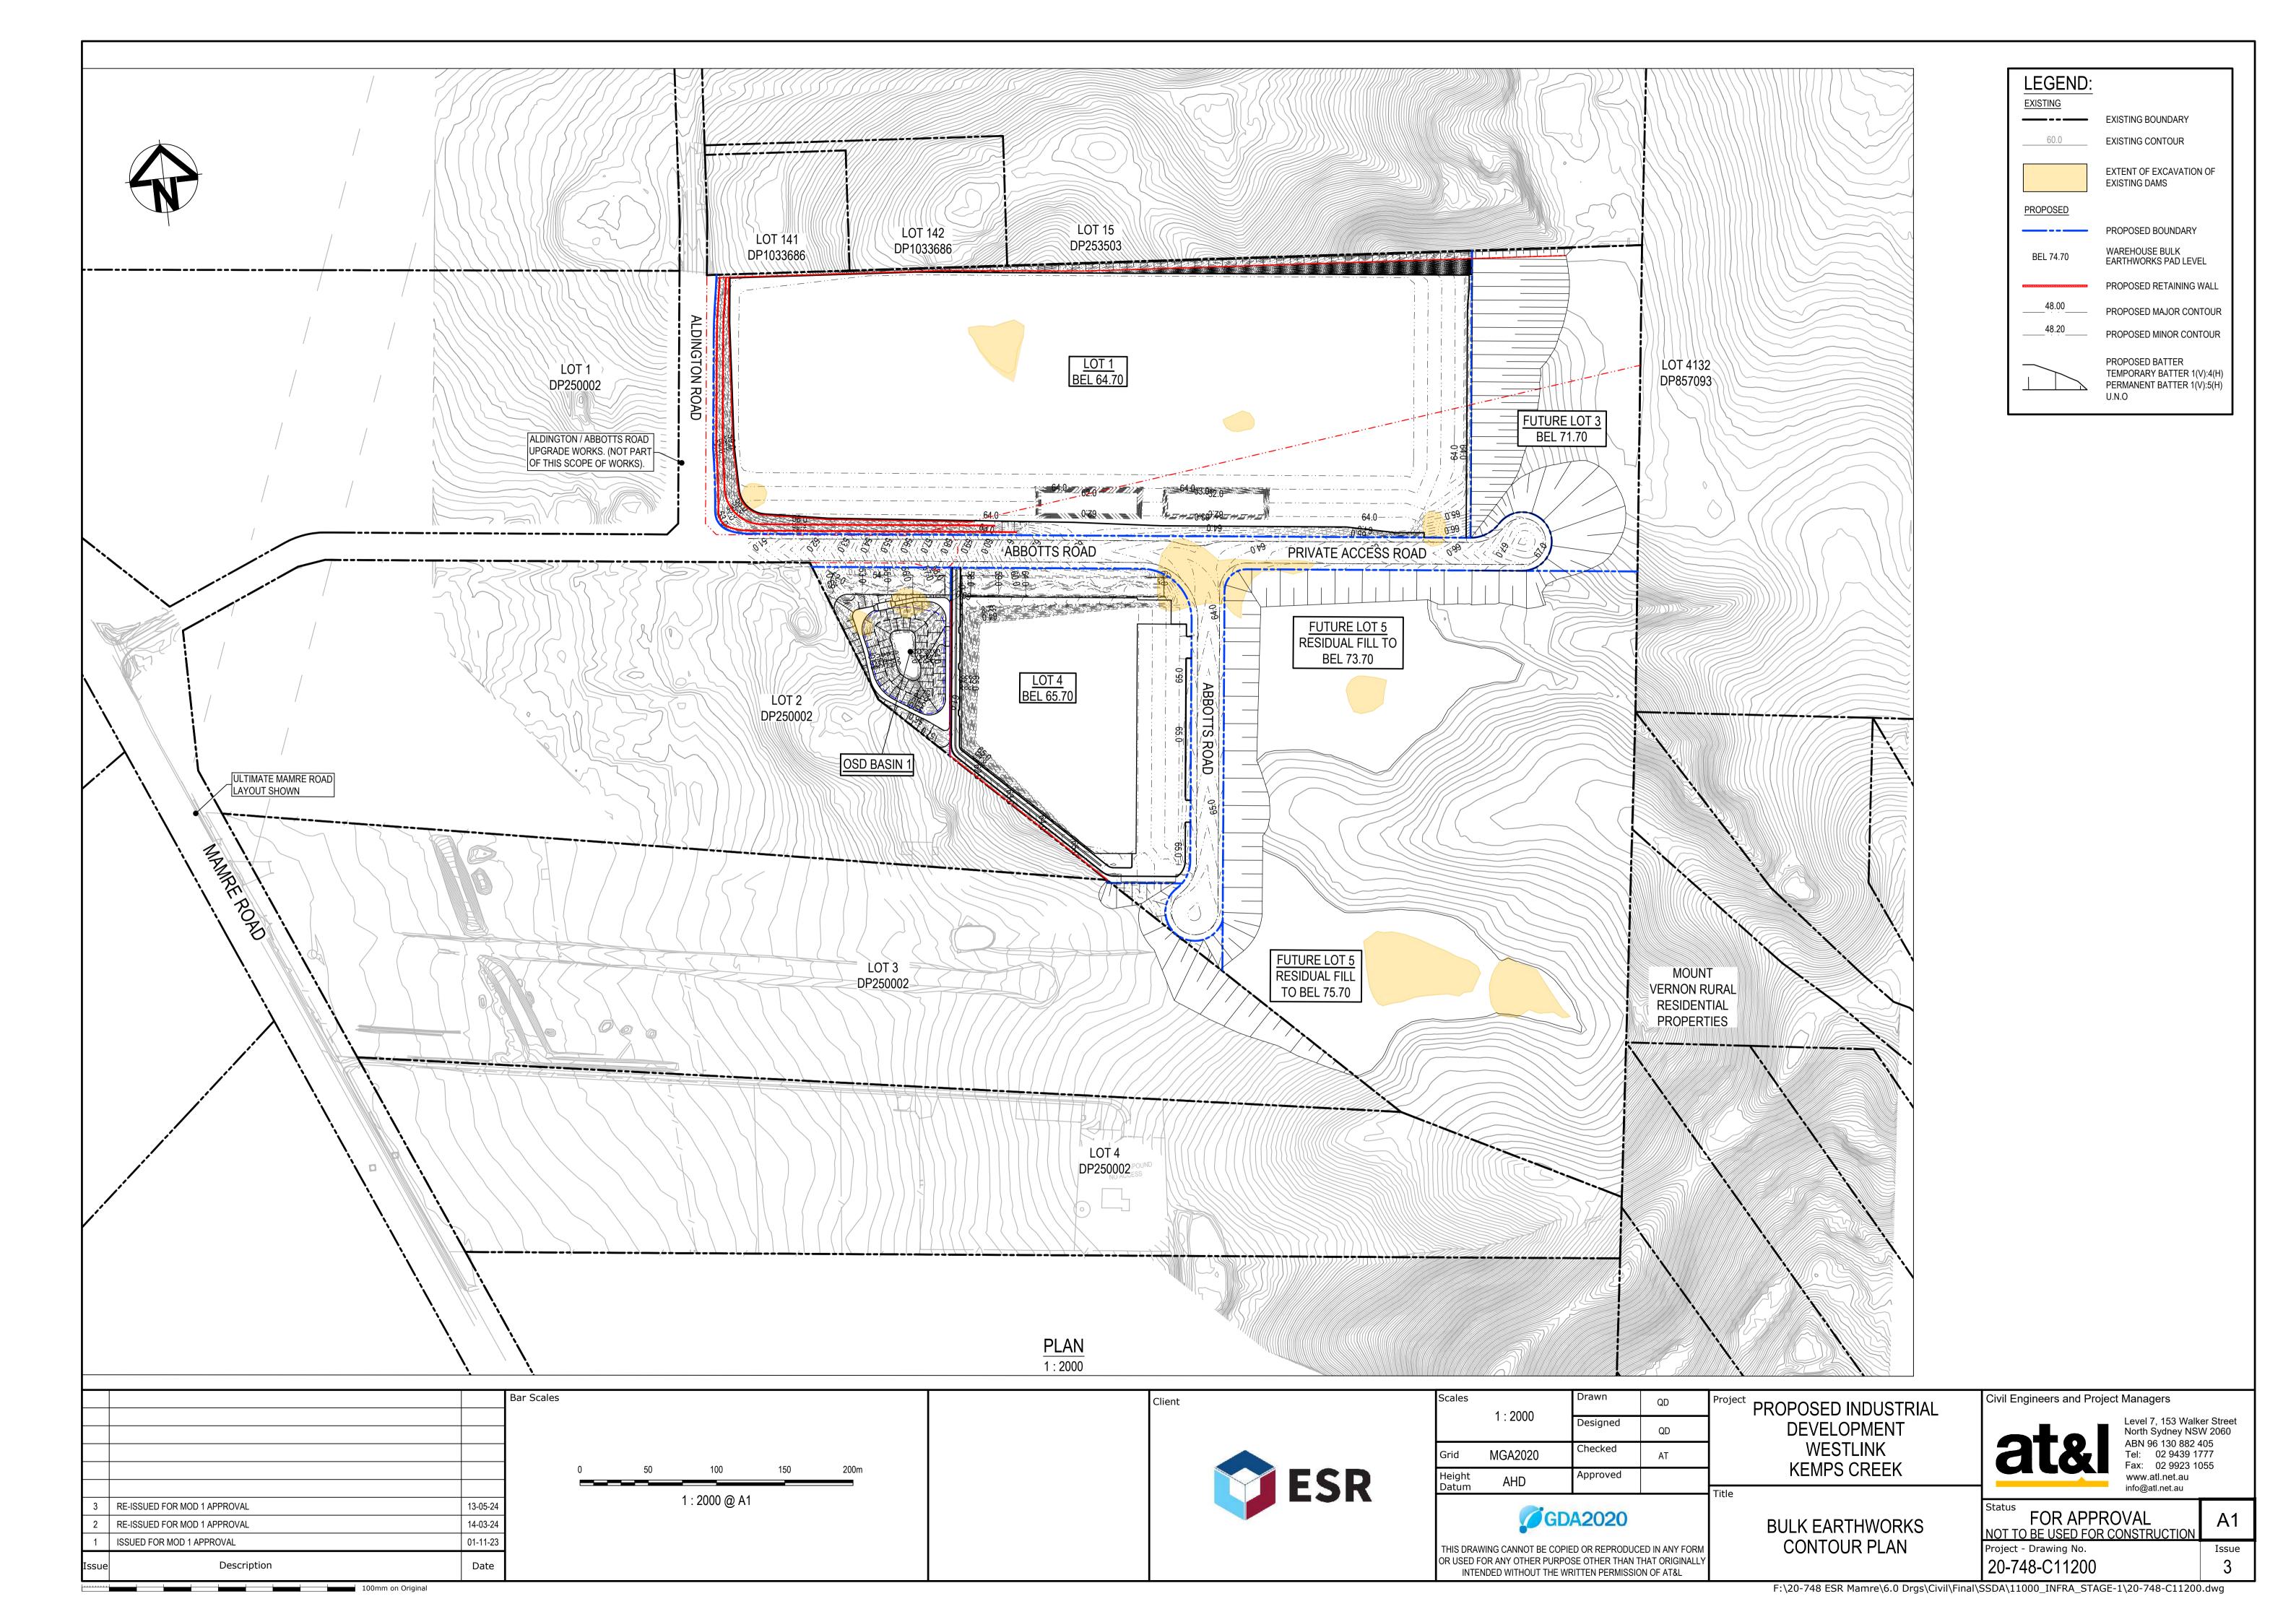

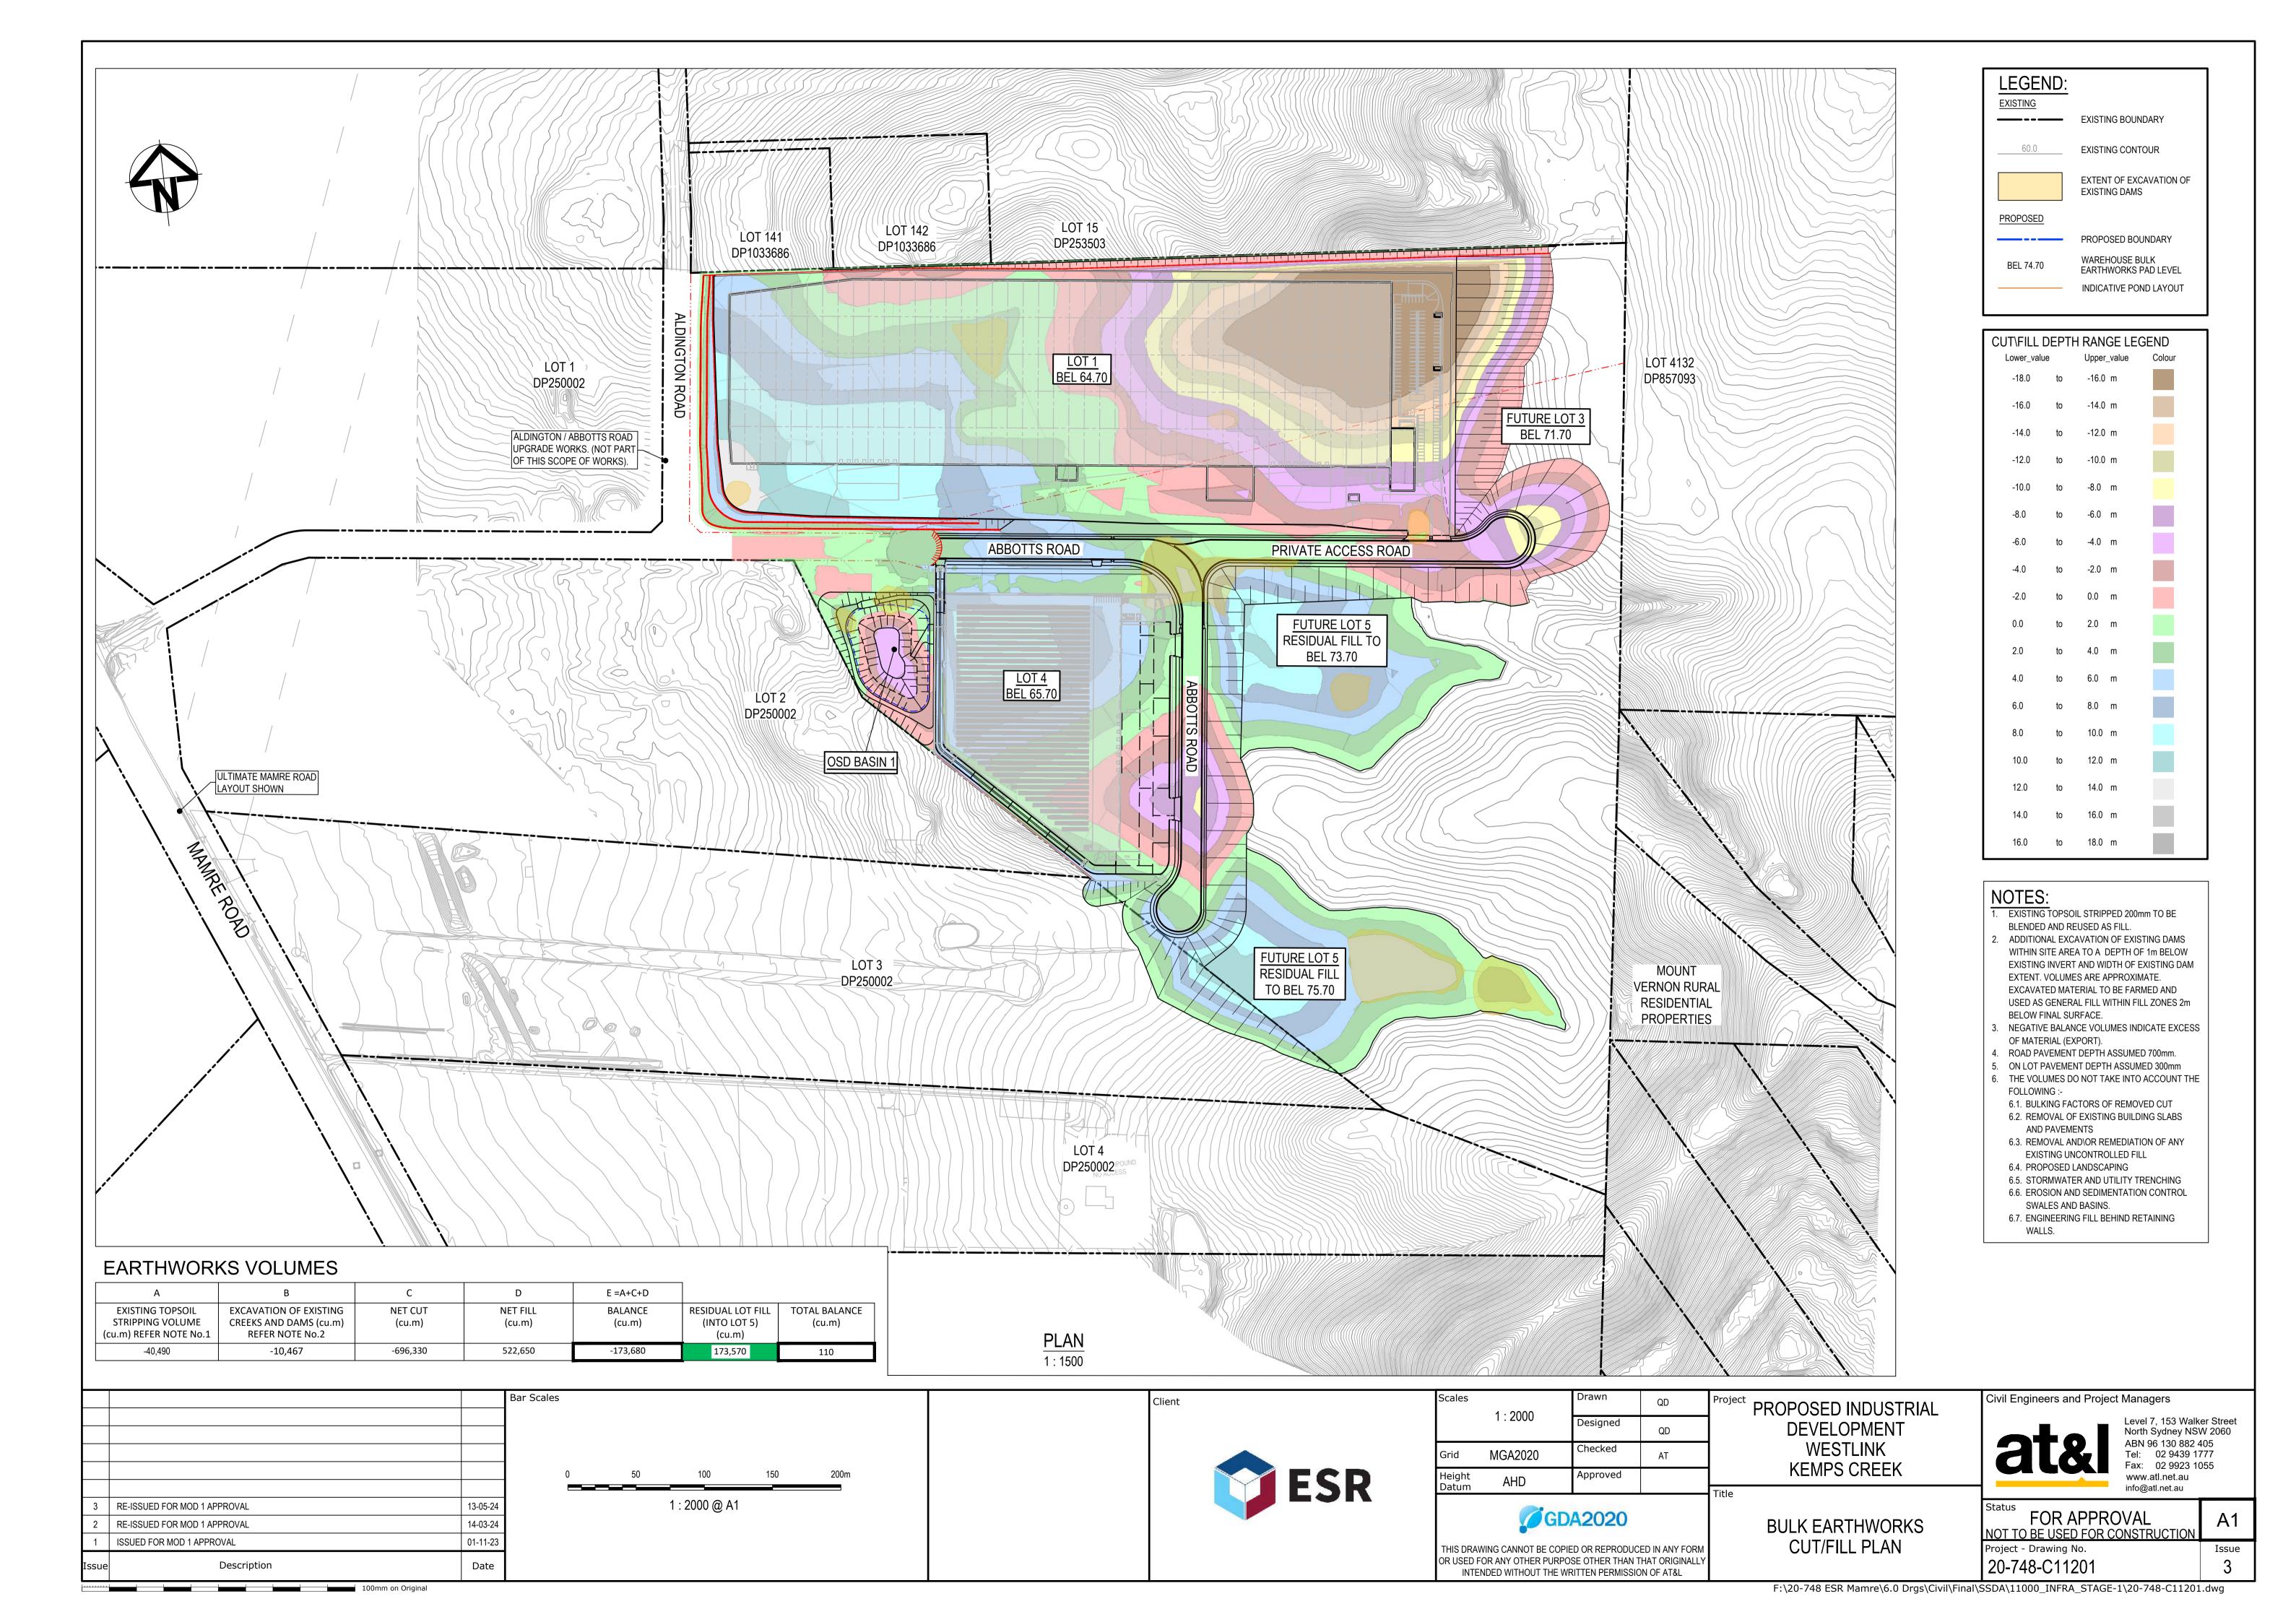

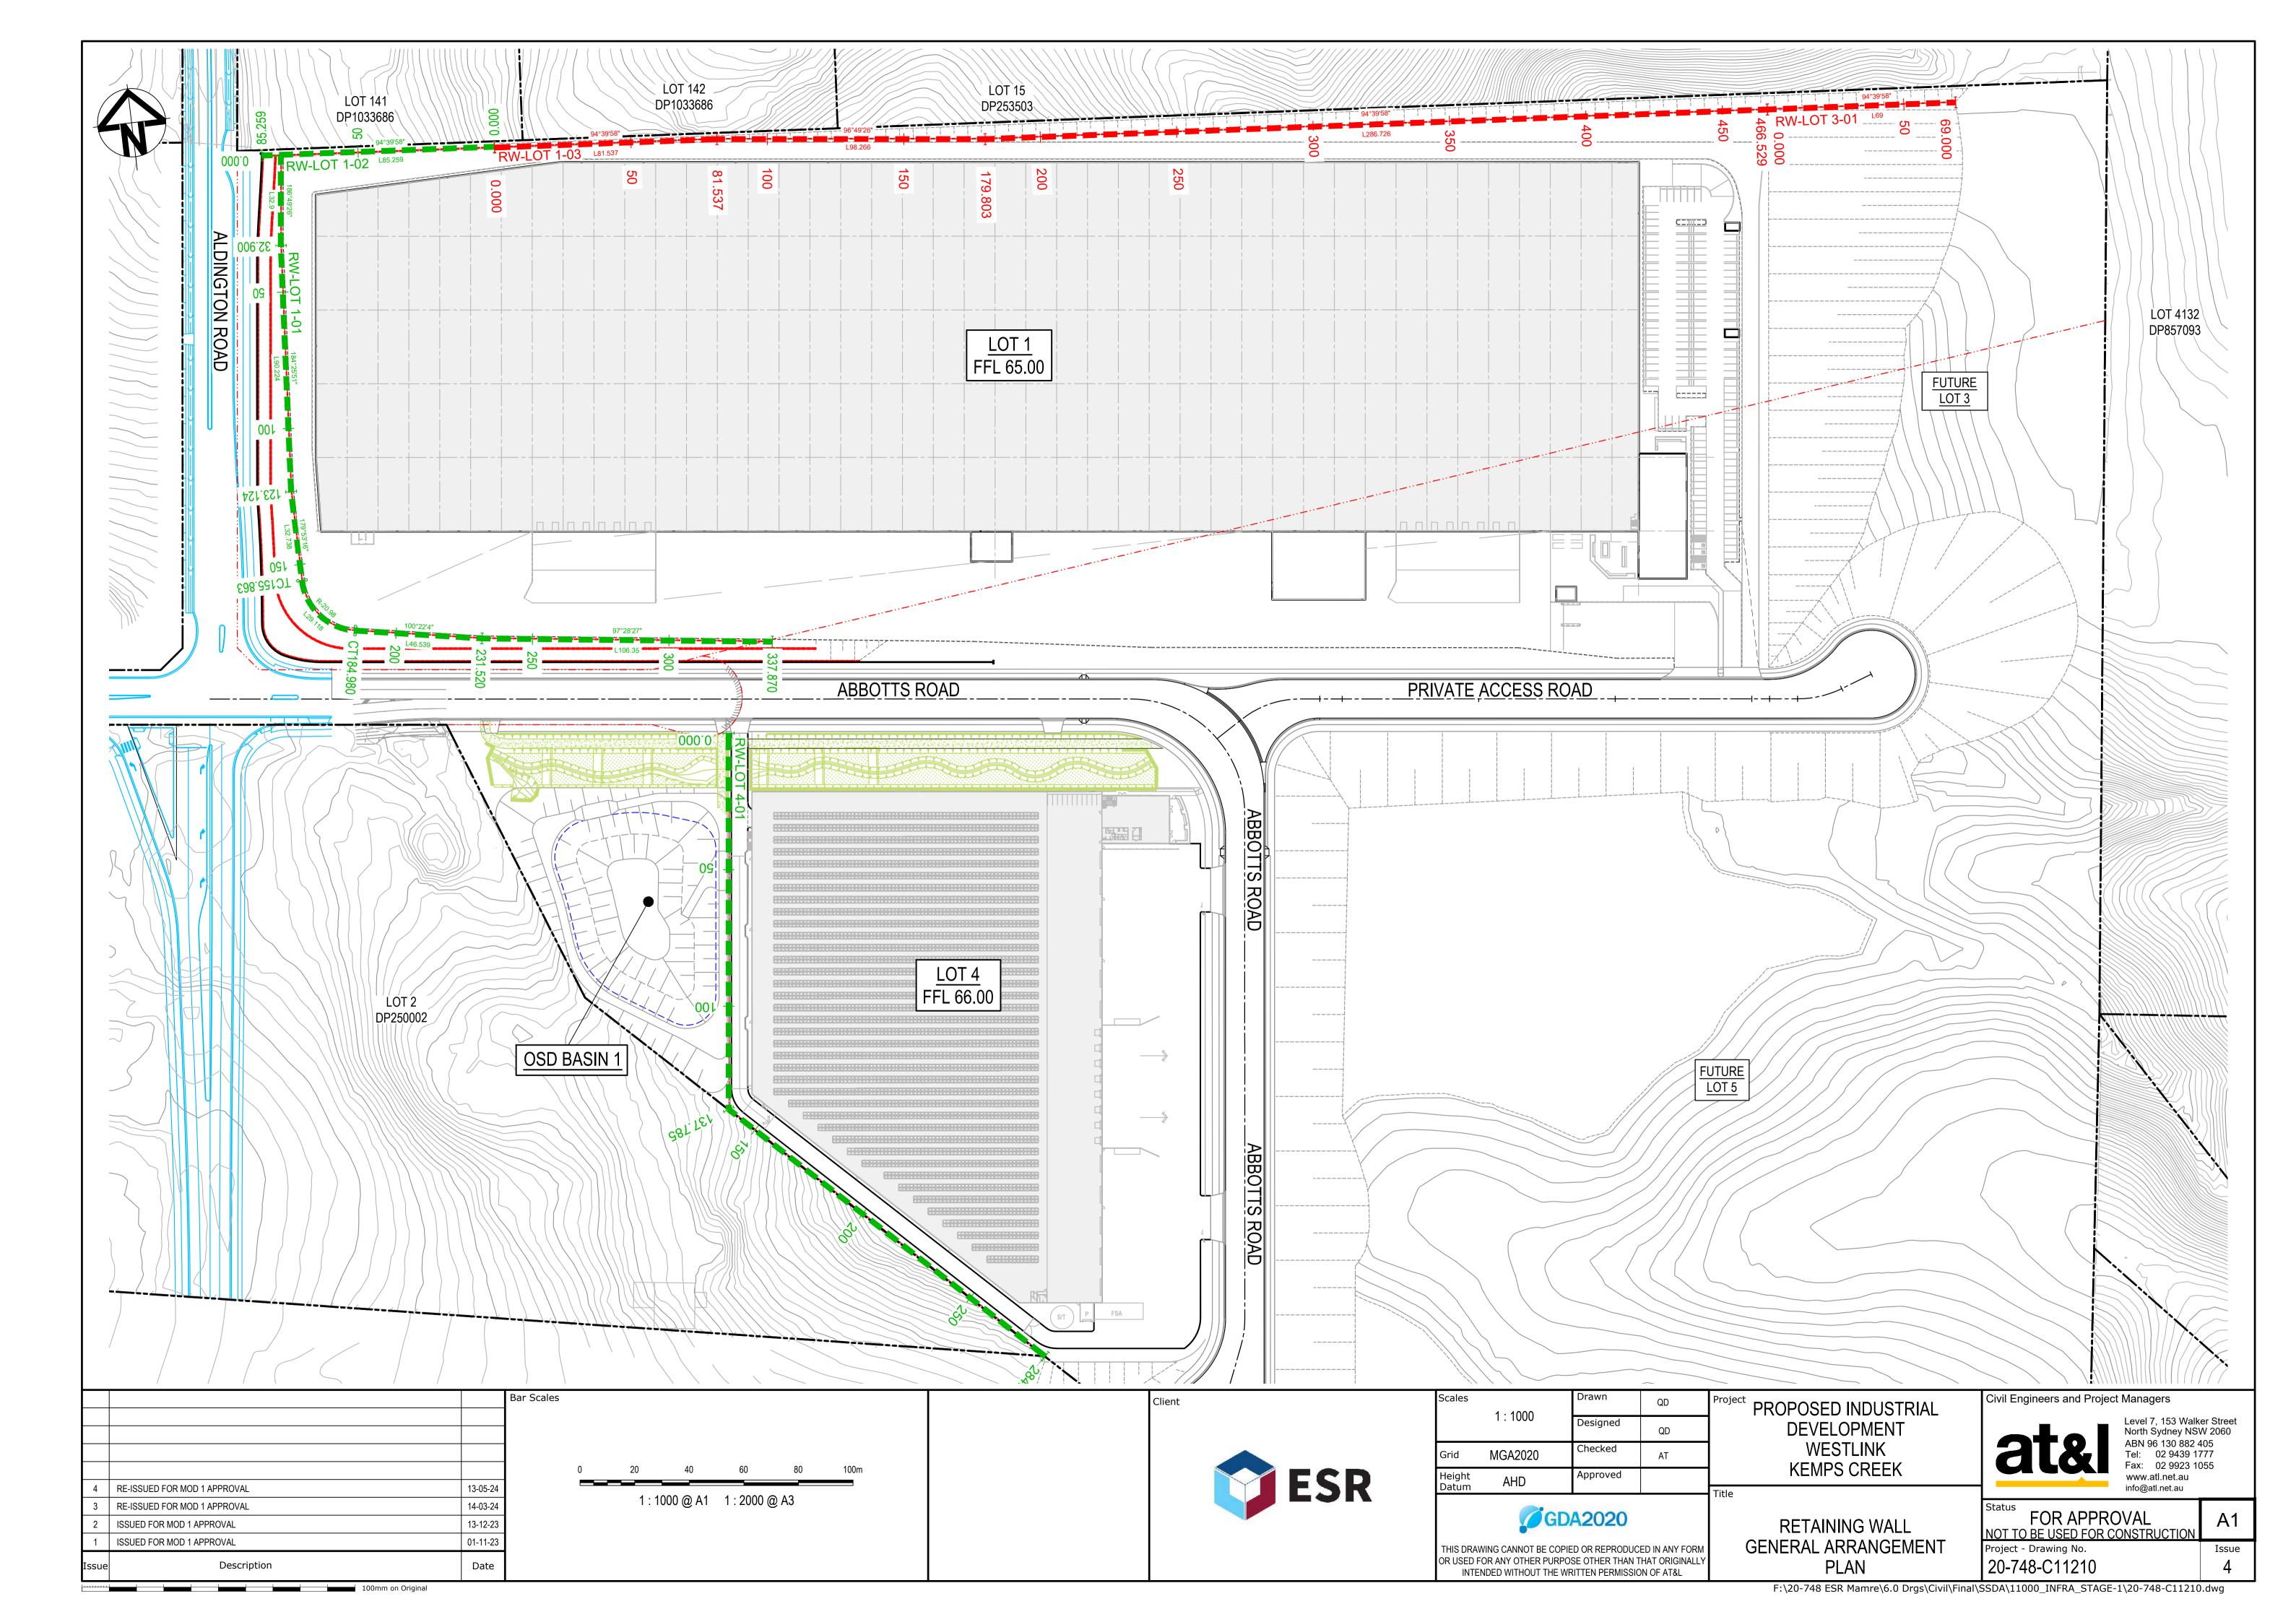



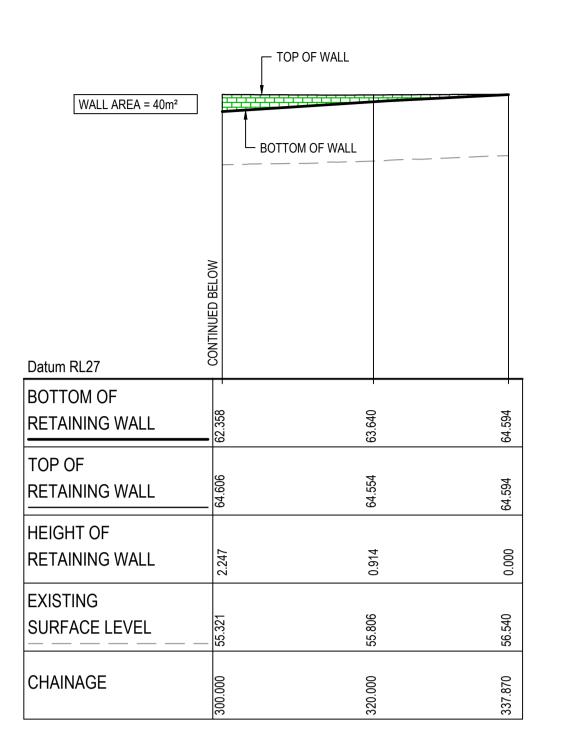

Datum RL31

BOTTOM OF RETAINING WALL

TOP OF RETAINING WALL

HEIGHT OF RETAINING WALL

HEIGHT OF RETAINING WALL

EXISTING

SURFACE LEVEL

CHAINAGE

OR OF OR OTHER OR OF OR OTHER OR OF OR OTHER OR OT

PROPOSED SURFACE LEVEL. TOP OF WALL

TOP OF WALL

EXISTING/PROPOSED SURFACE LEVEL

NOTE:

FEATURE WALL CONCEPT.

RETAINING WALL PROFILE IS INDICATIVE ONLY, REFER TO LANDSCAPE DRAWINGS FOR ENTRY


BOTTOM OF WALL

<u>SECTION</u> 1 : 50

RETAINING WALL (RW-LOT 1-01) PROFILE (CONTINUED) SCALE 1:500 HORI. 1:500 VERT.

100mm on Original


RETAINING WALL (RW-LOT 1-02) PROFILE SCALE 1:500 HORI. 1:500 VERT.

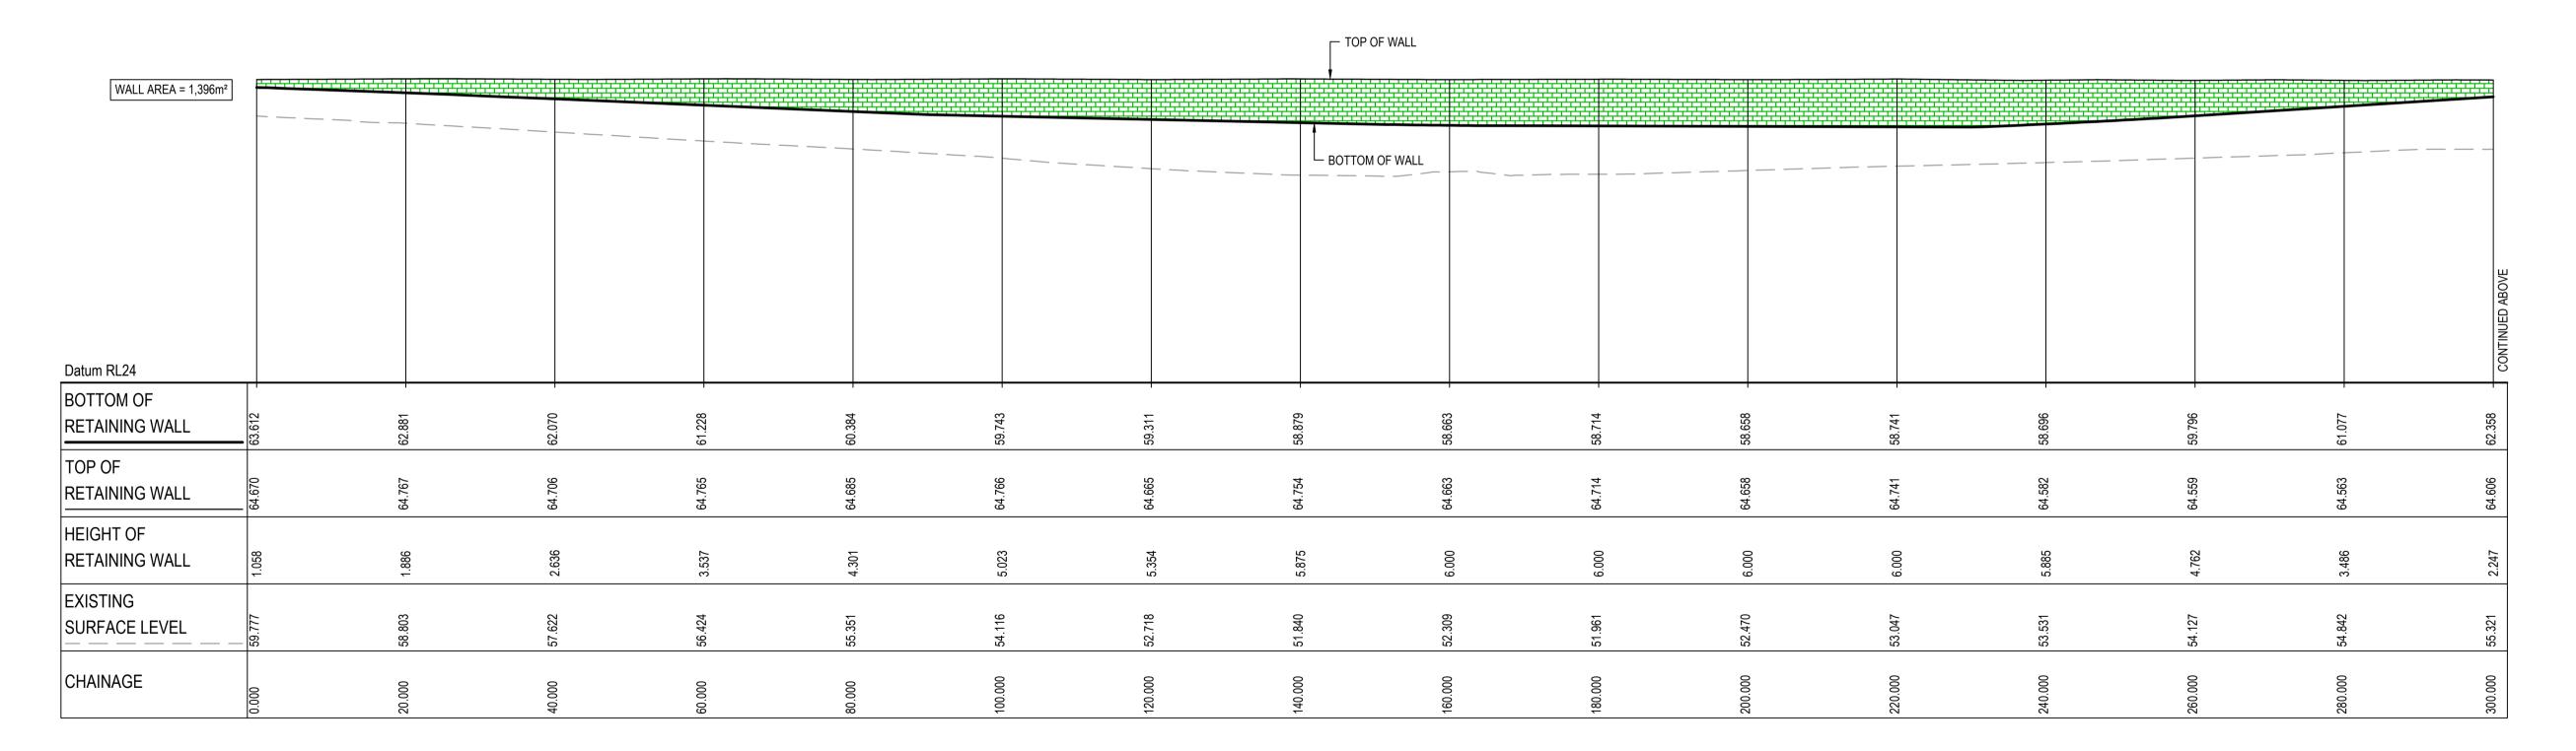


RETAINING WALL (RW-LOT 1-01) PROFILE SCALE 1:500 HORI.

						_		
	Bar Scales	Client	Scales 1 : 500 V	Drawn	QD	Project PROPOSED INDUSTRIAL	Civil Engineers and Project Managers	
			1 : 500 H	Designed	QD	DEVELOPMENT	Level 7, 153 Walk North Sydney NSV	SW 2060
			Grid MGA2020	Checked	AT	WESTLINK	ABN 96 130 882 4 Tel: 02 9439 17 Fax: 02 9923 10	1777
	0 10 20 30 40 50m	FSR	Height Datum AHD	Approved		KEMPS CREEK	www.atl.net.au info@atl.net.au	
3 RE-ISSUED FOR MOD 1 APPROVAL 13-05-24	1 : 500 @ A1 1 : 1000 @ A3	LJK		D40000		Title	Status FOD ADDDOV/AL	
2 RE-ISSUED FOR MOD 1 APPROVAL 14-03-24			G	DA2020		RETAINING WALL	FOR APPROVAL NOT TO BE USED FOR CONSTRUCTION	A1
1 ISSUED FOR MOD 1 APPROVAL 01-11-23			THIS DRAWING CANNOT BE CO	OPIED OR REPRODU	ICED IN ANY FORM	PROFILES	Project - Drawing No.	Issue
Issue Description Date			OR USED FOR ANY OTHER PUR INTENDED WITHOUT THE			SHEET 1	20-748-C11211	3


ALL FINISHED LEVELS ARE ±1000mm U.N.O REFER TO DRG C11211 FOR TYPICAL WALL SECTION

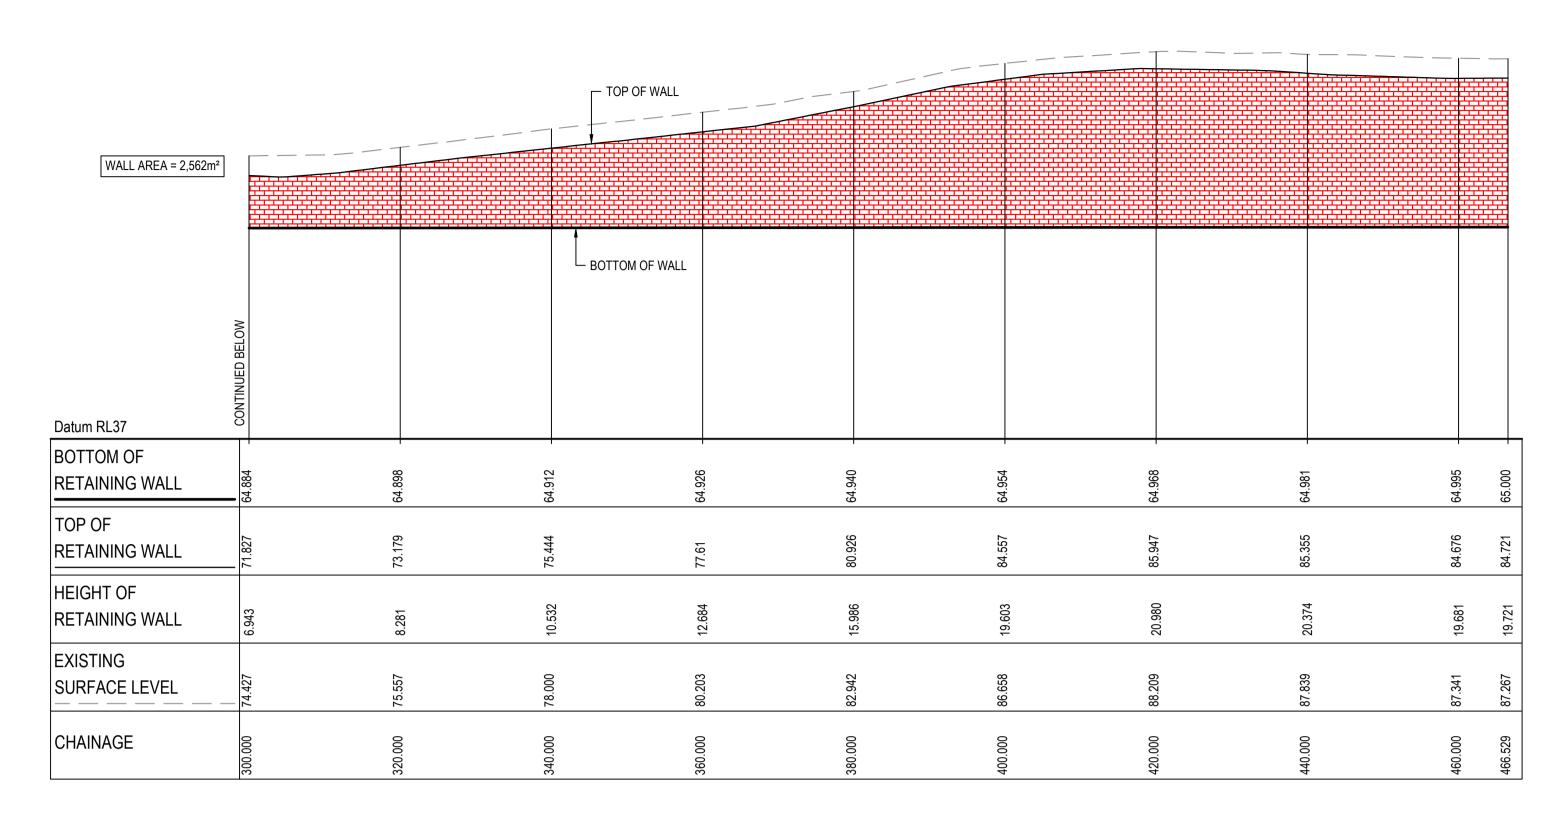

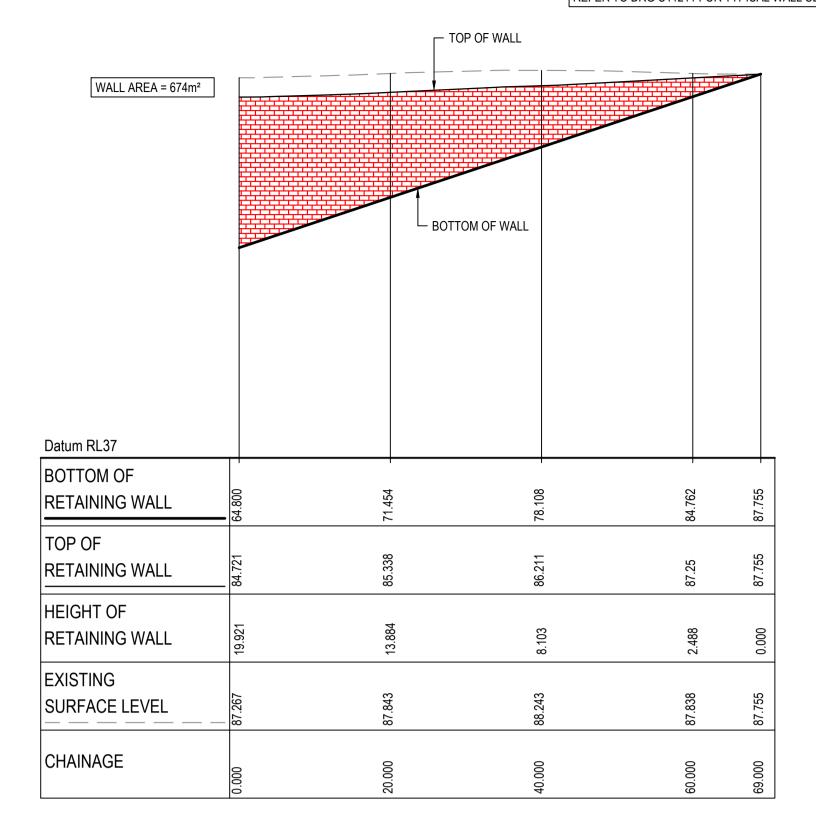

RETAINING WALL (RW-LOT 1-03) PROFILE (CONTINUED) 1:500 VERT.

RETAINING WALL (RW-LOT 3-01) PROFILE SCALE 1:500 HORI. 1:500 VERT.

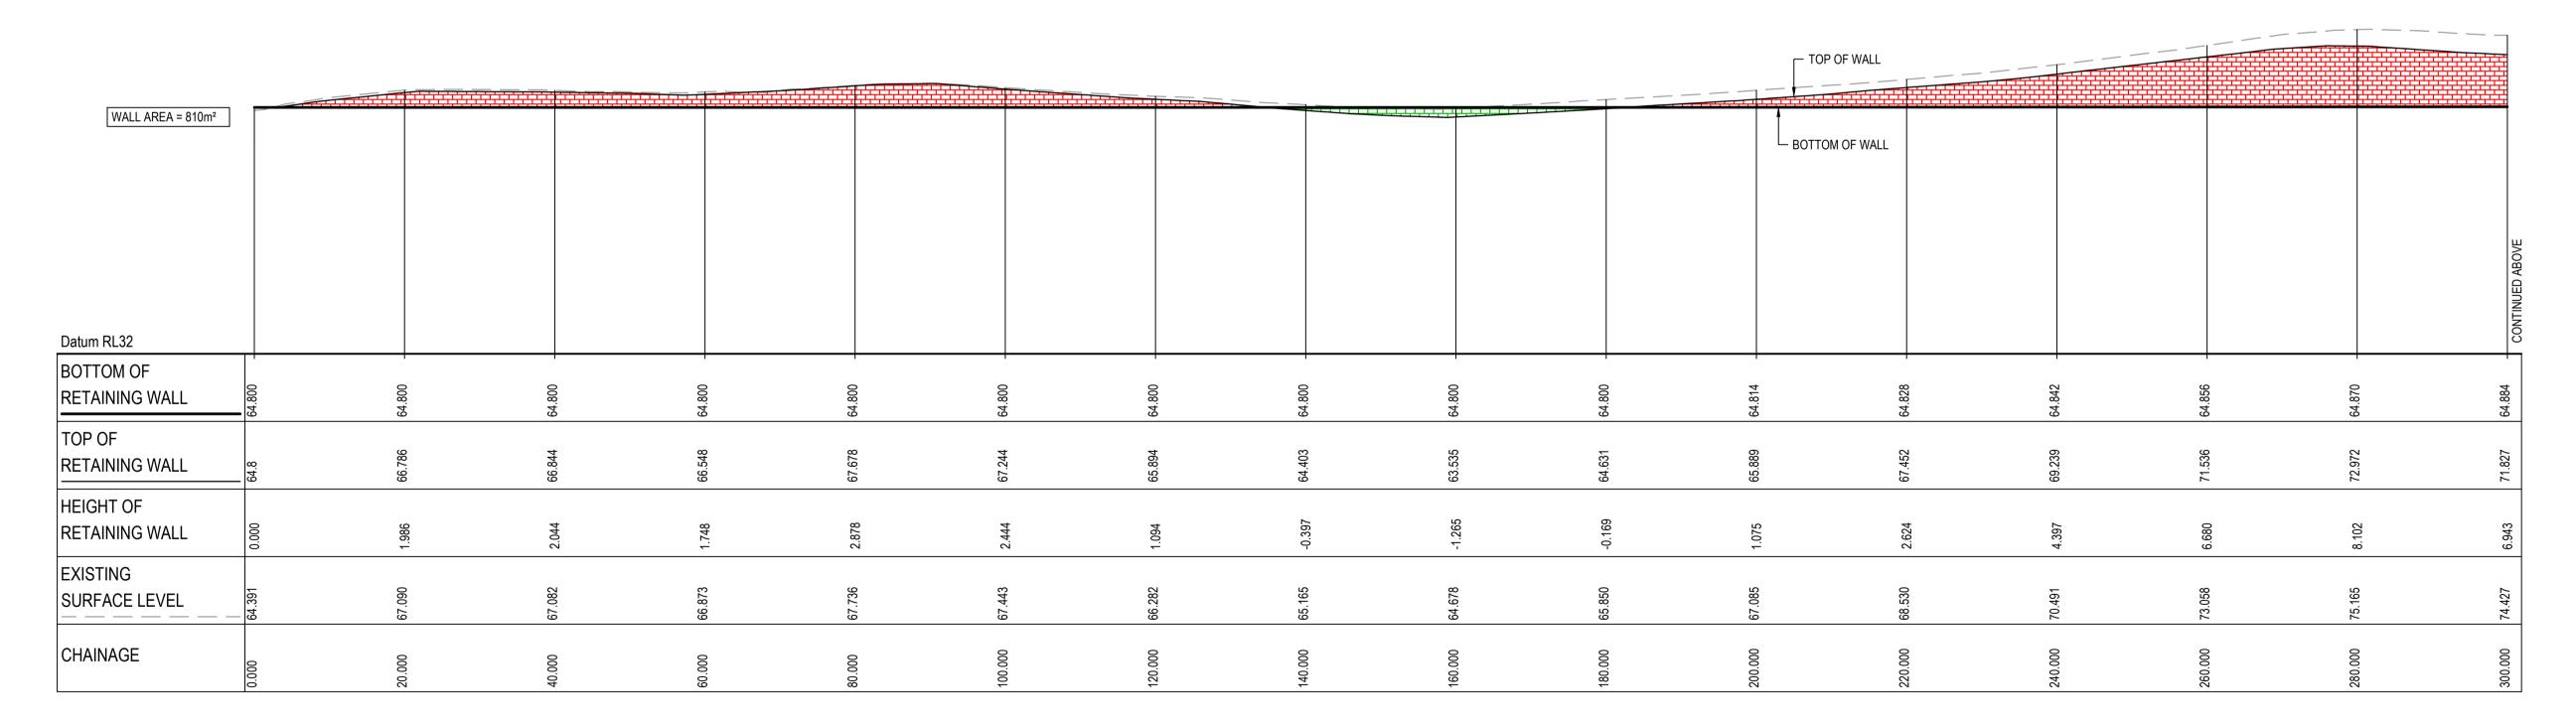

RETAINING WALL (RW-LOT 1-03) PROFILE

			Bar Scales	Client
-				
			0 10 20 30 40 50m	
	DE ICCUED FOR MOD 4 APPROVAL	12.05.04	1 · 500 @ A1 1 · 1000 @ A3	
3	RE-ISSUED FOR MOD 1 APPROVAL	13-05-24		
2	RE-ISSUED FOR MOD 1 APPROVAL	14-03-24		
1	ISSUED FOR MOD 1 APPROVAL	01-11-23		
Issue	e Description	Date		

100mm on Original



Scales	1:500 V	Drawn	QD	Projec
	1 : 500 H	Designed	QD	
Grid	MGA2020	Checked	AT	
Height	AHD	Approved		
Datum	· · · · · -			Title

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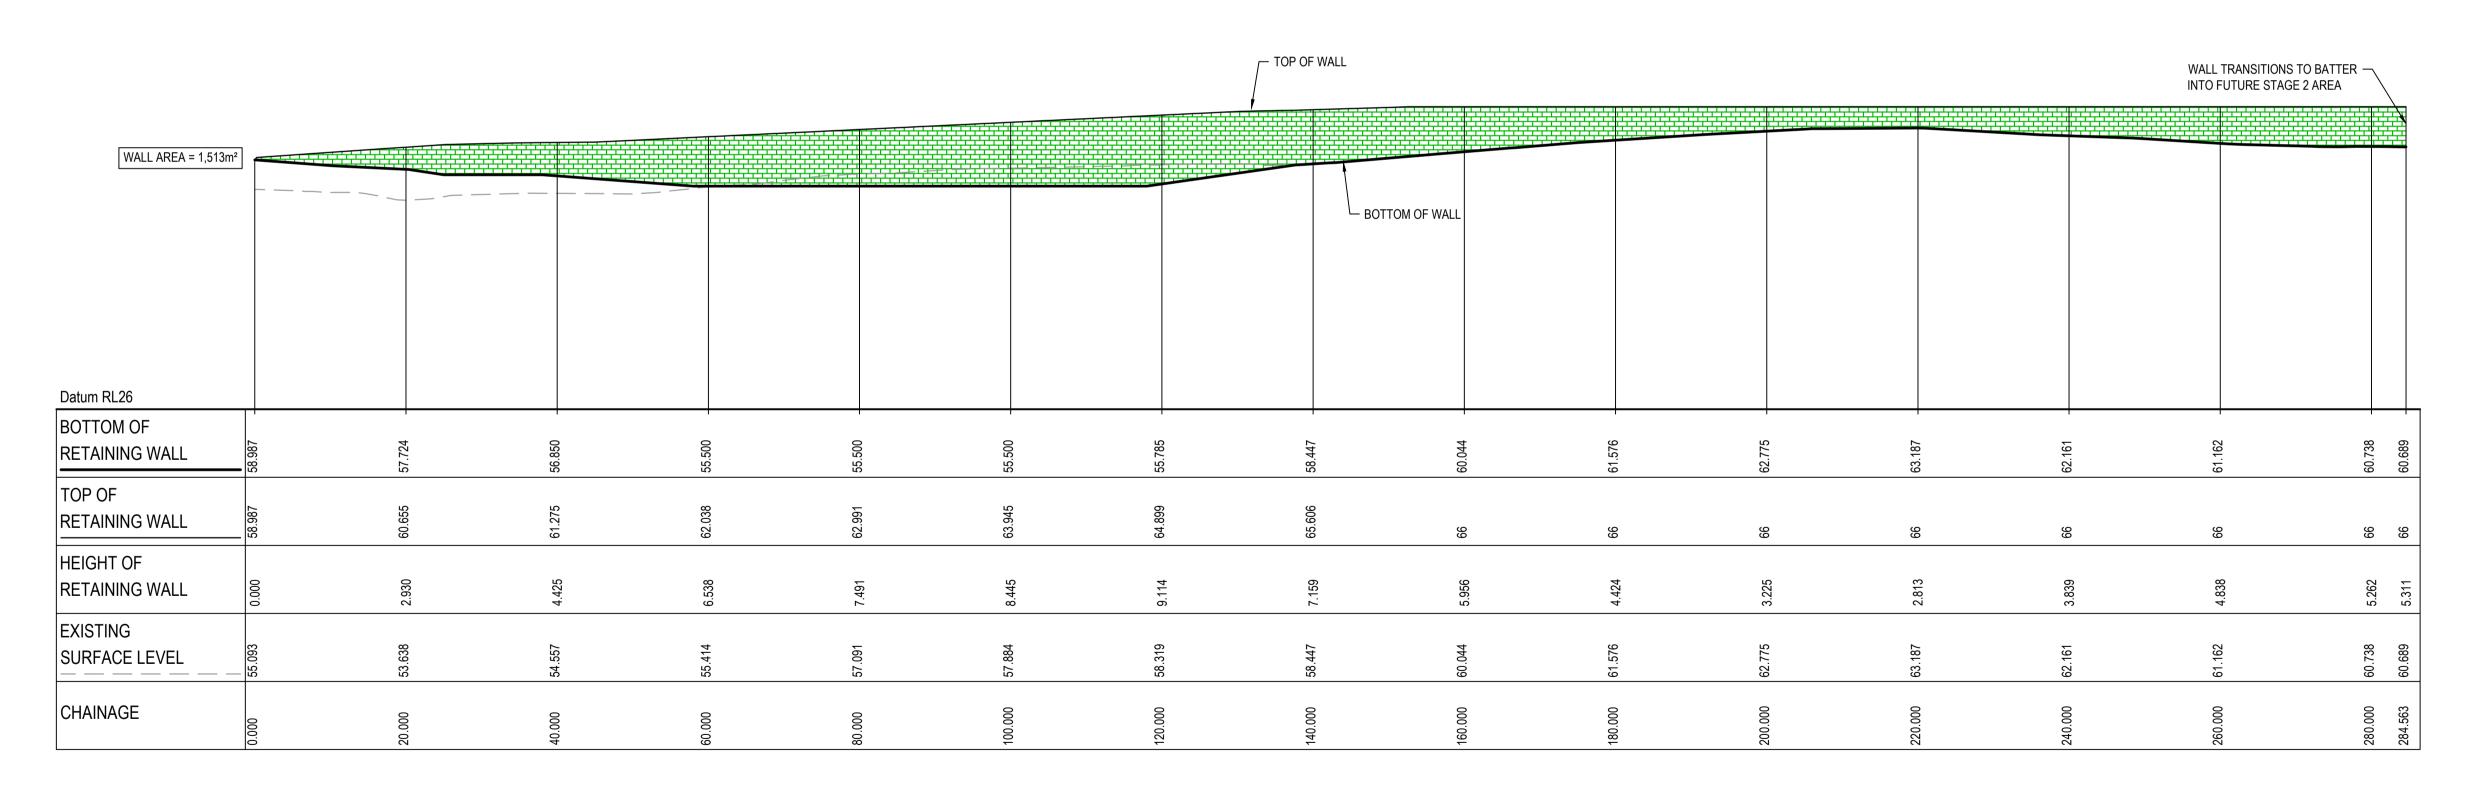
GDA2020 RETAINING WALL PROFILES THIS DRAWING CANNOT BE COPIED OR REPRODUCED IN ANY FORM OR USED FOR ANY OTHER PURPOSE OTHER THAN THAT ORIGINALLY SHEET 2

PROPOSED INDUSTRIAL DEVELOPMENT WESTLINK KEMPS CREEK

Civil Engineers and Project Managers Level 7, 153 Walker Street North Sydney NSW 2060 ABN 96 130 882 405 Tel: 02 9439 1777 Fax: 02 9923 1055 www.atl.net.au info@atl.net.au

FOR APPROVAL NOT TO BE USED FOR CONSTRUCTION Project - Drawing No. 20-748-C11212

Issue



RETAINING WALL (RW-LOT 4-01) PROFILE SCALE 1:500 HORI. 1:500 VERT.

3 RE-ISSUED FOR MOD 1 APPROVAL 2 ISSUED FOR MOD 1 APPROVAL 1 ISSUED FOR MOD 1 APPROVAL 5 ISSUED FOR MOD 1 APPROVAL 6 ISSUED FOR MOD 1 APPROVAL 7 INSTANDED WITHOUT THE WRITTEN PERMISSION OF AT&L 8 ISSUED FOR MOD 1 APPROVAL 8 ISSUED FOR MOD 1 APPROVAL 9 ISSUED FOR MOD 1 APPROVAL 1 ISSUED FOR MOD 1 APPROVAL 2 IS	4	RE-ISSUED FOR MOD 1 APPROVAL 13-05-24	Bar Scales 0 10 20 30 40 5	Client	Scales Grid Height Datum	1 : 500 V 1 : 500 H MGA2020 AHD	Drawn Designed Checked Approved	QD QD AT	Project PROPOSED INDUSTRIAL DEVELOPMENT WESTLINK KEMPS CREEK	Civil Engineers and Project Managers Level 7, 153 Walk North Sydney NSV ABN 96 130 882 4 Tel: 02 9439 17 Fax: 02 9923 10 www.atl.net.au info@atl.net.au	. 405 1777
THIS DRAWING CANNOT BE COPIED OR REPRODUCED IN ANY FORM OR USED FOR ANY OTHER PURPOSE OTHER THAN THAT ORIGINALLY Description O1-11-23 Project - Drawing No. Issue O7.749 C11212	2		<u> </u>		GDA2020			RETAINING WALL	FOR APPROVAL	A1	
	1 Issue				OR USED FO	THIS DRAWING CANNOT BE COPIED OR REPRODUCED IN ANY FORM OR USED FOR ANY OTHER PURPOSE OTHER THAN THAT ORIGINALLY		PROFILES	Project - Drawing No.	Issue 4	